SECTION 00 90 02 BIDDING AND CONTRACT REQUIREMENTS ADDENDUM NUMBER 2

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To: Prospective Bidders

Issued: November 1, 2024

Re: ADDENDUM NUMBER (2) TO THE BIDDING DOCUMENTS FOR

McHenry County College 2024 Renovations – Bid Package 2 Architect's Project Number: 24-013

This addendum forms a part of the bidding and contract documents and modifies the original bidding documents dated October 17, 2024. Acknowledge receipt of this addendum in the space provided on Bid Form. FAILURE TO DO SO MAY SUBJECT BIDDER TO DISQUALIFICATION.

ADDENDA TO THE PROJECT MANUAL

- 1. 00 41 13 BID FORM
 - A. **ADD** ALTERNATE No. 6 to Part 2, Alternate Bids of the Bid Form. The entire specification section has been re-issued to be included in the bid submittal.
- 2. 01 23 00 ALTERNATES
 - A. ADD Alternate No. 6 as indicated below to section 3.1-SCHEDULE OF ALTERNATES.
 - 'F. ALTERNATE NO. 6: Deduct to the Lump Sum Base Bid to provide non-rated gyp partitions and a gyp soffit in lieu of fire walls, shaft walls, and the fire door at the Library Renovation in the Second Floor of Building A. Refer to Architectural and Electrical drawings for location and additional details.'
 - B. The specification section has not been re-issued. The changes noted will be reflected in the final Issued for Construction Specifications released post-bid.
- 3. 08 80 00 GLAZING
 - A. **REVISE** 2.8-A-3 to "60 inches high" in lieu of "48 inches high".
 - B. The specification section has not been re-issued. The changes noted will be reflected in the final Issued for Construction Specifications released post-bid.

ADDENDA TO THE DRAWINGS

ARCHITECTURAL

- 1. AD1.11
 - A. ADD Demo Referenced Note F7.
 - B. **REVISE** F3 demo note in EMS LAB to F7.
- 2. AD1.20
 - A. REVISE demolition extent of existing South Gallery wall.
- 3. AD2.20
 - A. **REVISE** demolition extent of existing South Gallery wall.
 - B. **REVISE** existing window layout and associated scope to demolish the existing window blinds.
- 4. A1.11
 - A. ADD scope of Floor Plan Reference Note 13 for continuous blocking to plan as indicated.

- 5. A1.20
 - A. **DELETE** pole mount TV.
 - B. **REVISE** Referenced Note 9 to refer to the fire rated folding door in lieu of pole mount tv.
 - C. **REVISE** existing Gallery wall near DIRECTOR OFFICE A212A as indicated.
 - D. ADD monitor and Power/ Data to existing corridor wall outside of Library. Refer to Elec.
 - E. **REVISE** existing window layout and associated furring walls as indicated on Library Floor Plan and Dimension Plan.
 - F. **DELETE** Millwork cabinets and countertop from TECH PROCESSING A212C and associated enlarged plans and details. Scope of millwork in this area no longer included in the project.
 - G. ADD scope of Floor Plan Reference Note 13 for continuous blocking to plan as indicated.
 - H. ADD fire extinguisher cabinets as indicated. Refer to plan for types.
- 6. A2.20
 - A. **REVISE** existing window layout and associated scope for new roller shades.
 - B. **REVISE** size of new gyp ceiling at existing South Gallery wall near DIRECTOR OFFICE A212A to be reduced in length where existing Gallery wall has increased in length.
 - C. ADD control joint where existing soffit meets elongated South Gallery wall as indicated.
 - D. **DELETE** the two new square recessed downlights near the library entrance.
 - E. **REVISE** associated reference note 6 to indicate control joint location at soffit.
 - F. **REVISE** GALLERY A212.3 lighting and ceiling layout as indicated.
 - G. **REVISE** 2x2 return grille in GALLERY A212.3 to 1x4 return grille.
 - H. **REVISE** lighting layout at South Gallery wall near LIBRARY A212 entrance as indicated.
 - I. ADD referenced note 18 and 19 to clarify scope associated with Fire Rated Folding Door.
- 7. A7.01
 - A. REVISE detail 20 as indicated.
- 8. A7.02
 - A. REVISE Detail 4 to show increased length of existing South Gallery wall.
 - B. **REVISE** Details 9 & 10 to clarify scope of fire walls and folding fire wall.
- 9. A9.02
 - A. **REVISE** Raised Brushed Aluminum Lettering orientation on Elevation 14.
 - B. REVISE "LEARNING" lettering from 6"H to 12"H on Elevation 14.
 - C. ADD monitor and Power/ Data to Elevation 14. Refer to Elec.
 - D. **REVISE** brushed aluminum dimensional lettering location and add brushed aluminum logo with approximate size/ placement dimensions indicated on elevation.
 - E. **REVISE** "TUTORING CENTER" signage height from 18"H to 12"H and revise phrasing to say "TUTORING" on Elevation 12.
 - F. **ADD** 6"H black vinyl lettering saying "ACADEMIC SUPPORT" below "TUTORING" lettering on Elevation 12.
 - G. ADD control joints to Elevation 12 as indicated.
 - H. **DELETE** pole mount monitor note on Elevation 6.
 - I. **REVISE** Elevation 6 to show elongated Gallery wall and termination of PT-5 at new control joint.
 - J. **REVISE** frosted vinyl film (V-3) extents on Elevation 5.
 - K. ADD control joint to Elevation 13 as indicated.
 - L. ADD fire extinguishers cabinet as indicated.
- 10. A9.52
 - A. **REVISE** size of Book Return opening from 1'-6" wide to 1'-3" wide on Millwork Elevation 1C.
 - B. **REVISE** size of vinyl Book Return lettering from 4"H to 2"H on Millwork Elevation 1C.
- 11. A9.53
 - A. DELETE Millwork Plan 11 Tech Processing.
- 12. A9.54
 - A. DELETE Millwork Elevation 1 Tech Processing.
 - B. **DELETE** Millwork Detail 9.
- 13. A11.10
 - A. ADD Finish Plan Reference Note 15.
 - B. ADD scope of Plan Reference Note 15 for new subfloor leveler to plan as indicated.
- 14. A11.11
 - A. **REVISE** LVT-1 in EMS LAB D167, STORAGE D167D, and STORAGE D167C to EPX-1 over existing floor to remain.
 - B. ADD EPX-1 to Floor Finish Types legend.

- C. ADD Note 14 to Finish Plan Referenced Notes legend, EMS LAB D167, STORAGE D167C and STORAGE D167D.
- D. ADD TRANS-2 from EMS LAB D167 into EMS OFFICE SUITE D166.

STRUCTURAL

- 1. Structural Reference Sheet
 - A. **ADD** structural reference sheet in its entirety to provide attachment details for Fire Rated Folding Door at the Library in Building A, 2nd Floor.

PLUMBING

- 2. P2.10
 - A. ADD 'EWC-1' to 'PLUMBING FIXTURE SCHEDULE'.

ELECTRICAL

- 1. E0.12
 - A. ADD proposed routing of new feeders on lower level.
 - B. ADD approximate locations of new rooms on upper level containing electrical panels.
 - C. **REVISE** note regarding server room cooling system replacement.
 - D. ADD general notes to drawing.
- 2. E1.11
 - A. **ADD** receptacles serving electric water cooler and associated drawing note located outside Gender Neutral Toilet D151E.
- 3. E1.20
 - A. **DELETE** ceiling mounted devices and associated drawing note outside Director Office A212A.
 - B. ADD receptacle and data outlet outside IT Help Desk A212.2.
 - C. **DELETE** ceiling mounted fire alarm device at IT Help Desk A212.2.
 - D. **DELETE** (1) floor box at Library A212.
- 4. E2.20
 - A. **REVISE** lighting layout outside Directory Office A212A.
 - B. **REVISE** luminaire type in wood ceiling panel at Library A212.
 - C. **REVISE** luminaire type at IT Help Desk A212.2.
 - D. **REVISE** luminaire type at Gallery A212.3.
- 5. E3.00
 - A. REVISE 'ELECTRICAL RISER DIAGRAM' as indicated.
- 6. E4.00
 - A. REVISE 'LUMINAIRE SCHEDULE' as indicated.
 - B. ADD 'LIGHTING CONTROL SEQUENCE OF OPERATION' as indicated.
- 7. E4.10
 - A. **ADD** circuit in schedule for panel "S/H".
 - B. **REVISE** remarks for panels "S/H" and "S/J2".

CLARIFICATIONS

1. Refer to attached pre-bid RFI submitted and the responses provided. Any pre-bid RFI not listed in this addendum will be included with responses in a subsequent addenda.

This addendum consists of 3 pages, excluding attachments.

END 00 90 02.

Attachments:

- 1. 2024.11.01 MCC 2024 Reno BP2 Pre-bid RFI_ADDENDUM #2
- 2. 00 41 13 BID FORM
- 3. AD1.11, AD1.20, A1.11, A1.20, A2.20, A7.01, A7.02, A9.02, A9.52, A9.53, A9.54, A11.10, A11.11
- 4. Structural Reference Sheet
- 5. P2.10, E0.12, E1.11, E1.20, E2.20, E3.00, E4.00, E4.10



DEMONICA KEMPER ARCHITECTS

McHenry County College 2024 Renovations - Bid Package 2 DKA Project No.: 24-013

Pre-Bid RFI - Addendum 2 11/1/2024

RFI#	Question	Answer
001	What are the deck heights in each renovation area?	The deck heights in each renovation area are - Building A, 2nd Floor = +/- 13'-0" AFF. The deck above is structurally sloped so it varies throughout the renovation area. - Building A, 1st Floor = +/- 13'-0" AFF - Building C = +/- 13'-4" AFF - Building D = +/- 19'-4" AFF. The deck above is structurally sloped so it varies
002	As shown in drawings, . There are a number of card readers shown on the floor plan E1.20. In the Spec it says "credential reader by division 28" however there isn't a division 28 in the spec book. Please clarify.	throughout the renovation areas. Door Access Control systems will be conduit rough-in only. Final installation of card readers, notification to exit devices, and associated wiring will be provided by Owner's Vendor. Disregard reference notes to DIV 28 in door hardware specification.
003	Sheet E501 is missing from the set of drawing and is listed on the title page.	There is no sheet E501. This sheet was included in the sheet index in error and can be disregarded. The sheet index will be updated in the Issued for Construction Drawings after the award of the contract.
004	Door Schedule Sheet A10.00 show the use of glass type GL-03 yet the specification section do not list exactly what GL-03 is Need to know what this item is?	GL-03 is the same as GL-02 but at a 3/8" (10mm) thickness.
005	It looks like there is to be carpet removed on sheet AD1.11 per note F3. Per the walk thru today it looks to be epoxy or painted floors. Please confirm the intent is to use lyt over ex floors?	Refer to Addendum #2 for clarification on the flooring removal and new type of flooring at the EMS lab.
006	The drawings and the finish schedule indicate PWP-1 perforated wood panels and to see spec. What spec can I find this in?	Refer to Spec Section 09 84 33 Sound Absorbing Wall and Ceiling Units for product details for PWP-1 Perforated Wood Panels.
007	Spec 064216 item 2.2 F 2 indicates PVC T-mold for exposed edges. Will 3m PVC be acceptable, as PVC T-molding is not very common for cabinets.	3m PVC is acceptable.
008	Spec 064216 item 2.2 F 1 indicates HGS laminate for exposed surfaces. Please confirm this is required, as VGS laminate is typically standard for cabinet exteriors.	HGS laminate is required for horizontal surfaces, but VGS can be used on vertical surfaces.
009	Spec 064216 includes WD-1, 2 & 3 and is described as wood paneling. The only item noted on the drawings on the finish schedule on A11 sheets is WD-3 which is a 2" solid wood edge. Is this the correct spec for this item? And is WD-1, 2, & 3 in the spec relevant to this project? Please clarify.	Refer to Millwork Sheets for WD-1 and WD-2 locations (A9.51-A9.54). Refer to Detail Sheets (17/A7.01, 15/A7.02, 10&11/A7.51), Interior Elevation Sheets (A9.02), Millwork Details (A9.51) and Finish Plans (A11.20) for WD-3 locations. The design in intent is for WD-1 (solid wood) and WD-2 (Veneer) to have the same custom finish to match the control sample and for WD-3 (Solid wood) to be stained to match the Perforated Wood Panels (PWP-1).
010	Upon looking through the project documents, I see it mentions four window films (v1, v2, v3, and v4). I see that V3 is a frosted film which I can quote the standard for, but can you clarify how "high" of a gradient for V4 and specifics on V1 and V2?	Refer to 08 80 00 GLAZING, Section 2.8 for details on V2, V3, and V4 and the interior elevations / window elevations for extents of the graphics provided. V1 will be a custom graphic printed on the applied vinyl, size as indicated on
011	The EWC-1 shown on P1.11/detail 3 (Alternate #2) is not shown on the fixture schedule. Is this water cooler supposed to be new? Demo note "16" on PD1.11/detail 3 calls out for the existing water cooler to be removed but does not say to "reinstall." So, I'm assuming this unit goes to the trash?	Refer to Addendum #2 for revised plumbing drawings. The existing EWC can be removed and either salvaged to the owner or thrown out.
	Are we to provide a new water cooler? If so, please have the A/E provide a make and model.	

012	Can you provide more information on the signage planned for the wall noted	Refer to Addendum #2 for additional details on the logo planned for
	on 11/A9.02.	11/A9.02.
013	Are the CMU walls remved at the toilet room full height? If so, what shoring	The west walls and outer south walls of the existing office area are full height.
	is required for demolition and bracing is required for new work?	The inner south wall is partial height. Both south walls are shown to be
		removed complete up to deck. The contractor is responsible for providing a
		shoring plan to safely remove both existing CMU walls to the south. The west
		CMU wall will be left existing to remain with new bracing provided as
		required to maintain structural stability of the full height CMU wall.

SECTION 00 41 13 - BID FORM

То:	8900 U	ory County Colle IS Hwy 14 I Lake, IL 60012						
Project:	2024 R	Renovations – B	3id Package 2					
Date:								
Submitted by:								
(Full name and	addraga	<u> </u>						
(Full flame and	auuress	o)						
PART 1 - OFFE	₽R							
associated with everything requ	the proj ired and ervices	ject and with the d to furnish all land necessary to co	e bidding doc abor, material omplete in a v	uments, Bi s, necessa vorkmanlik	idder her ary tools, e manne	eby propo expendab r the subd	ng the cost of the w ses to perform le equipment, and livision of work state	
Base Bid:								
We have includ	ed, atta	ched herewith,	the Bid Bond	as require	d by the	Instruction	s to Bidders.	
The Bidder agre	ees to pe	erform the work	c for the lump	sum amou	ınt of:			
TOTAL BASE E	BID	\$					(in figures)	
	-						(in words)	
Allowances:								
The undersigne included in the					describe	ed in Section	on 01 21 00, are	
ALLOWANCE N	NO. 1: U	Inforseen Cond	lition Allowand	ce of \$25,0	00.00			
ALLOWANCE N	NO. 2: F	ire Wall Allowa	nce of \$25,00	00.00				
Alternate Bids:	:							
The undersigne following Alterna					increase	to the Lu	mp Sum Base Bid f	or the
ALTERNATE N from the Contra		educt from the	Lump Sum B	ase Bid to	eliminate	e the Liqui	dated Damages Cla	ause
Total, Alternate	No. 1: \$	\$						

MCHENRY COUNTY COLLEGE 2024 Renovations – Bid Package 2 DKA Project No.: 24-013

Toilet Room Renovation in the First Floor of Building D.
Total, Alternate No. 2: \$
ALTERNATE No. 3: Deduct from the Lump Sum Base Bid to eliminate the entire scope of work at the Server Room Cooling System Replacement in the First Floor of Building A.
Total, Alternate No. 3: \$
ALTERNATE No. 4: Deduct from the Lump Sum Base Bid to leave the raised flooring areas, indicated on the drawing, under the existing server racks / equipment as existing to remain in lieu of a new raised flooring system at the Server Room Cooling System Replacement in the First Floor of Building A. Refeto architectural drawings for location and additional details. Alternate No. 4 will not apply if Alternate No. is selected.
Total, Alternate No. 4: \$
ALTERNATE No. 5: Add to the Lump Sum Base Bid to raise the section of the Hot Water Supply / Hot Water Return piping at the Library Renovation in the Second Floor of Building A.
Total, Alternate No. 5: \$
ALTERNATE No. 6: Deduct to the Lump Sum Base Bid to provide non-rated gyp partitions and a gyp soffit in lieu of fire walls, shaft walls, and fire door at the Library Renovation in the Second Floor of Building A.
Total, Alternate No. 6: \$

PART 3 - ACCEPTANCE

This offer shall be open to acceptance and is irrevocable for thirty (90) days from the Bid closing date.

If the bid is accepted by the Owner within the time period stated above, we will:

- A. Execute the Agreement within ten (10) days of receipt of Notice of Award.
- B. Furnish the required bonds within ten (10) days of receipt of Notice of Award in the form described in the Supplementary Conditions.
- C. Furnish the required Certificate of Insurance within ten (10) days of receipt of Notice of Award in the form and amounts described in the Supplementary Conditions.
- D. Commence work as established by the written Notice to Proceed.

If this Bid is accepted within the time stated, and we fail to commence the Work or we fail to provide the required Bonds(s), the Security Deposit shall be forfeited as damages to the Owner by reason of our failures.

In the event our Bid is not accepted within the time stated above, the required security deposit shall be returned to the undersigned, in accordance with the provisions of the Instructions to Bidders; unless a mutually satisfactory arrangement is made for its retention and validity for an extended period of time.

3

PART 4 - CONTRACT TIME

If the Bid is accepted, we will:					
A.	Complete the work in manner consistent to meet the requirements of the schedule.				
B.	Contractor has examined the Schedule included in these documents and takes no exception, or records the following exceptions:				
PART 5 - CON	ITRACTOR'S FEES FOR CHANGES IN THE WORK				
percentages for deleted from, t	Time and Materials Changes: We, the undersigned bidder, agree that the following or overhead and profit shall be added to costs for the net amount of work added to, or he contract by written lump sum or time and material change orders recommended by the approved by the Owner:				
B. On first-tier	tor's direct net cost: 15%, with a minimum fee of one hundred dollars (\$100.00). Subcontractor's net cost: 5%, with a minimum fee of fifty dollars (\$50.00). Net cost o-subcontractors work, and excludes subcontractors (all tiers) overhead and profit				
Note: Insurance listed above.	e, bond, and taxes are considered as job cost items and are included in the percentages				
PART 6 - ADD	ENDA				
The following /	Addenda have been received. The modifications to the Bid Documents noted therein have				

PART 7 - SUBCONTRACTORS

Addendum #

Addendum #

Scope of Work

been considered and all costs thereto are included in the Bid Sum.

____ Dated _____

GC/Sub.

____ Dated ____ Addendum #

Identify below which work will be completed by the General Contractor's own forces and which work will be completed by first tier Subcontractors. Include Subcontractors name and estimated contract amount.

Name

Addendum #

•		

Dated _____

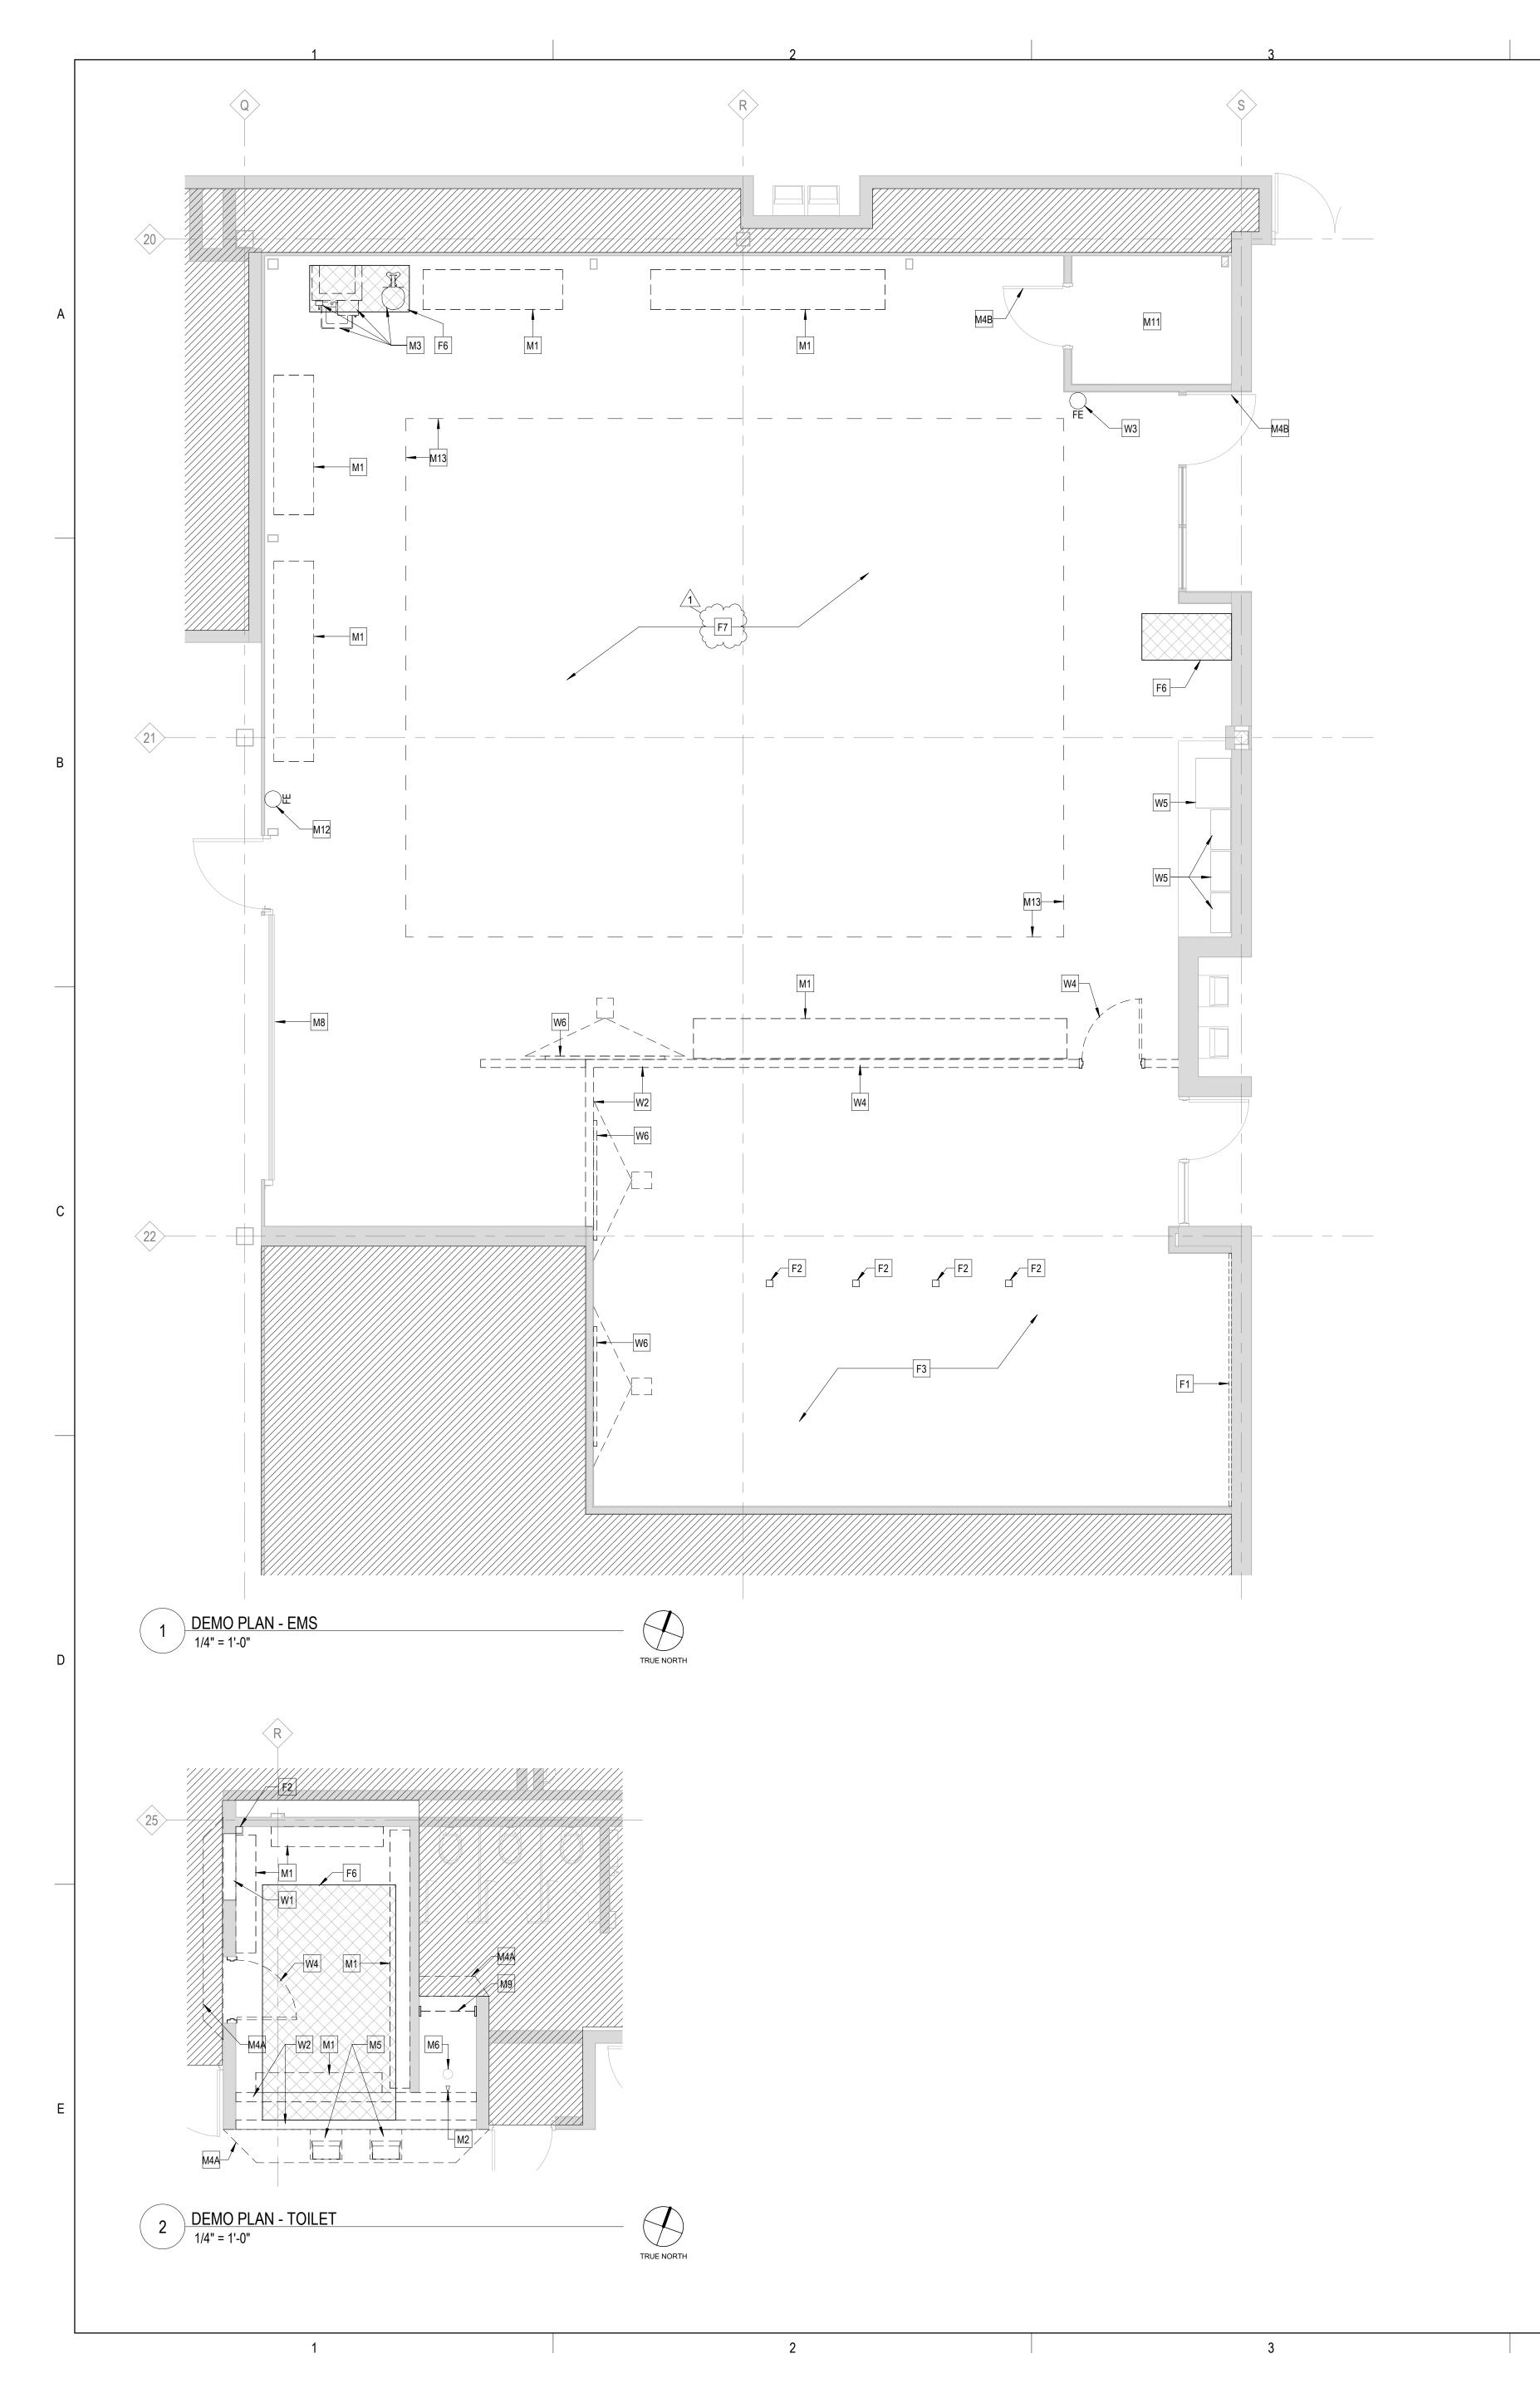
Est. Contract Amount

Dated _____

PART 8 - BID FORM SIGNATURE(S)		
The Corporate Seal of:		
(Bidder – please print the full name of your	Proprietorship or Corporation)	
Was hereunto affixed in the presence of:		
(Authorized signing officer)	(Title)	
(ratherized eighning eineer)	(1.11.5)	
(Seal)		

MCHENRY COUNTY COLLEGE 2024 Renovations – Bid Package 2 DKA Project No.: 24-013

END OF SECTION 00 41 13



DEMO GENERAL NOTES:

PRIOR TO AND DURING ANY DEMOLITION THE CONTRACTOR SHALL VERIFY AND MAINTAIN THE BUILDING'S STRUCTURAL INTEGRITY. 2. CONTRACTOR SHALL BE RESPONSIBLE FOR ALL DEMOLITION AS REQUIRED TO INSTALL ALL NEW WORK. REPAIR, PATCH AND FINISH EXISTING FLOORS, WALLS AND CEILINGS DESIGNATED TO REMAIN TO MATCH EXISTING CONDITIONS. REMOVE ALL HANGERS, SUSPENSION SYSTEMS, SUPPORT FRAMING, EQUIPMENT PADS, ANCHORS, ATTACHMENT HARDWARE AND RELATED APPURTENANCES CONNECTED WITH THE WORK TO BE DEMOLISHED. IF COMPLETE REMOVAL IS NOT POSSIBLE, CUT DEVICES AS CLOSE AS POSSIBLE TO ADJOINING SURFACES OR ORIGIN OF SUPPORT. I. DURING THE BIDDING PERIOD. EACH BIDDING CONTRACTOR SHALL VISIT THE SITE AND THE

FACILITY TO DETERMINE EXISTING CONDITIONS. CONTRACTOR'S FAILURE TO REASONABLY DETERMINE AND/OR ANTICIPATE THE EFFECT OF EXISTING CONDITIONS AND THE WORK INVOLVED THEREBY SHALL NOT BE JUSTIFICATION FOR ADDITIONAL COMPENSATION. NOTIFY ARCHITECT OF ANY DISCREPANCIES.

5. ALL MATERIALS, EQUIPMENT, FIXTURES, SYSTEMS, AND ACCESSORIES WHICH ARE TO REMAIN IN SERVICE SHALL BE CLEANED, REPAIRED, ADJUSTED AND PLACED INTO PROPER OPERATIONS IN ALL MODES WITH THE ORIGINAL SYSTEM. B. WHEN TEMPORARY SHORING AND BRACING IS REQUIRED, CONTRACTOR SHALL RETAIN AND PAY

FOR THE SERVICES OF A PROFESSIONAL ENGINEER- LICENSED TO PRACTICE IN THE STATE WHERE THE PROJECT IS LOCATED- TO DESIGN AND PREPARE DETAILED DRAWINGS. . CONTRACTOR SHALL COORDINATE SCHEDULE OF DEMOLITION WORK WITH THE OVERALL PHASING PLAN. ALL AREAS SURROUNDING EACH PHASE OF DEMOLITION/CONSTRUCTION WILL BE OCCUPIED BY THE OWNER DURING THE OWNER'S NORMAL BUSINESS HOURS. DEMOLITION WORK SHALL NOT ENCUMBER THE USE OF EXISTING ADJACENT SPACES. B. EACH CONTRACTOR SHALL FOLLOW THE PROGRESS OF THE GENERAL DEMOLITION AND

REMODELING WORK TO ASSURE THE ACCESSIBILITY AND SAFETY OF EQUIPMENT AND SYSTEMS IN SERVICE IN ORDER TO PROVIDE FOR THE TIMELY REMOVAL AND/OR RELOCATION OF EQUIPMENT, PIPING, ETC. REMOVE ALL ABANDONED CONDUIT BOXES, CONDUCTORS, TELEPHONE LINES, ELECTRIC PANELS, AND ANY OTHER MISCELLANEOUS EQUIPMENT NOT REQUIRED FOR THE NEW FACILITY. 10. REMOVE ALL RECESSED FLOOR BOXES, WALKER DUCTS, FLOOR SINKS, HUB DRAINS, ELECTRICAL RECEPTACLES, ETC. AND FILL VOIDS AS REQUIRED.

12. NO TOXIC SUBSTANCES HAVE BEEN NOTED ON THE SITE. SHOULD THE CONTRACTOR ENCOUNTER ANY ASBESTOS, ASBESTOS PRODUCTS, PCBs OR OTHER TOXIC SUBSTANCES, THE CONTRACTOR SHOULD REPORT THIS IMMEDIATELY TO THE OWNER IN WRITING PRIOR TO CONTINUING WORK IN THIS AREA. WORK SHALL NOT BE RESUMED EXCEPT BY WRITTEN AUTHORIZATION OR AGREEMENT. 13. ALL CONSTRUCTION DEBRIS AND EXCESS MATERIAL IS TO BE REMOVED BY THE CONTRACTOR AT THE END OF EACH WORK DAY. THE JOB SITE IS TO BE LEFT SUFFICIENTLY CLEAN AS TO WARRANT OWNER'S APPROVAL. 4. REMOVE ALL CEILING SYSTEMS IN THEIR ENTIRETY, INCLUDING TILE, GRID, SUSPENSION WIRING,

REMOVE ALL DOOR STOPS AT ASSOCIATED DOORS TO BE DEMOLISHED.

ANCHORS AND ALL ASSOCIATED APPURTENANCES UNLESS OTHERWISE NOTED.

DEMO SYMBOLS LEGEND: NOTE: REFER TO M.E.P.F.P. DRAWINGS FOR ADDITIONAL INFORMATION ON MECHANICAL, ELECTRICAL, AND FIRE PROTECTION SYSTEMS HATCH INDICATES AREA NOT IN SCOPE GYPSUM BOARD OR PLASTER PARTITION TO BE REMOVED CMU PARTITION TO BE REMOVED FRAME AND DOOR TO BE REMOVED, SALVAGE HARDWARE TO OWNER SUSPENDED ACOUSTICAL TILE CEILING TO BE REMOVED SUSPENDED ACOUSTICAL TILE CEILING TO REMAIN GYPSUM BOARD OR PLASTER CEILING TO BE REMOVED GYPSUM BOARD OR PLASTER CEILING TO REMAIN RECESSED 2'x4' LAY-IN LIGHT FIXTURE TO BE REMOVED RECESSED 2'x2' LAY-IN LIGHT FIXTURE TO BE REMOVED

RECESSED 2'x4' LAY-IN LIGHT FIXTURE TO REMAIN

RECESSED 2'x2' LAY-IN LIGHT FIXTURE TO REMAIN

REMOVE MOTORIZED SCREEN - SALVAGE TO OWNER

REMOVE CEILING MOUNTED PROJECTOR - SALVAGE TO OWNER

LINEAR LIGHT FIXTURE TO BE REMOVED

RETURN AIR GRILLE TO BE REMOVED

SUPPLY AIR GRILLE TO BE REMOVED

RETURN AIR GRILLE TO REMAIN

SUPPLY AIR GRILLE TO REMAIN

FLOOR DEMOLITION KEYED NOTES

MOUNTING ACCESSORIES COMPLETE.

 $\sqsubseteq \bot$

F1. REMOVE FLOOR / WALL WIREMOLD SYSTEM COMPLETE, INCLUDING ALL WIRING AND

ACCESSORIES. PATCH AND PREP EXISTING WALL AS REQUIRED FOR NEW WORK. REMOVE EXISTING POWER / DATA VERTICAL UTILITY CHASE, INCLUDING ALL WIRING AND

. REMOVE CARPET, BACKER, TRANSITIONS, RESILIENT BASE AND ALL ADHESIVES COMPLETE. CLEAN AND PREP FLOOR SLAB AS REQUIRED FOR NEW FLOORING FINISH.

. REMOVE VCT FLOORING, TRANSITIONS, RESILIENT BASE, AND ALL ADHESIVES COMPLETE. CLEAN

AND PREP FLOOR SLAB AS REQUIRED FOR NEW FLOORING FINISH. EXISTING RESILIENT RAMP AND STAIR TREADS TO REMAIN. PROTECT THROUGHOUT

CONSTRUCTION. . HATCH INDICATES PROPOSED AREA OF SLAB REMOVAL AS REQUIRED FOR PLUMBING WORK. $^{\prime}$ BACKFILLAS REQUIRED AN DINFILL PER DETAIL 11/AZ 02,

PŘEP EXISTING EPÓXY BROADCAST FLOOR AS REQUIRED TO INSTALL NEW SPECIFIED EPOXY FLOOR COATING.

WALL DEMOLITION KEYED NOTES

W1. REMOVE CMU AS REQUIRED FOR NEW OPENING. CUT WHOLE BLOCKS BACK AND INTALL NEW CMU AS REQUIRED FOR SOLID JAMBS.

W2. REMOVE WALL COMPLETE TO DECK (+/- 18') ABOVE FOR EXTENTS INDICATED. PATCH AND PREP ADJACENT WALLS TO REMAIN FOR NEW WORK.

W3. EXISTING FIRE EXTINGUISHER TO REMAIN. PROTECT THROUGHOUT CONSTRUCTION. W4. REMOVE HOLLOW METAL DOOR AND WINDOW SYSTEM COMPLETE. W5. EXISTING MECHANICAL/ ELECTRICAL EQUIPMENT TO REMAIN - PROTECT THROUGHOUT

CONSTRUCTION. W6. REMOVE EXISTING MARKERBOARD, CORK BOARD, PROJECTOR SCREEN, OR MISC WALL

MOUNTED SHELVING COMPLETE. PATCH AND PREP EXISTING WALL AS REQUIRED FOR NEW

CEILING DEMOLITION KEYED NOTES

C1A. REMOVE EXISTING SUSPENDED CEILING SYSTEM COMPLETE, INCLUDING ALL ACCESSORIES, SUSPENSION WIRES, CLIPS, ETC. TO EXTENTS SHOWN.

C1B. NOT USED. C1C. REMOVE EXISTING SUSPENDED CEILING SYSTEM COMPLETE, INCLUDING ALL GRILLES / REGISTERS, ACCESSORIES, SUSPENSION WIRES, CLIPS, ETC COMPLETE TO EXTENTS INDICATED. REMOVE ALL LIGHTING / DEVICES AND SALVAGE FOR REINSTALLATION IN NEW CEILING. ALL SPRINKLERS TO BE LEFT EXISTING TO REMAIN AND PROTECTED THROUGHOUT CONSTRUCTION.

REMOVE SPRINKLER COVERPLATES AND REINSTALL IN NEW CEILING. REMOVE AND SALVAGE ALL FULLY INTACT, NON-DAMAGED CEILING TILES AND TURN OVER TO OWNER FOR ATTIC STOCK. REMOVE ALL CEILING TILES, LIGHTING, AND DIFFUSERS / REGISTERS COMPLETE. LEAVE GRID INTACT AND PROTECT AS REQUIRED FOR NEW WORK. REMOVE ALL DEVICES AND SALVAGE FOR REINSTALLATION IN NEW CEILING TILES. LEAVE EXISTING SPRINKLER HEADS TO REMAIN, U.N.O.

ON FIRE PROTECTION DRAWINGS. C2. EXISTING CEILING TO REMAIN. PROTECT THROUGHOUT CONSTRUCTION AND TIE INTO NEW

CEILING SYSTEM AS REQUIRED. B. REMOVE TRACK LIGHTING SYSTEM COMPLETE. PATCH AND PREP CEILING AS REQUIRED FOR NEW LIGHT FIXTURE INSTALLATION (REFER TO ELEC).

C4. REMOVE EXISTING BLINDS COMPLETE. PREP WALL / CEILING AS REQUIRED FOR NEW WORK. C5. REMOVE GYP. CEILING AND LIGHT FIXTURES COMPLETE TO EXTENTS INDICATED. C6. REMOVE SUSPENDED CEILING SYSTEM COMPLETE AS REQUIRED FOR MECHANICAL DUCT REPLACEMENT. SALVAGE ALL UN-DAMAGED TILES, LIGHTS, AND DEVICES FOR REINSTALLATION IN NEW WORK. COORDINATE SCHEDULING OF NEW WORK WITH OWNER PRIOR TO

MISCELLANEOUS DEMOLITION KEYED NOTES

M1. REMOVE EXISTING COUNTERTOPS, SINKS, SHELVES, BOOKCASES, AND BASE CABINETS

M2. REMOVE EXISTING SHOWER HEAD, CONTROLS, PIPING AND SHOWER ACCESSORIES COMPLETE. M3. EXISTING MECHANICAL AND PLUMBING SYSTEM (INCLUDING ALL ASSOCIATED PIPING, DUCT,

UTILITIES, AND ACCESSORIES) TO BE REMOVED COMPLETE. REFER TO MEP DRAWINGS FOR ADDITIONAL SCOPE. M4A. PROVIDE FULL-HEIGHT DUST ENCLOSURE TO EXISTING CEILING ABOVE THROUGHOUT THE DURATION OF CONSTRUCTION. PROVIDE ACCESS LOCATIONS AS REQUIRED FOR CONTRACTOR

AND OWNER ACCESS. M4B. EXISTING DOOR TO REMAIN. SEAL AT THE BEGINNING OF CONSTRUCTION FOR DUST CONTROL AND PROTECT THROUGHOUT CONSTRUCTION.

M5. REMOVE EXISTING DRINKING FOUNTAINS COMPLETE. M6. EXISTING SHOWER DRAIN TO REMAIN. REFER TO PLUMBING.

M7. NOT USED.

M8. EXISTING OVERHEAD COILING GARAGE DOOR TO REMAIN. PROTECT THROUGHOUT CONSTRUCTION.

M9. REMOVE SHOWER CURTAIN, ROD, AND SOLID SURFACE TRIM COMPLETE. M10. CORRIDOR TO REMAIN OPEN AND ACCESSIBLE THROUGHOUT CONSTRUCTION. THE GC IS RESPONSIBLE FOR COORDINATING A PHASED SEQUENCE OF DEMO AND NEW WORK WITH THE OWNER TO MAINTAIN CONTINUED OPERATION OF THE CORRIDOR. REFER TO SPECS FOR ADDITIONAL DETAILS.

M11. EXISTING IT CLOSET - EQUIPMENT TO REMAIN OPERATIONAL THROUGHOUT CONSTRUCTION -PROVIDE DUST PROTECTION OVER DOOR AND COORDINATE WITH OWNER IF ANY TEMP POWER

OR VENTILATION IS REQUIRED WITH NEW WORK SCOPE. M12. REMOVE FIRE EXTINGUISHER AND ASSOCIATED WALL MOUNT. TURN OVER TO OWNER. M13. REMOVE ALL UTILITIES AND UTILITY SUPPORT SYSTEMS (UNISTRUT, CONDUIT, HANGERS,

PEDESTALS, ETC) SERVING OLD EQUIPMENT COMPLETE IN THE AREA INDICATED



ARCHITECT OF RECORD DEMONICA KEMPER ARCHITECTS 125 N. HALSTED STREET, SUITE 301

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CHICAGO, IL 60661

20/10 ENGINEERING GROUP, LLC 1216 TOWER ROAD SCHAUMBURG,IL 60173 P: 847.882.2010

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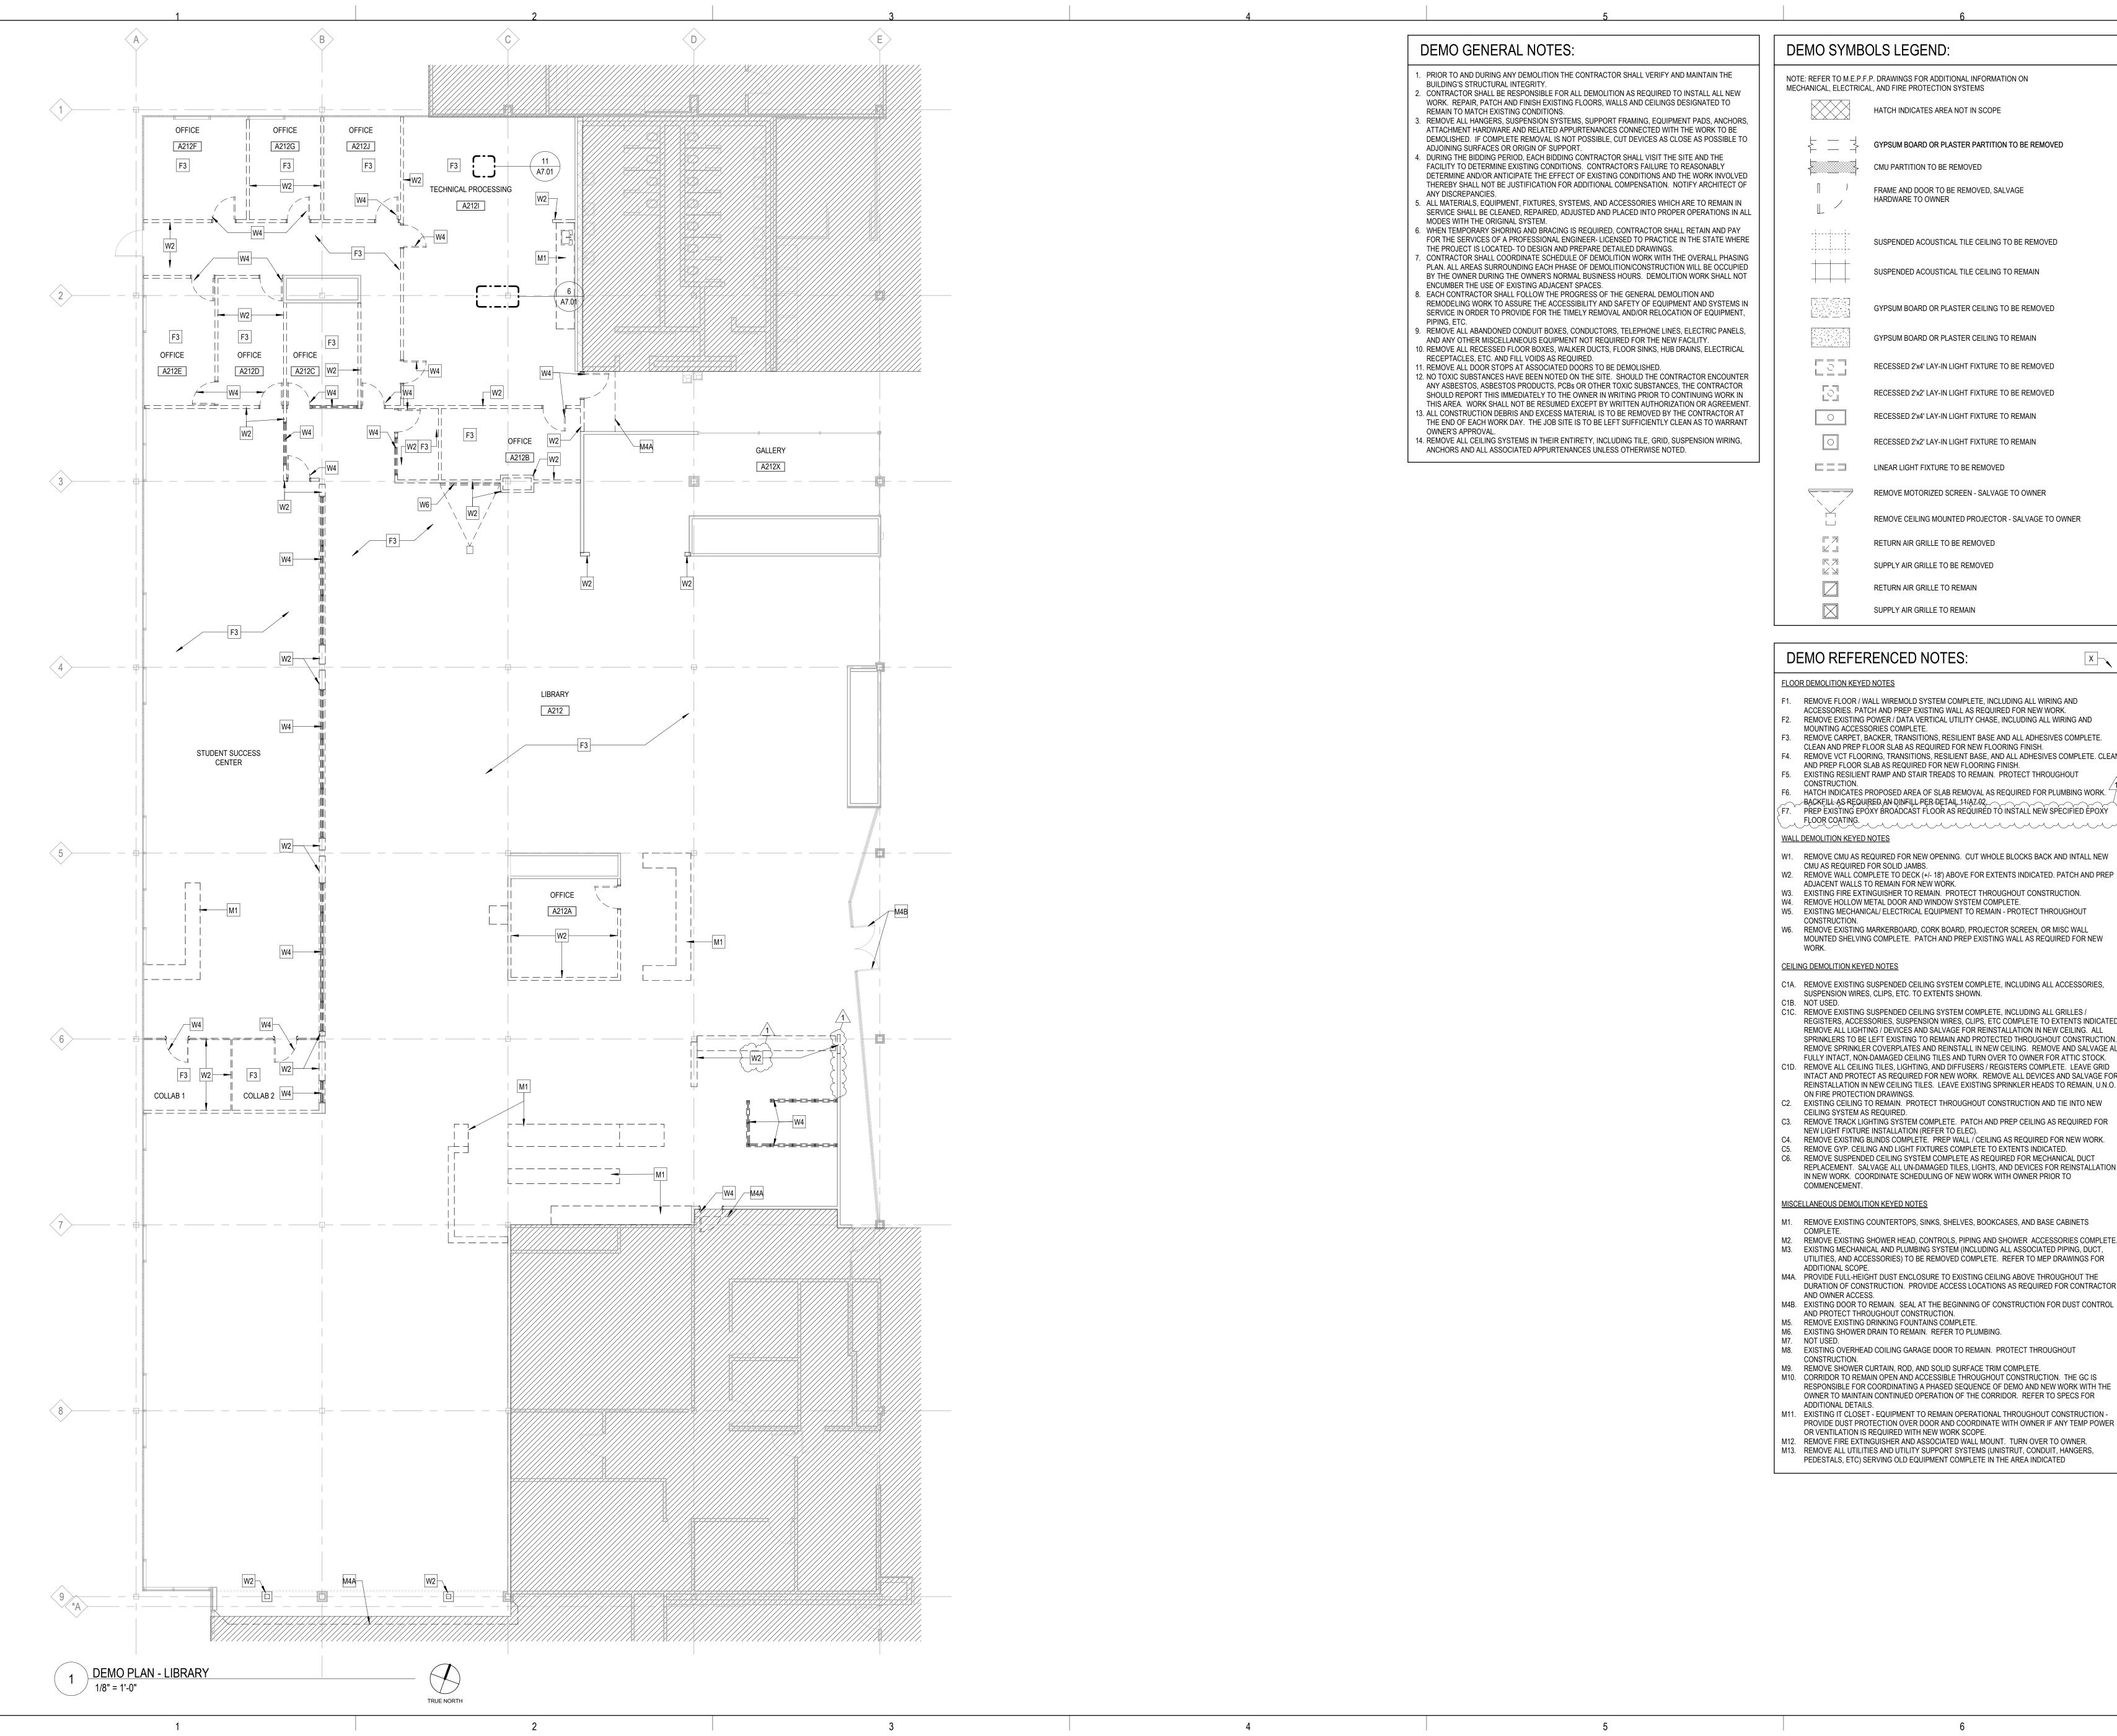
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SUSPENDED ACOUSTICAL TILE CEILING TO REMAIN

GYPSUM BOARD OR PLASTER CEILING TO BE REMOVED

GYPSUM BOARD OR PLASTER CEILING TO REMAIN

RECESSED 2'x2' LAY-IN LIGHT FIXTURE TO BE REMOVED

RECESSED 2'x2' LAY-IN LIGHT FIXTURE TO REMAIN

REMOVE MOTORIZED SCREEN - SALVAGE TO OWNER

RETURN AIR GRILLE TO BE REMOVED

SUPPLY AIR GRILLE TO BE REMOVED RETURN AIR GRILLE TO REMAIN

SUPPLY AIR GRILLE TO REMAIN

F1. REMOVE FLOOR / WALL WIREMOLD SYSTEM COMPLETE, INCLUDING ALL WIRING AND ACCESSORIES. PATCH AND PREP EXISTING WALL AS REQUIRED FOR NEW WORK.

- REMOVE EXISTING POWER / DATA VERTICAL UTILITY CHASE, INCLUDING ALL WIRING AND MOUNTING ACCESSORIES COMPLETE.
- REMOVE CARPET, BACKER, TRANSITIONS, RESILIENT BASE AND ALL ADHESIVES COMPLETE. CLEAN AND PREP FLOOR SLAB AS REQUIRED FOR NEW FLOORING FINISH.
- . REMOVE VCT FLOORING, TRANSITIONS, RESILIENT BASE, AND ALL ADHESIVES COMPLETE. CLEAN AND PREP FLOOR SLAB AS REQUIRED FOR NEW FLOORING FINISH.
- EXISTING RESILIENT RAMP AND STAIR TREADS TO REMAIN. PROTECT THROUGHOUT
- HATCH INDICATES PROPOSED AREA OF SLAB REMOVAL AS REQUIRED FOR PLUMBING WORK. BACKFILLAS REQUIRED AN DINFILL PER DETAIL 11/AZ 02. PŘEP EXISTING EPÓXY BROADCAST FLOOR AS REQUIRED TO INSTALL NEW SPECIFIED EPOXY
- FLOOR COATING.
- W1. REMOVE CMU AS REQUIRED FOR NEW OPENING. CUT WHOLE BLOCKS BACK AND INTALL NEW
- CMU AS REQUIRED FOR SOLID JAMBS. W2. REMOVE WALL COMPLETE TO DECK (+/- 18') ABOVE FOR EXTENTS INDICATED. PATCH AND PREP
- W3. EXISTING FIRE EXTINGUISHER TO REMAIN. PROTECT THROUGHOUT CONSTRUCTION. W4. REMOVE HOLLOW METAL DOOR AND WINDOW SYSTEM COMPLETE.
- W5. EXISTING MECHANICAL/ ELECTRICAL EQUIPMENT TO REMAIN PROTECT THROUGHOUT
- W6. REMOVE EXISTING MARKERBOARD, CORK BOARD, PROJECTOR SCREEN, OR MISC WALL MOUNTED SHELVING COMPLETE. PATCH AND PREP EXISTING WALL AS REQUIRED FOR NEW
- C1A. REMOVE EXISTING SUSPENDED CEILING SYSTEM COMPLETE, INCLUDING ALL ACCESSORIES, SUSPENSION WIRES, CLIPS, ETC. TO EXTENTS SHOWN.
- C1C. REMOVE EXISTING SUSPENDED CEILING SYSTEM COMPLETE, INCLUDING ALL GRILLES / REGISTERS, ACCESSORIES, SUSPENSION WIRES, CLIPS, ETC COMPLETE TO EXTENTS INDICATED. REMOVE ALL LIGHTING / DEVICES AND SALVAGE FOR REINSTALLATION IN NEW CEILING. ALL SPRINKLERS TO BE LEFT EXISTING TO REMAIN AND PROTECTED THROUGHOUT CONSTRUCTION.
- REMOVE SPRINKLER COVERPLATES AND REINSTALL IN NEW CEILING. REMOVE AND SALVAGE ALL FULLY INTACT, NON-DAMAGED CEILING TILES AND TURN OVER TO OWNER FOR ATTIC STOCK. REMOVE ALL CEILING TILES, LIGHTING, AND DIFFUSERS / REGISTERS COMPLETE. LEAVE GRID INTACT AND PROTECT AS REQUIRED FOR NEW WORK. REMOVE ALL DEVICES AND SALVAGE FOR REINSTALLATION IN NEW CEILING TILES. LEAVE EXISTING SPRINKLER HEADS TO REMAIN, U.N.O.
- C2. EXISTING CEILING TO REMAIN. PROTECT THROUGHOUT CONSTRUCTION AND TIE INTO NEW
- 3. REMOVE TRACK LIGHTING SYSTEM COMPLETE. PATCH AND PREP CEILING AS REQUIRED FOR NEW LIGHT FIXTURE INSTALLATION (REFER TO ELEC).
- C4. REMOVE EXISTING BLINDS COMPLETE. PREP WALL / CEILING AS REQUIRED FOR NEW WORK. C5. REMOVE GYP. CEILING AND LIGHT FIXTURES COMPLETE TO EXTENTS INDICATED. C6. REMOVE SUSPENDED CEILING SYSTEM COMPLETE AS REQUIRED FOR MECHANICAL DUCT REPLACEMENT. SALVAGE ALL UN-DAMAGED TILES, LIGHTS, AND DEVICES FOR REINSTALLATION IN NEW WORK. COORDINATE SCHEDULING OF NEW WORK WITH OWNER PRIOR TO

- M1. REMOVE EXISTING COUNTERTOPS, SINKS, SHELVES, BOOKCASES, AND BASE CABINETS
- M2. REMOVE EXISTING SHOWER HEAD, CONTROLS, PIPING AND SHOWER ACCESSORIES COMPLETE. M3. EXISTING MECHANICAL AND PLUMBING SYSTEM (INCLUDING ALL ASSOCIATED PIPING, DUCT, UTILITIES, AND ACCESSORIES) TO BE REMOVED COMPLETE. REFER TO MEP DRAWINGS FOR
- M4A. PROVIDE FULL-HEIGHT DUST ENCLOSURE TO EXISTING CEILING ABOVE THROUGHOUT THE DURATION OF CONSTRUCTION. PROVIDE ACCESS LOCATIONS AS REQUIRED FOR CONTRACTOR
- AND PROTECT THROUGHOUT CONSTRUCTION.
- M6. EXISTING SHOWER DRAIN TO REMAIN. REFER TO PLUMBING.
- M8. EXISTING OVERHEAD COILING GARAGE DOOR TO REMAIN. PROTECT THROUGHOUT
- M9. REMOVE SHOWER CURTAIN, ROD, AND SOLID SURFACE TRIM COMPLETE. M10. CORRIDOR TO REMAIN OPEN AND ACCESSIBLE THROUGHOUT CONSTRUCTION. THE GC IS RESPONSIBLE FOR COORDINATING A PHASED SEQUENCE OF DEMO AND NEW WORK WITH THE OWNER TO MAINTAIN CONTINUED OPERATION OF THE CORRIDOR. REFER TO SPECS FOR
- M11. EXISTING IT CLOSET EQUIPMENT TO REMAIN OPERATIONAL THROUGHOUT CONSTRUCTION -PROVIDE DUST PROTECTION OVER DOOR AND COORDINATE WITH OWNER IF ANY TEMP POWER
- OR VENTILATION IS REQUIRED WITH NEW WORK SCOPE. M12. REMOVE FIRE EXTINGUISHER AND ASSOCIATED WALL MOUNT. TURN OVER TO OWNER. M13. REMOVE ALL UTILITIES AND UTILITY SUPPORT SYSTEMS (UNISTRUT, CONDUIT, HANGERS,

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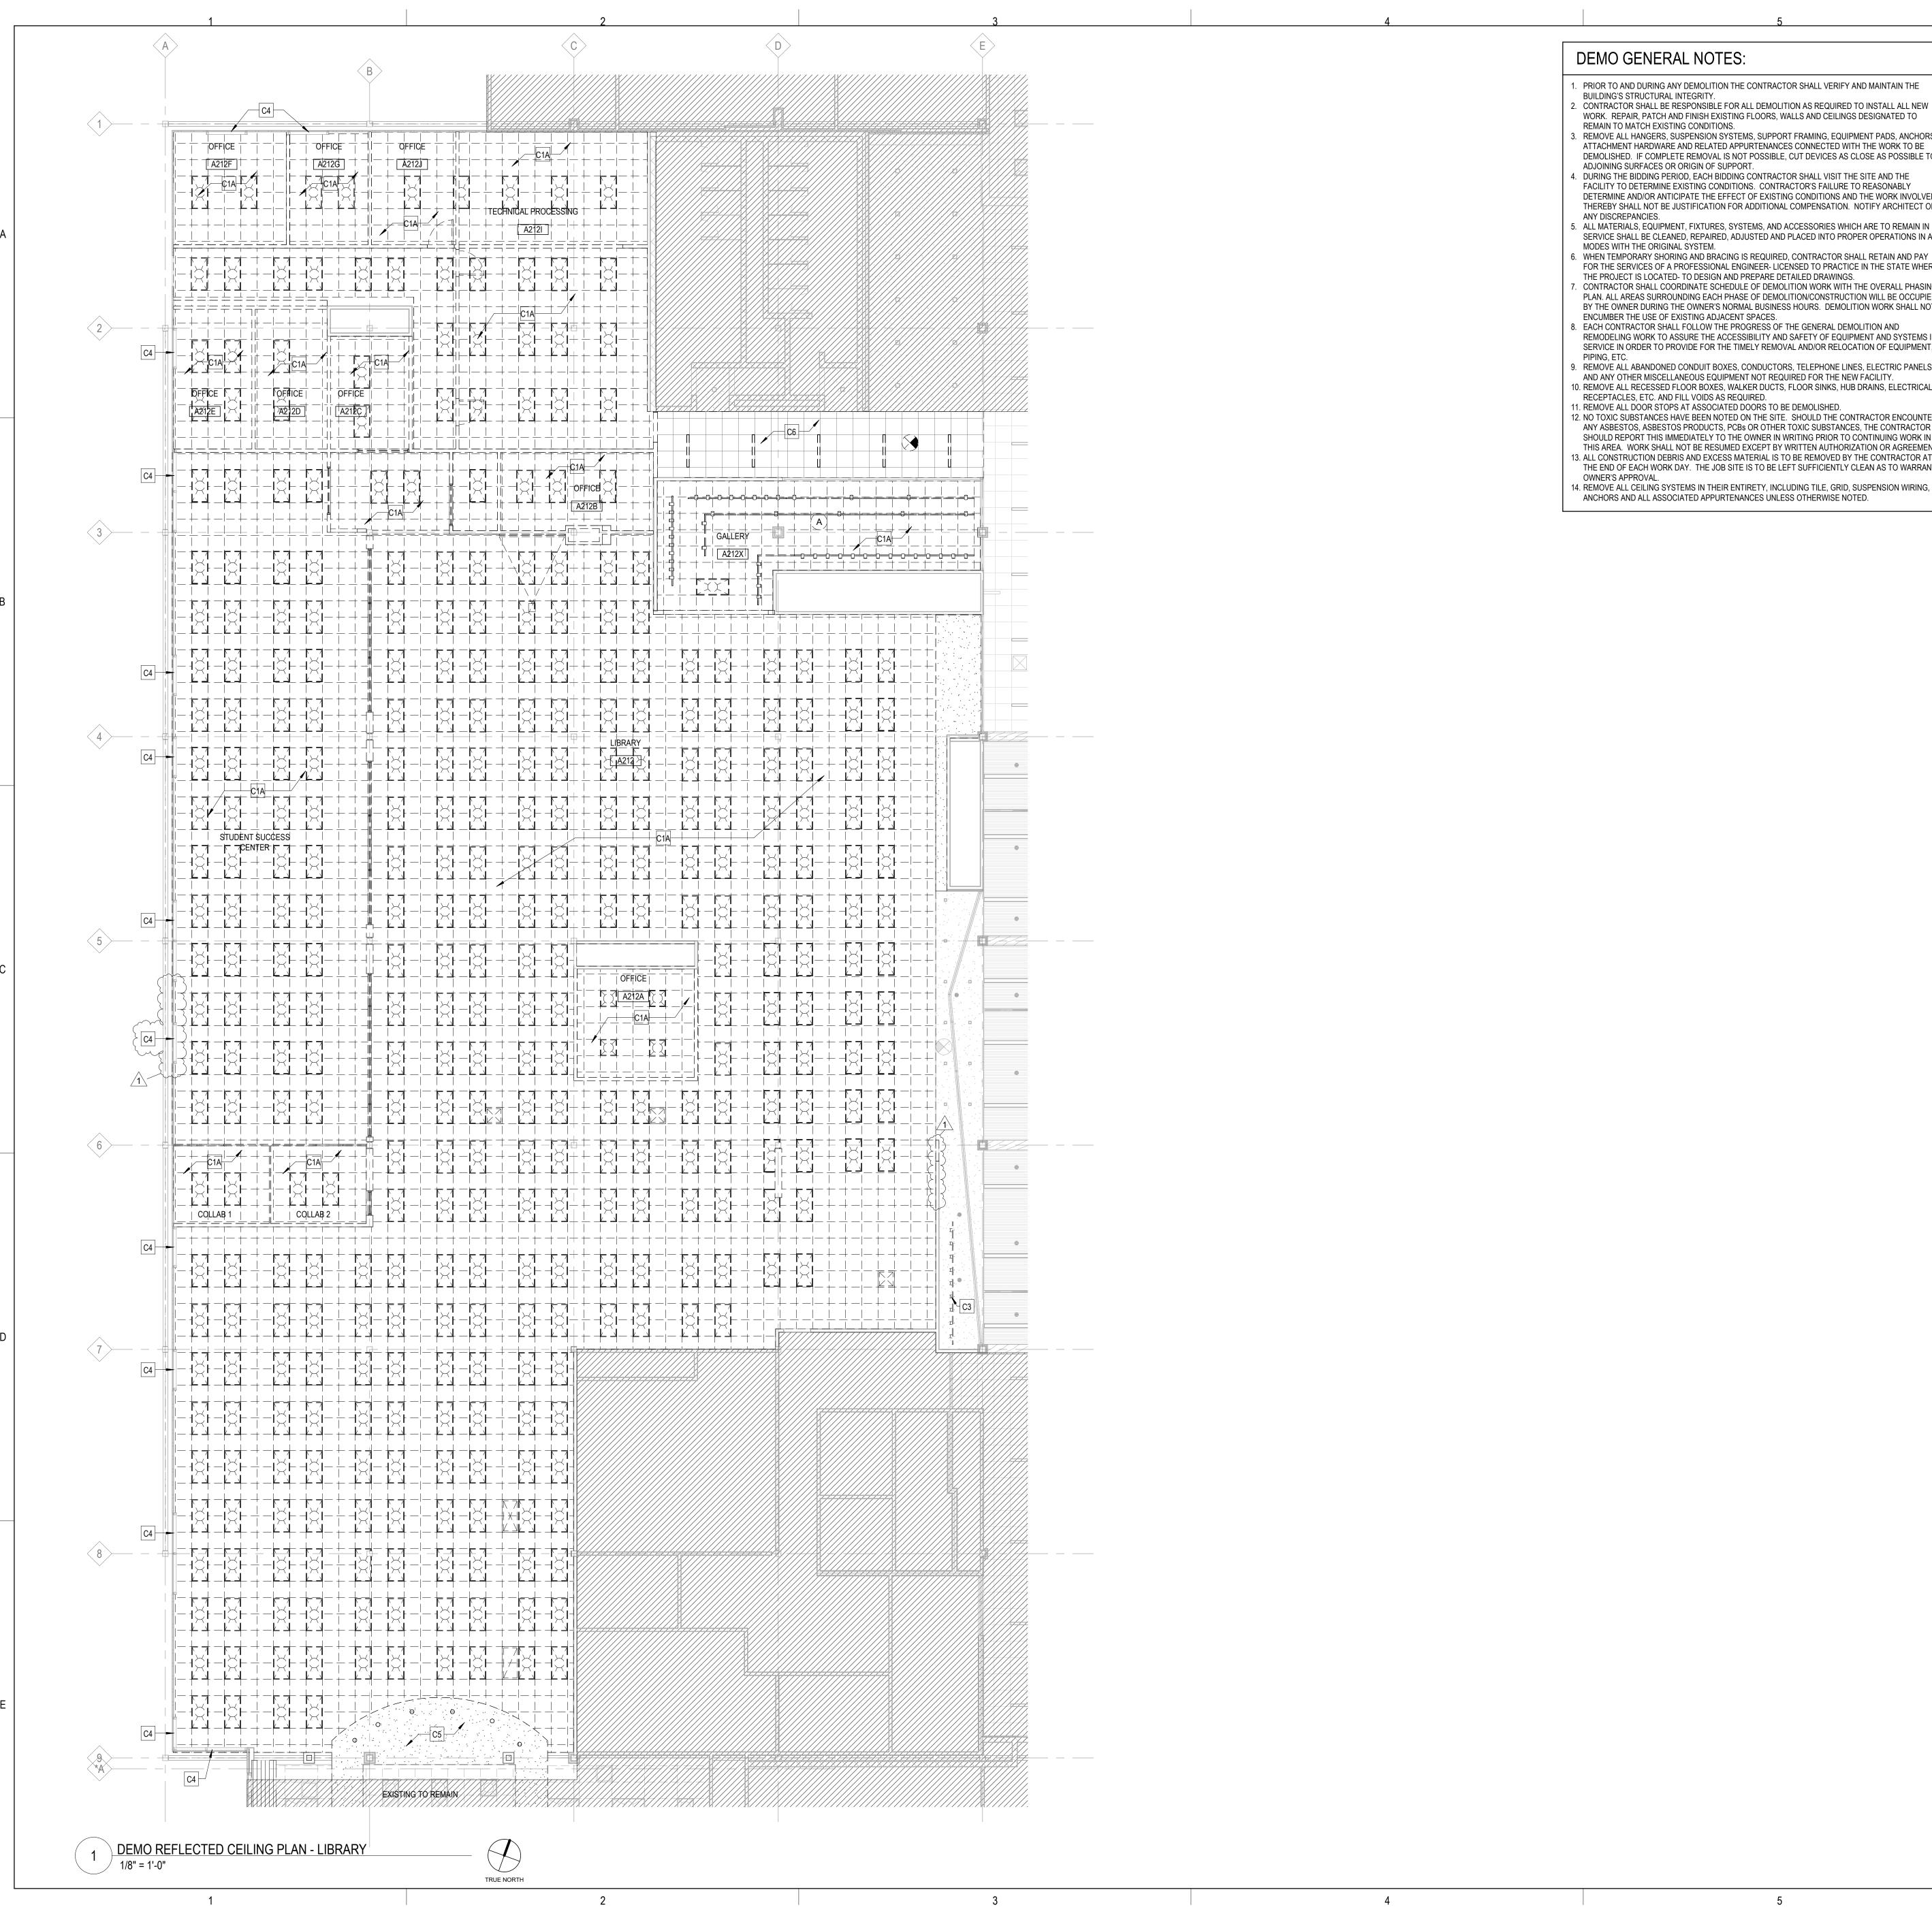
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PRIOR TO AND DURING ANY DEMOLITION THE CONTRACTOR SHALL VERIFY AND MAINTAIN THE BUILDING'S STRUCTURAL INTEGRITY. . CONTRACTOR SHALL BE RESPONSIBLE FOR ALL DEMOLITION AS REQUIRED TO INSTALL ALL NEW WORK. REPAIR, PATCH AND FINISH EXISTING FLOORS, WALLS AND CEILINGS DESIGNATED TO REMAIN TO MATCH EXISTING CONDITIONS. . REMOVE ALL HANGERS, SUSPENSION SYSTEMS, SUPPORT FRAMING, EQUIPMENT PADS, ANCHORS

ATTACHMENT HARDWARE AND RELATED APPURTENANCES CONNECTED WITH THE WORK TO BE DEMOLISHED. IF COMPLETE REMOVAL IS NOT POSSIBLE, CUT DEVICES AS CLOSE AS POSSIBLE TO ADJOINING SURFACES OR ORIGIN OF SUPPORT. . DURING THE BIDDING PERIOD. EACH BIDDING CONTRACTOR SHALL VISIT THE SITE AND THE FACILITY TO DETERMINE EXISTING CONDITIONS. CONTRACTOR'S FAILURE TO REASONABLY DETERMINE AND/OR ANTICIPATE THE EFFECT OF EXISTING CONDITIONS AND THE WORK INVOLVED

THEREBY SHALL NOT BE JUSTIFICATION FOR ADDITIONAL COMPENSATION. NOTIFY ARCHITECT OF 5. ALL MATERIALS, EQUIPMENT, FIXTURES, SYSTEMS, AND ACCESSORIES WHICH ARE TO REMAIN IN SERVICE SHALL BE CLEANED, REPAIRED, ADJUSTED AND PLACED INTO PROPER OPERATIONS IN ALL

. WHEN TEMPORARY SHORING AND BRACING IS REQUIRED, CONTRACTOR SHALL RETAIN AND PAY FOR THE SERVICES OF A PROFESSIONAL ENGINEER- LICENSED TO PRACTICE IN THE STATE WHERE THE PROJECT IS LOCATED- TO DESIGN AND PREPARE DETAILED DRAWINGS CONTRACTOR SHALL COORDINATE SCHEDULE OF DEMOLITION WORK WITH THE OVERALL PHASING PLAN. ALL AREAS SURROUNDING EACH PHASE OF DEMOLITION/CONSTRUCTION WILL BE OCCUPIED BY THE OWNER DURING THE OWNER'S NORMAL BUSINESS HOURS. DEMOLITION WORK SHALL NOT ENCUMBER THE USE OF EXISTING ADJACENT SPACES.

. EACH CONTRACTOR SHALL FOLLOW THE PROGRESS OF THE GENERAL DEMOLITION AND REMODELING WORK TO ASSURE THE ACCESSIBILITY AND SAFETY OF EQUIPMENT AND SYSTEMS IN SERVICE IN ORDER TO PROVIDE FOR THE TIMELY REMOVAL AND/OR RELOCATION OF EQUIPMENT, REMOVE ALL ABANDONED CONDUIT BOXES, CONDUCTORS, TELEPHONE LINES, ELECTRIC PANELS, AND ANY OTHER MISCELLANEOUS EQUIPMENT NOT REQUIRED FOR THE NEW FACILITY. 10. REMOVE ALL RECESSED FLOOR BOXES, WALKER DUCTS, FLOOR SINKS, HUB DRAINS, ELECTRICAL

12. NO TOXIC SUBSTANCES HAVE BEEN NOTED ON THE SITE. SHOULD THE CONTRACTOR ENCOUNTER ANY ASBESTOS, ASBESTOS PRODUCTS, PCBs OR OTHER TOXIC SUBSTANCES, THE CONTRACTOR SHOULD REPORT THIS IMMEDIATELY TO THE OWNER IN WRITING PRIOR TO CONTINUING WORK IN THIS AREA. WORK SHALL NOT BE RESUMED EXCEPT BY WRITTEN AUTHORIZATION OR AGREEMENT. 3. ALL CONSTRUCTION DEBRIS AND EXCESS MATERIAL IS TO BE REMOVED BY THE CONTRACTOR AT THE END OF EACH WORK DAY. THE JOB SITE IS TO BE LEFT SUFFICIENTLY CLEAN AS TO WARRANT

ANCHORS AND ALL ASSOCIATED APPURTENANCES UNLESS OTHERWISE NOTED.

DEMO SYMBOLS LEGEND:

NOTE: REFER TO M.E.P.F.P. DRAWINGS FOR ADDITIONAL INFORMATION ON MECHANICAL, ELECTRICAL, AND FIRE PROTECTION SYSTEMS HATCH INDICATES AREA NOT IN SCOPE GYPSUM BOARD OR PLASTER PARTITION TO BE REMOVED CMU PARTITION TO BE REMOVED

FRAME AND DOOR TO BE REMOVED, SALVAGE HARDWARE TO OWNER

SUSPENDED ACOUSTICAL TILE CEILING TO BE REMOVED

SUSPENDED ACOUSTICAL TILE CEILING TO REMAIN

GYPSUM BOARD OR PLASTER CEILING TO BE REMOVED

GYPSUM BOARD OR PLASTER CEILING TO REMAIN RECESSED 2'x4' LAY-IN LIGHT FIXTURE TO BE REMOVED

RECESSED 2'x2' LAY-IN LIGHT FIXTURE TO BE REMOVED

RECESSED 2'x4' LAY-IN LIGHT FIXTURE TO REMAIN RECESSED 2'x2' LAY-IN LIGHT FIXTURE TO REMAIN

LINEAR LIGHT FIXTURE TO BE REMOVED REMOVE MOTORIZED SCREEN - SALVAGE TO OWNER REMOVE CEILING MOUNTED PROJECTOR - SALVAGE TO OWNER

RETURN AIR GRILLE TO BE REMOVED $\sqsubseteq \bot$ SUPPLY AIR GRILLE TO BE REMOVED $\sqsubseteq \supseteq$

RETURN AIR GRILLE TO REMAIN SUPPLY AIR GRILLE TO REMAIN

DEMO REFERENCED NOTES:

FLOOR DEMOLITION KEYED NOTES

F1. REMOVE FLOOR / WALL WIREMOLD SYSTEM COMPLETE, INCLUDING ALL WIRING AND

ACCESSORIES. PATCH AND PREP EXISTING WALL AS REQUIRED FOR NEW WORK. REMOVE EXISTING POWER / DATA VERTICAL UTILITY CHASE. INCLUDING ALL WIRING AND MOUNTING ACCESSORIES COMPLETE.

REMOVE CARPET. BACKER. TRANSITIONS, RESILIENT BASE AND ALL ADHESIVES COMPLETE. CLEAN AND PREP FLOOR SLAB AS REQUIRED FOR NEW FLOORING FINISH.

REMOVE VCT FLOORING, TRANSITIONS, RESILIENT BASE, AND ALL ADHESIVES COMPLETE. CLEAN AND PREP FLOOR SLAB AS REQUIRED FOR NEW FLOORING FINISH.

EXISTING RESILIENT RAMP AND STAIR TREADS TO REMAIN. PROTECT THROUGHOUT HATCH INDICATES PROPOSED AREA OF SLAB REMOVAL AS REQUIRED FOR PLUMBING WORK. BACKFILL-AS-REQUIRED AN DINFILL PER DETAIL 14/A7.02

PREP EXISTING EPOXY BROADCAST FLOOR AS REQUIRED TO INSTALL NEW SPECIFIED EPOXY FLOOR COATING.

WALL DEMOLITION KEYED NOTES

W1. REMOVE CMU AS REQUIRED FOR NEW OPENING. CUT WHOLE BLOCKS BACK AND INTALL NEW CMU AS REQUIRED FOR SOLID JAMBS. W2. REMOVE WALL COMPLETE TO DECK (+/- 18') ABOVE FOR EXTENTS INDICATED. PATCH AND PREP

ADJACENT WALLS TO REMAIN FOR NEW WORK. W3. EXISTING FIRE EXTINGUISHER TO REMAIN. PROTECT THROUGHOUT CONSTRUCTION. W4. REMOVE HOLLOW METAL DOOR AND WINDOW SYSTEM COMPLETE.

W5. EXISTING MECHANICAL/ ELECTRICAL EQUIPMENT TO REMAIN - PROTECT THROUGHOUT W6. REMOVE EXISTING MARKERBOARD. CORK BOARD. PROJECTOR SCREEN. OR MISC WALL MOUNTED SHELVING COMPLETE. PATCH AND PREP EXISTING WALL AS REQUIRED FOR NEW

CEILING DEMOLITION KEYED NOTES

C1A. REMOVE EXISTING SUSPENDED CEILING SYSTEM COMPLETE, INCLUDING ALL ACCESSORIES, SUSPENSION WIRES, CLIPS, ETC. TO EXTENTS SHOWN.

C1B. NOT USED. C1C. REMOVE EXISTING SUSPENDED CEILING SYSTEM COMPLETE, INCLUDING ALL GRILLES / REGISTERS, ACCESSORIES, SUSPENSION WIRES, CLIPS, ETC COMPLETE TO EXTENTS INDICATED. REMOVE ALL LIGHTING / DEVICES AND SALVAGE FOR REINSTALLATION IN NEW CEILING. ALL REMOVE SPRINKLER COVERPLATES AND REINSTALL IN NEW CEILING. REMOVE AND SALVAGE ALL

FULLY INTACT, NON-DAMAGED CEILING TILES AND TURN OVER TO OWNER FOR ATTIC STOCK. REMOVE ALL CEILING TILES, LIGHTING, AND DIFFUSERS / REGISTERS COMPLETE. LEAVE GRID INTACT AND PROTECT AS REQUIRED FOR NEW WORK. REMOVE ALL DEVICES AND SALVAGE FOR REINSTALLATION IN NEW CEILING TILES. LEAVE EXISTING SPRINKLER HEADS TO REMAIN, U.N.O. ON FIRE PROTECTION DRAWINGS.

C2. EXISTING CEILING TO REMAIN. PROTECT THROUGHOUT CONSTRUCTION AND TIE INTO NEW CEILING SYSTEM AS REQUIRED. REMOVE TRACK LIGHTING SYSTEM COMPLETE. PATCH AND PREP CEILING AS REQUIRED FOR

NEW LIGHT FIXTURE INSTALLATION (REFER TO ELEC). REMOVE EXISTING BLINDS COMPLETE. PREP WALL / CEILING AS REQUIRED FOR NEW WORK. C5. REMOVE GYP. CEILING AND LIGHT FIXTURES COMPLETE TO EXTENTS INDICATED. 6. REMOVE SUSPENDED CEILING SYSTEM COMPLETE AS REQUIRED FOR MECHANICAL DUCT REPLACEMENT. SALVAGE ALL UN-DAMAGED TILES, LIGHTS, AND DEVICES FOR REINSTALLATION IN NEW WORK. COORDINATE SCHEDULING OF NEW WORK WITH OWNER PRIOR TO

COMMENCEMENT. MISCELLANEOUS DEMOLITION KEYED NOTES

M1. REMOVE EXISTING COUNTERTOPS, SINKS, SHELVES, BOOKCASES, AND BASE CABINETS

M2. REMOVE EXISTING SHOWER HEAD, CONTROLS, PIPING AND SHOWER ACCESSORIES COMPLETE. M3. EXISTING MECHANICAL AND PLUMBING SYSTEM (INCLUDING ALL ASSOCIATED PIPING, DUCT, UTILITIES, AND ACCESSORIES) TO BE REMOVED COMPLETE. REFER TO MEP DRAWINGS FOR ADDITIONAL SCOPE.

M4A. PROVIDE FULL-HEIGHT DUST ENCLOSURE TO EXISTING CEILING ABOVE THROUGHOUT THE DURATION OF CONSTRUCTION. PROVIDE ACCESS LOCATIONS AS REQUIRED FOR CONTRACTOR AND OWNER ACCESS. M4B. EXISTING DOOR TO REMAIN. SEAL AT THE BEGINNING OF CONSTRUCTION FOR DUST CONTROL

AND PROTECT THROUGHOUT CONSTRUCTION. M5. REMOVE EXISTING DRINKING FOUNTAINS COMPLETE.

M6. EXISTING SHOWER DRAIN TO REMAIN. REFER TO PLUMBING. M7. NOT USED. M8. EXISTING OVERHEAD COILING GARAGE DOOR TO REMAIN. PROTECT THROUGHOUT

CONSTRUCTION. M9. REMOVE SHOWER CURTAIN, ROD, AND SOLID SURFACE TRIM COMPLETE. M10. CORRIDOR TO REMAIN OPEN AND ACCESSIBLE THROUGHOUT CONSTRUCTION. THE GC IS RESPONSIBLE FOR COORDINATING A PHASED SEQUENCE OF DEMO AND NEW WORK WITH THE OWNER TO MAINTAIN CONTINUED OPERATION OF THE CORRIDOR. REFER TO SPECS FOR ADDITIONAL DETAILS.

M11. EXISTING IT CLOSET - EQUIPMENT TO REMAIN OPERATIONAL THROUGHOUT CONSTRUCTION -PROVIDE DUST PROTECTION OVER DOOR AND COORDINATE WITH OWNER IF ANY TEMP POWER OR VENTILATION IS REQUIRED WITH NEW WORK SCOPE.

M12. REMOVE FIRE EXTINGUISHER AND ASSOCIATED WALL MOUNT. TURN OVER TO OWNER. M13. REMOVE ALL UTILITIES AND UTILITY SUPPORT SYSTEMS (UNISTRUT, CONDUIT, HANGERS, PEDESTALS, ETC) SERVING OLD EQUIPMENT COMPLETE IN THE AREA INDICATED

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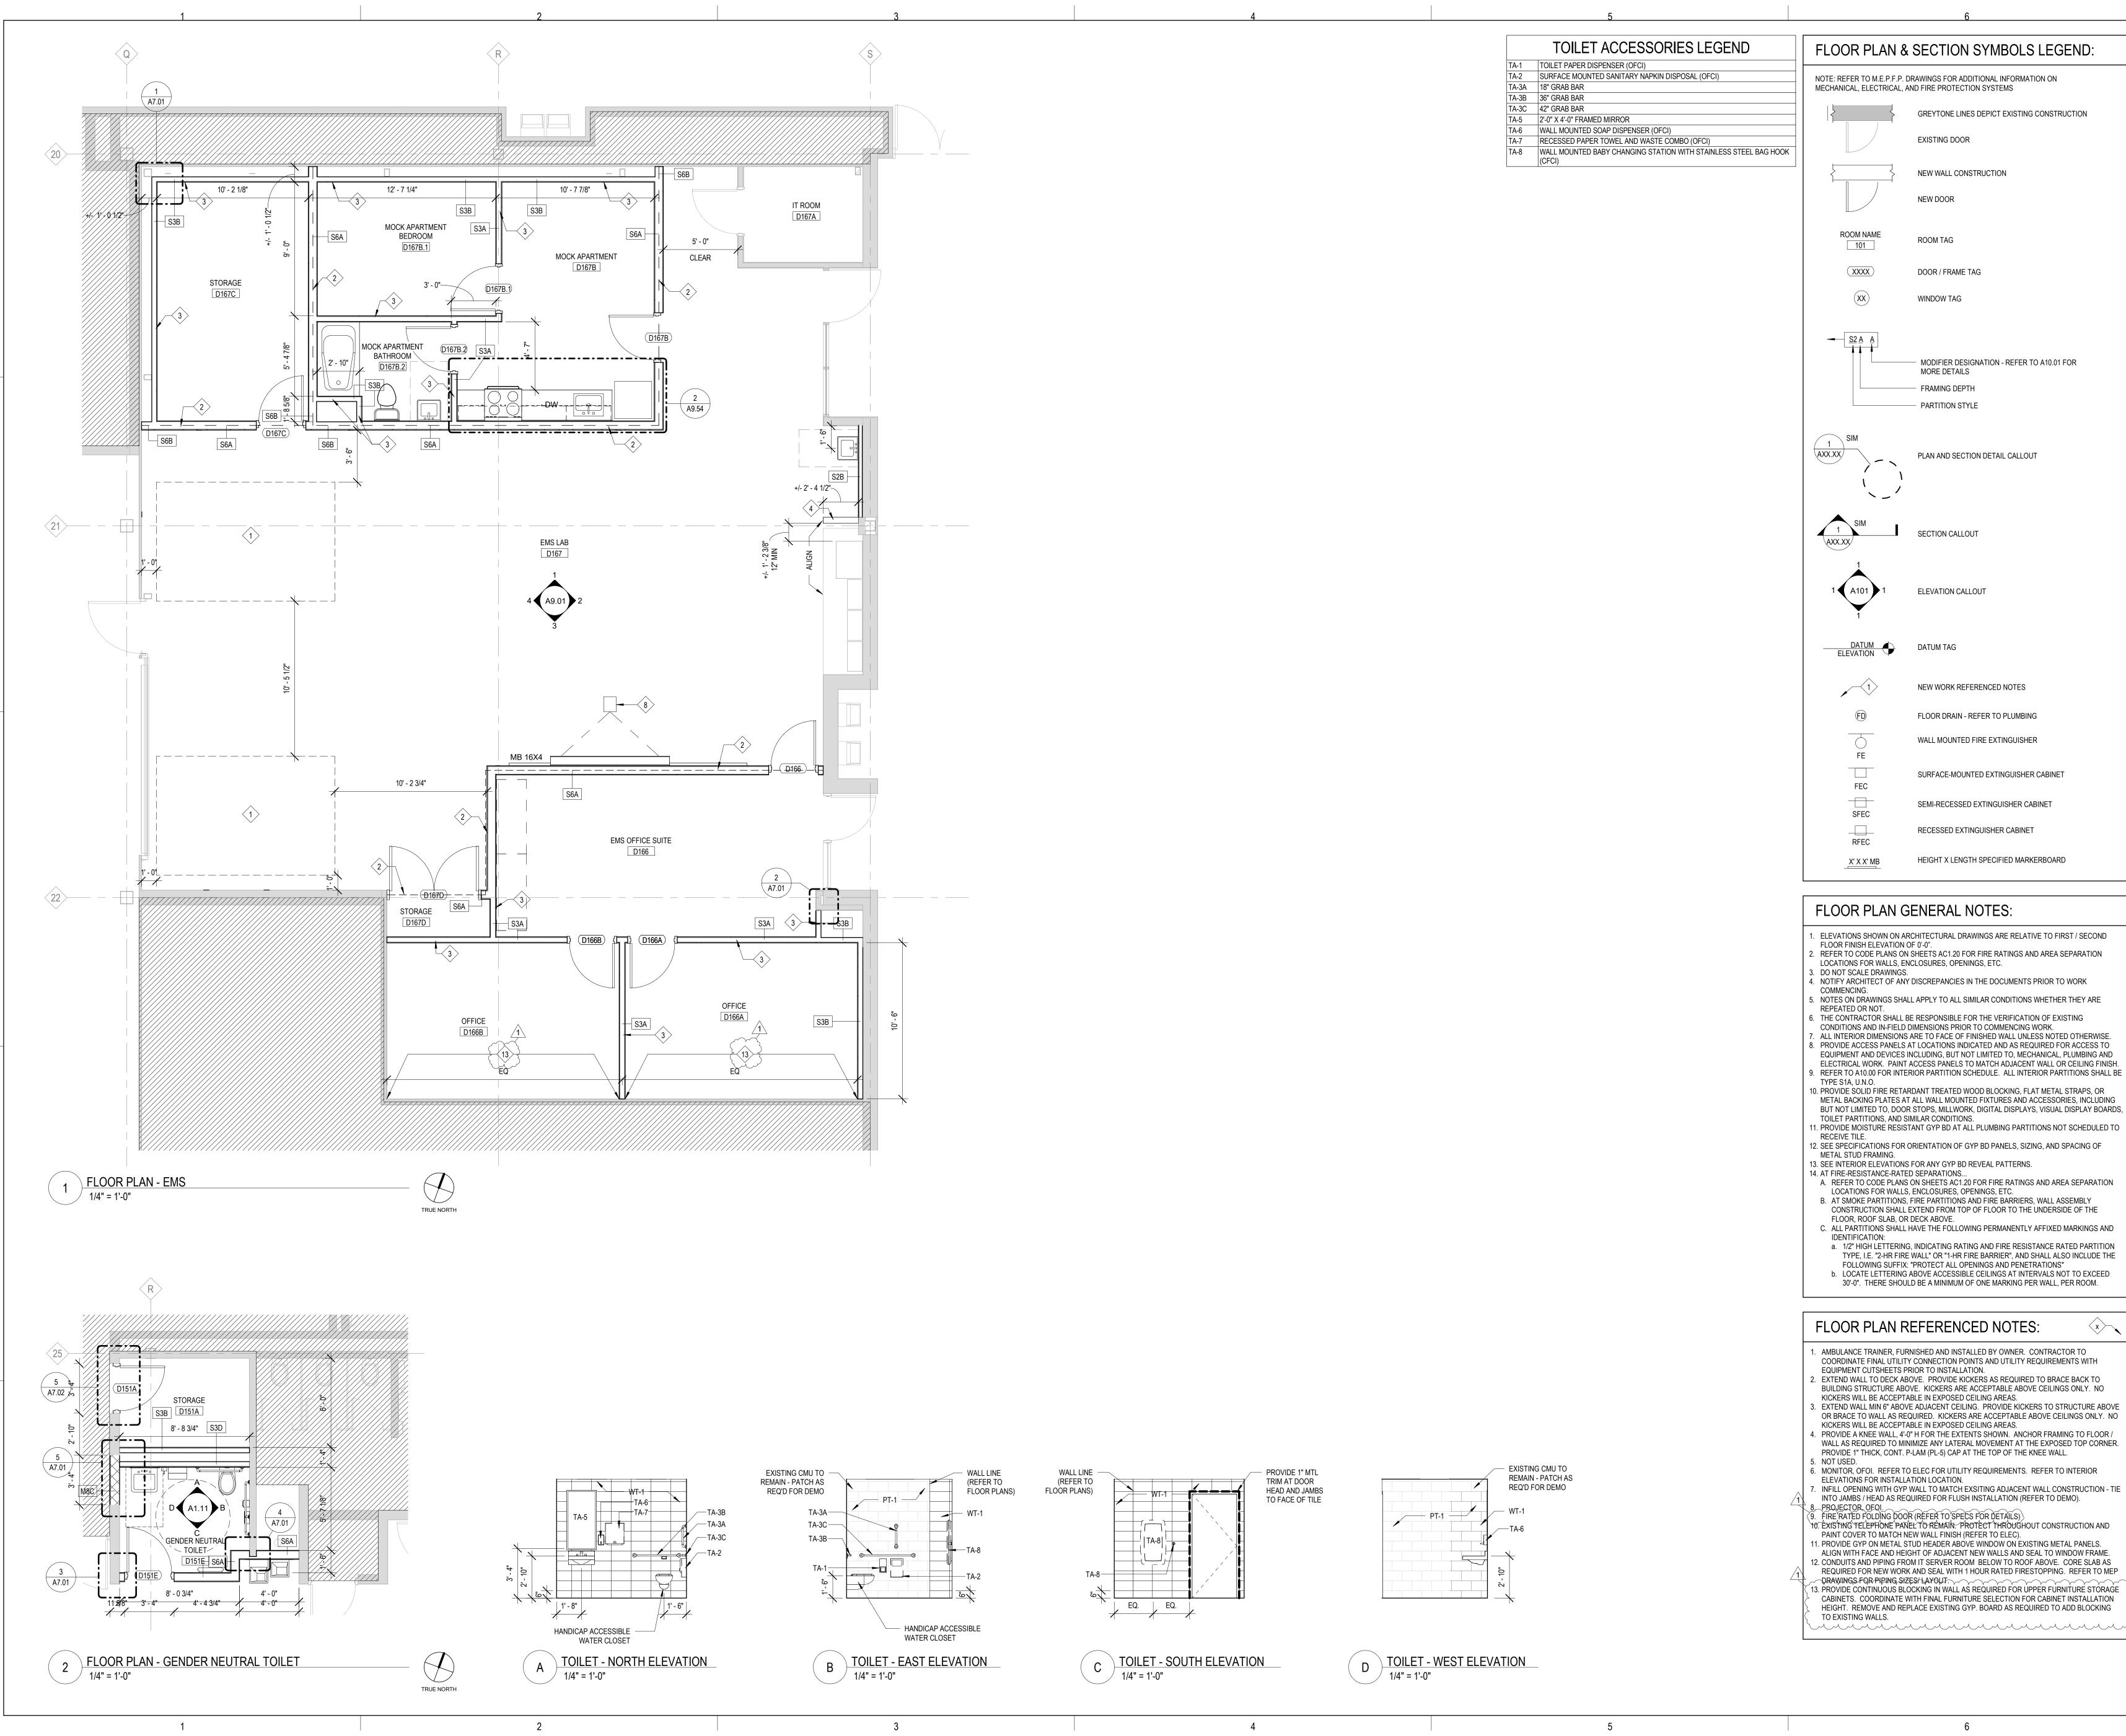
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ELEVATIONS SHOWN ON ARCHITECTURAL DRAWINGS ARE RELATIVE TO FIRST / SECOND FLOOR FINISH ELEVATION OF 0'-0". 2. REFER TO CODE PLANS ON SHEETS AC1.20 FOR FIRE RATINGS AND AREA SEPARATION

WALL MOUNTED FIRE EXTINGUISHER

SURFACE-MOUNTED EXTINGUISHER CABINET

SEMI-RECESSED EXTINGUISHER CABINET

I. NOTIFY ARCHITECT OF ANY DISCREPANCIES IN THE DOCUMENTS PRIOR TO WORK

5. NOTES ON DRAWINGS SHALL APPLY TO ALL SIMILAR CONDITIONS WHETHER THEY ARE

EXISTING DOOR

NEW DOOR

MORE DETAILS

- FRAMING DEPTH - PARTITION STYLE

MODIFIER DESIGNATION - REFER TO A10.01 FOR

6. THE CONTRACTOR SHALL BE RESPONSIBLE FOR THE VERIFICATION OF EXISTING CONDITIONS AND IN-FIELD DIMENSIONS PRIOR TO COMMENCING WORK.

ALL INTERIOR DIMENSIONS ARE TO FACE OF FINISHED WALL UNLESS NOTED OTHERWISE. B. PROVIDE ACCESS PANELS AT LOCATIONS INDICATED AND AS REQUIRED FOR ACCESS TO EQUIPMENT AND DEVICES INCLUDING, BUT NOT LIMITED TO, MECHANICAL, PLUMBING AND ELECTRICAL WORK. PAINT ACCESS PANELS TO MATCH ADJACENT WALL OR CEILING FINISH.

9. REFER TO A10.00 FOR INTERIOR PARTITION SCHEDULE. ALL INTERIOR PARTITIONS SHALL BE 0. PROVIDE SOLID FIRE RETARDANT TREATED WOOD BLOCKING, FLAT METAL STRAPS, OR METAL BACKING PLATES AT ALL WALL MOUNTED FIXTURES AND ACCESSORIES, INCLUDING

BUT NOT LIMITED TO, DOOR STOPS, MILLWORK, DIGITAL DISPLAYS, VISUAL DISPLAY BOARDS, TOILET PARTITIONS, AND SIMILAR CONDITIONS. 1. PROVIDE MOISTURE RESISTANT GYP BD AT ALL PLUMBING PARTITIONS NOT SCHEDULED TO

12. SEE SPECIFICATIONS FOR ORIENTATION OF GYP BD PANELS, SIZING, AND SPACING OF

13. SEE INTERIOR ELEVATIONS FOR ANY GYP BD REVEAL PATTERNS. 14. AT FIRE-RESISTANCE-RATED SEPARATIONS...

A. REFER TO CODE PLANS ON SHEETS AC1.20 FOR FIRE RATINGS AND AREA SEPARATION LOCATIONS FOR WALLS, ENCLOSURES, OPENINGS, ETC. B. AT SMOKE PARTITIONS, FIRE PARTITIONS AND FIRE BARRIERS, WALL ASSEMBLY CONSTRUCTION SHALL EXTEND FROM TOP OF FLOOR TO THE UNDERSIDE OF THE FLOOR, ROOF SLAB, OR DECK ABOVE.

C. ALL PARTITIONS SHALL HAVE THE FOLLOWING PERMANENTLY AFFIXED MARKINGS AND a. 1/2" HIGH LETTERING, INDICATING RATING AND FIRE RESISTANCE RATED PARTITION TYPE, I.E. "2-HR FIRE WALL" OR "1-HR FIRE BARRIER", AND SHALL ALSO INCLUDE THE FOLLOWING SUFFIX: "PROTECT ALL OPENINGS AND PENETRATIONS" b. LOCATE LETTERING ABOVE ACCESSIBLE CEILINGS AT INTERVALS NOT TO EXCEED

FLOOR PLAN REFERENCED NOTES:

- AMBULANCE TRAINER, FURNISHED AND INSTALLED BY OWNER. CONTRACTOR TO COORDINATE FINAL UTILITY CONNECTION POINTS AND UTILITY REQUIREMENTS WITH EQUIPMENT CUTSHEETS PRIOR TO INSTALLATION. EXTEND WALL TO DECK ABOVE. PROVIDE KICKERS AS REQUIRED TO BRACE BACK TO
- BUILDING STRUCTURE ABOVE. KICKERS ARE ACCEPTABLE ABOVE CEILINGS ONLY. NO KICKERS WILL BE ACCEPTABLE IN EXPOSED CEILING AREAS.
- EXTEND WALL MIN 6" ABOVE ADJACENT CEILING. PROVIDE KICKERS TO STRUCTURE ABOVE OR BRACE TO WALL AS REQUIRED. KICKERS ARE ACCEPTABLE ABOVE CEILINGS ONLY. NO KICKERS WILL BE ACCEPTABLE IN EXPOSED CEILING AREAS. . PROVIDE A KNEE WALL, 4'-0" H FOR THE EXTENTS SHOWN. ANCHOR FRAMING TO FLOOR / WALL AS REQUIRED TO MINIMIZE ANY LATERAL MOVEMENT AT THE EXPOSED TOP CORNER.
- PROVIDE 1" THICK, CONT. P-LAM (PL-5) CAP AT THE TOP OF THE KNEE WALL. 6. MONITOR, OFOI. REFER TO ELEC FOR UTILITY REQUIREMENTS. REFER TO INTERIOR
- ELEVATIONS FOR INSTALLATION LOCATION. . INFILL OPENING WITH GYP WALL TO MATCH EXSITING ADJACENT WALL CONSTRUCTION - TIE
- INTO JAMBS / HEAD AS REQUIRED FOR FLUSH INSTALLATION (REFER TO DEMO). (9. FIRE RATED FOLDING DOOR (REFER TO SPECS FOR DETAILS))
- 10. EXISTING TELEPHONE PANEL TO REMAIN. PROTECT THROUGHOUT CONSTRUCTION AND PAINT COVER TO MATCH NEW WALL FINISH (REFER TO ELEC). 11. PROVIDE GYP ON METAL STUD HEADER ABOVE WINDOW ON EXISTING METAL PANELS. ALIGN WITH FACE AND HEIGHT OF ADJACENT NEW WALLS AND SEAL TO WINDOW FRAME.
- 12. CONDUITS AND PIPING FROM IT SERVER ROOM BELOW TO ROOF ABOVE. CORE SLAB AS REQUIRED FOR NEW WORK AND SEAL WITH 1 HOUR RATED FIRESTOPPING. REFER TO MEP - DRAWINGS FOR PIPING SIZES/LAYOUT. 3. PROVIDE CONTINUOUS BLOCKING IN WALL AS REQUIRED FOR UPPER FURNITURE STORAGE CABINETS. COORDINATE WITH FINAL FURNITURE SELECTION FOR CABINET INSTALLATION HEIGHT. REMOVE AND REPLACE EXISTING GYP. BOARD AS REQUIRED TO ADD BLOCKING

FLOOR PLANS

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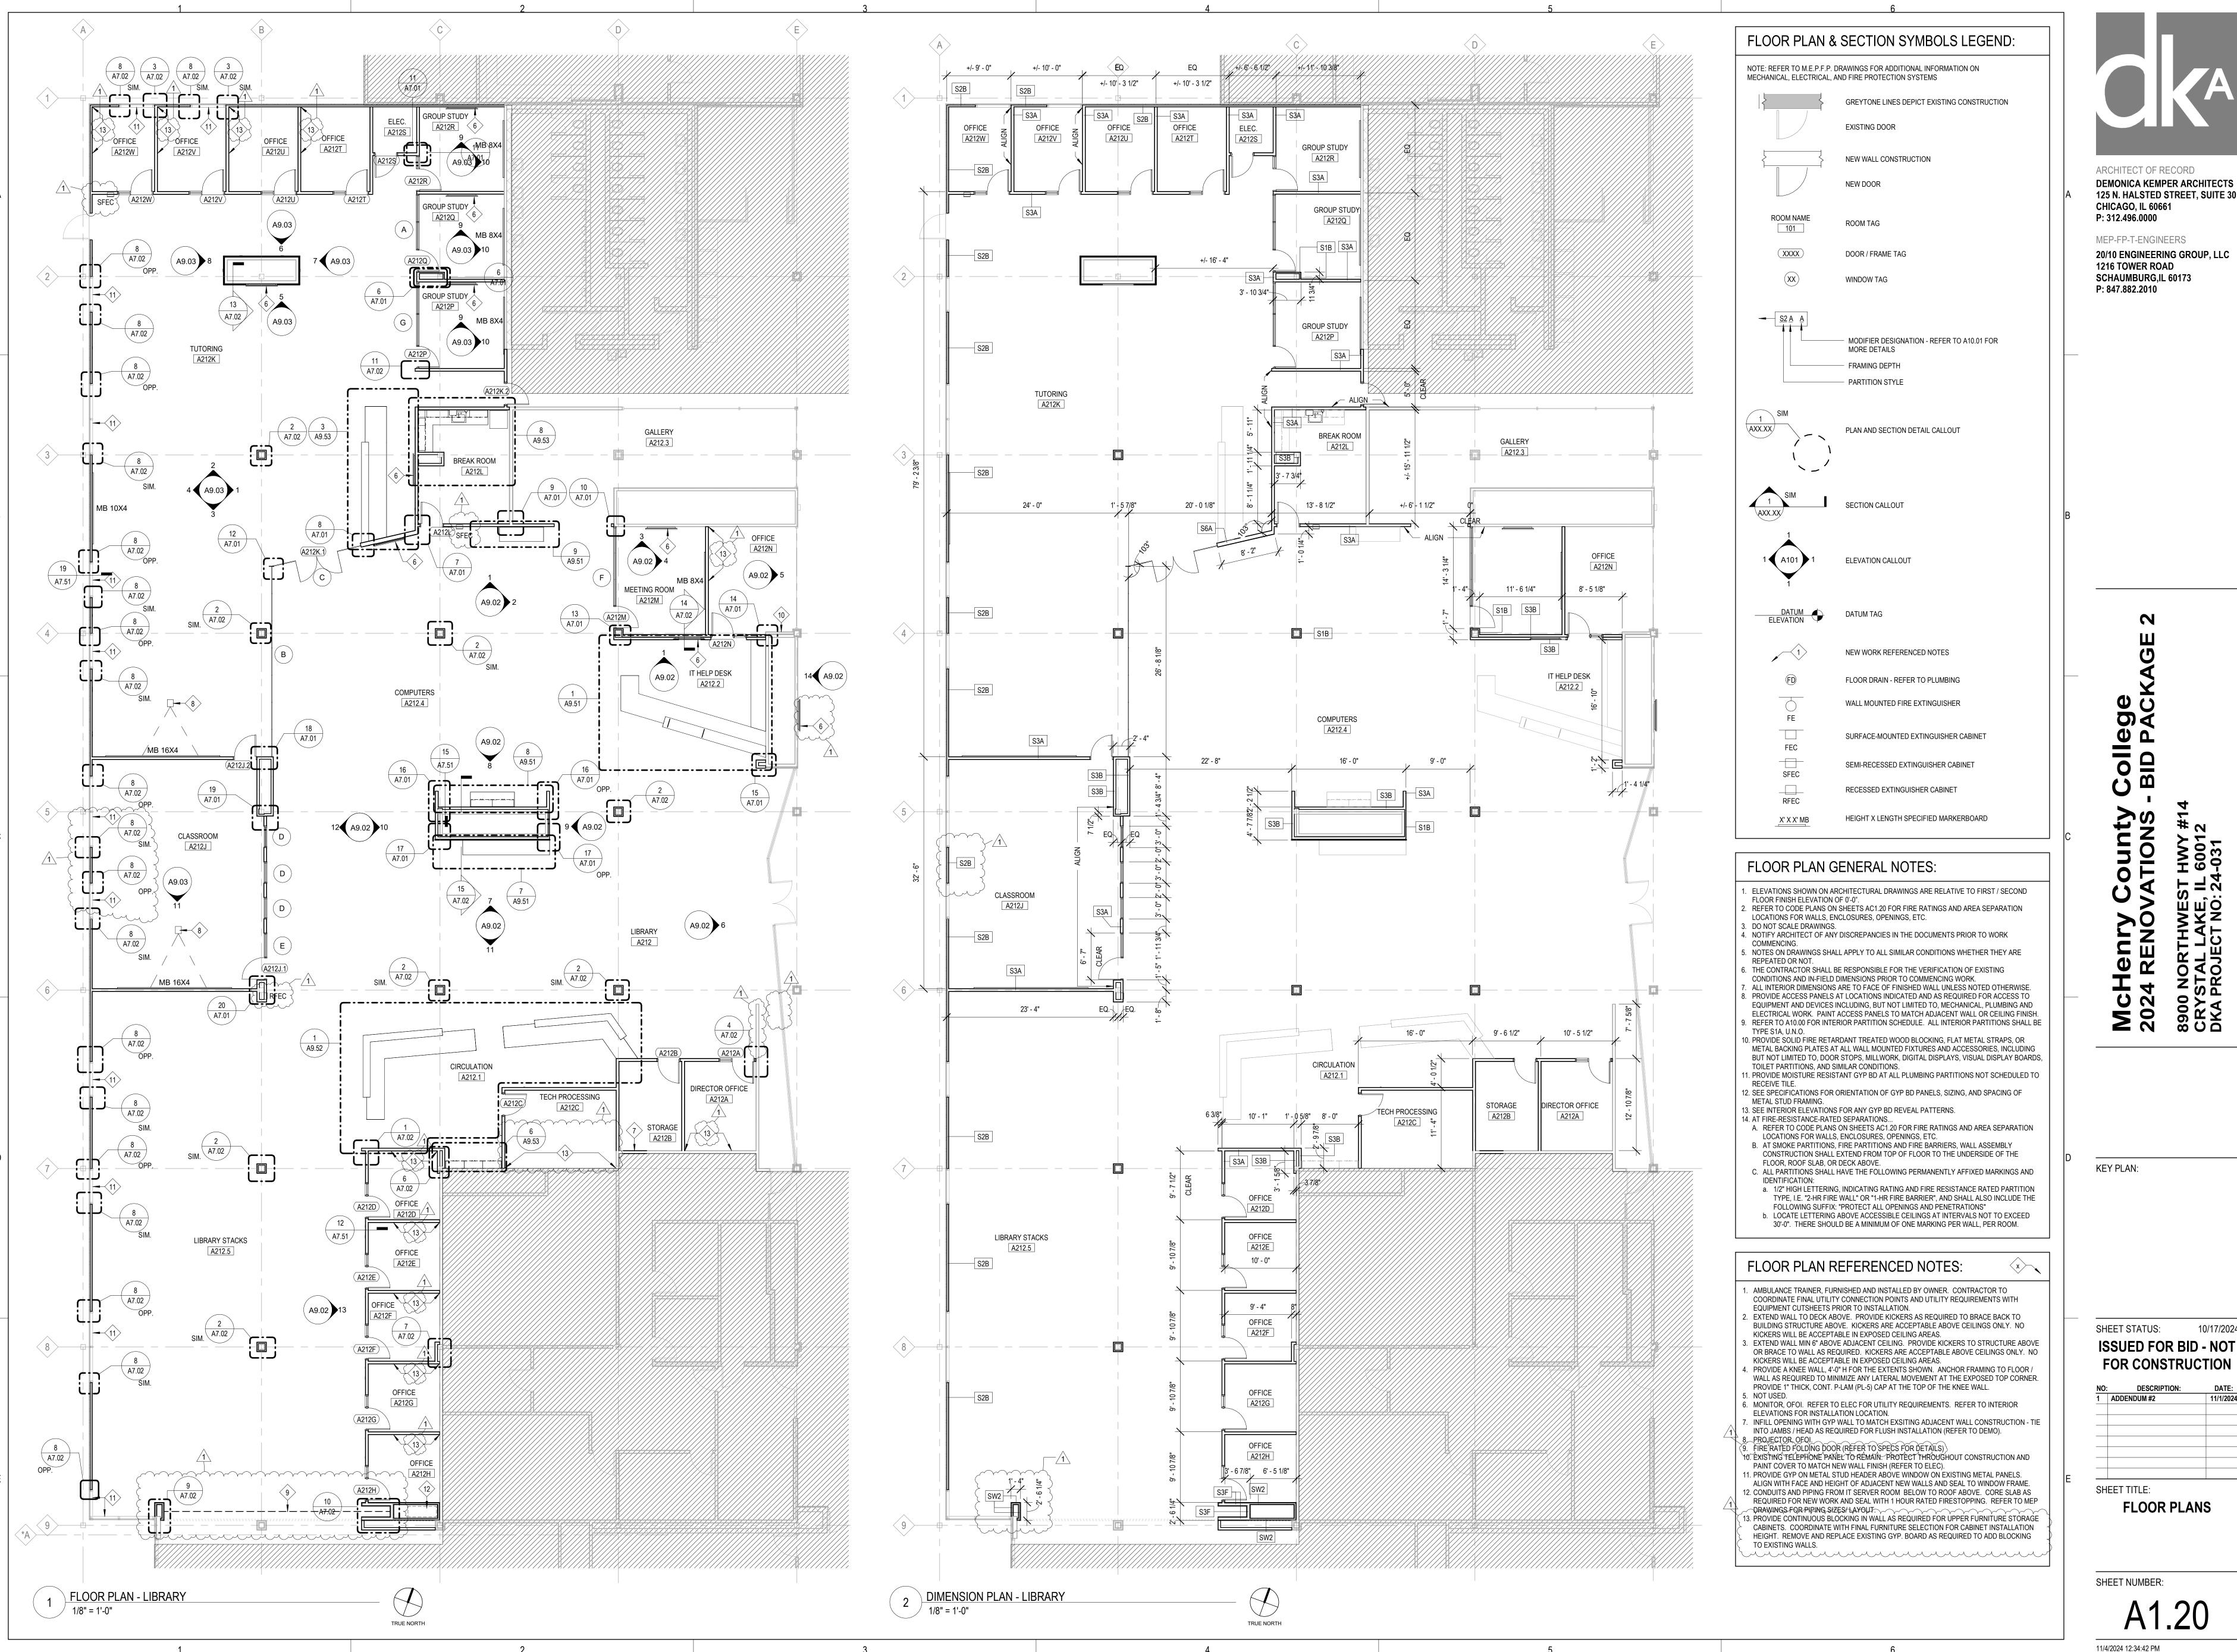
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ARCHITECT OF RECORD **DEMONICA KEMPER ARCHITECTS** 125 N. HALSTED STREET, SUITE 301

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> **a c** College BID

KEY PLAN:

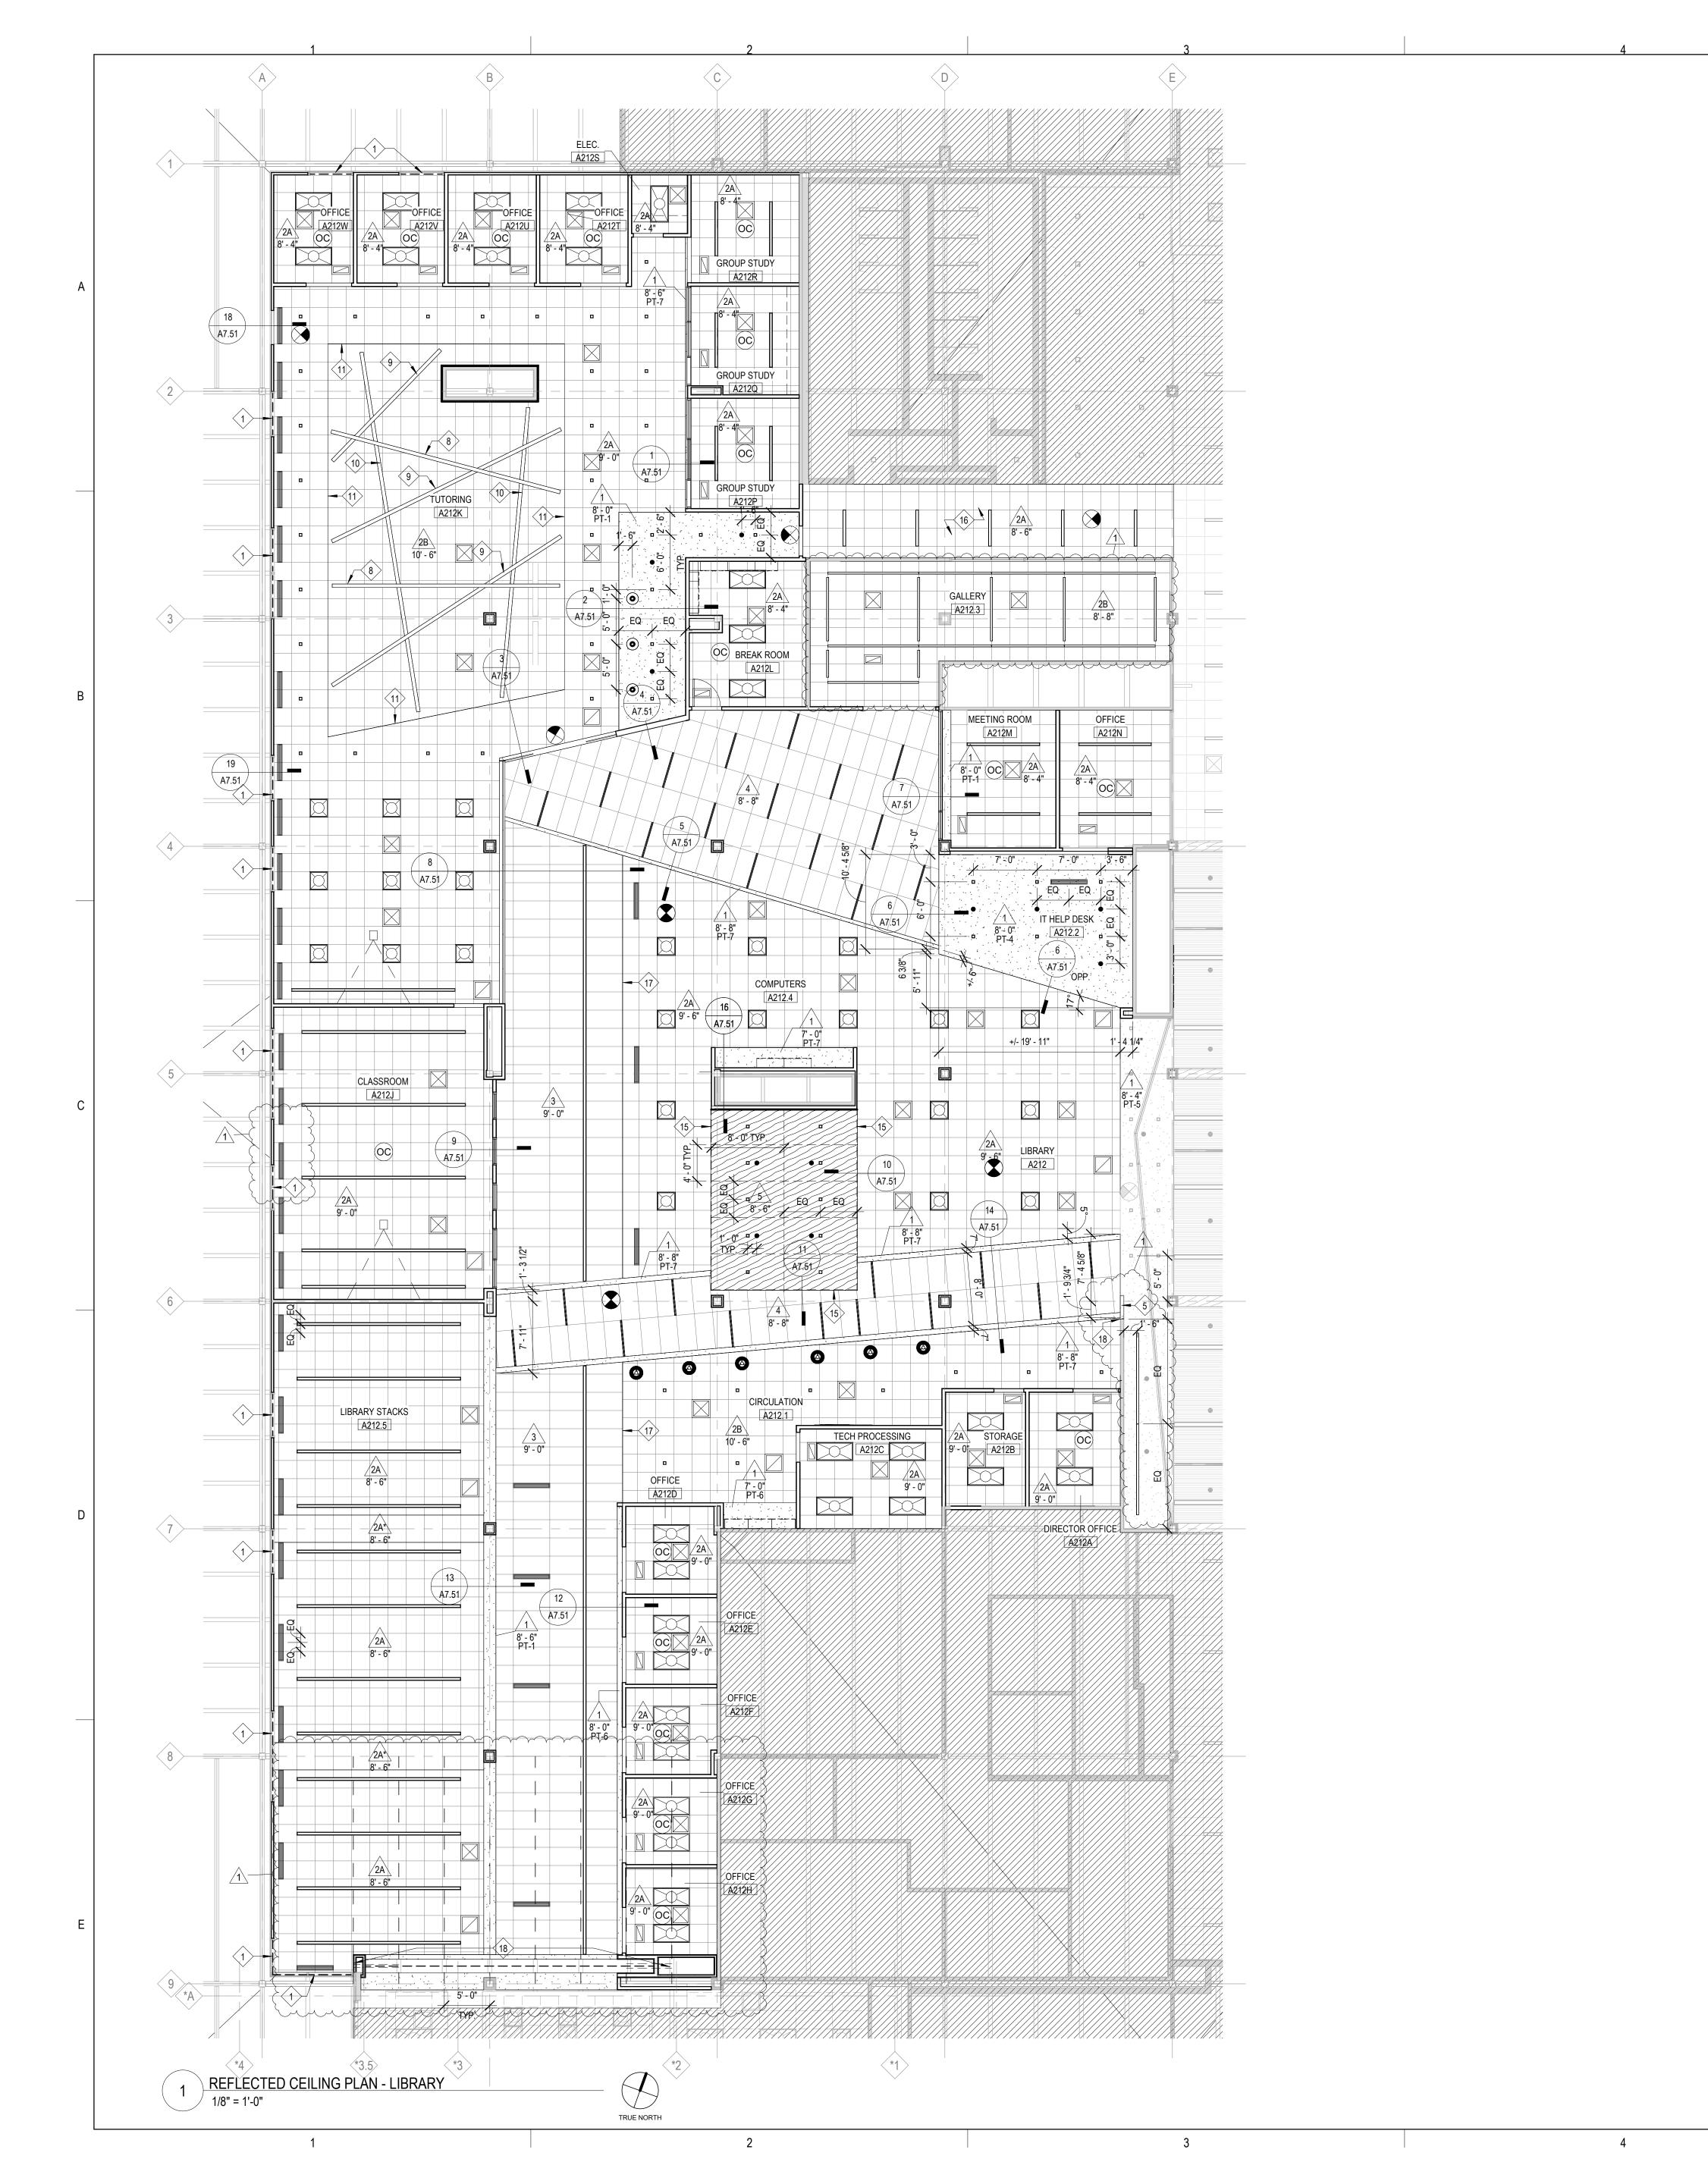
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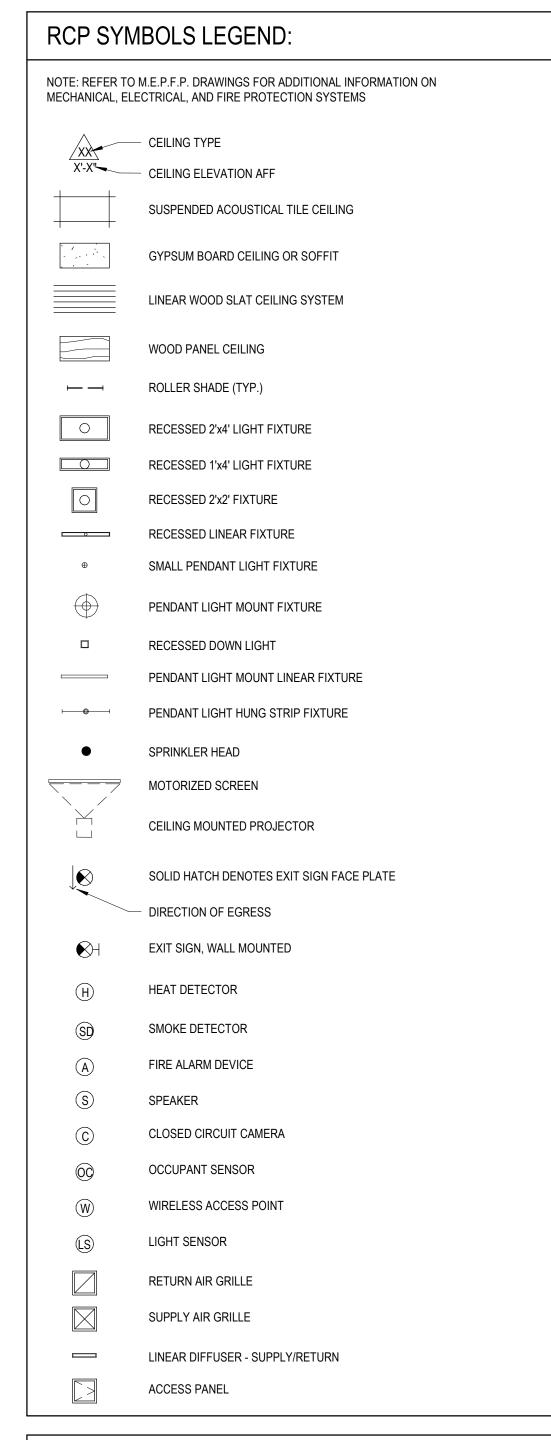
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1	ADDENDUM #2	11/1/2024

FLOOR PLANS

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RCP GENERAL NOTES:

- ALL HEATING, VENTILATION, ELECTRICAL, PLUMBING, AND FIRE PROTECTION ITEMS ARE SHOWN ON ARCHITECTURAL REFLECTED CEILING PLANS FOR REFERENCE AND COORDINATION ONLY. REFER TO HEATING, VENTILATION, ELECTRICAL, PLUMBING, AND FIRE PROTECTION DRAWINGS FOR ACTUAL QUANTITIES. IN CASE OF CONFLICT THE ARCHITECTURAL REFLECTED CEILING PLAN SHALL GOVERN LOCATION OF THESE ITEMS.
 IN AREAS THAT DO NOT HAVE ARCHITECTURAL REFLECTED CEILING PLANS YET REQUIRE NEW ITEMS TO BE INSTALLED IN OR ABOVE THE CEILING PLANE, CONTRACTOR SHALL REMOVE AND REINSTALL, REPLACE OR MODIFY EXISTING CEILING CONSTRUCTION TO ACCOMMODATE NEW WORK. ANY NEW CEILING AREAS SHALL MATCH EXISTING ADJACENT FINISHES.
- 3. CENTER ALL FIXTURES IN CEILING TILES AND FIELD VERIFY GRID LAYOUT FOR PROPER FIXTURE LOCATION. ALIGN ALL FIXTURES IN BOTH DIRECTIONS OF CEILING TILE. (UNO)
 4. CENTER ALL SPRINKLER HEADS IN CEILING TILES.
- 4. CENTER ALL SPRINKLER HEADS IN CEILING TILES.
 5. ALL GYP. BD. CEILINGS TO BE PAINTED PT-1 UNLESS OTHERWISE NOTED ON PLANS
 6. EXTEND FACE OF ALL GYP. BD. SOFFITS AND HEADERS 6" MIN. BEYOND FINISHED CEILING ABOVE U.N.O.

RCP REFERENCED NOTES:

PROVIDE NEW ROLLER SHADE. INSTALL AT TOP OF EXISTING WINDOW FRAME - FIELD VERIFY WIDTH PRIOR TO PROCUREMENT AND INSTALLATION (REFER TO SPECS).
 EXISTINGS RADIANT HEATING TILE TO REMAIN. PROTECT THROUGHOUT CONSTRUCTION.
 EXISTING CEILING TO REMAIN - PULL BACK GRID AND REMOVE TILES AS NEEDED FOR NEW WALL CONSTRUCTION. RE-INSTALL GRID TO NEW WALL AND CUT TILES AS REQUIRED FOR NEW WALL LAYOUT.
 TIE-IN NEW CEILING SYSTEM TO EXISTING CEILING SYSTEM. ALIGN NEW GRIDS WITH

EXISTING LAYOUT.

5. PROVIDE NEW GYP. BOARD ON METAL STUD CEILING AND SOFFIT SYSTEM TO MATCH
EXISTING PAINT GYP. RT-5-TO-MATCH EXISTING-SOFFIT TO REMAIN.

6. PROVIDE CONTROL JOINT BETWEEN EXISTING SOFFIT AND ADJACENT WALL.)
7. MODIFY TRACK LIGHTING AS REQUIRED FOR REDUCED OVERALL LENGTH (REFER TO ELEC).
CUT AND PATCH CEILING AS REQUIRED. TURN OVER ANY EXTRA LIGHT FIXTURES TO THE

MOUNT CONTINUOUS PENDANT AT 9'-0" AFF TO BOTTOM OF PENDANT.
 MOUNT CONTINUOUS PENDANT AT 9'-4" AFF TO BOTTOM OF PENDANT.
 MOUNT CONTINUOUS PENDANT AT 9'-8" AFF TO BOTTOM OF PENDANT.

11. PAINT BULKHEAD PT-7.
12. PROVIDE NEW CEILING TILES, LIGHTING, GRILLES AND DIFFUSERS IN EXISTING GRID AS INDICATED. RE-INSTALL EXISTING SPRINKLER HEADS AS REQUIRED. RE-INSTALL SALVAGED DEVICES IN NEW CEILING AS INDICATED ON ELECTRICAL DRAWINGS (REFER TO MEP DRAWINGS FOR ADDITIONAL SCOPE).
13. PROVIDE NEW SUSPENDED CEILING CRID SYSTEM CEILING THES. AND RECISTERS

13. PROVIDE NEW SUSPENDED CEILING GRID SYSTEM, CEILING TILES, GRILLES, AND REGISTERS AS INDICATED. RE-INSTALL EXISTING SPRINKLER HEAD COVERPLATES IN NEW CEILING TILES. RE-INSTALL EXISTING LIGHT FIXTURES AND SALVAGED DEVICES IN NEW CEILING AS INDICATED ON ELECTRICAL DRAWINGS (REFER TO MEP DRAWINGS FOR ADDITIONAL SCOPE).

14. PROVIDE AXIOM TRIM AT CEILING TRANSITION (REFER TO RCP AND DETAILS FOR HEIGHT OF

AXIOM TRIM REQUIRED)

15. PROVIDE 3/4" THICK X 2"W SOLID WOOD EDGE TRIM TO MATCH PERFORATED WOOD PANELS (PWP-1). TRIM TO BE FLUSH WITH PANELS.

16. INSTALL NEW CEILING GRID AND REINSTALL EXISTING TILES, LIGHTING, AND DEVICES SALVAGED DURING DEMOLITION. REPLACE ANY DAMAGED CEILING TILES WITH NEW AND PROVIDE NEW CEILING TILES AS REQUIRED FOR ADDITIONAL EXTENTS OF CEILING. COORDINATE SCHEDULING OF WORK WITH OWNER PRIOR TO COMMENCEMENT.

17. PROVIDE PERIMETER TRIM AT CEILING TRANSITION (REFER TO RCP AND DETAILS FOR HEIGHT-OF-TRIM-REQUIRED)

18. 10' H FIRE-RATED FOLDING DOOR. SUSPEND FIRE DOOR TRACK FROM EXISTING STRUCTURE ABOVE (W16X31, B/STL @ +/- 11'-8) WITH 1/2" HANGING RODS FROM (2) BEAM CLAMPS @ EA. EXISTING BEAM AND FROM NEW CHANNELS SPANNING BETWEEN THE EXISTING BEAMS @ EA END. PATCH AND REPAIR EXISTING FIREPROOFING AT ALL STRUCTURE OVERHEAD AS REQUIRED FOR NEW WORK. REFER TO STRUCTURAL REF SHEET FOR MORE DETAILS.

19. PROVIDE 2-HOUR GYP WALL FROM T/FIRE DOOR TO DECK ABOVE ON EACH SIDE OF FIRE-

CEILING TYPES:			
TYPE	DESCRIPTION		
0A	EXPOSED STRUCTURE - NO PAINTED FINISH REQUIRED		
0B	EXPOSED STRUCTURE - PAINT ALL STRUCTURE AND MEP SYSTEMS ABO		
1	1/2" PAINTED GYP BOARD ON METAL FRAMING		
2A	2X2 WHITE ACOUSTICAL PANEL SYSTEM (2x3 @ SIM LOCATIONS INDICAT		
2B	2X2 BLACK ACOUSTICAL PANEL SYSTEM		

2X4 SCORED ACOUSTICAL PANEL SYSTEM

4x10 PERFORATED WOOD PANEL CEILING SYSTEM

4 2x4 PET ACOUSTICAL PANEL SYSTEM

RATED FOLDING DOOR.

ARCHITECT OF RECORD

DEMONICA KEMPER ARCHITECTS
125 N. HALSTED STREET, SUITE 301
CHICAGO, IL 60661
P: 312.496.0000

MEP-FP-T-ENGINEERS

20/10 ENGINEERING GROUP, LLC 1216 TOWER ROAD SCHAUMBURG,IL 60173 P: 847.882.2010

ry County College

KEY PLAN:

SHEET STATUS: 10/17/2024

ISSUED FOR BID - NOT

NO:	DESCRIPTION:	DATE:
1	ADDENDUM #2	11/1/2024

FOR CONSTRUCTION

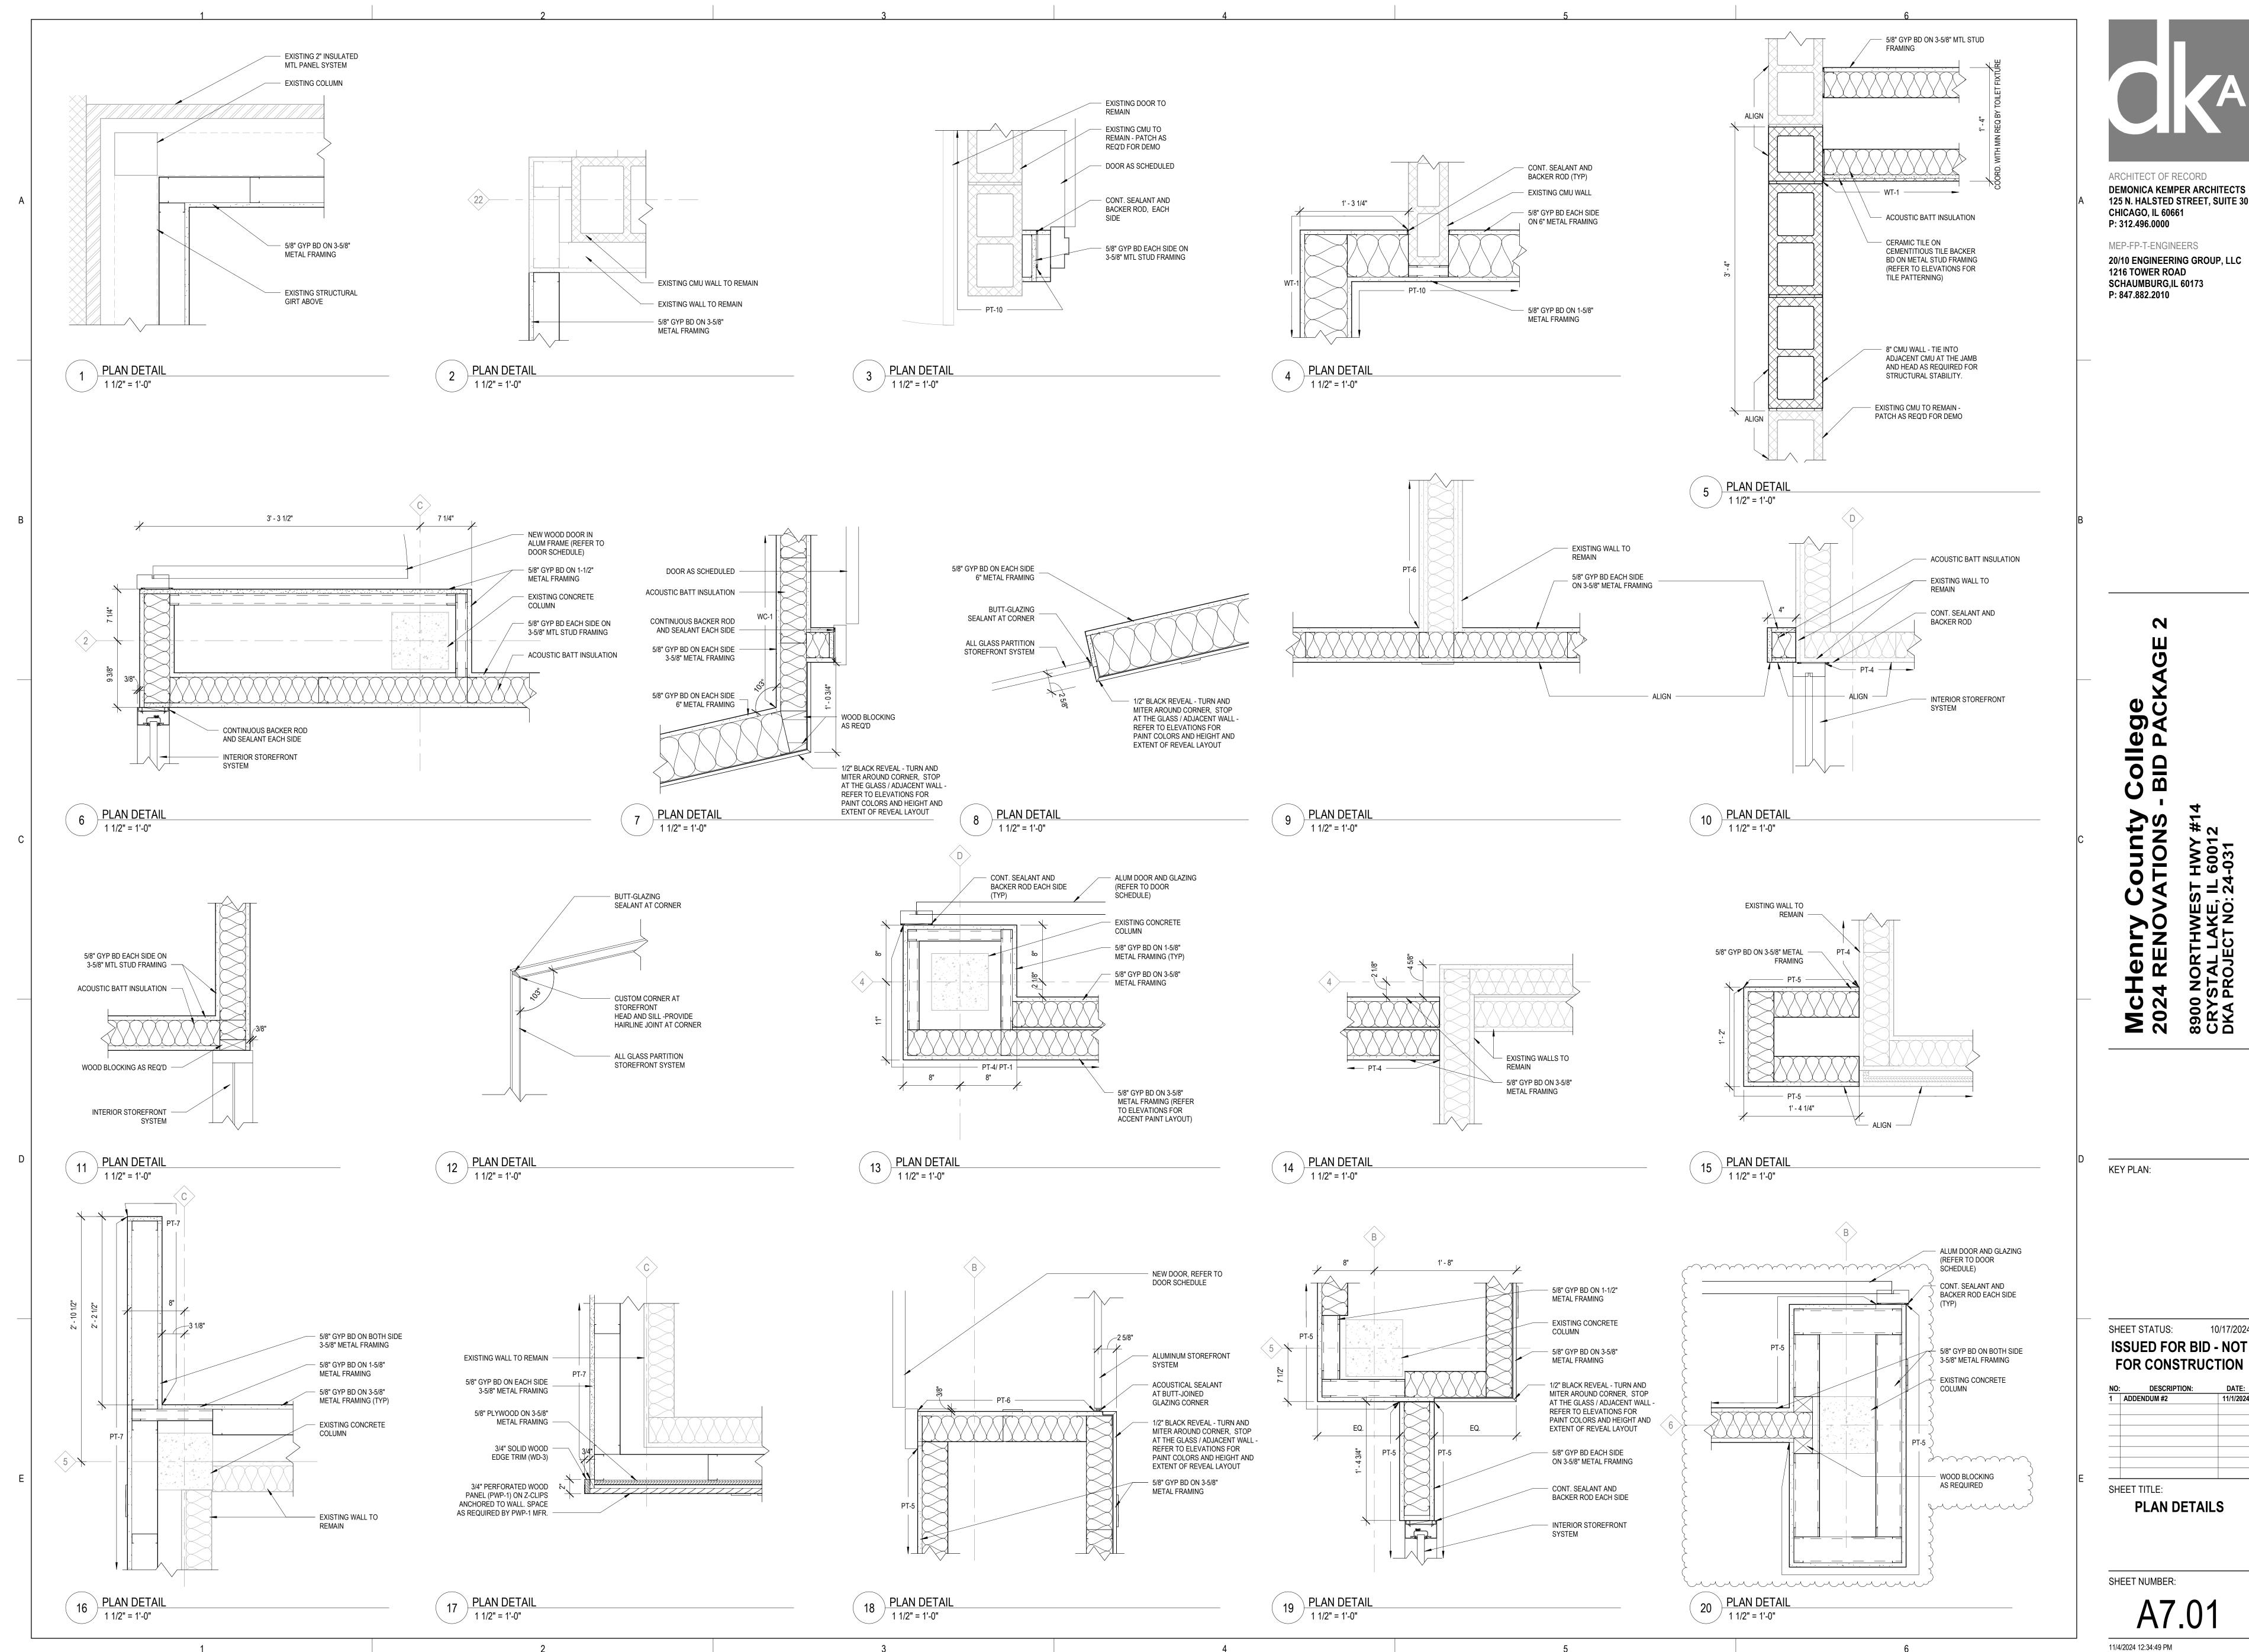
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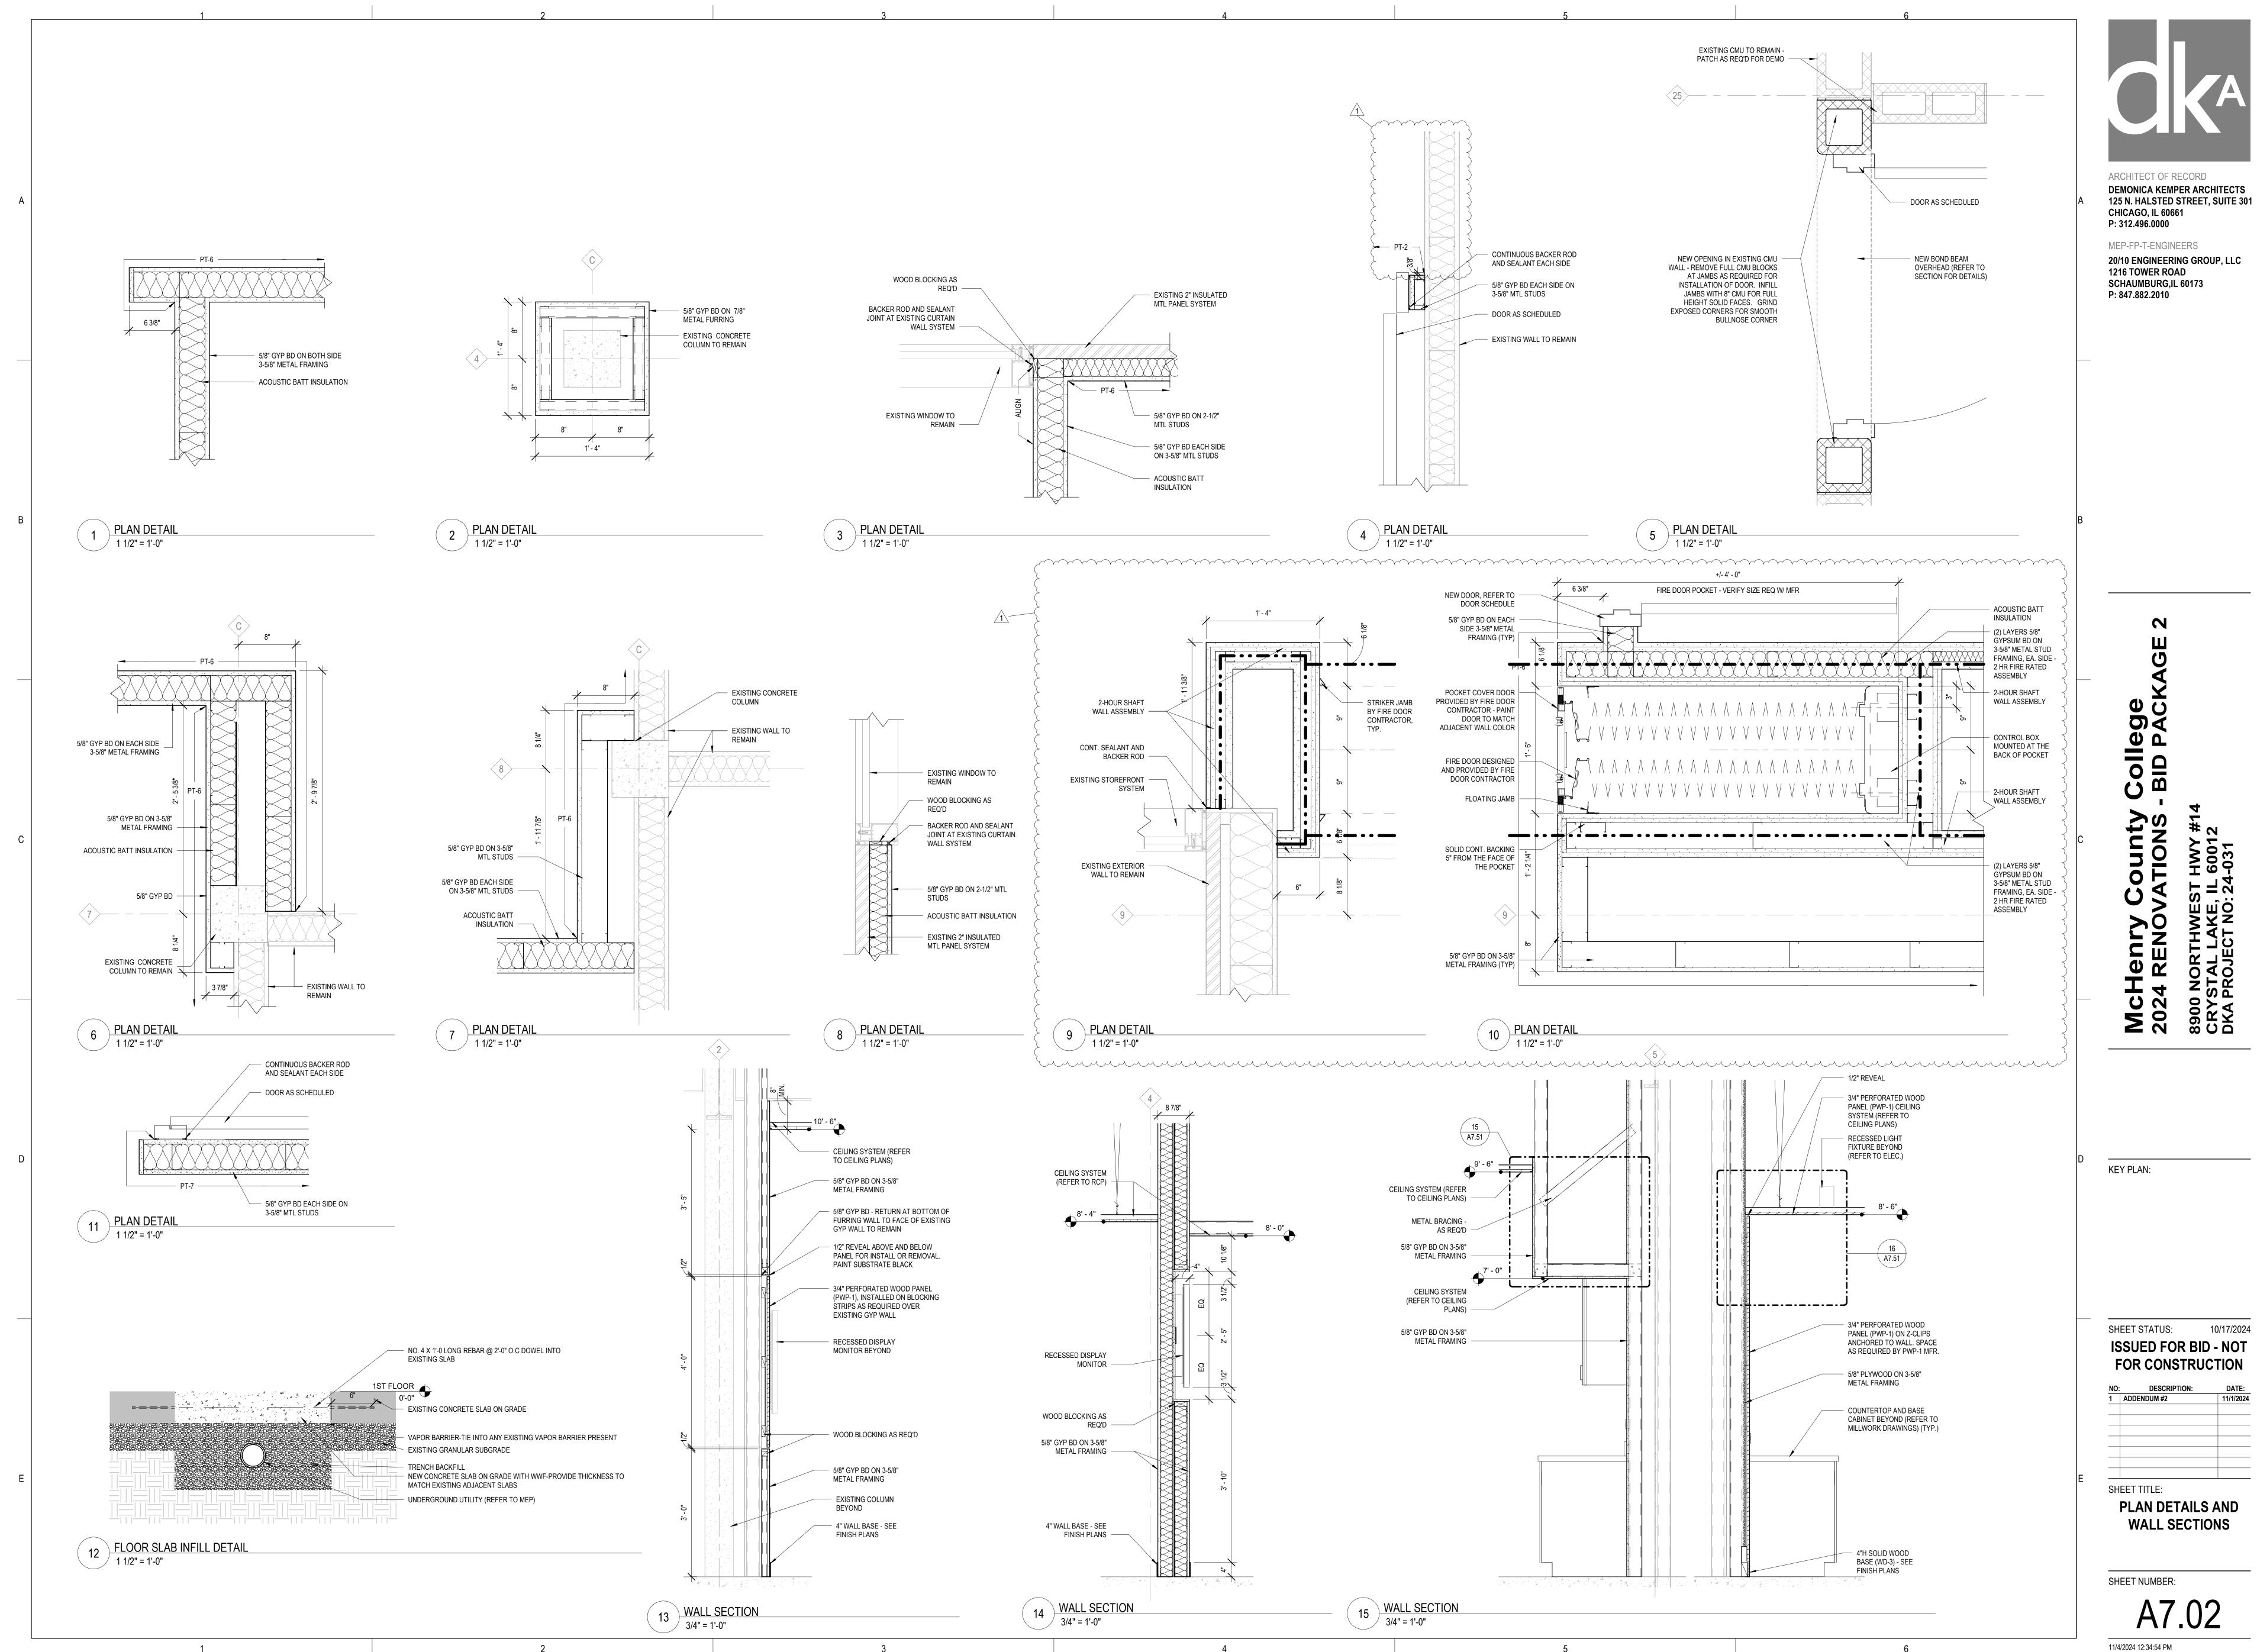
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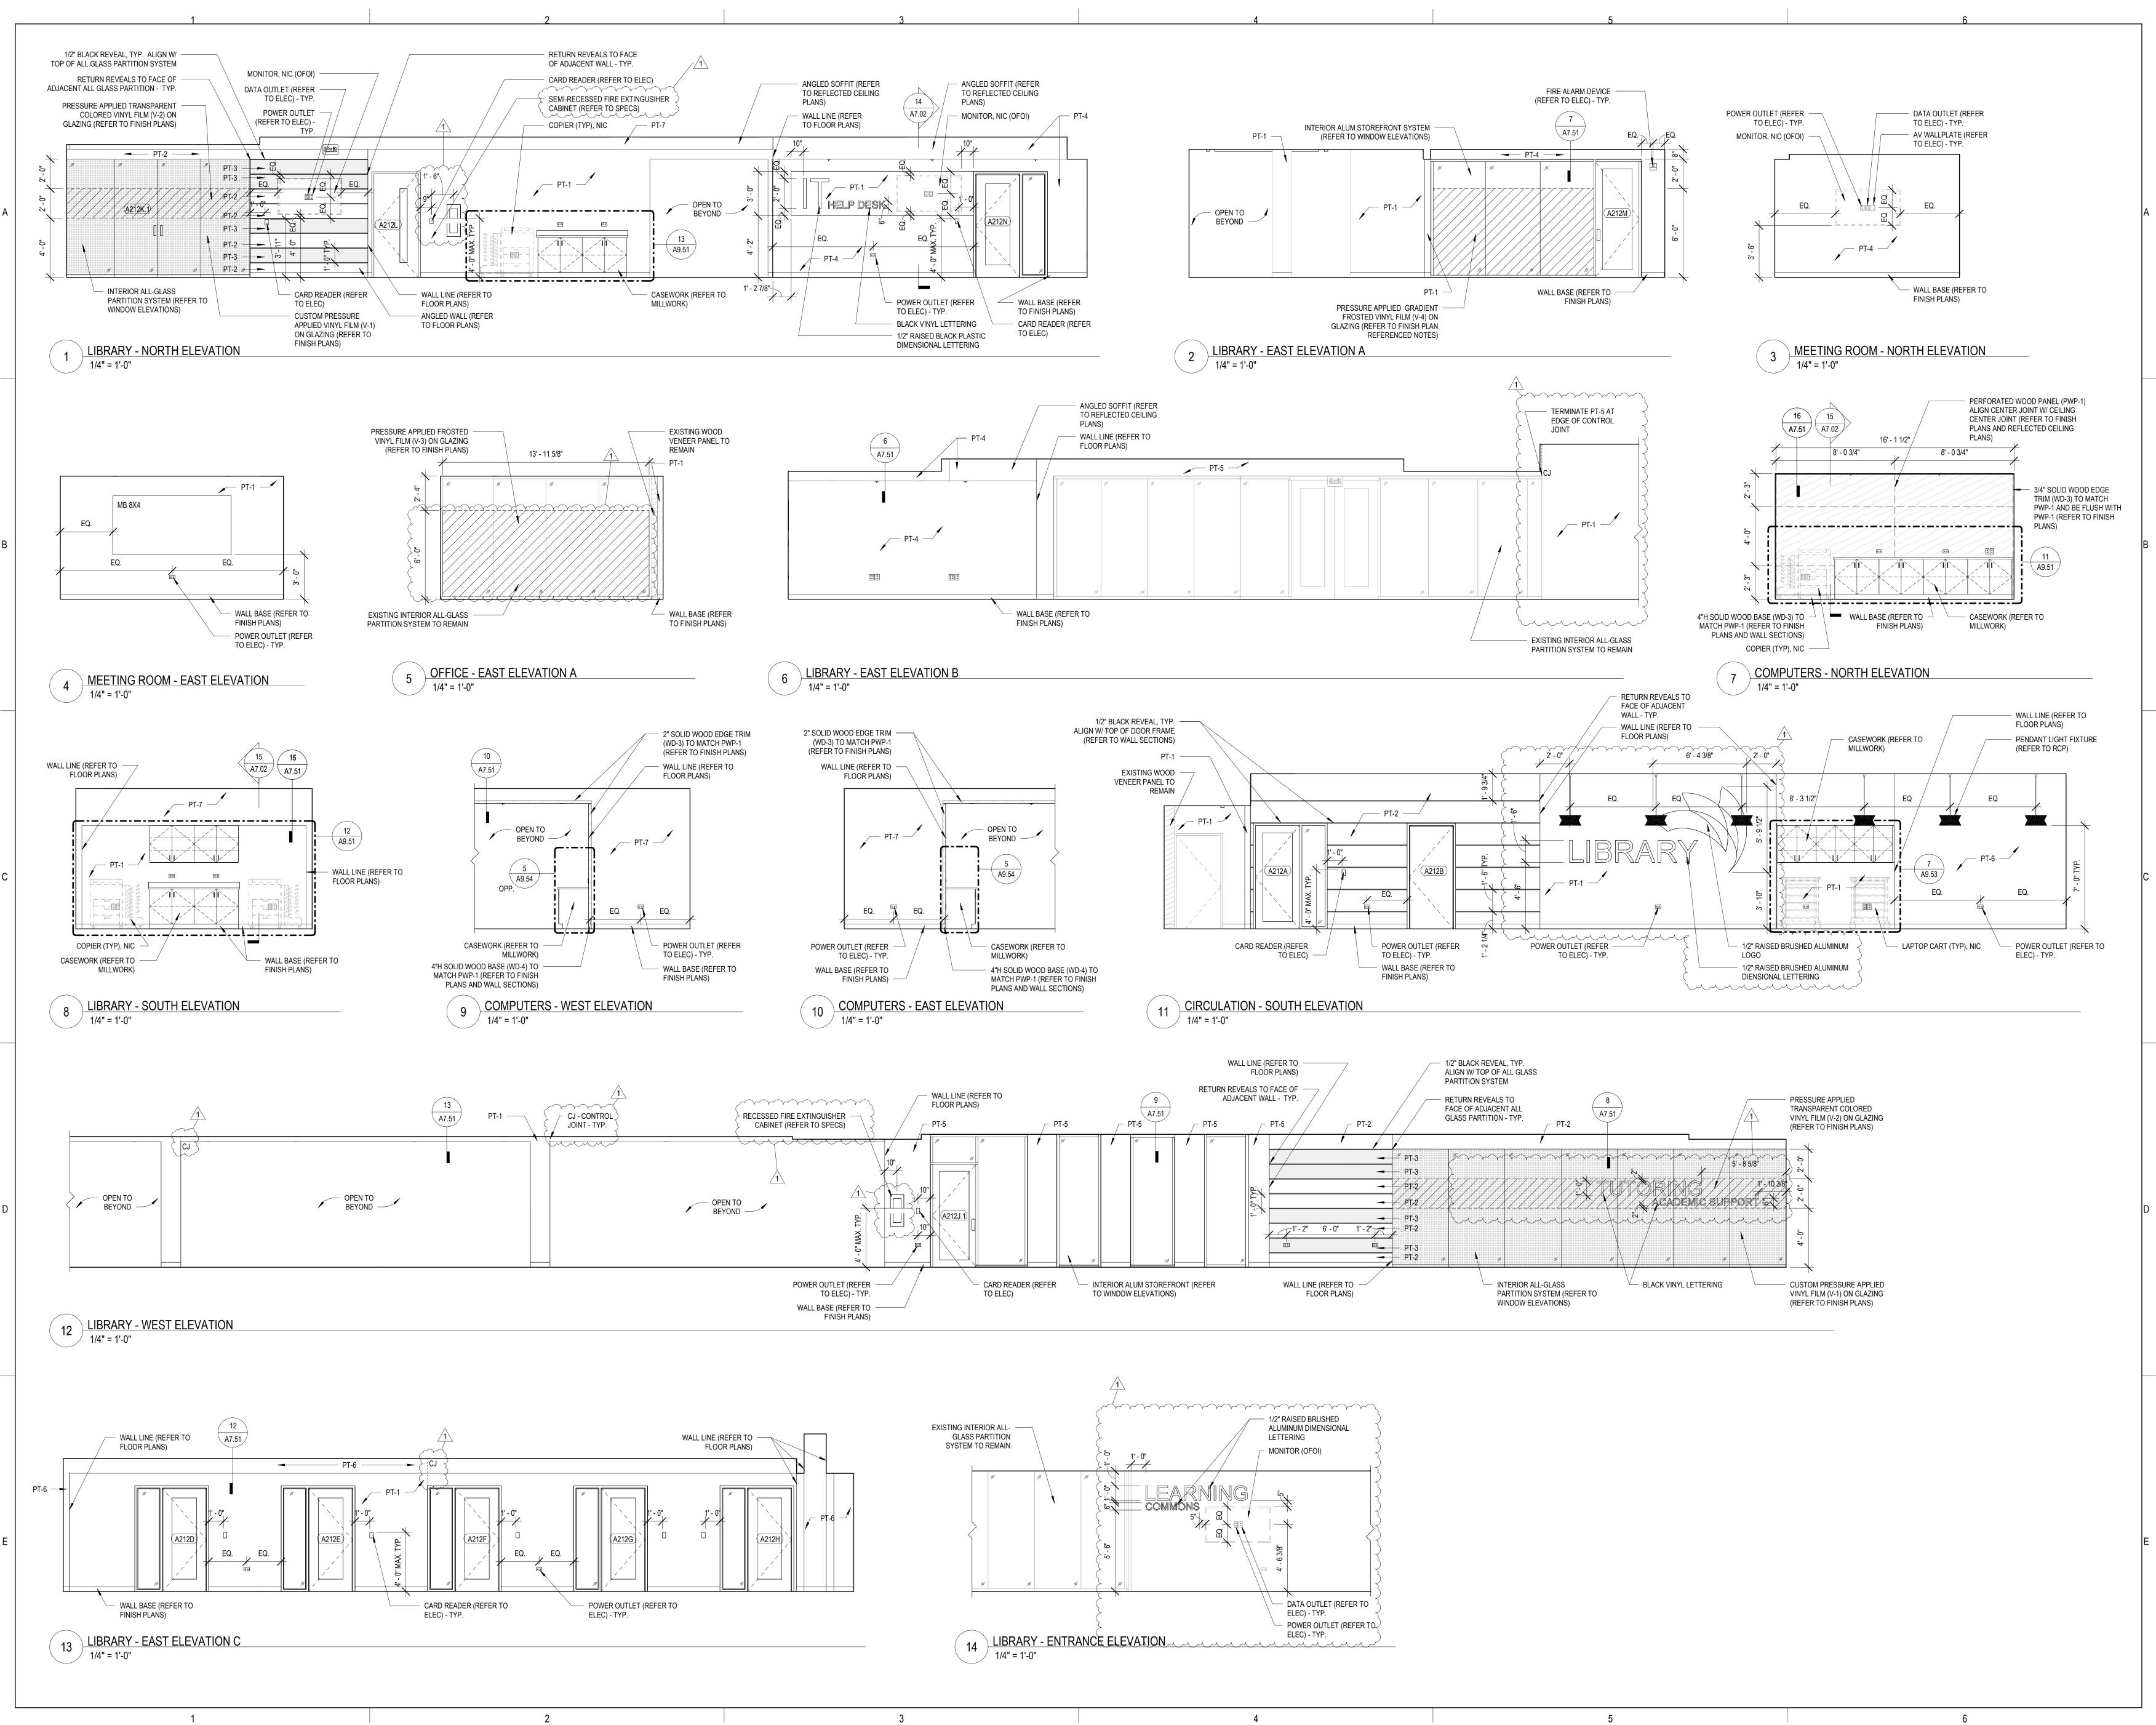
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DEMONICA KEMPER ARCHITECTS 125 N. HALSTED STREET, SUITE 301

FOR CONSTRUCTION DESCRIPTION: DATE:





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Henry County College 4 RENOVATIONS - BID PACKAGE

KEY PLAN:

SHEET STATUS: 10/17/2024
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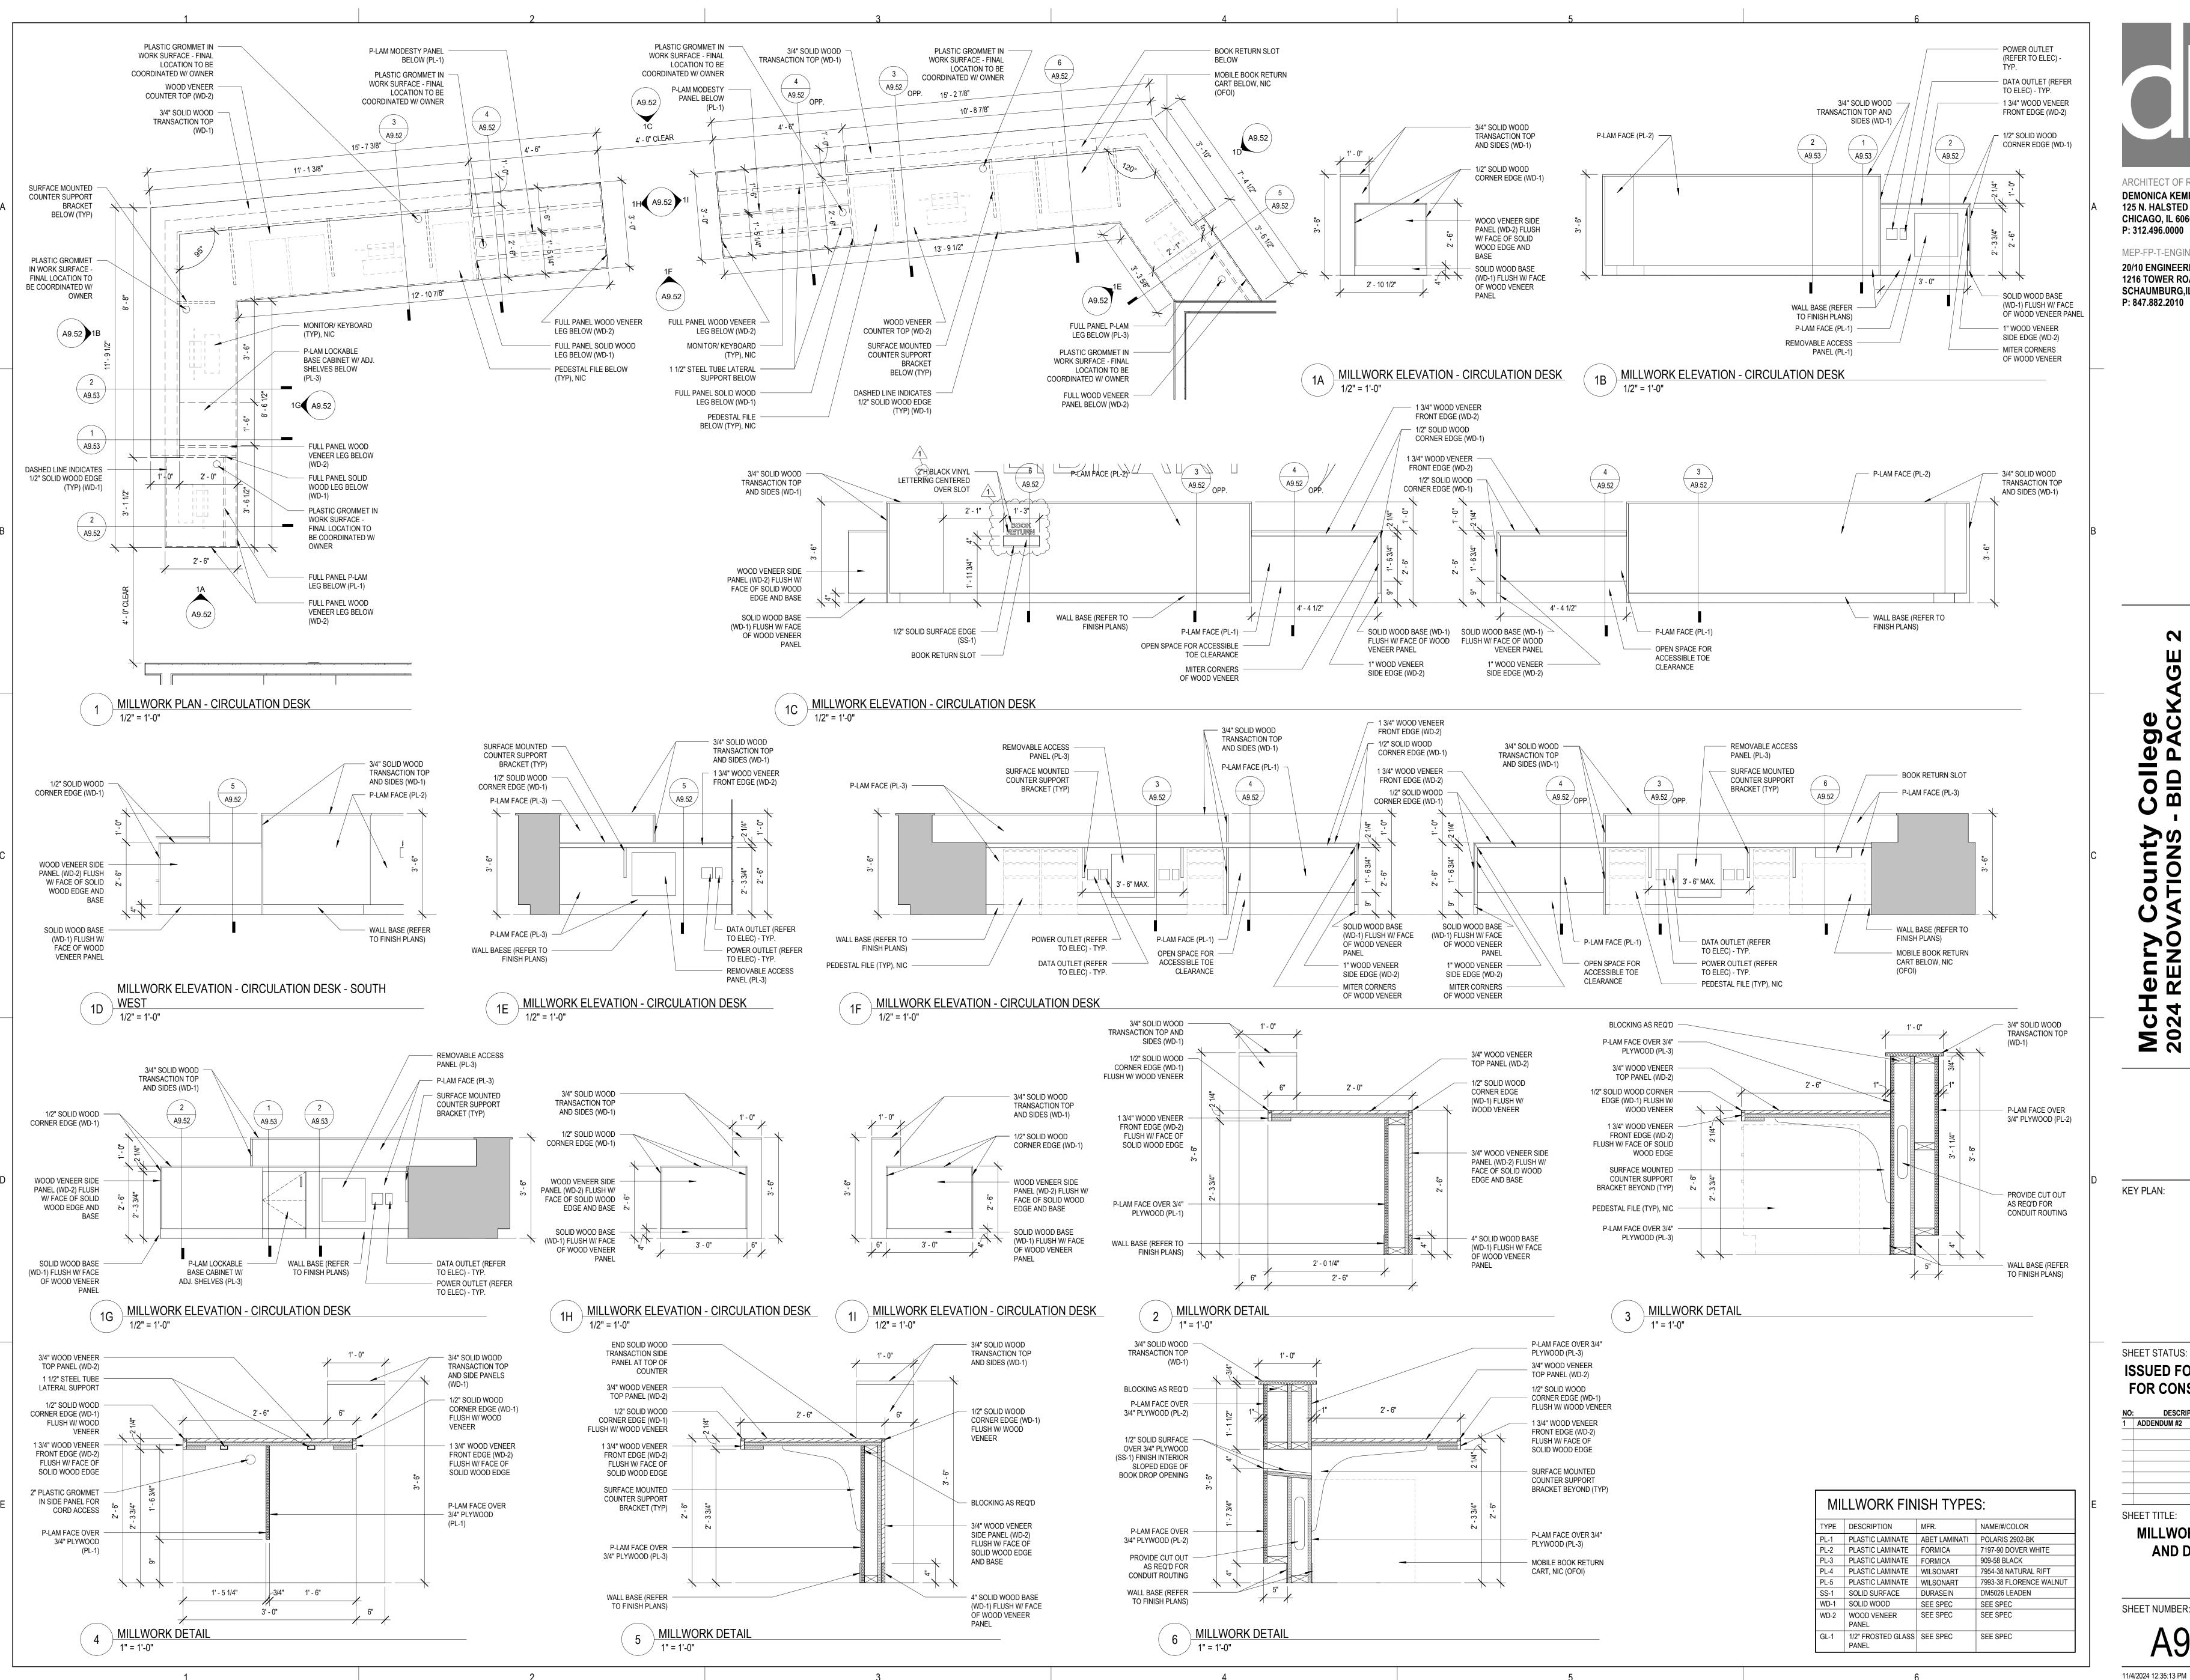
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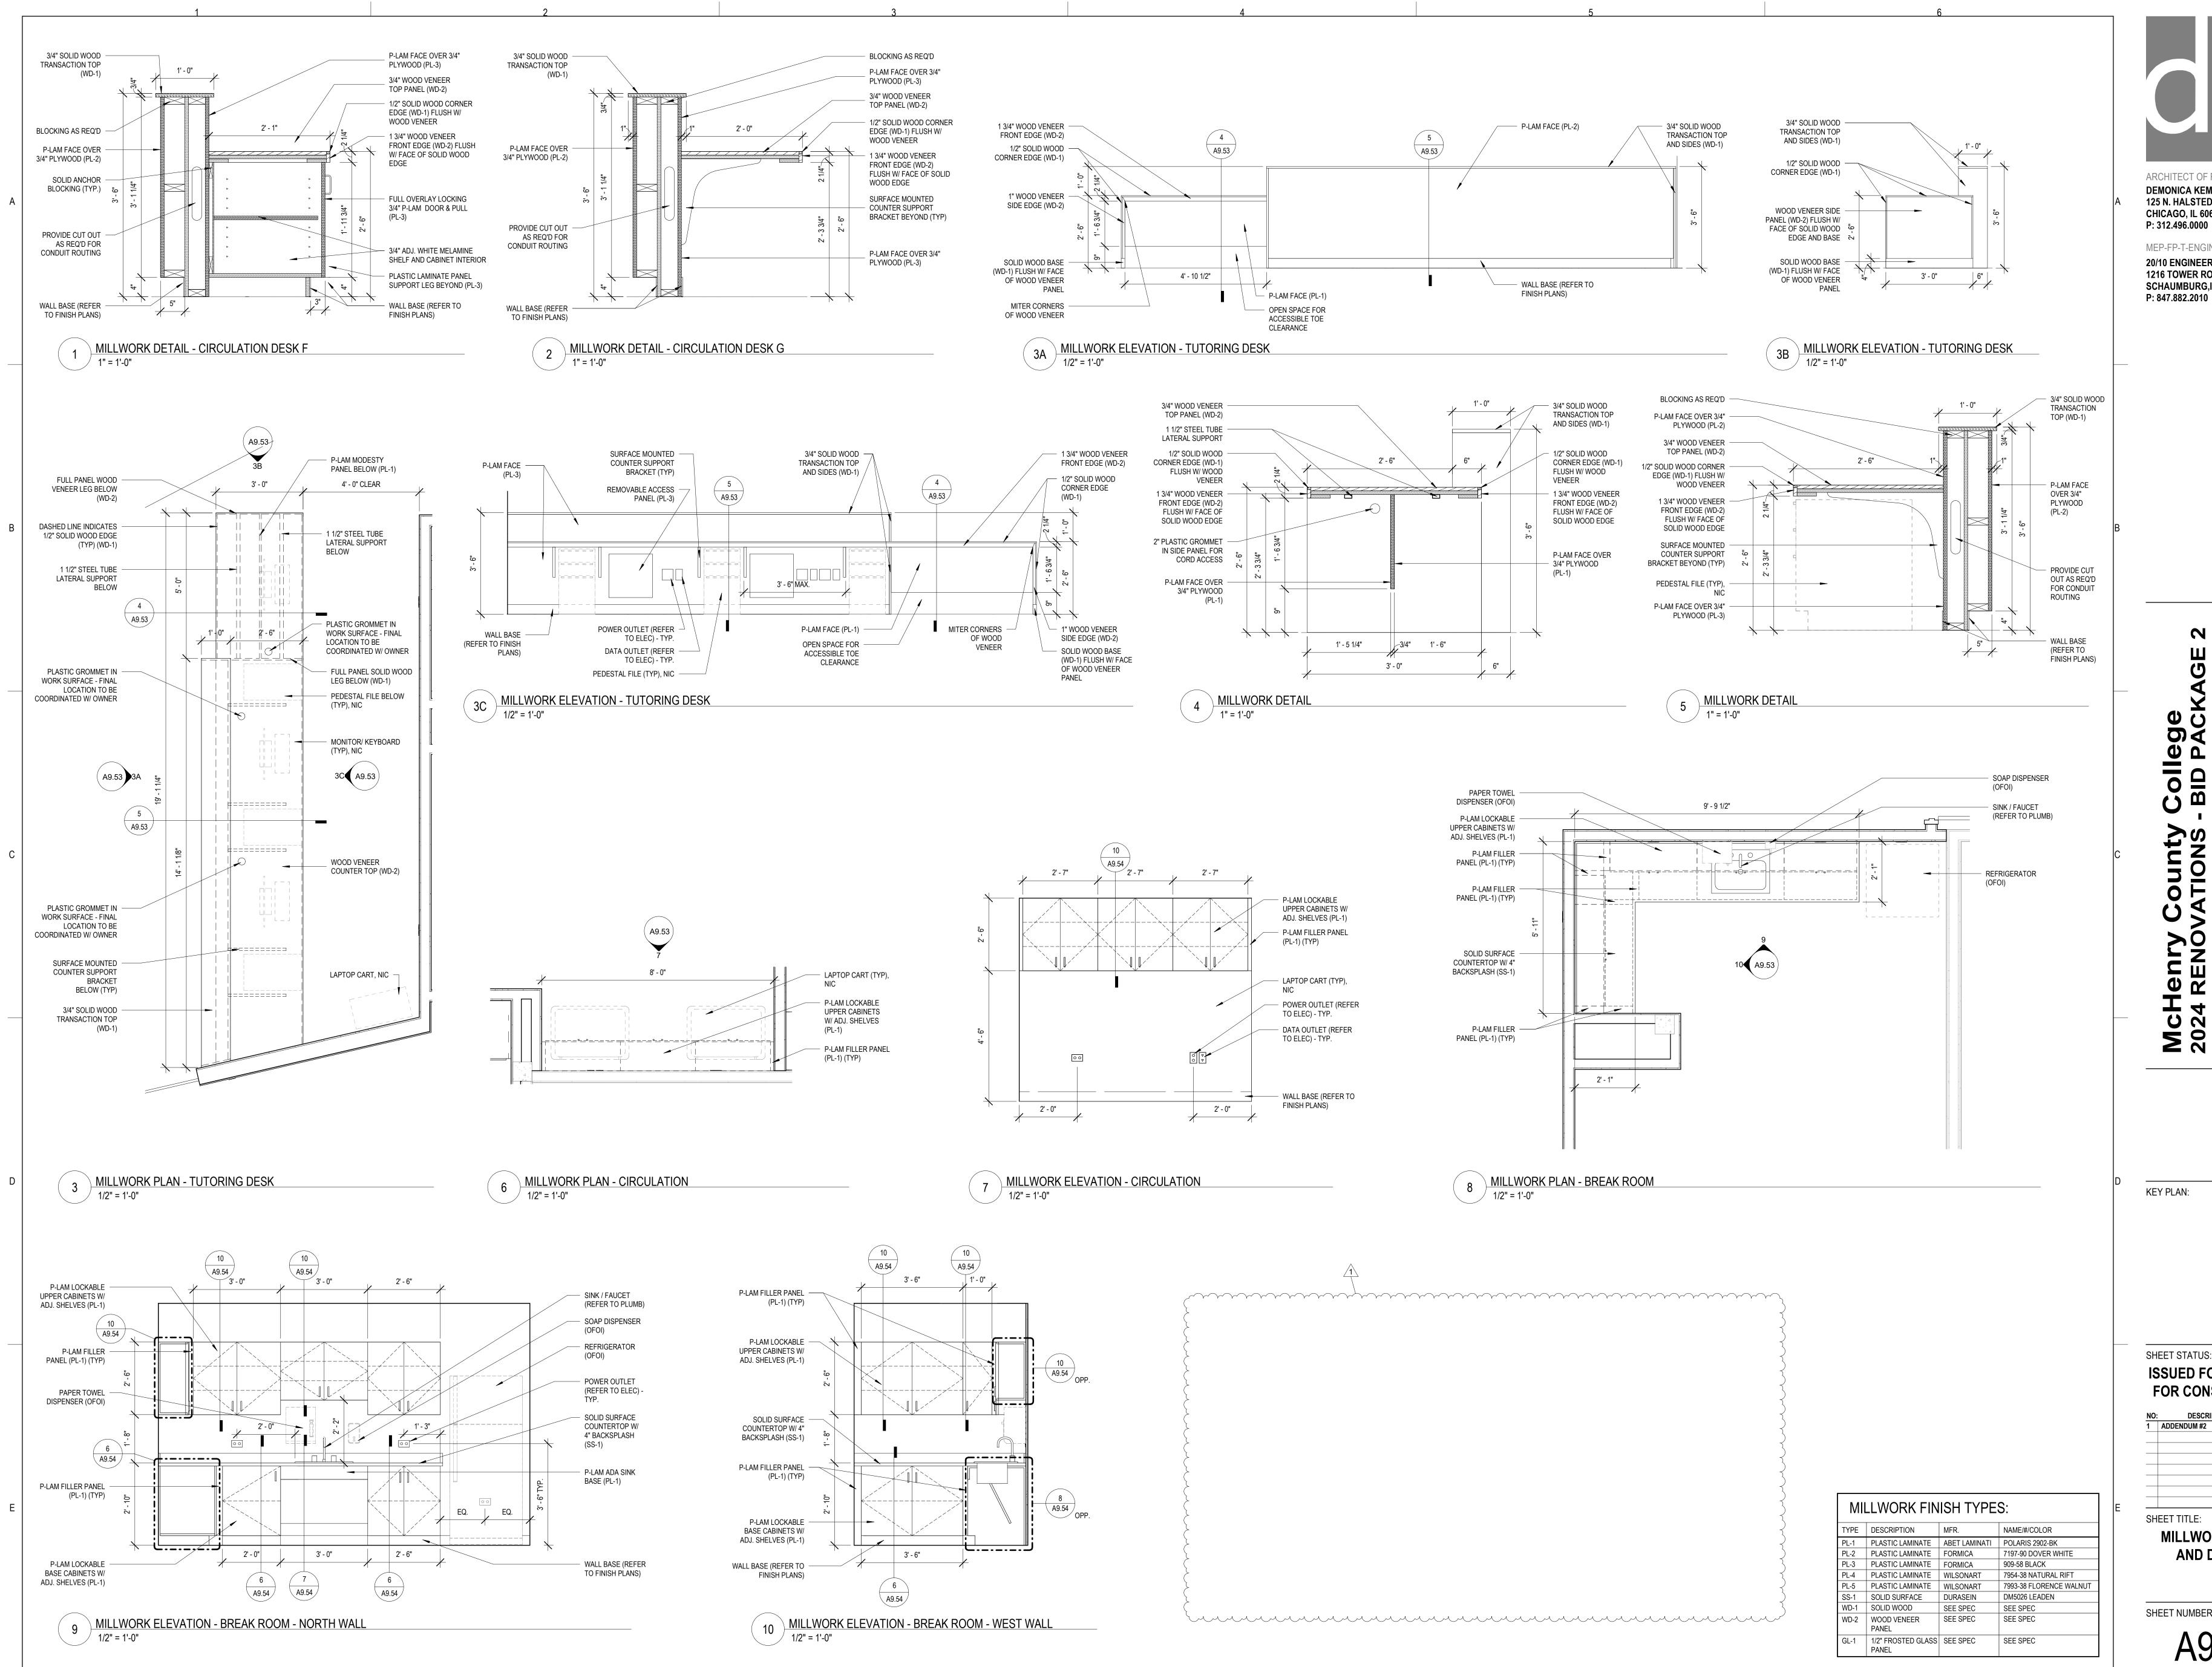
KEY PLAN:

SHEET STATUS: **ISSUED FOR BID - NOT** FOR CONSTRUCTION

DESCRIPTION: SHEET TITLE:

MILLWORK PLANS AND DETAILS

SHEET NUMBER:





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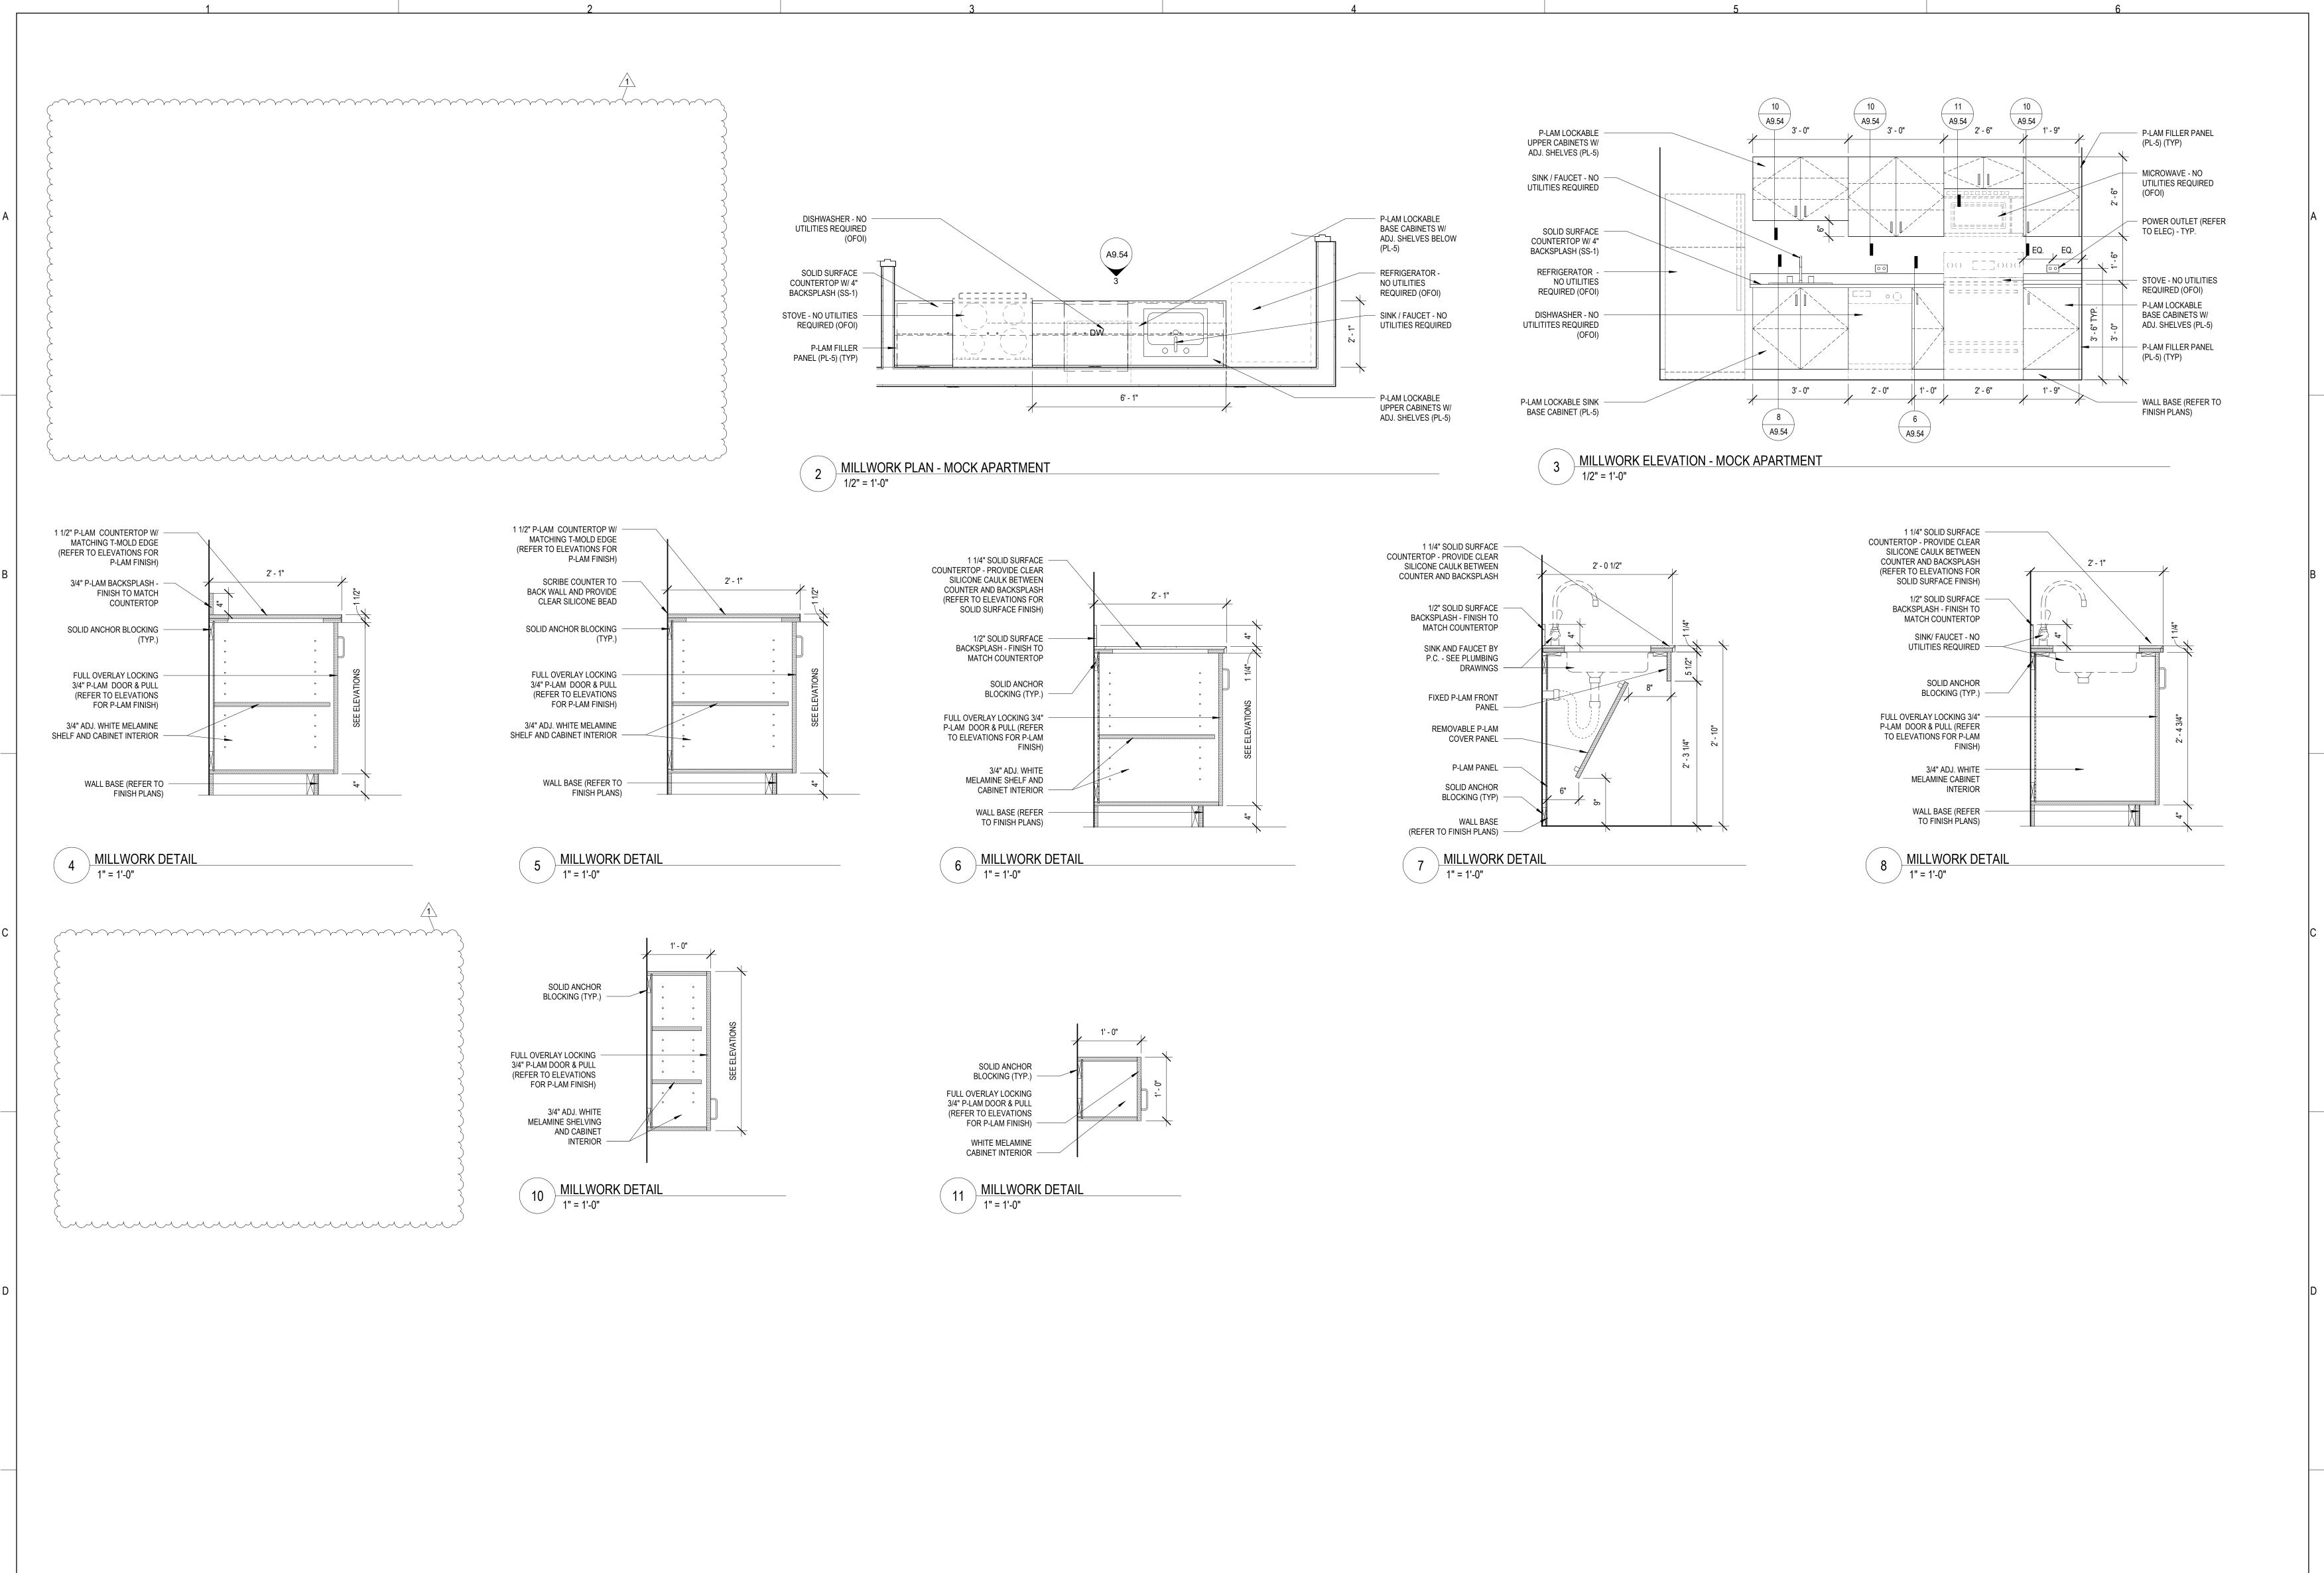
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KEY PLAN:

SHEET STATUS: **ISSUED FOR BID - NOT** FOR CONSTRUCTION

NO: DESCRIPTION: DATE:

SHEET TITLE:

MILLWORK PLANS AND DETAILS

SHEET NUMBER:

MILLWORK FINISH TYPES:

PL-1 PLASTIC LAMINATE ABET LAMINATI POLARIS 2902-BK

SS-1 SOLID SURFACE DURASEIN DM5026 LEADEN WD-1 SOLID WOOD SEE SPEC SEE SPEC

WD-2 WOOD VENEER SEE SPEC SEE SPEC

GL-1 1/2" FROSTED GLASS SEE SPEC SEE SPEC

PL-2 PLASTIC LAMINATE FORMICA 7197-90 DOVER WHITE PL-3 PLASTIC LAMINATE FORMICA 909-58 BLACK

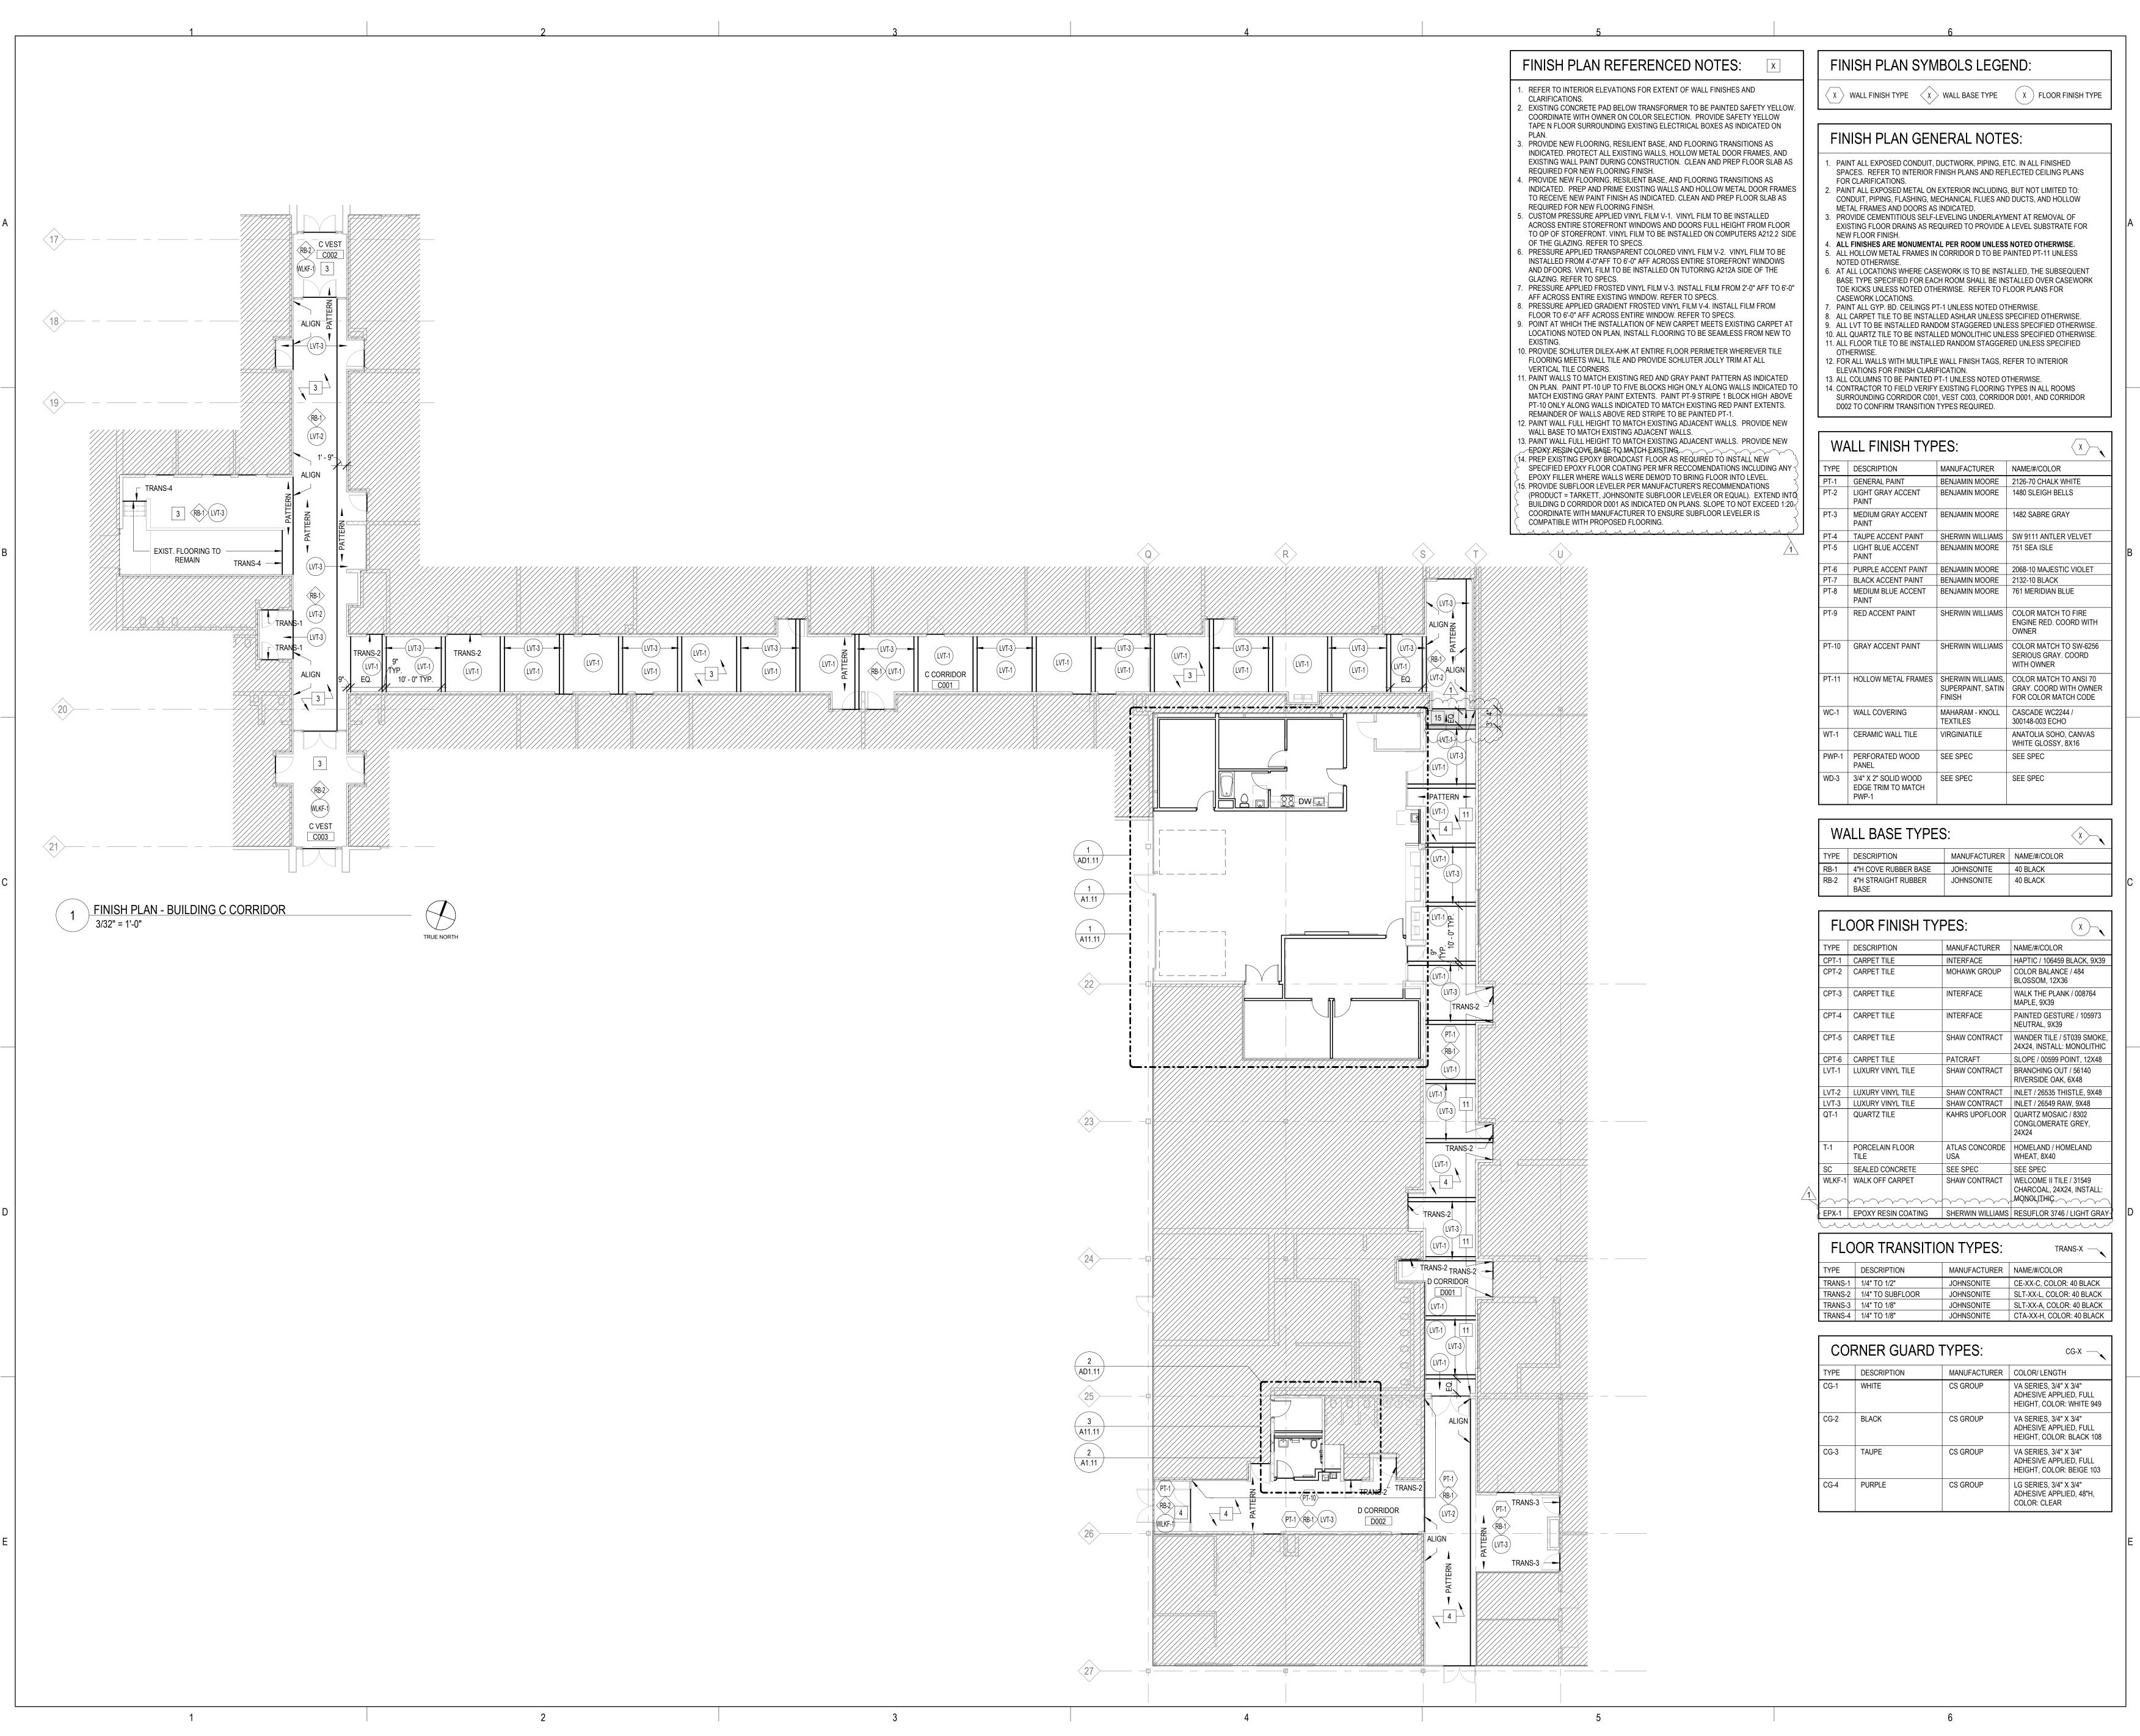
PL-4 PLASTIC LAMINATE WILSONART 7954-38 NATURAL RIFT PL-5 PLASTIC LAMINATE WILSONART 7993-38 FLORENCE WALNUT

NAME/#/COLOR

TYPE DESCRIPTION MFR.

PANEL

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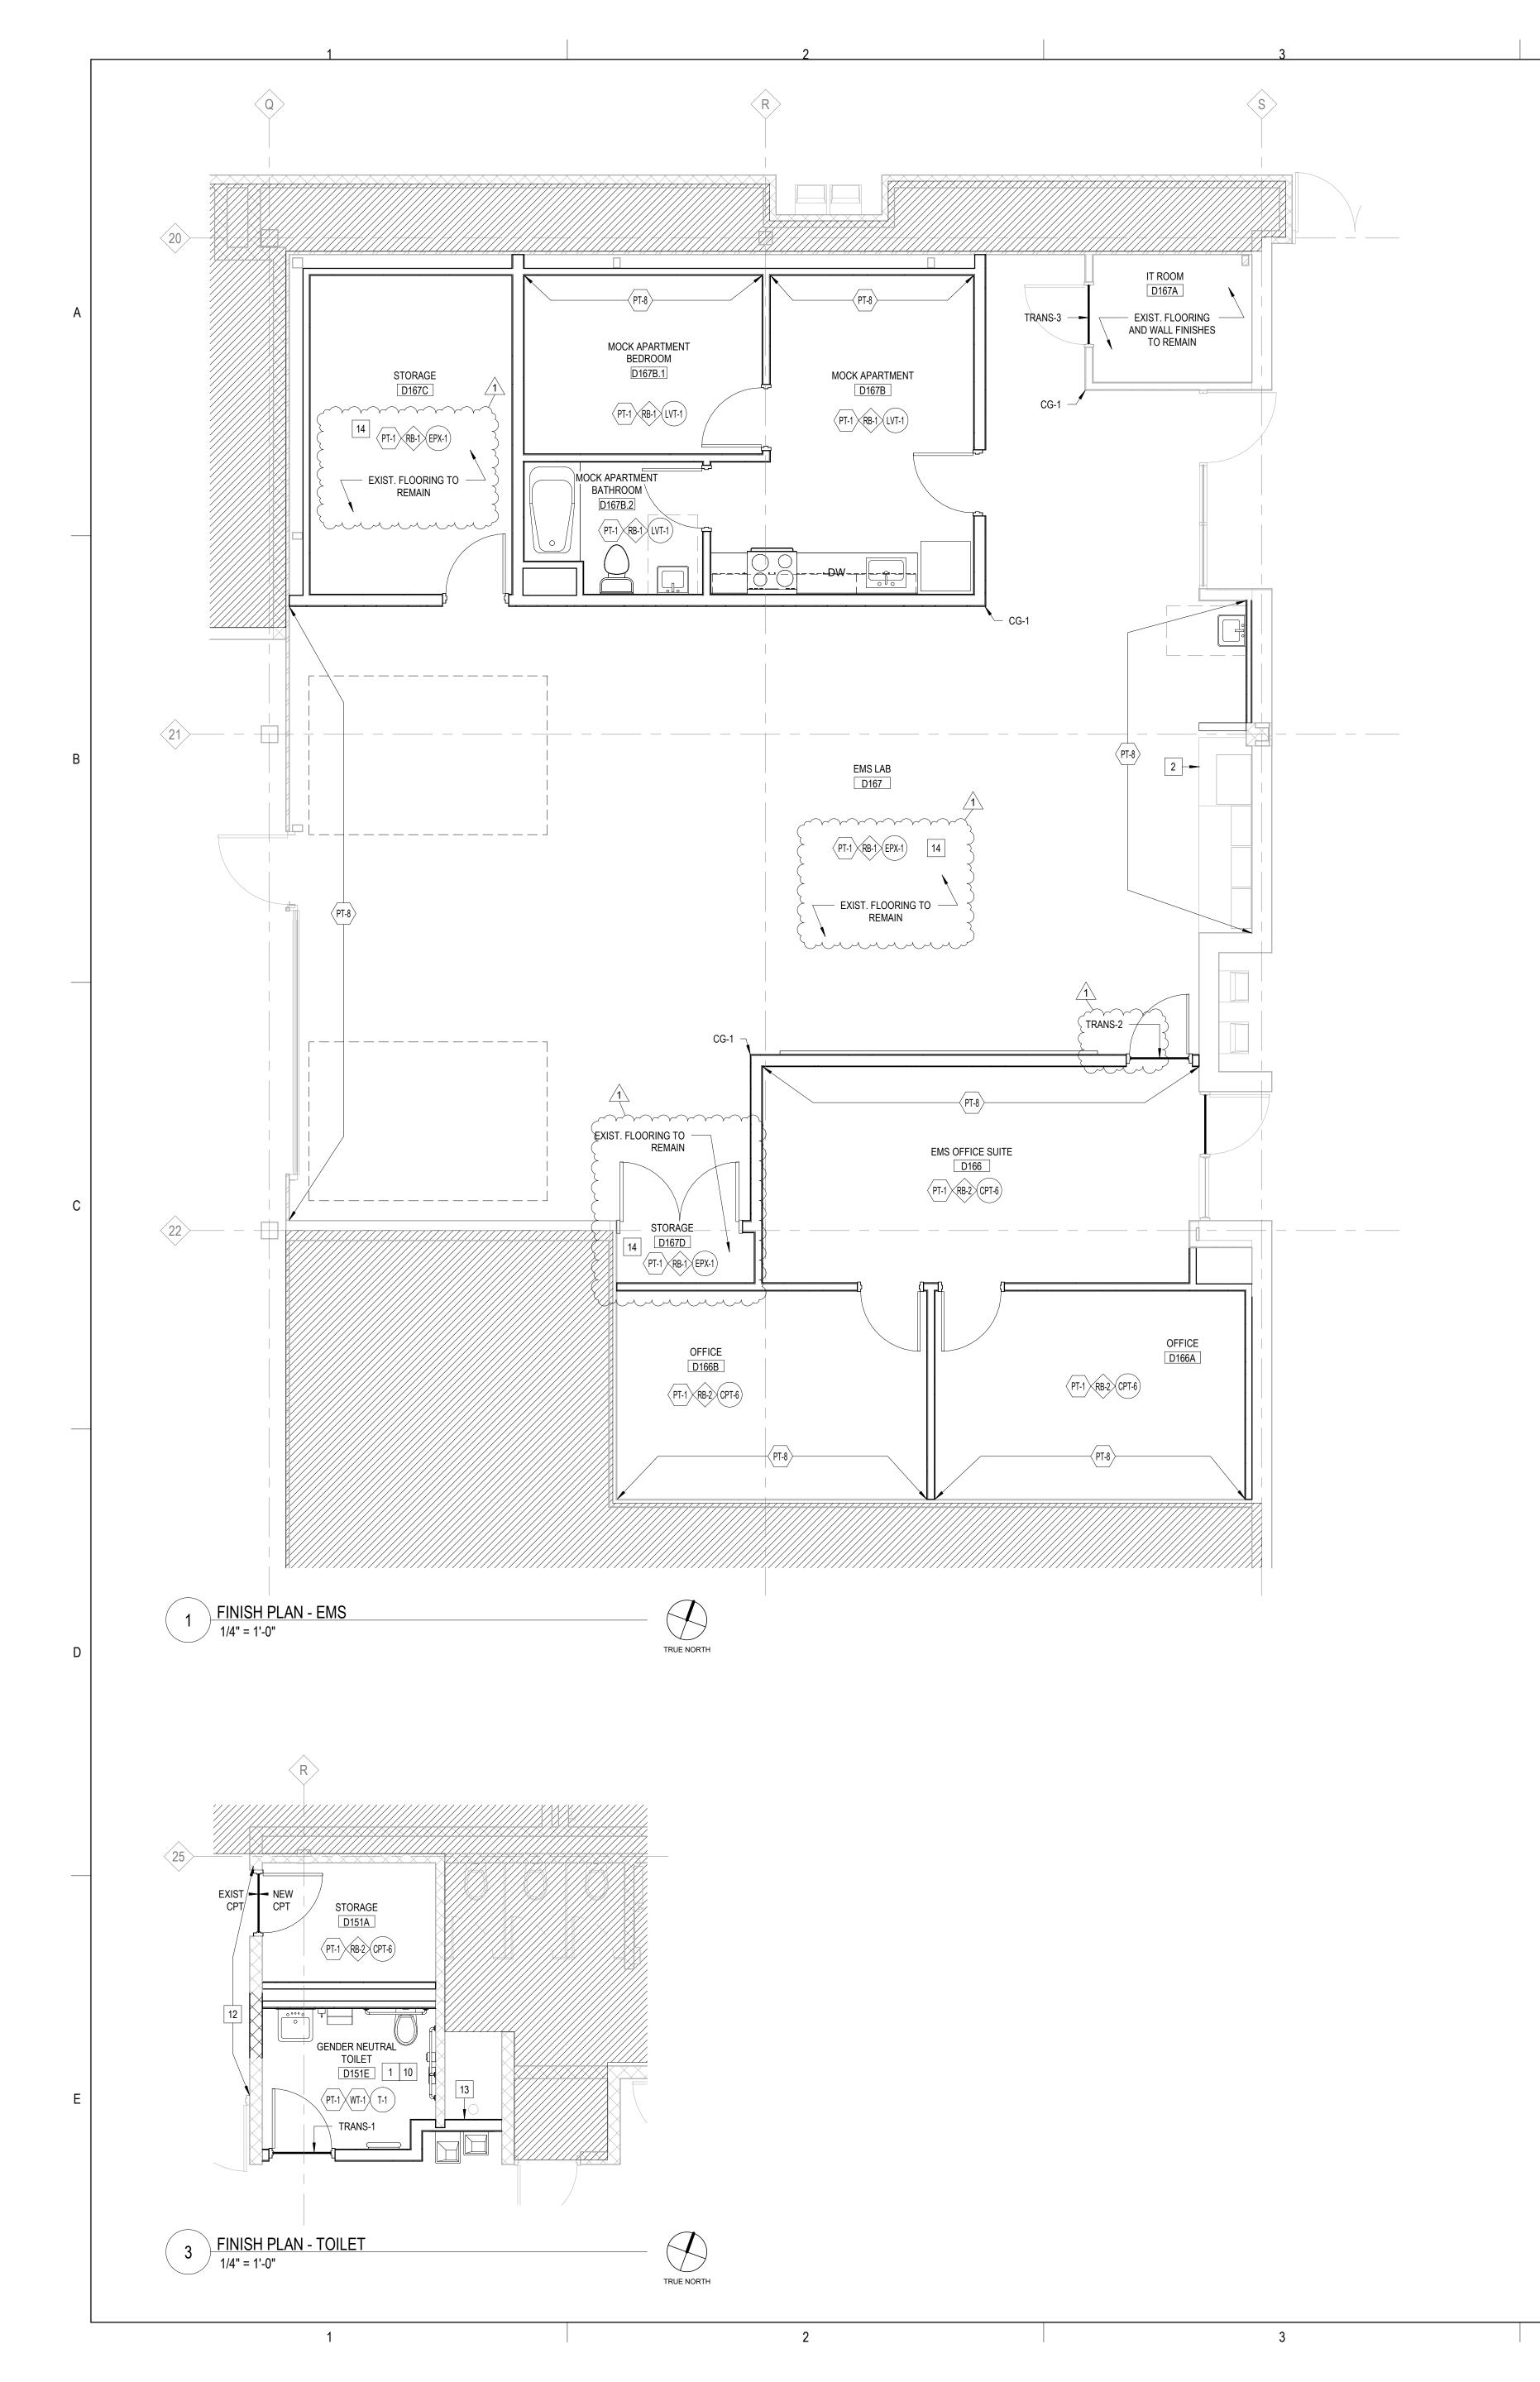
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FINISH PLANS

SHEET NUMBER:

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FINISH PLAN REFERENCED NOTES:

- 1. REFER TO INTERIOR ELEVATIONS FOR EXTENT OF WALL FINISHES AND CLARIFICATIONS. 2. EXISTING CONCRETE PAD BELOW TRANSFORMER TO BE PAINTED SAFETY YELLOW. COORDINATE WITH OWNER ON COLOR SELECTION. PROVIDE SAFETY YELLOW TAPE N FLOOR SURROUNDING EXISTING ELECTRICAL BOXES AS INDICATED ON
 - B. PROVIDE NEW FLOORING, RESILIENT BASE, AND FLOORING TRANSITIONS AS INDICATED. PROTECT ALL EXISTING WALLS, HOLLOW METAL DOOR FRAMES, AND EXISTING WALL PAINT DURING CONSTRUCTION. CLEAN AND PREP FLOOR SLAB AS
- REQUIRED FOR NEW FLOORING FINISH. 4. PROVIDE NEW FLOORING, RESILIENT BASE, AND FLOORING TRANSITIONS AS INDICATED. PREP AND PRIME EXISTING WALLS AND HOLLOW METAL DOOR FRAMES TO RECEIVE NEW PAINT FINISH AS INDICATED. CLEAN AND PREP FLOOR SLAB AS REQUIRED FOR NEW FLOORING FINISH. 5. CUSTOM PRESSURE APPLIED VINYL FILM V-1. VINYL FILM TO BE INSTALLED
- ACROSS ENTIRE STOREFRONT WINDOWS AND DOORS FULL HEIGHT FROM FLOOR TO OP OF STOREFRONT. VINYL FILM TO BE INSTALLED ON COMPUTERS A212.2 SIDE OF THE GLAZING. REFER TO SPECS. 6. PRESSURE APPLIED TRANSPARENT COLORED VINYL FILM V-2. VINYL FILM TO BE INSTALLED FROM 4'-0"AFF TO 6'-0" AFF ACROSS ENTIRE STOREFRONT WINDOWS AND DFOORS. VINYL FILM TO BE INSTALLED ON TUTORING A212A SIDE OF THE
- GLAZING. REFER TO SPECS. ". PRESSURE APPLIED FROSTED VINYL FILM V-3. INSTALL FILM FROM 2'-0" AFF TO 6'-0"
- AFF ACROSS ENTIRE EXISTING WINDOW. REFER TO SPECS.
- 8. PRESSURE APPLIED GRADIENT FROSTED VINYL FILM V-4. INSTALL FILM FROM FLOOR TO 6'-0" AFF ACROSS ENTIRE WINDOW. REFER TO SPECS. 9. POINT AT WHICH THE INSTALLATION OF NEW CARPET MEETS EXISTING CARPET AT
- LOCATIONS NOTED ON PLAN, INSTALL FLOORING TO BE SEAMLESS FROM NEW TO 10. PROVIDE SCHLUTER DILEX-AHK AT ENTIRE FLOOR PERIMETER WHEREVER TILE FLOORING MEETS WALL TILE AND PROVIDE SCHLUTER JOLLY TRIM AT ALL
- VERTICAL TILE CORNERS. 11. PAINT WALLS TO MATCH EXISTING RED AND GRAY PAINT PATTERN AS INDICATED ON PLAN. PAINT PT-10 UP TO FIVE BLOCKS HIGH ONLY ALONG WALLS INDICATED TO MATCH EXISTING GRAY PAINT EXTENTS. PAINT PT-9 STRIPE 1 BLOCK HIGH ABOVE PT-10 ONLY ALONG WALLS INDICATED TO MATCH EXISTING RED PAINT EXTENTS. REMAINDER OF WALLS ABOVE RED STRIPE TO BE PAINTED PT-1. 12. PAINT WALL FULL HEIGHT TO MATCH EXISTING ADJACENT WALLS. PROVIDE NEW WALL BASE TO MATCH EXISTING ADJACENT WALLS.
- 14. PREP EXISTING EPOXY BROADCAST FLOOR AS REQUIRED TO INSTALL NEW SPECIFIED EPOXY FLOOR COATING PER MFR RECCOMENDATIONS INCLUDING ANY \(\zera \) EPOXY FILLER WHERE WALLS WERE DEMO'D TO BRING FLOOR INTO LEVEL. 15. PROVIDE SUBFLOOR LEVELER PER MANUFACTURER'S RECOMMENDATIONS (PRODUCT = TARKETT, JOHNSONITE SUBFLOOR LEVELER OR EQUAL). EXTEND INTO BUILDING D CORRIDOR D001 AS INDICATED ON PLANS. SLOPE TO NOT EXCEED 1:20≺ COORDINATE WITH MANUFACTURER TO ENSURE SUBFLOOR LEVELER IS

13. PAINT WALL FULL HEIGHT TO MATCH EXISTING ADJACENT WALLS. PROVIDE NEW

EPOXY RESIN COVE BASE TO MATCH EXISTING

COMPATIBLE WITH PROPOSED FLOORING.

FINISH PLAN SYMBOLS LEGEND:

X WALL FINISH TYPE (X) WALL BASE TYPE (X) FLOOR FINISH TYPE

FINISH PLAN GENERAL NOTES:

- PAINT ALL EXPOSED CONDUIT, DUCTWORK, PIPING, ETC. IN ALL FINISHED SPACES. REFER TO INTERIOR FINISH PLANS AND REFLECTED CEILING PLANS FOR CLARIFICATIONS.
- PAINT ALL EXPOSED METAL ON EXTERIOR INCLUDING, BUT NOT LIMITED TO: CONDUIT, PIPING, FLASHING, MECHANICAL FLUES AND DUCTS, AND HOLLOW METAL FRAMES AND DOORS AS INDICATED. PROVIDE CEMENTITIOUS SELF-LEVELING UNDERLAYMENT AT REMOVAL OF
- NEW FLOOR FINISH. ALL FINISHES ARE MONUMENTAL PER ROOM UNLESS NOTED OTHERWISE. ALL HOLLOW METAL FRAMES IN CORRIDOR D TO BE PAINTED PT-11 UNLESS
- NOTED OTHERWISE. AT ALL LOCATIONS WHERE CASEWORK IS TO BE INSTALLED, THE SUBSEQUENT

EXISTING FLOOR DRAINS AS REQUIRED TO PROVIDE A LEVEL SUBSTRATE FOR

- BASE TYPE SPECIFIED FOR EACH ROOM SHALL BE INSTALLED OVER CASEWORK TOE KICKS UNLESS NOTED OTHERWISE. REFER TO FLOOR PLANS FOR
- CASEWORK LOCATIONS. PAINT ALL GYP. BD. CEILINGS PT-1 UNLESS NOTED OTHERWISE.
- ALL CARPET TILE TO BE INSTALLED ASHLAR UNLESS SPECIFIED OTHERWISE. . ALL LVT TO BE INSTALLED RANDOM STAGGERED UNLESS SPECIFIED OTHERWISE. 10. ALL QUARTZ TILE TO BE INSTALLED MONOLITHIC UNLESS SPECIFIED OTHERWISE.
- 1. ALL FLOOR TILE TO BE INSTALLED RANDOM STAGGERED UNLESS SPECIFIED
- OTHERWISE. 12. FOR ALL WALLS WITH MULTIPLE WALL FINISH TAGS, REFER TO INTERIOR ELEVATIONS FOR FINISH CLARIFICATION. 13. ALL COLUMNS TO BE PAINTED PT-1 UNLESS NOTED OTHERWISE.

10: ALE GOLOMINO TO BETAMINED TO TONELOG NOTED OTHERWISE.
14. CONTRACTOR TO FIELD VERIFY EXISTING FLOORING TYPES IN ALL ROOMS
SURROUNDING CORRIDOR C001, VEST C003, CORRIDOR D001, AND CORRIDOR
D002 TO CONFIRM TRANSITION TYPES REQUIRED.

WA	ALL FINISH TYF	PES:	X
TYPE	DESCRIPTION	MANUFACTURER	NAME/#/COLOR
PT-1	GENERAL PAINT	BENJAMIN MOORE	2126-70 CHALK WHITE
PT-2	LIGHT GRAY ACCENT PAINT	BENJAMIN MOORE	1480 SLEIGH BELLS
PT-3	MEDIUM GRAY ACCENT PAINT	BENJAMIN MOORE	1482 SABRE GRAY
PT-4	TAUPE ACCENT PAINT	SHERWIN WILLIAMS	SW 9111 ANTLER VELVET
PT-5	LIGHT BLUE ACCENT PAINT	BENJAMIN MOORE	751 SEA ISLE
PT-6	PURPLE ACCENT PAINT	BENJAMIN MOORE	2068-10 MAJESTIC VIOLET
PT-7	BLACK ACCENT PAINT	BENJAMIN MOORE	2132-10 BLACK
PT-8	MEDIUM BLUE ACCENT PAINT	BENJAMIN MOORE	761 MERIDIAN BLUE
PT-9	RED ACCENT PAINT	SHERWIN WILLIAMS	COLOR MATCH TO FIRE ENGINE RED. COORD WITH OWNER
PT-10	GRAY ACCENT PAINT	SHERWIN WILLIAMS	COLOR MATCH TO SW-6256 SERIOUS GRAY. COORD WITH OWNER
PT-11	HOLLOW METAL FRAMES	SHERWIN WILLIAMS, SUPERPAINT, SATIN FINISH	COLOR MATCH TO ANSI 70 GRAY. COORD WITH OWNER FOR COLOR MATCH CODE
WC-1	WALL COVERING	MAHARAM - KNOLL TEXTILES	CASCADE WC2244 / 300148-003 ECHO
WT-1	CERAMIC WALL TILE	VIRGINIATILE	ANATOLIA SOHO, CANVAS WHITE GLOSSY, 8X16
PWP-1	PERFORATED WOOD PANEL	SEE SPEC	SEE SPEC
WD-3	3/4" X 2" SOLID WOOD EDGE TRIM TO MATCH PWP-1	SEE SPEC	SEE SPEC

WA	ALL BASE TYPES	S:	X
TYPE	DESCRIPTION	MANUFACTURER	NAME/#/COLOR
RB-1	4"H COVE RUBBER BASE	JOHNSONITE	40 BLACK
RB-2	4"H STRAIGHT RUBBER BASE	JOHNSONITE	40 BLACK
FI	OOR FINISH TY	PFS:	(Y)
	OOR FINISH TYI		X NAME/#/COLOR
TYPE	DESCRIPTION	MANUFACTURER	NAME/#/COLOR
TYPE CPT-1			
	DESCRIPTION CARPET TILE	MANUFACTURER INTERFACE	NAME/#/COLOR HAPTIC / 106459 BLACK, 9. COLOR BALANCE / 484

CPT-1	CARPET TILE	INTERFACE	HAPTIC / 106459 BLACK, 9X3
CPT-2	CARPET TILE	MOHAWK GROUP	COLOR BALANCE / 484 BLOSSOM, 12X36
CPT-3	CARPET TILE	INTERFACE	WALK THE PLANK / 008764 MAPLE, 9X39
CPT-4	CARPET TILE	INTERFACE	PAINTED GESTURE / 105973 NEUTRAL, 9X39
CPT-5	CARPET TILE	SHAW CONTRACT	WANDER TILE / 5T039 SMOR 24X24, INSTALL: MONOLITH
CPT-6	CARPET TILE	PATCRAFT	SLOPE / 00599 POINT, 12X48
LVT-1	LUXURY VINYL TILE	SHAW CONTRACT	BRANCHING OUT / 56140 RIVERSIDE OAK, 6X48
LVT-2	LUXURY VINYL TILE	SHAW CONTRACT	INLET / 26535 THISTLE, 9X48
LVT-3	LUXURY VINYL TILE	SHAW CONTRACT	INLET / 26549 RAW, 9X48
QT-1	QUARTZ TILE	KAHRS UPOFLOOR	QUARTZ MOSAIC / 8302 CONGLOMERATE GREY, 24X24
T-1	PORCELAIN FLOOR TILE	ATLAS CONCORDE USA	HOMELAND / HOMELAND WHEAT, 8X40
SC	SEALED CONCRETE	SEE SPEC	SEE SPEC
WLKF-1	WALK OFF CARPET	SHAW CONTRACT	WELCOME II TILE / 31549 CHARCOAL, 24X24, INSTALL MQNOLITHIC
EPX-1	EPOXY RESIN COATING	SHERWIN WILLIAMS	RESUFLOR 3746 / LIGHT GR
		nun	munu

FLO	OR TRANSITIC	ON TYPES:	TRANS-X —
TYPE	DESCRIPTION	MANUFACTURER	NAME/#/COLOR
TRANS-1	1/4" TO 1/2"	JOHNSONITE	CE-XX-C, COLOR: 40 BLACK
TRANS-2	1/4" TO SUBFLOOR	JOHNSONITE	SLT-XX-L, COLOR: 40 BLACK
TRANS-3	1/4" TO 1/8"	JOHNSONITE	SLT-XX-A, COLOR: 40 BLACK
TRANS-4	1/4" TO 1/8"	JOHNSONITE	CTA-XX-H, COLOR: 40 BLAC

COF	RNER GUARD 1	TYPES:	CG-X
TYPE	DESCRIPTION	MANUFACTURER	COLOR/ LENGTH
CG-1	WHITE	CS GROUP	VA SERIES, 3/4" X 3/4" ADHESIVE APPLIED, FULL HEIGHT, COLOR: WHITE 949
CG-2	BLACK	CS GROUP	VA SERIES, 3/4" X 3/4" ADHESIVE APPLIED, FULL HEIGHT, COLOR: BLACK 108
CG-3	TAUPE	CS GROUP	VA SERIES, 3/4" X 3/4" ADHESIVE APPLIED, FULL HEIGHT, COLOR: BEIGE 103
CG-4	PURPLE	CS GROUP	LG SERIES, 3/4" X 3/4" ADHESIVE APPLIED, 48"H, COLOR: CLEAR



ARCHITECT OF RECORD DEMONICA KEMPER ARCHITECTS 125 N. HALSTED STREET, SUITE 301 **CHICAGO, IL 60661** P: 312.496.0000

MEP-FP-T-ENGINEERS

20/10 ENGINEERING GROUP, LLC 1216 TOWER ROAD SCHAUMBURG,IL 60173 P: 847.882.2010

KEY PLAN:

SHEET STATUS: **ISSUED FOR BID - NOT** FOR CONSTRUCTION

NO: DESCRIPTION: DATE:

FINISH PLANS

SHEET NUMBER:

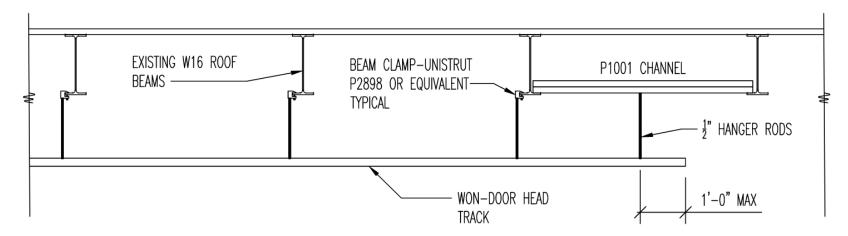
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MCC 2024 RENOVATIONS - BID PACKAGE 2 STRUCTURAL REFERENCE SHEET

11/4/2024 - ADDENDUM #2

REF-2



1 TYPICAL WON DOOR SUPENSION SECTION

REF-1 NOT TO SCALE

P1001 CHANNELS

TWON-DOOR HEAD
TRACK

WON DOOR SUPENSION SECTION AT ENDS OF TRACK

NOT TO SCALE

PLUMBING SPECIFICATIONS

- I.I ALL WORK SHALL BE INSTALLED AND ALL MATERIALS SHALL BE IN STRICT ACCORDANCE WITH ALL APPLICABLE RULES AND REGULATIONS OF ILLINOIS DEPARTMENT OF PUBLIC HEALTH ILLINOIS PLUMBING CODE 2014 EDITION AND ALL LOCAL AMENDMENTS TO THE PLUMBING CODE.
- 1.2 IT SHALL BE THE CONTRACTORS RESPONSIBILITY TO COORDINATE ALL INSPECTIONS WITH THE LOCAL PLUMBING INSPECTOR HAVING JURISDICTION.
- 1.3 EXACT LOCATION OF PLUMBING FIXTURES AND DEVICES SHALL BE VERIFIED WITH ARCHITECTURAL DRAWINGS, ACTUAL BUILDING WALLS, FLOORS AND CEILING, CABINETRY AND EQUIPMENT SHOP DRAWINGS PRIOR TO STARTING ANY WORK.
- 1.4 DRAWINGS ARE GENERALLY DIAGRAMMATIC. ROUTING OF PIPING, ETC., AS SHOWN ON DRAWINGS, DOES NOT INTEND TO SHOW EVERY RISE, DROP, OFFSET, FITTING NOR EVERY STRUCTURAL ELEMENT THAT MAY BE ENCOUNTERED DURING THE INSTALLATION OF THIS WORK. CONTRACTOR SHALL MAKE ANY REQUIRED CHANGES FROM THE GENERAL ROUTING SHOWN ON THESE DRAWINGS, SUCH AS OFFSETS, BENDS OR CHANGES IN ELEVATION DUE TO COORDINATION WITH THE WORK OF OTHER TRADES AND BUILDING CONSTRUCTION. ALL CHANGES SHALL BE MADE WITHOUT ADDITIONAL COST TO THE OWNER OR DELAY IN COMPLETION DATE OF THE PROJECT.
- 1.5 STERILIZATION: ALL NEW, ALTERED OR REPAIRED POTABLE WATER PIPING SHALL BE DISINFECTED, STERILIZED AND FLUSHED PER THE REQUIREMENTS OF THE ILLINOIS STATE PLUMBING CODE 2014 EDITION, SECTIONS 890.1180(a) AND 890.1180(b)(3). CONTRACTOR SHALL STERILIZE AND FLUSH ALL WATER PIPING INCLUDING ALL DOMESTIC HOT WATER SUPPLY AND RETURN AND ALL DOMESTIC COLD WATER PIPING. CONTRACTOR SHALL FURNISH AND INSTALL ALL TEMPORARY TAPPINGS, VALVE OPENINGS, DRAIN FITTINGS, ETC. AS REQUIRED TO STERILIZE AND FLUSH THE WATER SUPPLY PIPING.
- 1.6 ALL EXISTING PIPING INFORMATION SHOWN ON THIS DRAWING HAS BEEN OBTAINED FROM OWNER'S EXISTING CONSTRUCTION DOCUMENTS AND LIMITED FIELD SURVEY. EXACT LOCATION OF EXISTING SANITARY/STORM LINES, WATER LINES, VENT LINES, VALVES AND ALL PIPE SIZES SHALL BE FIELD VERIFIED BEFORE STARTING INSTALLATION.
- 1.7 PLUMBING CONTRACTOR SHALL PROVIDE STACK TEST ON ALL ROUGH AND UNDERGROUND PLUMBING PER ILLINOIS PLUMBING CODE.
- 1.8 PLUMBING CONTRACTOR SHALL PROVIDE PRESSURE TEST ON ALL ABOVE GROUND SANITARY AND VENT PIPING PER ILLINOIS PLUMBING CODE.
- 1,9 PLUMBING CONTRACTOR SHALL PROVIDE 100LB AIR TEST OR WATER PRESSURE TEST ON ALL WATER PIPING AT TIME OF ROUGH INSPECTION PER ILLINOIS PLUMBING CODE.
- 1.10 DEAD END PIPING BEYOND 24 INCHES IN WATER SUPPLY PIPING SHALL NOT BE PERMITTED. DEAD END PIPING BEYOND 10 FEET OF NEAREST VENTED SANITARY PIPING WILL NOT BE PERMITTED PER I.D.P.H. SECTION 890.1320.

PIPE INSULATION

- 2.1 ALL DOMESTIC COLD WATER AND DOMESTIC HOT WATER SUPPLY/RETURN PIPING SHALL BE INSULATED WITH ASTM C547 FIBERGLASS PIPE INSULATION WITH ASTM C1136 VAPOR BARRIER JACKET COMPLETE WITH PVC FITTING COVERS. ALL COLD WATER PIPING SHALL BE INSULATED WITH I" THICK INSULATION. ALL DOMESTIC HOT WATER AND RECIRC PIPING I 1/4" AND SMALLER SHALL BE INSULATED WITH I" INSULATION. ALL DOMESTIC HOT WATER AND RECIRC PIPING I 1/2" AND LARGER SHALL BE INSULATED WITH I 1/2" THICK INSULATION. INSULATE ALL DOMESTIC WATER SUPPLY PIPING TO THE FIXTURE CONNECTION. INSULATE ALL WATER SUPPLY PIPING IN CEILINGS, PLUMBING CHASES AND WALLS.
- 2.2 PATCH AND REFINISH ALL DAMAGED INSULATED SURFACES OF ALL EXISTING PLUMBING PIPING AND ASSOCIATED FITTINGS WHERE NEW CONNECTIONS ARE MADE. INCLUDING BUT NOT LIMITED DOMESTIC COLD WATER, HOT WATER SUPPLY/RETURN AND WASTE.

PIPE HANGERS AND SUPPORTS

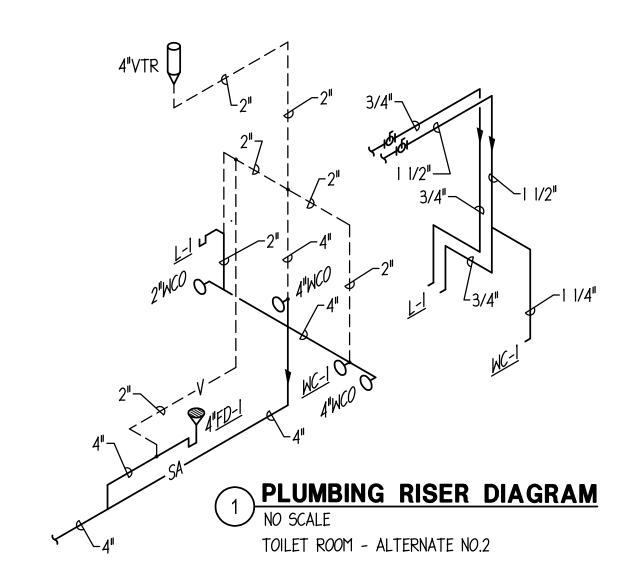
- 3.1 ALL SANITARY, VENT, STORM, DOMESTIC SUPPLY AND RETURN PIPING SHALL BE SUSPENDED WITH CLEVIS AND/OR TRAPEZE PIPE HANGERS. ALL HORIZONTAL STORM, DOMESTIC SUPPLY AND RETURN PIPING SHALL BE INSULATED AND REST ON SHEET METAL INSULATION SHIELDS. SEE DETAIL ON MECHANICAL/ELECTRICAL COORDINATION DRAWINGS FOR ADDITIONAL INFORMATION. SWIVEL JOINT HANGERS MAY BE USED ONLY ON WASTE AND VENT PIPING WHEN PIPING IS NOT INSULATED. HANGER MATERIAL SHALL BE OF COMPATIBLE MATERIAL TO PIPING MATERIAL TO PREVENT CORROSION. HANGERS SHALL BE SUPPORTED FROM STRUCTURAL MEMBERS ONLY.
- 3.2 VERTICAL ATTACHMENT TO METAL DECK AND WOOD TRUSS'S SHALL NOT BE PERMITTED. HORIZONTAL ATTACHMENT TO WOOD TRUSS SHALL BE MADE BY HORIZONTAL SUPPORT TO BOTTOM CORD OF TRUSS.

3.3 HANGER SPACING SHALL BE AS FOLLOWS.

PIPE MATERIAL	MAX HANGER SPACING	ROD DIAMETER
CAST IRON (ALL SIZES)	5 FEET	5/8"
CAST IRON (ALL SIZES) WITH	10 FEET	5/8 "
10 FOOT LENGTH OF PIPE		
COPPER TUBE, I INCH AND SMALLER	8 FEET	1/2"
COPPER TUBE, I 1/4 INCH AND LARGER	10 FEET	1/2"
PVC (ALL SIZĖS)	4 FEET	3/8

PIPE AND VALVE IDENTIFICATION

4.1 PROVIDE PIPE LABELING IDENTIFICATION PER ASME AI3.1. SEE DETAIL FOR ADDITIONAL INFORMATION.



- 5.1 PLUMBING CONTRACTOR SHALL PROVIDE ALL REQUIRED ISOLATION VALVES PER I.D.P.H. SECTION 890.1190. VALVES SHALL BE INSTALLED TO ISOLATE ONE ROOM WITHOUT AFFECTING WATER SUPPLY TO ANY OTHER ROOM.
- 5.2 BALL VALVES SHALL BE MILWAUKEE, NIBCO, STOCKHAM, APOLLO, KITZ, WATTS, OR JOMAR; LEAD FREE NSF-61 CERTIFIED, WITH BRONZE TWO PIECE BODY, STAINLESS STEEL STEM AND BALL, TEFLON SEATS AND STUFFING BOX RING, LEVER HANDLE, SOLDER ENDS, FULL PORT AND CONFORM TO MSS SP-110. WHEN PRESS FITTINGS ARE USED, VIEGA OR NIBCO SHALL BE AN ACCEPTABLE MANUFACTURER OF BALL VALVES.
- 5.3 INSTALL VALVES WITH STEMS UPRIGHT OR HORIZONTAL, NOT INVERTED.
- 5.4 INSTALL VALVES WITH CLEARANCE FOR INSTALLATION OF INSULATION AND ALLOWING ACCESS.
- 5.5 PROVIDE ACCESS TO ALL VALVES AND SYSTEM COMPONENTS REQUIRING ACCESS. ALL PIPING ACCESSORIES AND EQUIPMENT SUCH AS ISOLATION VALVES AND IN-LINE PUMPS SHALL BE INSTALLED AT A REASONABLE HEIGHT AND POSITION IN ORDER TO FACILITATE MAINTENANCE

WATER SHUT-DOWN

6.1 CONTRACTOR SHALL PROVIDE ALL MEANS TO SHUT-DOWN EXISTING PIPING SYSTEMS WHERE REQUIRED TO COMPLETE WORK UNDER THIS CONTRACT. CONTRACTOR SHALL PROVIDE ALL NECESSARY VALVES TO ISOLATE RENOVATED SECTIONS OF THE BUILDING WITHOUT DISTURBING SECTIONS OF THE BUILDING NOT UNDER RENOVATION. CONTRACTOR SHALL PROVIDE ALL MEANS TO DRAIN WATER SUPPLY PIPING WHERE REQUIRED TO MODIFY PIPING CONFIGURATION OR MAKE NEW CONNECTIONS TO EXISTING PIPING. CONTRACTOR SHALL BE RESPONSIBLE FOR ANY WATER DAMAGE CAUSED BY DRAINING OF WATER SUPPLY PIPING. UPON REACTIVATION OF WATER IN PIPING, CONTRACTOR SHALL OPERATE ALL ASSOCIATED FAUCETS, FLUSH VALVES, HOSE VALVES, PLUMBING FIXTURES AND REMOVE ALL REMAINING AIR IN THE SYSTEM.

PIPE ROUTING AND REPLACEMENT

- 7.1 PIPE SIZES INDICATED ON DRAWINGS ARE MINIMUMS. CONTRACTOR SHALL MATCH PIPE SIZE WHEN CONNECTING TO EXISTING PIPING LARGER THAN SIZED LISTED.
- 7.2 NEW PIPING SHALL NOT BE PERMITTED OVER ANY ELECTRICAL PANELS OR EQUIPMENT.
- 7.3 NEW PIPE ROUTING SHALL NOT INTERFERE WITH NORMAL MAINTENANCE OPERATION OF EXISTING EQUIPMENT, ACCESS PANELS, DUCTWORK ACCESS PANELS, DUCTWORK ACCESSORIES, AND ALL HVAC AND ELECTRICAL EQUIPMENT.
- 7.4 ALL PIPING, FITTINGS AND JOINTS SHALL COMPLY WITH THE STATE AND LOCAL AMENDMENTS AND THE AUTHORITY HAVING JURISDICTION. MATERIALS LISTED IN THE SPECIFICATION THAT DO NOT COMPLY WITH THESE AMENDMENTS SHALL NOT BE USED IN THE BIDDING PROCESS. IT SHALL BE THE CONTRACTOR'S RESPONSIBILITY TO VERIFY THESE ADOPTED AMENDMENTS.
- 7.5 WATER SUPPLY PIPING SIZES SHOWN ON DRAWING ARE BASED ON COPPER PIPING. SANITARY, VENT AND STORM PIPING SIZES SHOWN ARE BASED ON CAST IRON PIPING. INNER DIAMETERS SHALL BE REVIEWED WITH IDPH STATE PLUMBING INSPECTOR PRIOR TO INSTALLATION AND SHALL BE OF SUFFICIENT SIZE TO PROVIDE ADEQUATE FLOW AT MINIMAL PRESSURE DROP TO INSURE PLUMBING FIXTURES OPERATE TO OWNER'S SATISFACTION.

SHOP DRAWINGS, SUBMITTALS AND CLOSE OUT DOCUMENTS

- 8.1 CONTRACTOR SHALL SUBMIT ELECTRONIC COPIES IN PDF FORMAT SHOP DRAWINGS OF ALL PIPING, VALVES, PIPE HANGERS, PIPE INSULATION, MISC DEVICES, PUMPS, MIXING VALVES, PLUMBING FIXTURES, ACCESS PANELS, EQUIPMENT, TO ENGINEER FOR APPROVAL PRIOR TO ORDERING ANY ITEMS OR FABRICATING ANY DUCTWORK. SUBMITTALS SHALL BE RETURNED WITHIN TEN BUSINESS DAYS.
- 8.2 AT COMPLETION OF PROJECT, CONTRACTOR SHALL SUBMIT PDF FORMAT OF OPERATION AND MAINTENANCE MANUALS FOR ALL WORK PROVIDED BY HIM ON PROJECT. MANUALS SHALL BE CLEARLY ORGANIZED AND CONTAIN COPIES OF APPROVED EQUIPMENT, COMPONENT BREAK-DOWN AND PARTS LISTS, MAINTENANCE/CLEANING AND TROUBLESHOOTING MANUALS, SERVICE CONTACTS, CONTRACTOR AND MANUFACTURER WARRANTEES, AND "AS BUILT" FLOOR PLANS INDICATING ALL APPROVED DEVIATIONS AND REVISIONS TO BIDDING DOCUMENTS.

PIPE SPECIFICATIONS

PLUMBING PIPING SHALL BE AS FOLLOWS:

- SANITARY SEWER AND VENT PIPING, BURIED WITHIN 5 FEET OF BUILDING A. CAST IRON PIPE: ASTM A74 SERVICE WEIGHT.
- FITTINGS: CAST IRON. JOINTS: HUB-AND-SPIGOT, CISPI HSN COMPRESSION TYPE WITH ASTM C564 NEOPRENE GASKETS OR LEAD AND OAKUM.
- B. PLASTIC PIPE: ASTM D2665, POLYVINYL CHLORIDE (PVC) MATERIAL. FITTINGS: PVC, ASTM D2665. JOINTS: ASTM D2855 SOLVENT WELD WITH ASTM D2564 SOLVENT CEMENT.

SANITARY AND VENT PIPING, ABOVE GRADE

- A, CAST IRON PIPE: CISPI 301, HUBLESS, SERVICE WEIGHT.
- FITTINGS: CAST IRON. JOINTS: CISPI 310, NEOPRENE GASKETS AND STAINLESS STEEL CLAMP AND SHIELD ASSEMBLIES.
- B. PLASTIC PIPE: ASTM D2665, POLYVINYL CHLORIDE (PVC) MATERIAL. FITTINGS: PVC, ASTM D2665. JOINTS: ASTM D2855 SOLVENT WELD WITH ASTM D2564 SOLVENT CEMENT. INSULATE ALL VERTICAL AND HORIZONTAL PIPING FOR SOUND CONTROL.

WATER PIPING, ABOVE GRADE

- A. COPPER TUBING: ASTM B88, TYPE L, HARD DRAWN. FITTINGS: ASME BI6.18, CAST COPPER ALLOY OR ASME BI6.22, WROUGHT COPPER AND BRONZE.
- JOINTS: ASTM B32, SOLDER, GRADE 95TA.
- B. COPPER TUBING: ASTM B88, TYPE L, HARD DRAWN. COPPER PRESS-JOINT FITTINGS: VIEGA PROPRESS; ASME BI6.18 CAST COPPER ALLOY, ASME BI6.22 WROUGHT COPPER, ASME BI6.51 COPPER PRESS-CONNECT PRESSURE FITTINGS, EPDM O-RING AND INTEGRAL LEAK DETECTION. FITTINGS SHALL BE INSTALLED PER MANUFACTURERS RECOMMENDATIONS. ONLY MANUFACTURERS COMPATIBLE PRESS TOOLS SHALL BE USED. OTHER ACCEPTABLE MANUFACTURERS: NIBCO, MUELLER PRS STREAMLINE.

STORM PIPING, ABOVE GRADE

- A, CAST IRON PIPE: CISPI 301, HUBLESS, SERVICE WEIGHT. FITTINGS: CAST IRON.
- JOINTS: CISPI 310, NEOPRENE GASKETS AND STAINLESS STEEL CLAMP AND SHIELD ASSEMBLIES.

LUMBING FIXTURE TAG	TYPE	MANUFACTURER AND MODEL	DESCRIPTION	OTHER ACCEPTABLE MANUFACTURERS	NOTES
<u>WC-1</u>	WATER CL <i>O</i> SET	BOWL: KOHLER KINGSTON K-4325 FLUSH VALVE: SLOAN VALVE OPTIMA G2 8III-1.28 SEAT: BEMIS 2I55-SSCT CARRIER: JR SMITH 02IIY/022IY (M58 & M54)	BOWL: WALL MOUNTED, SIPHON JET, WHITE, VITREOUS CHINA BOWL WITH ELONGATED BOWL AND I 1/2" TOP SPUD. CHINA SHALL BE UNIVERSAL FLOW COMPATIBLE AND OPERATE AT 1.28-1.6 GPF. FLUSH VALVE: EXPOSED CHROME PLATED, BATTERY POWERED SENSOR OPERATED, 1.6 GALLONS PER FLUSH, INTEGRAL SCREWDRIVER STOP AND VACUUM BREAKER. SEAT: WHITE, ELONGATED, OPEN FRONT, ANTI-MICROBACTERIAL. CARRIER: AII2.6 IM-97, ADJUSTABLE HORIZONTAL CONFIGURATION. 500LB RATING.	BOWL: AMERICAN STANDARD, ZURN, & MANSFIELD FLUSH VALVE: NONE. SEAT: CHURCH, OLSONITE & SPERZAL CARRIER: MIFAB, WADE, ZURN JOSAM, WATTS	1,8
<u>L-l</u>	ADA COMPLIANT LAVATORY	BASIN: KOHLER KINGSTON K-2005 TRIM: SLOAN VALVE MODEL EBF-650 CARRIER: JR SMITH 0700-M32	WHITE VITREOUS CHINA WALL HUNG LAVATORY, 21x18 MINIMUM, 5" HIGH BACK, DRILLINGS ON 4" CENTERS, CONCEALED ARM SUPPORT, RECTANGULAR BASIN WITH SPLASH LIP AND FRONT OVERFLOW. FAUCET: CHROME PLATED, BATTERY POWERED SENSOR OPERATED, 4" CENTERS, 0.5 GPM AERATOR & ADA COMPLIANT. CARRIER: LACQUERED STEEL FRAME WITH LEGS, FEET FOR FLOOR ATTACHMENT, CONCEALED ARMS. FAUCET SHALL HAVE A MINIMUM 3-YEAR WARRANTY.	BOWL: AMERICAN STANDARD, ZURN, & MANSFIELD FAUCET: MOEN COMMERCIAL, T&S BRASS, FAUCET: CHICAGO FAUCET CARRIER: MIFAB, WADE, ZURN JOSAM, WATTS	1,2,3,4,5,6,8
<u>5-1</u>	SINK	BASIN: ELKAY, MODEL LUSTERTONE LRAD252155 TRIM: MOEN COMMERCIAL MODEL 8225	ASME AII2.19.3; SINGLE BOWL SELF RIMMING DROP-IN 25"Lx21"W x 5.5"D OVERALL DIMENSIONS, 18 GAUGE THICK, TYPE 304 STAINLESS STEEL. FAUCET SHALL BE CHROME PLATED BRASS SUPPLY WITH 8" SWING SPOUT, WATER ECONOMY AERATOR WITH MAXIMUM 1.5 GPM FLOW RATE, WITH INDEXED WRIST BLADE LEVER HANDLES ON 8" CENTERS, INTERCONNECTING COPPER TUBING CONNECTING FAUCET.	BASIN: JUST, FRANKE, ACORN TRIM: CHICAGO FAUCET, T&S BRASS, ZURN	1,2,4,5,6,7,8
<u>5-2</u>	SINK	BASIN: KOHLER KINGSTON K-2005 TRIM: SLOAN VALVE MODEL EBF-650 CARRIER: JR SMITH 0700-M32	WHITE VITREOUS CHINA WALL HUNG LAVATORY, 21x18 MINIMUM, 5" HIGH BACK, DRILLINGS ON 4" CENTERS, CONCEALED ARM SUPPORT, RECTANGULAR BASIN WITH SPLASH LIP AND FRONT OVERFLOW. FAUCET: CHROME PLATED, BATTERY POWERED SENSOR OPERATED, 4" CENTERS, 0.5 GPM AERATOR & ADA COMPLIANT. CARRIER: LACQUERED STEEL FRAME WITH LEGS, FEET FOR FLOOR ATTACHMENT, CONCEALED ARMS. FAUCET SHALL HAVE A MINIMUM 3-YEAR WARRANTY.	BOWL: AMERICAN STANDARD, ZURN, & MANSFIELD FAUCET: MOEN COMMERCIAL, T&S BRASS, FAUCET: CHICAGO FAUCET CARRIER: MIFAB, WADE, ZURN JOSAM, WATTS	1,2,3,4,5,6,8
<u>EWC-I</u>	ELECTRIC WATER COOLER	FOUNTAIN: ELKAY, MODEL LZSTL8WSSP	ARI 1010; TWO STATION WALL MOUNTED ELECTRIC WATER COOLER WITH BOTTLE FILLING STATION, WATER FILTER, STAINLESS STEEL BODY, ELEVATED ANTI-SQUIRT BUBBLER, LOWER STAINLESS STEEL SHROUD.	NONE.	1,2,4
<u>FD-1</u>	FLOOR DRAIN	ZURN, MODEL ZN415B	ANSIAII2.21.1; LACQUERED CAST IRON BODY WITH DOUBLE DRAINAGE FLANGE, WEEPHOLES, AND SQUARE ADJUSTABLE NICKEL BRONZE STRAINER.	J.R. SMITH, WADE, WATTS, MIFAB	
TMV-I	THERMOSTATIC MIXING VALVE	LEONARD MODEL 170LF	ASSE 1070; CAST BRASS BODY WITH ROUGH BRONZE FINISH, LOCKING TEMPERATURE REGULATOR, WITH INTEGRAL CHECK VALVES AND INLINE SCREENS ON BOTH INLETS.	POWERS, WATTS, ZURN.	
FIXTURES	FOR MOCK UP AF	PARTMENT	· · · · · · · · · · · · · · · · · · ·		
<u>WC-2</u>	WATER CLOSET	GLACIER BAY MODEL N2428E	FLOOR MOUNTED WHITE TANK TYPE TOILET WITH SEAT	APPROVED EQUAL.	9
<u>BT-I</u>	BATH TUB	TUB: AMERICAN STANDARD MODEL 2394.202.020 SHOWER VALVE: MOEN MODEL 82603	60"x34" WHITE TUB, 14" TALL, WITH CHROME, SHOWER VALVE, TUB SPOUT AND SHOWER HEAD, LEFT/RIGHT ORIENTATION TO BE VERIFIED BY CONTRACTOR.	APPROVED EQUAL.	q
<u>L-2</u>	LAVATORY	BASIN: GLACIER BAY MODEL GB24P2-WH FAUCET: GLACIER BAY MODEL HD67499W-6401	25"xI9" WHITE VANITY CABINET WITH WHITE COUNTER TOP AND LAVATORY FAUCET, CHROME, 4" CENTERS QUARTER TURN	APPROVED EQUAL.	9
		†	25"x22" STAINLESS STEEL DROP-IN KITCHEN SINK WITH	APPROVED EQUAL.	

- 3. PROVIDE CHROME PERFORATED OPEN STRAINER. 4. PROVIDE (BRASSCRAFT MODEL KTSCRI9XC) CHROME QUARTER-TURN ANGLE STOP VALVES WITH LOOSE KEY, CHROME ESCUTCHEONS,
- CHROME PLATED RIGID SUPPLIES OR APPROVED EQUAL.
- 5. INSULATE P-TRAP, DRAIN AND SUPPLY PIPING WITH TRUEBRO OR PLUMBEREX MODEL X4333 INSULATION OR APPROVED EQUAL. MATERIAL SHALL BE MOLDED (PVC) POLYVINYL CHLORIDE BASED, FOAM BASED MATERIAL WILL NOT BE PERMITTED. WHITE IN COLOR.
- 6. PROVIDE ASSE 1070 POINT OF USE THERMOSTATIC MIXING VALVE TYPE TMV-1 WITH CHROME RIGID SUPPLIES
- 7. PROVIDE ELKAY MODEL LK35 STRAINER BASKET EACH BOWL, DELETE WHERE THERE IS A GARBAGE DISPOSER.
- 8. CAULK FIXTURE TO FLOOR, WALL OR COUNTER TOP WITH MATCHING COLOR CAULK.
- 9. FIXTURE USED FOR EDUCATIONAL PURPOSES AND SHALL HAVE NO PLUMBING WATER SUPPLY AND SANITARY CONNECTIONS.

PLUMBING SYMBOLS AND ABBREVIATIONS

	AFF.	ABOVE FINISHED FLOOR	CW	DOMESTIC COLD WATER
	AP	ACCESS PANEL	——————————————————————————————————————	DOMESTIC HOT WATER
	BFP	BACK FLOW PREVENTER	——————————————————————————————————————	DOMESTIC HOT WATER CIRCULATING
	CI	CAST IRON	ST	SUSPENDED STORM SEWER
	СО	CLEANOUT	sa	UNDERGROUND SANITARY SEWER
	CW	COLD WATER	V	CUCDENDED VENT DIDING
	EWC	ELECTRIC WATER COOLER	V	SUSPENDED VENT PIPING
	FCO	FLOOR CLEANOUT		PIPING TO BE REMOVED (DEMOLITION DRAWING ONLY)
	FD	FLOOR DRAIN	────	GATE VALVE
	HW	HOT WATER		CHECK VALVE
	HWC	HOT WATER CIRCULATING		BALL VALVE
	L	LAVATORY		CIRCUIT BALANCING VALVE W/BALANCING PORTS
	NC	NEW CONNECTION		DIRECTION OF FLOW
	SA	SANITARY		DIDE ELDON /TUDNED LID)
	TMV	THERMOSTATIC MIXING VALVE		PIPE ELBOW (TURNED UP) PIPE ELBOW (TURNED DOWN)
	TYP.	TYPICAL		·
	٧	VENT		PIPE TEE DOWN (DROP)
	VTR	VENT THROUGH ROOF		PIPE TEE UP
	WC	WATER CLOSET		PIPE TEE UP OR ANGLE
	WCO	WALL CLEANOUT		PIPE TEE DOWN OR ANGLE
<i>∞</i>				NEW CONNECTION
⊗	<u>. 55</u>	FLOOR CLEANOUT (ROUND)		CLEANOUT IN SUSPENDED CEILING
	<u>FD</u>	FLOOR DRAIN (ROUND)		



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KEY PLAN:

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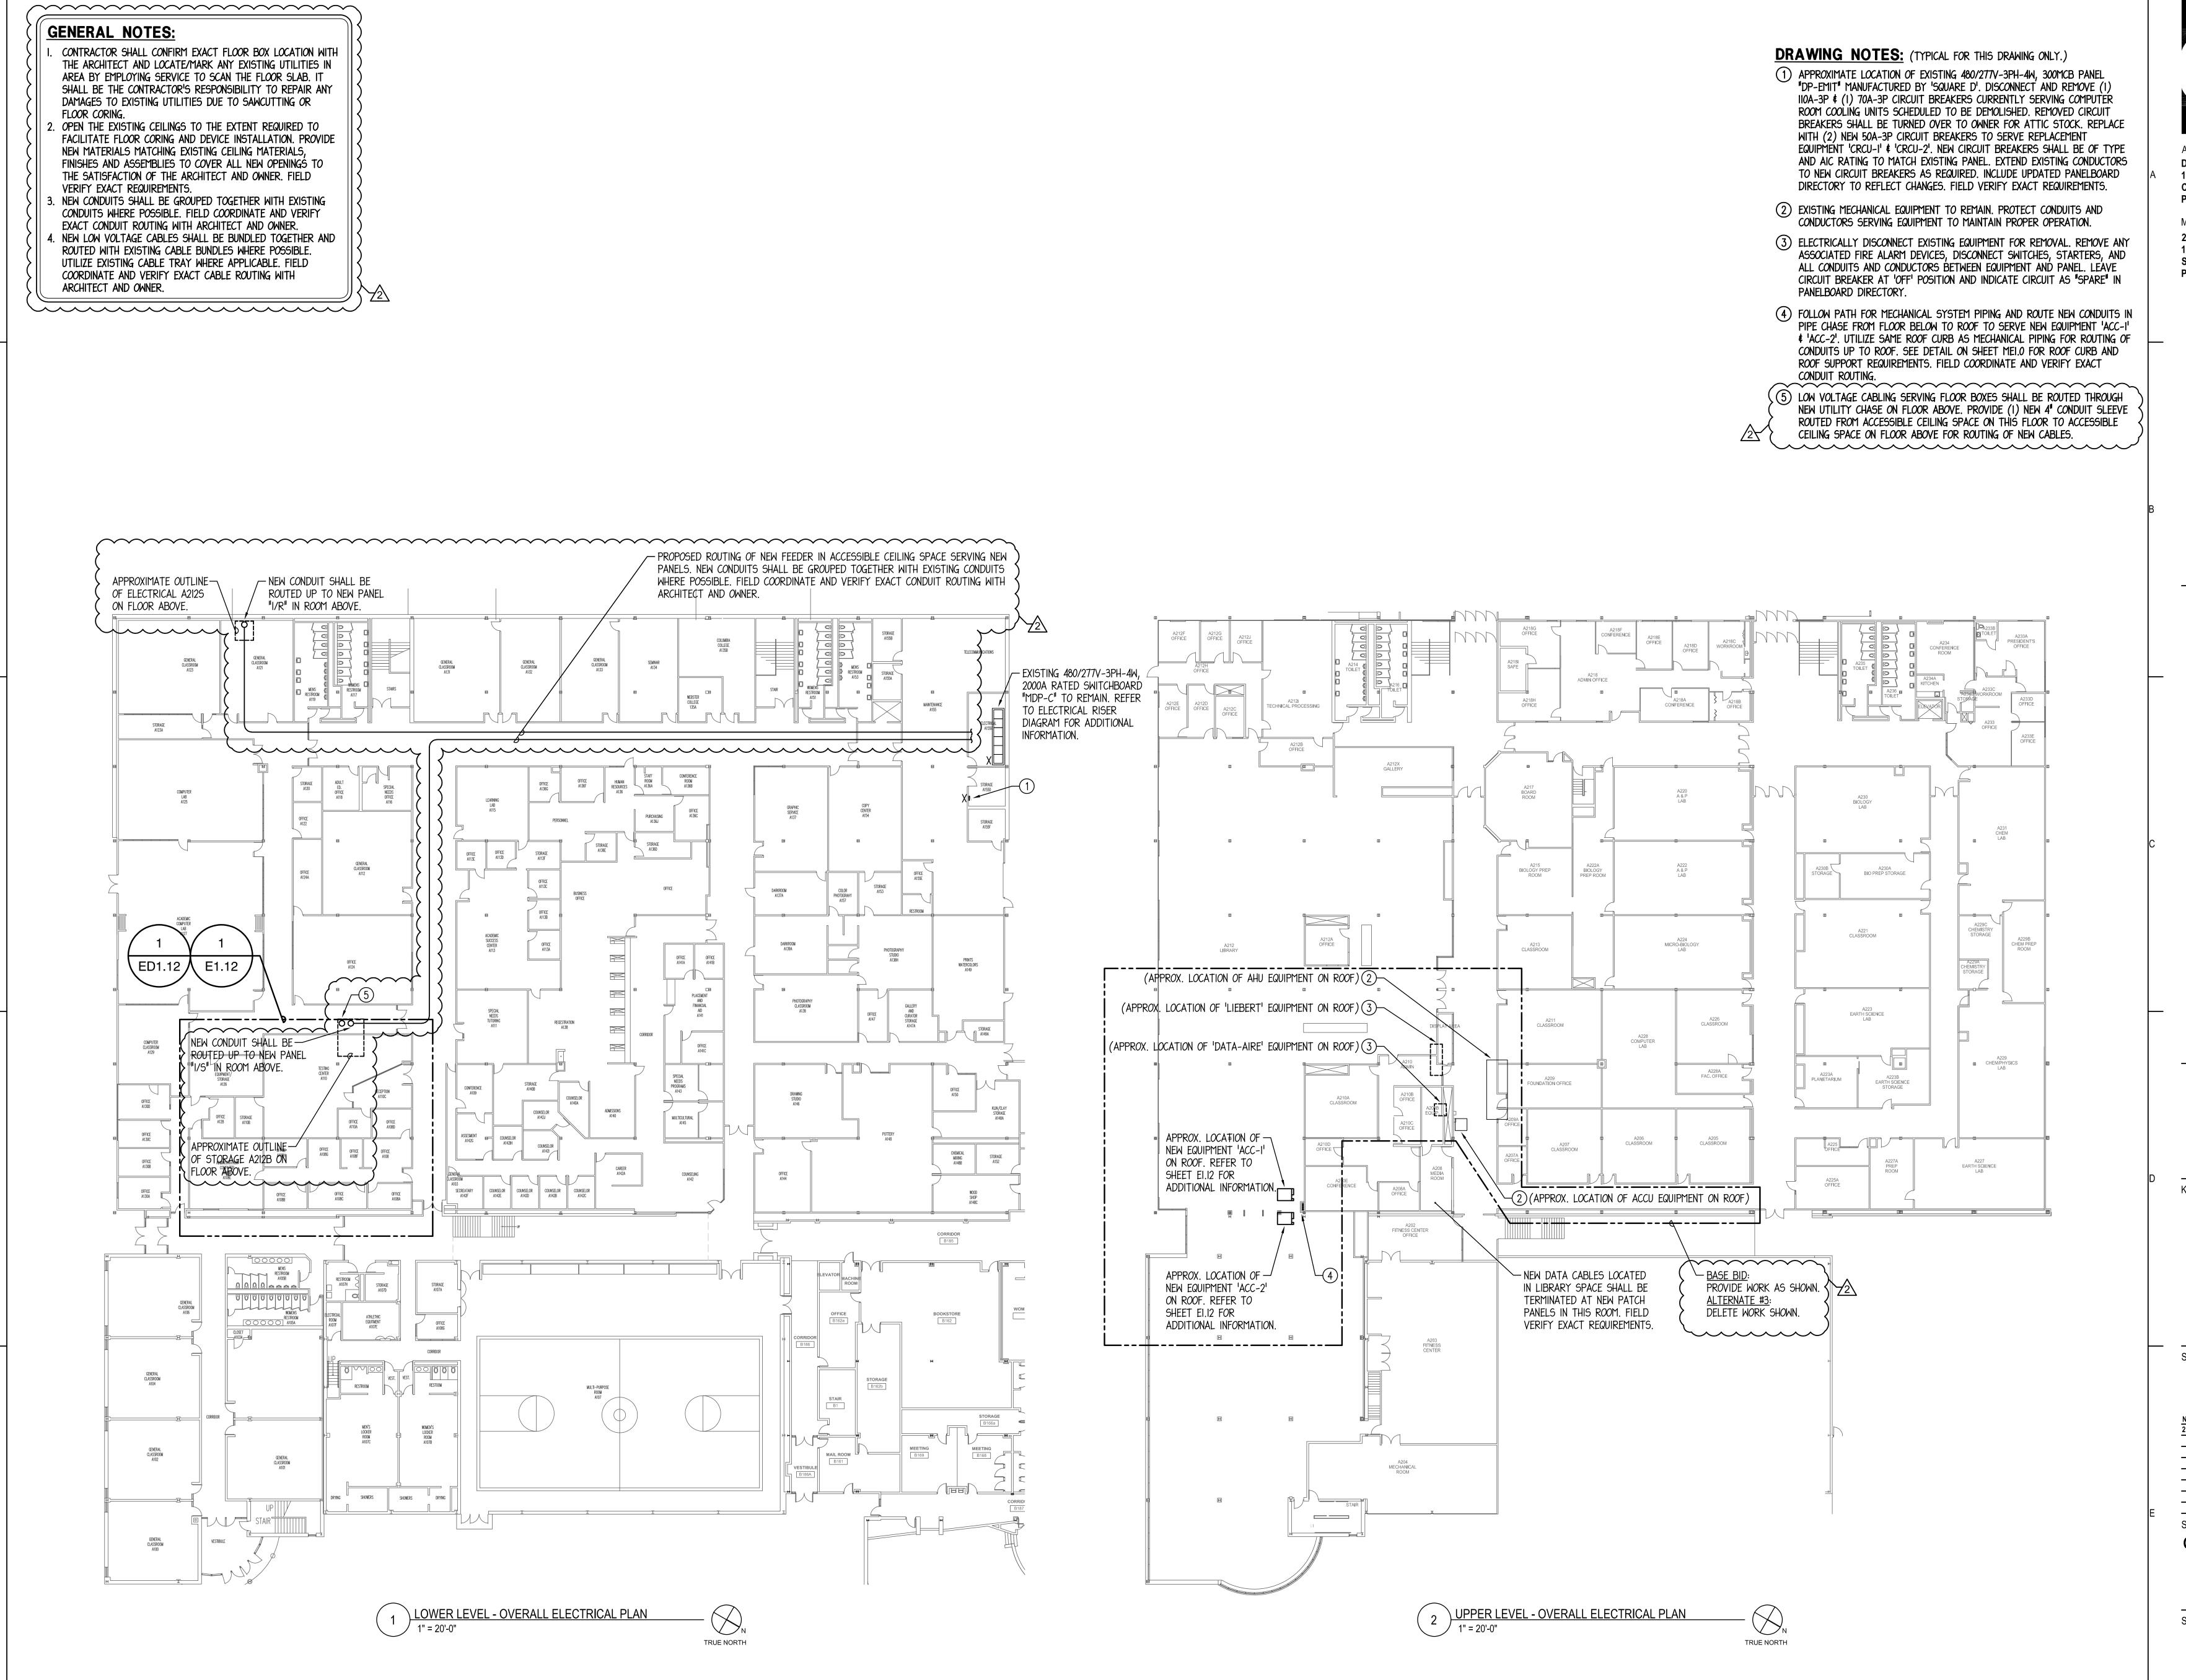
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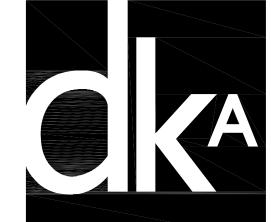
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PLUMBING GENERAL

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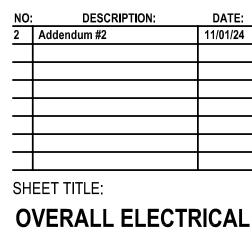


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SHEET STATUS: **ISSUED FOR BID - NOT** FOR CONSTRUCTION



PLANS

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DRAWING NOTES

I CONFIRM EXACT LOCATION OF DEVICES SERVING WORKSTATIONS PRIOR TO ROUGH-IN WITH ARCHITECT AND/OR GENERAL CONTRACTOR.

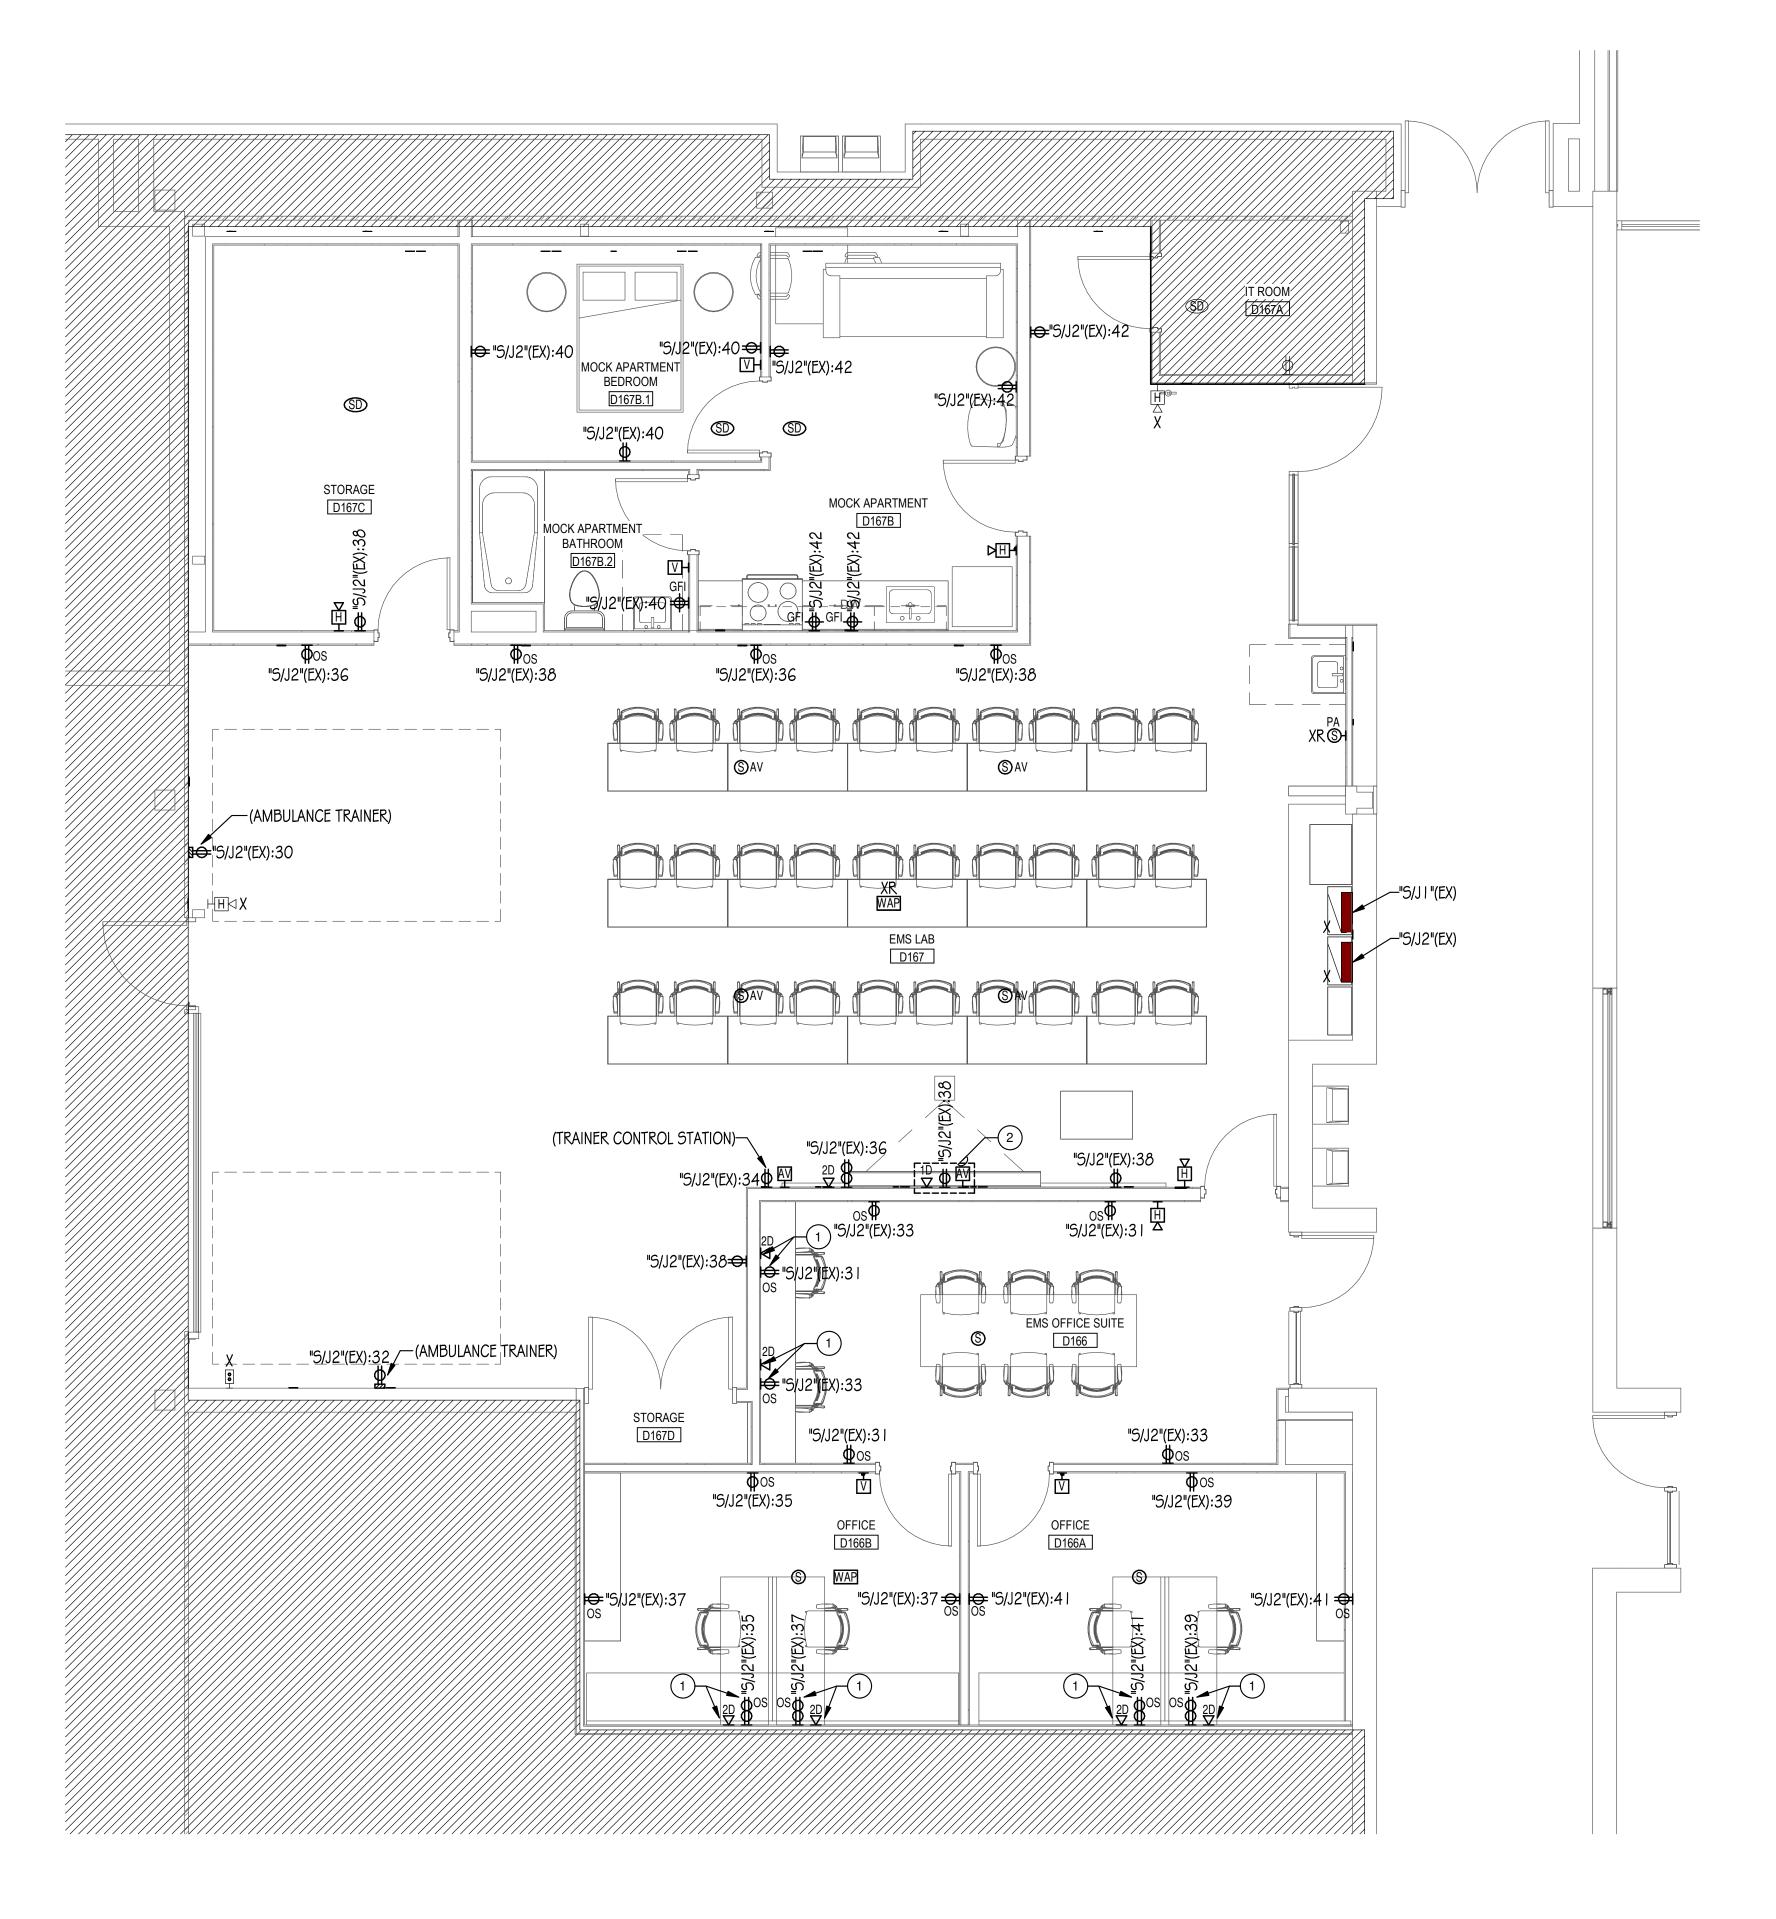
2 FOR WALL-MOUNTED SHORT-THROW PROJECTOR. CONFIRM EXACT LOCATION PRIOR TO ROUGH-IN WITH ARCHITECT AND/OR GENERAL CONTRACTOR.

3 INSTALL RECEPTACLE FOR ELECTRIC WATER COOLER (EWC) WITHIN EWC CABINET AS

RECOMMENDED BY MANUFACTURER.

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TRUE NORTH

1 ELECTRICAL PLAN - EMS 1/4" = 1'-0"

SD STORAGE D151A

ELECTRICAL PLAN - GENDER NEUTRAL TOILET

TRUE NORTH

GENDER NEUTRAL
TOILET
D151E

GENDER NEUTRAL
CONTROL
CO

"S/H"(EX):26

2 (ALTERNATE #2) 1/4" = 1'-0"

GENERAL NOTES:

UNLESS INDICATED OTHERWISE, CONTRACTOR SHALL CHANNEL EXISTING DRYWALL AS REQUIRED TO CONCEAL CONDUITS AND RECESS MOUNTED JUNCTION BOXES FOR ELECTRICAL DEVICES. COORDINATE WALL PATCHING REQUIREMENTS WITH GENERAL TRADES CONTRACTOR. WHERE RECESS MOUNTING IS NOT FEASIBLE, INFORM ARCHITECT AND/OR GENERAL

CONTRACTOR PRIOR TO INSTALLATION. CONTRACTOR SHALL CONFIRM EXACT FLOOR BOX LOCATION WITH THE ARCHITECT AND LOCATE/MARK ANY EXISTING UTILITIES IN AREA BY EMPLOYING SERVICE TO SCAN THE FLOOR SLAB. IT SHALL BE THE CONTRACTOR'S RESPONSIBILITY TO REPAIR ANY DAMAGES TO EXISTING UTILITIES DUE TO SAWCUTTING.

REFER TO MECHANICAL PLANS FOR EXACT LOCATIONS OF THERMOSTAT/CARBON DIOXIDE DETECTORS. PROVIDE SINGLE GANG BACKBOX AND EMPTY 3/4" CONDUIT WITH PULL STRING STUBBED INTO AN ACCESSIBLE CEILING SPACE FOR INSTALLATION OF THERMOSTAT/CARBON DIOXIDE DETECTORS.

SHEET STATUS: **ISSUED FOR BID - NOT** FOR CONSTRUCTION

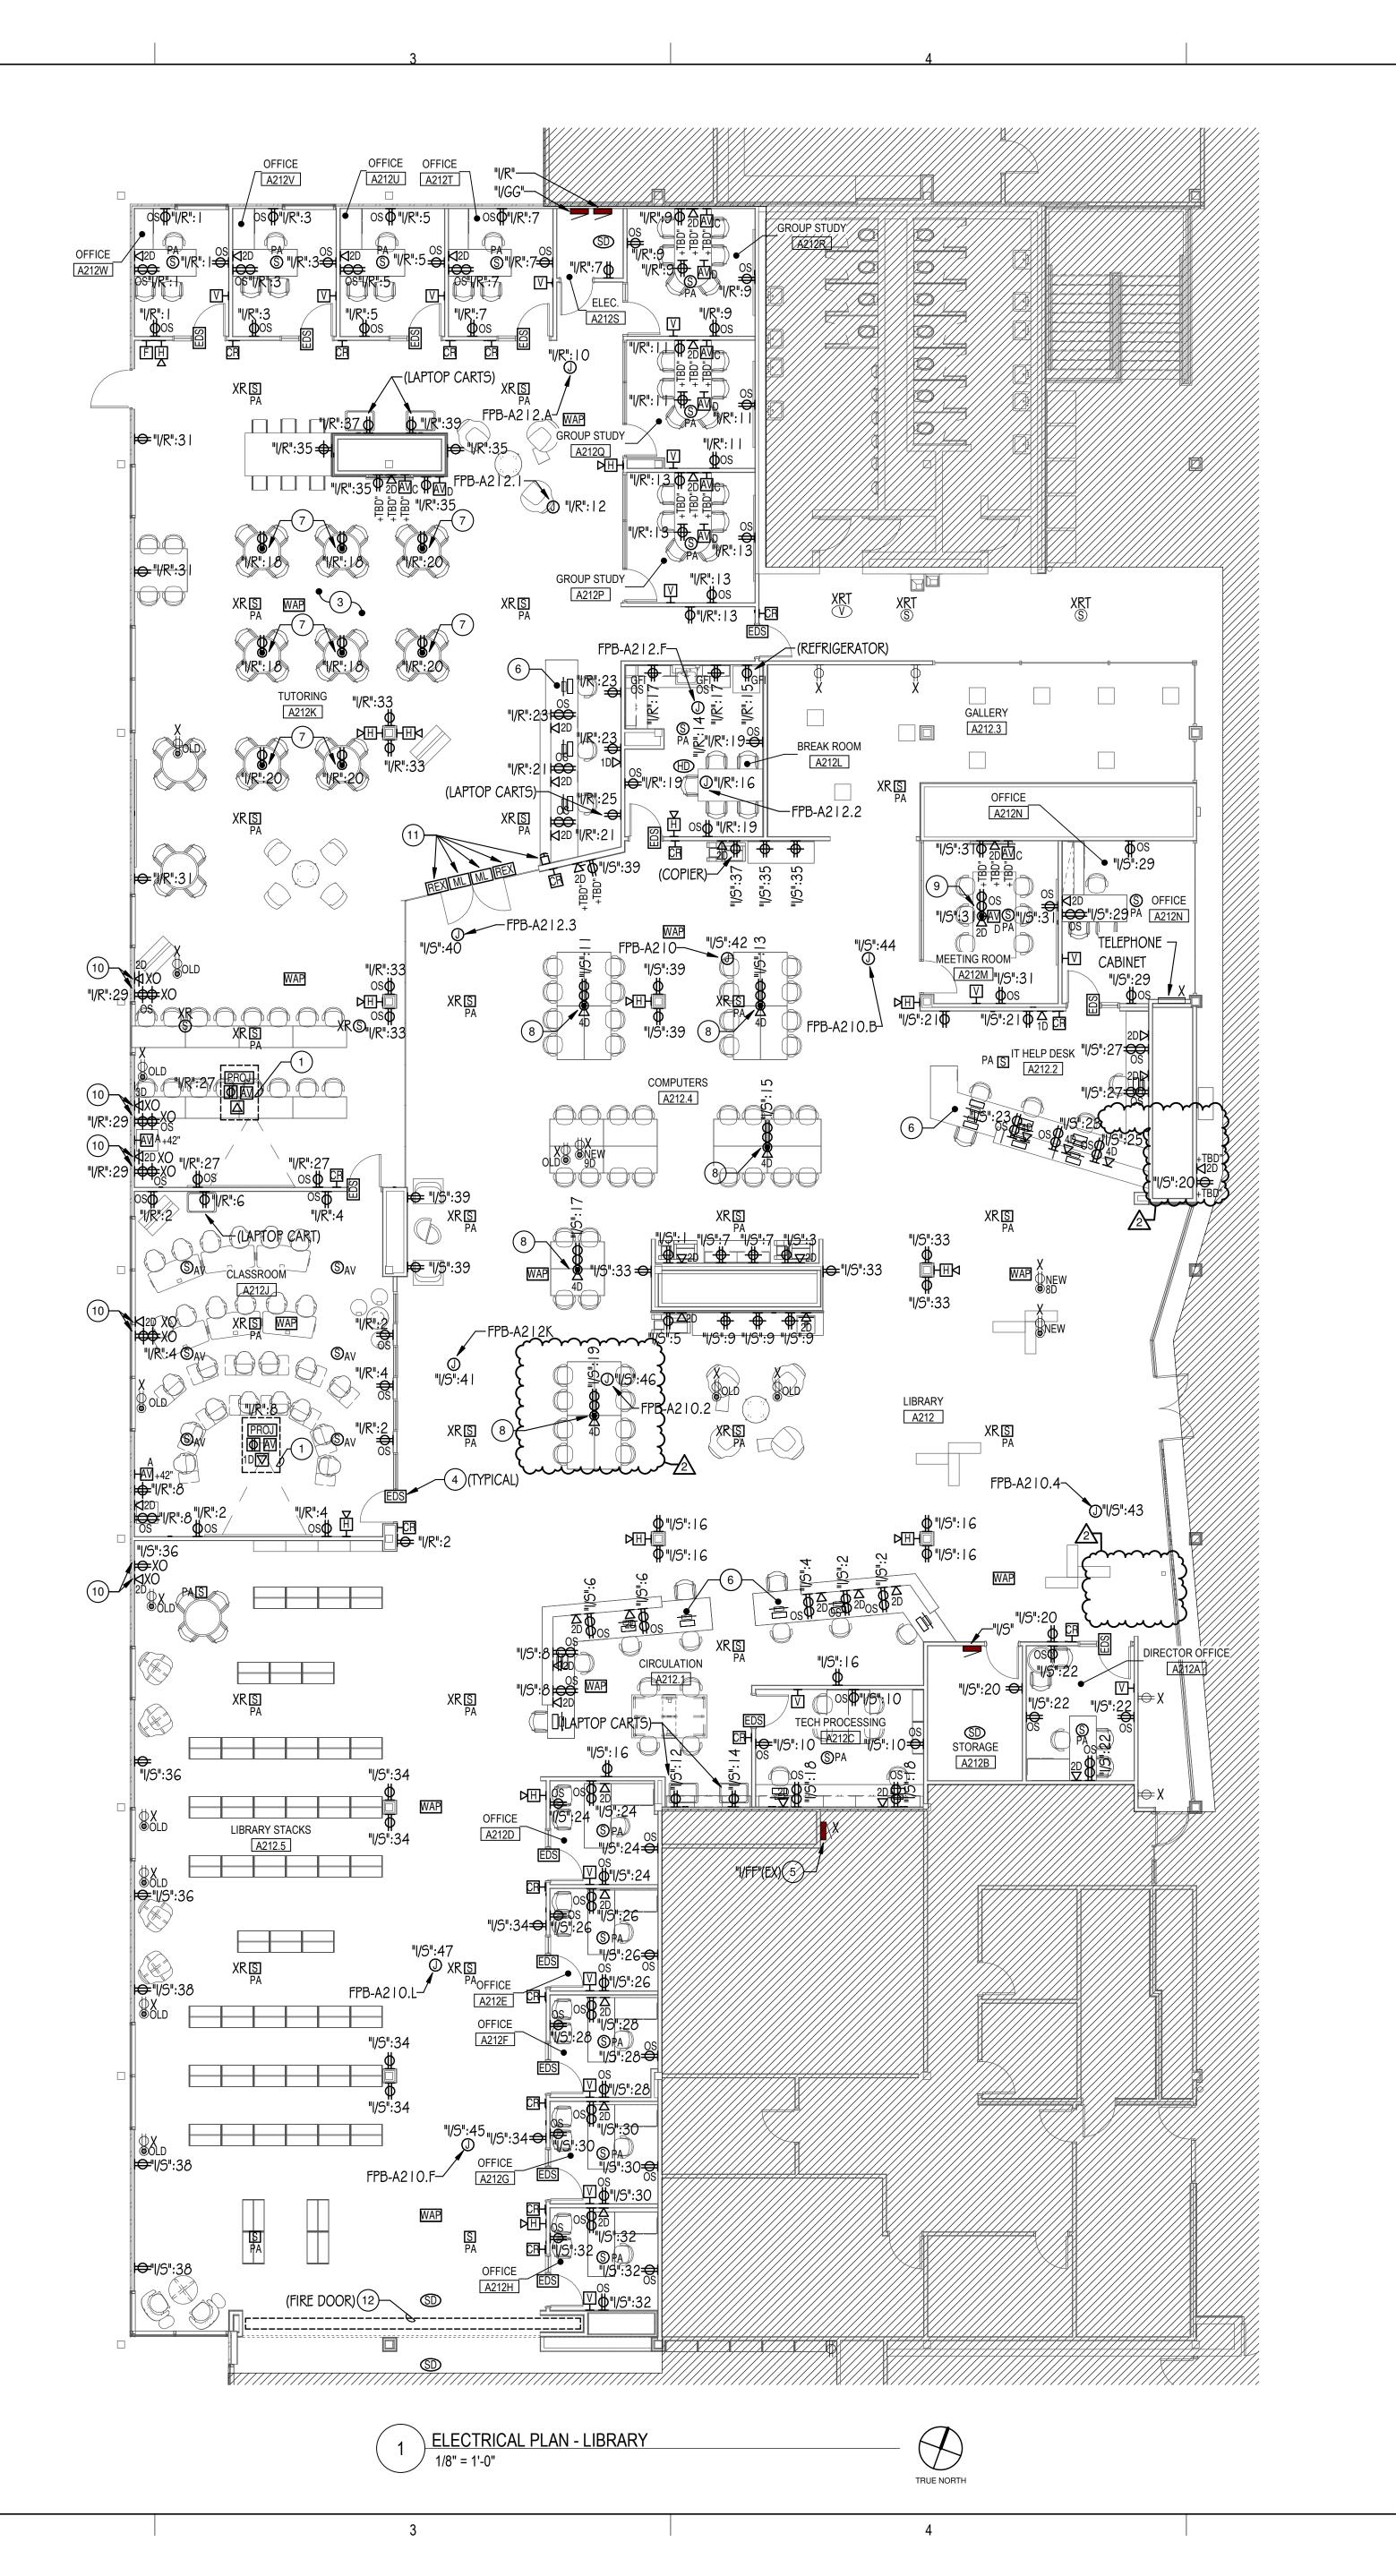
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ELECTRICAL PLANS

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DRAWING NOTES

I DEVICES SHALL BE LOCATED INSIDE CEILING MOUNTED ENCLOSURE / PROJECTOR MOUNT.

REFER TO ELECTRICAL DETAILS SHEET FOR ADDITIONAL INFORMATION.

2 NOT USED.

3 CONFIRM FINAL LAYOUT OF POKE-THROUGH FLOOR BOXES WITH OWNER PRIOR TO INSTALLATION.

- 4 PROVIDE I 20VAC CONNECTION TO LOW VOLTAGE TRANSFORMER FOR ELECTRIC STRIKE TO NEAREST RECEPTACLE BRANCH CIRCUIT. INSTALL AND WIRE PER DOOR MANUFACTURER'S INSTRUCTIONS FOR A COMPLETE AND OPERABLE SYSTEM.
- 5 CONTRACTOR SHALL VERIFY THAT NO BRANCH CIRCUITS IN EXISTING PANEL "I/FF" IS SERVING THE LIBRARY AT THE END OF THE PROJECT. ANY EXISTING BRANCH CIRCUITS SERVING LIBRARY THAT IS SCHEDULED TO REMAIN SHALL BE EXTENDED TO NEW PANEL "I/S". FIELD VERIFY EXACT REQUIREMENTS.
- 6 DEVICES SHOWN SHALL BE RECESSED IN MILLWORK KNEEWALL. PROVIDE MINIMUM 3/4" CONDUITS FOR POWER, MINIMUM 1 1/4" CONDUITS FOR LOW VOLTAGE. CONDUITS SHALL BE ROUTED INSIDE UTILITY CHASE. REFER TO ARCHITECTURAL SHEETS FOR ADDITIONAL INFORMATION. COORDINATE INSTALLATION WITH MILLWORK CONTRACTOR AND FIELD VERIFY FINAL DEVICE LOCATION PRIOR TO ROUGH-IN.
- 7 PROVIDE 4" ROUND RECESSED POKE-THRU DEVICE AS MANUFACTURED BY LEGRAND WIREMOLD EVOLUTION SERIES #4ATC(XX). INCLUDE SURFACE STYLE COVER #4CTC(XX), AND RECEPTACLE DEVICE PLATE #4REC. COVER FINISH COLOR TO BE SELECTED BY THE ARCHITECT. COORDINATE WITH FLOOR CONTRACTOR SUCH THAT COVER IS FLUSH WITH THE FLOOR FINISH MATERIAL.
- 8 PROVIDE 6" ROUND RECESSED POKE-THRU DEVICE AS MANUFACTURED BY LEGRAND WIREMOLD EVOLUTION SERIES #6ATC2(XX). INCLUDE SURFACE STYLE COVER #6CTC2(XX), RECEPTACLE DEVICE PLATE #68REC, AND COMMUNICATION DEVICE PLATE #6ACT8A. COVER FINISH COLOR TO BE SELECTED BY THE ARCHITECT. COORDINATE WITH FLOOR CONTRACTOR SUCH THAT COVER IS FLUSH WITH THE FLOOR FINISH MATERIAL. VERIFY FINAL LOCATION PRIOR TO INSTALLATION.
- 9 PROVIDE 8" ROUND RECESSED POKE-THRU DEVICE AS MANUFACTURED BY LEGRAND WIREMOLD EVOLUTION SERIES #8ATC2(FINISH). INCLUDE SURFACE STYLE COVER #8CTC2(FINISH), RECEPTACLE DEVICE PLATE #68REC, COMMUNICATION DEVICE PLATE #8ACTGA, AND DECORA STYLE DEVICE PLATES #8DEC. COVER FINISH COLOR TO BE SELECTED BY THE ARCHITECT. COORDINATE WITH FLOOR CONTRACTOR SUCH THAT COVER IS FLUSH WITH THE FLOOR FINISH MATERIAL.
- 10 INSTALL NEW EXTENSION RING OVER EXISTING RECESSED JUNCTION BOX TO ACCOMMODATE NEW WALL FURRING. PROVIDE NEW WALLPLATES AND EXTEND CONDUCTORS/CABLES AS REQUIRED TO MAINTAIN DEVICE OPERATION. FIELD VERIFY EXACT REQUIREMENTS.
- I PROVIDE ELECTRICAL CONNECTION AND JUNCTION BOXES FOR MAGNETIC LOCK, EMERGENCY RELEASE BUTTON, REQUEST-TO-EXIT DEVICE AND ASSOCIATED WIRING PER MANUFACTURER'S INSTRUCTIONS FOR A COMPLETE AND OPERABLE SYSTEM. INCLUDE INTERCONNECTION TO FIRE ALARM SYSTEM AS REQUIRED SUCH THAT MAGNETIC LOCK IS DEACTIVATED UPON ACTIVATION OF THE FIRE ALARM SYSTEM. COORDINATE EXACT REQUIREMENTS WITH OTHER TRADES.
- 12 PROVIDE FIRE ALARM CONTROL MODULES AS REQUIRED TO COMMUNICATE WITH FIRE DOOR SUCH THAT DOOR CLOSES UPON ACTIVATION OF ASSOCIATED SMOKE DETECTORS LOCATED ON EITHER SIDE OF OPENING. FIELD VERIFY EXACT REQUIREMENTS.

GENERAL NOTES:

SAWCUTTING.

DETECTORS.

CONTRACTOR PRIOR TO INSTALLATION.

UNLESS INDICATED OTHERWISE, CONTRACTOR SHALL CHANNEL EXISTING DRYWALL AS REQUIRED TO CONCEAL CONDUITS AND RECESS MOUNTED JUNCTION BOXES FOR ELECTRICAL DEVICES. COORDINATE WALL PATCHING REQUIREMENTS WITH GENERAL TRADES CONTRACTOR. WHERE RECESS MOUNTING IS NOT FEASIBLE, INFORM ARCHITECT AND/OR GENERAL

CONTRACTOR SHALL CONFIRM EXACT FLOOR BOX LOCATION WITH THE

SERVICE TO SCAN THE FLOOR SLAB. IT SHALL BE THE CONTRACTOR'S

REFER TO MECHANICAL PLANS FOR EXACT LOCATIONS OF

RESPONSIBILITY TO REPAIR ANY DAMAGES TO EXISTING UTILITIES DUE TO

ARCHITECT AND LOCATE/MARK ANY EXISTING UTILITIES IN AREA BY EMPLOYING

THERMOSTAT/CARBON DIOXIDE DETECTORS. PROVIDE SINGLE GANG BACKBOX

AND EMPTY 3/4" CONDUIT WITH PULL STRING STUBBED INTO AN ACCESSIBLE

CEILING SPACE FOR INSTALLATION OF THERMOSTAT/CARBON DIOXIDE

ARCHITECT OF RECORD **DEMONICA KEMPER ARCHITECTS** 125 N. HALSTED STREET, SUITE 301 **CHICAGO, IL 60661** P: 312.496.0000

MEP-FP-T-ENGINEERS 20/10 ENGINEERING GROUP, LLC 1216 TOWER ROAD SCHAUMBURG,IL 60173 P: 847.882.2010F: 847.882.2201

KEY PLAN:

SHEET STATUS: **ISSUED FOR BID - NOT**

FOR CONSTRUCTION

NO:	DESCRIPTION:	DATE:
1	Addendum #1	10/29/24
2	Addendum #2	11/01/24

SHEET TITLE: **ELECTRICAL PLANS**

SHEET NUMBER:

11/1/2024 2:14:09 PM





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20/10 ENGINEERING GROUP, LLC
1216 TOWER ROAD
SCHAUMBURG,IL 60173
P: 847.882.2010F: 847.882.2201

McHenry County College 2024 RENOVATIONS - BID PACKAGE

KEY PLAN:

SHEET STATUS: 10/17/2024
ISSUED FOR BID - NOT
FOR CONSTRUCTION

NO:	DESCRIPTION:	DATE:
1	Addendum #1	10/29/24
2	Addendum #2	11/01/24

SHEET TITLE:

LIGHTING PLANS

SHEET NUMBER:

EXIT SIGN AND EMERGENCY LIGHTING NOTE:

NUMBERS AND REQUIREMENTS.

CIRCUITING NOTE:

EXIT SIGNS AND LUMINAIRES DESIGNATED AS "EM" SHALL BE WIRED TO EXISTING

SHALL OPERATE AT ALL TIMES AND SHALL NOT BE CONNECTED TO ANY LIGHTING

CONTROL SYSTEM UNLESS INDICATED OTHERWISE. FIELD VERIFY EXACT CIRCUIT

ALL BRANCH CIRCUITS SHOWN SHALL BE WIRED TO EXISTING PANEL "I/GG" UNLESS

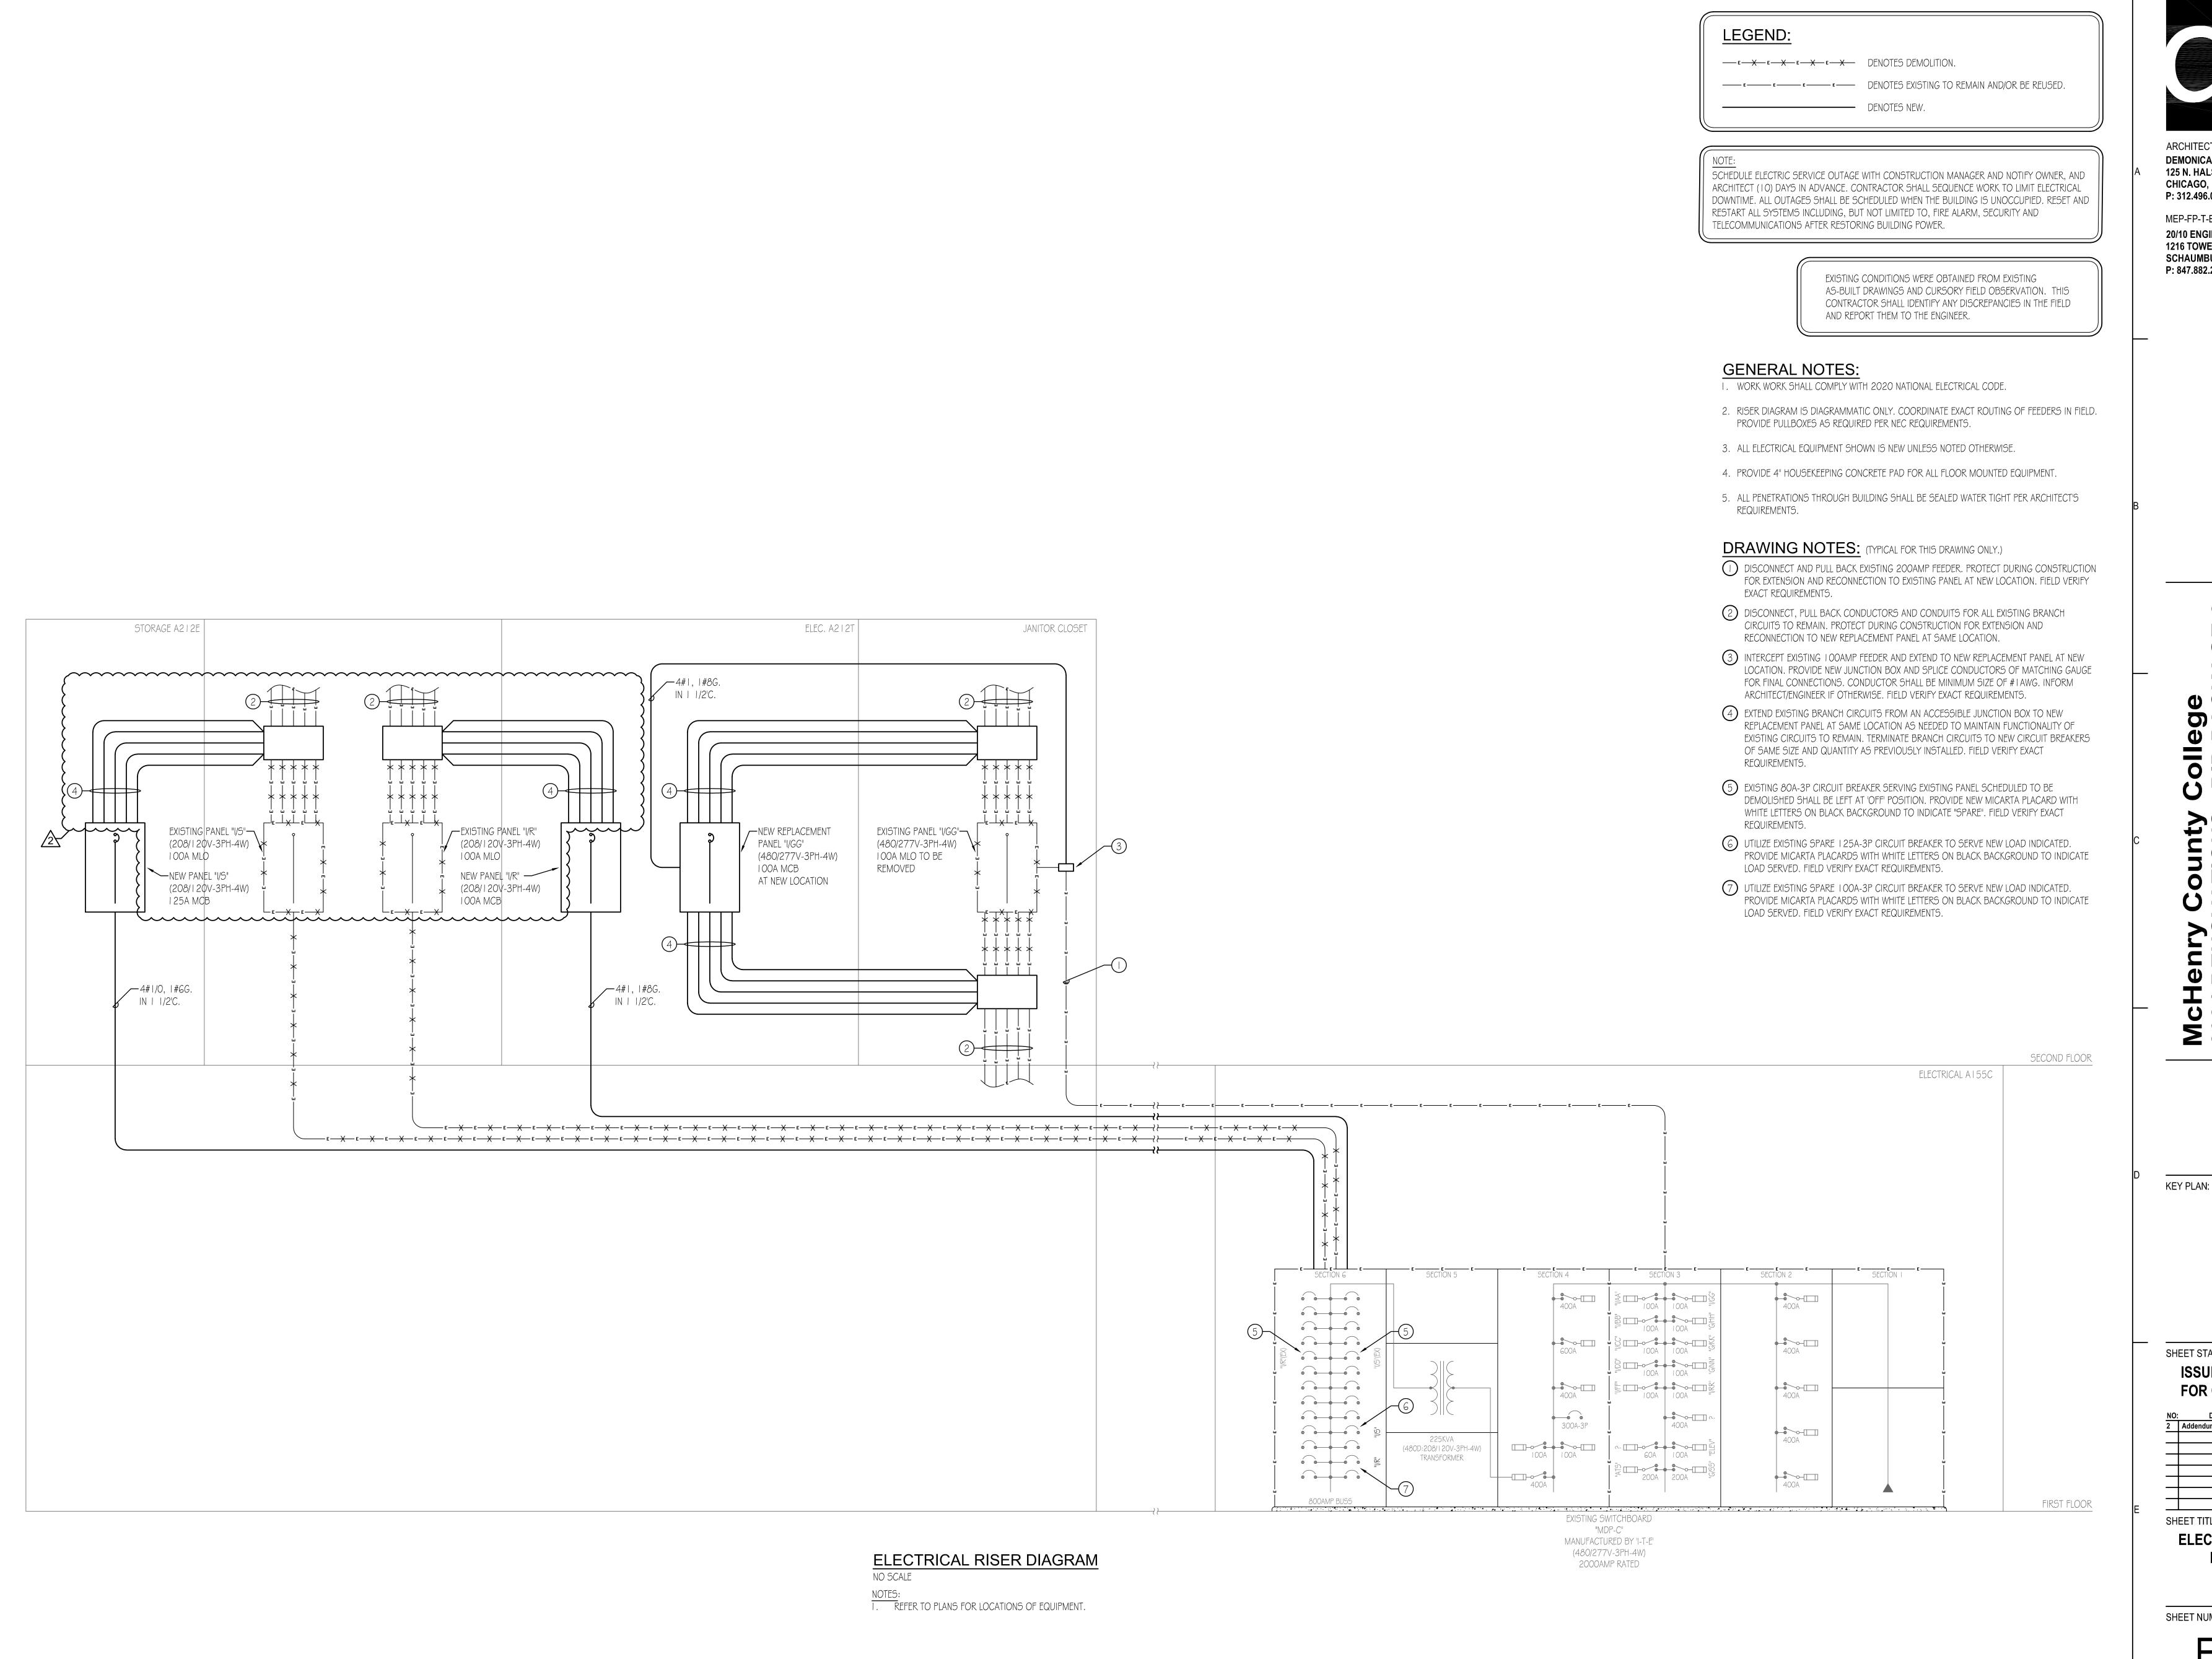
NOTED OTHERWISE. CIRCUIT NUMBERS ARE TO INDICATE QUANTITY OF CIRCUITS

REQUIRED. VERIFY EXACT CIRCUIT NUMBER TO BE UTILIZED IN FIELD.

EMERGENCY LIGHTING BRANCH CIRCUIT CURRENTLY SERVING AREA. "EM" LUMINAIRES

E2.20

11/1/2024 2:14:13 PM

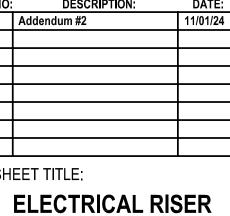




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eg PA

SHEET STATUS: DESCRIPTION:



DIAGRAM

SHEET NUMBER:

		EXIT SIGN & EME	RGENCY	/ LIGHT	TING SC	HEDULE		
SYMBOL	TAG	DESCRIPTION	MOUNTING	LAMPS	VOLTAGE	MANUFACTURER & CATALOG NUMBER	ALTERNATIVE MANUFACTURER	NOTES
⊗ ❷	EMI	SELF POWERED EMERGENCY EXIT SIGN, SINGLE FACE, DIE CAST ALUMINUM HOUSING WITH WHITE FINISH AND RED LETTERS, FIELD KNOCKOUT ARROWS AS REQUIRED		LED	UNV	LITHONIA LIGHTING #LQC-W-I-R-ELN	HLI DUAL-LITE, SIGNIFY CHLORIDE	1
፟	EM2	SELF POWERED EMERGENCY EXIT SIGN, SINGLE FACE, DIE CAST ALUMINUM HOUSING WITH WHITE FINISH AND RED LETTERS, FIELD KNOCKOUT ARROWS AS REQUIRED		LED	UNV	LITHONIA LIGHTING #LQC-W-I-R-ELN	HLI DUAL-LITE, SIGNIFY CHLORIDE	
-	EM3	DUAL HEAD EMERGENCY LIGHTING UNIT WITH WHITE CONTEMPORARY THERMOPLASTIC ENCLOSURE	SURFACE/ WALL	LED	UNV	LITHONIA LIGHTING #ELM4L-UVOLT-LTP-SDRT	HLI DUAL-LITE, SIGNIFY CHLORIDE	I

. CONNECT ALL BATTERY LIGHT FIXTURES TO LOCAL UNSWITCHED NORMAL LIGHTING CIRCUIT.

GENERAL NOTES:

a. CONTRACTOR TO PROVIDE ALL NECESSARY MOUNTING HARDWARE AND LABOR FOR ALL DEVICES.

BATTERIES SHALL BE CAPABLE OF PROVIDING ILLUMINATION FOR A MINIMUM OF 90 MINUTES.

NOT ALL SYMBOLS WILL BE ACCOMPANIED BY TAGS ON THE FLOOR PLANS FOR CLARITY PURPOSES.

							_
GE	ENERAL NOTES:			LIGHTING CONTE	ROL DEV	ICE SCHEDUL	.E
а.	ALL SENSOR LOCATIONS ARE APPROXIMATE, REFER TO MANUFACTURERS INSTALLATION INSTRUCTIONS PRIOR TO INSTALLATION.	SYMBOL	TYPE	DESCRIPTION	MOUNTING	MANUFACTURER & CATALOG NUMBER	
b. с.	SUPPLY/RETURN VENTS.	0	osA	STANDARD RANGE 360°, LOW VOLTAGE, DUAL TECHNOLOGY	CEILING	ACUITY nLIGHT #nCM-PDT-9-RJB	HUBBELL LIGHTING CONTROLS, WATTSTOPPER
d.	PLACEMENT.	0	оѕВ	EXTENDED RANGE 360°, LOW VOLTAGE, DUAL TECHNOLOGY	CEILING	ACUITY nLIGHT #nCM-PDT-10-RJB	HUBBELL LIGHTING CONTROLS, WATTSTOPPER
	 IF MULTIPLE CIRCUITS ARE TO BE CONTROLLED BY A SENSOR, AN AUXILIARY RELAY CAN BE USED IN CONJUNCTION WITH THE POWER PACK. THE MAXIMUM NUMBER OF SENSORS THAT CAN BE PUT ON A POWER PACK IS TO BE REDUCED BY ONE FOR EACH SLAVE PACK USED. 	0	osC	STANDARD RANGE 360°, LOW VOLTAGE, PASSIVE INFRARED	CEILING	ACUITY nLIGHT #nCM-9-RJB	HUBBELL LIGHTING CONTROLS, WATTSTOPPER
e. f.	MOUNT CONTROL UNITS WITHIN JUNCTION BOXES INSTALLED PER ALL CODE REQUIREMENTS. CONTROL WIRING BETWEEN SENSORS AND CONTROLS UNITS SHALL BE CLASS II, 18-24 AWG, STRANDED UL CLASSIFIED. ALL CONTROL WIRING/CABLING SHALL BE PLENUM-RATED.	0	osD	EXTENDED RANGE 360°, LOW VOLTAGE, PASSIVE INFRARED	CEILING	ACUITY nLIGHT #nCM-10-RJB	HUBBELL LIGHTING CONTROLS, WATTSTOPPER
g. h.	SENSOR PLACEMENT ON PLANS IS APPROXIMATE. CONTRACTOR IS RESPONSIBLE FOR ENGAGING A MANUFACTURER TO PRODUCE A MOTION SENSOR LAYOUT THAT IS COMPLIANT WITH THE GOVERNING ENERGY CODE. CONTRACTOR IS RESPONSIBLE FOR ENSURING MOTION CONTROL OF ALL LOCATIONS SHOWN ON PLAN.	\$	osE	WALL SWITCH SENSOR, LOW VOLTAGE, PASSIVE INFRARED	WALL	ACUITY nLIGHT #nWSXA-LV	HUBBELL LIGHTING CONTROLS, WATTSTOPPER
J. k.	CONTRACTOR IS RESPONSIBLE FOR INSTALLING EQUIPMENT IN COMPLIANCE WITH LOCAL CODE. PRODUCTS FROM SPECIFIED AND ACCEPTABLE MANUFACTURERS SHALL PROVIDE SAME LEVEL OF CONTROL.	\$	osF	WALL SWITCH SENSOR, LOW VOLTAGE, DUAL TECHNOLOGY	WALL	ACUITY nLIGHT #nWSXA-PDT-LV	HUBBELL LIGHTING CONTROLS, WATTSTOPPER
		\$	sA	ON/OFF SINGLE ZONE PUSH-BUTTON CONTROL STATION	WALL	ACUITY nLIGHT #nPODMA	HUBBELL LIGHTING CONTROLS, WATTSTOPPER
		\$	sВ	ON/OFF/DIM, SINGLE ZONE PUSH-BUTTON CONTROL STATION	WALL	ACUITY nLIGHT #nPODMA-DX	HUBBELL LIGHTING CONTROLS, WATTSTOPPER
		\$	sС	ON/OFF/DIM KEY SWITCH CONTROL STATION	WALL	ACUITY nLIGHT #nPODA-KEY	HUBBELL LIGHTING CONTROLS, WATTSTOPPER

						SCHEDULE		
TYPE	DESCRIPTION	MOUNTING	LAMPS	VOLTAGE	INPUT WATTS	MANUFACTURER & CATALOG NUMBER	ALTERNATE MANUFACTURER	NOTES
"FIA"	2'X2' LED RECESSED VOLUMENTRIC TROFFER, CURVED LINEAR PRISMS DIFFUSER, 3300	RECESSED	LED	277 V	26.5	LITHONIA LIGHTING #2BLT2-33L-ADP-GZ10-LP840	HLI COLUMBIA LIGHTING, SIGNIFY DAY-BRITE	I
"FIB"	2'X2' LED RECESSED VOLUMENTRIC TROFFER, CURVED LINEAR PRISMS DIFFUSER, 4000	RECESSED	LED	277 V	31	LITHONIA LIGHTING #2BLT2-4OL-ADP-GZ1O-LP840	HLI COLUMBIA LIGHTING, SIGNIFY DAY-BRITE	1
"F2A"	2'X4' LED RECESSED VOLUMENTRIC TROFFER, CURVED LINEAR PRISMS DIFFUSER, 4,000	RECESSED	LED	277 V	30.5	LITHONIA LIGHTING #2BLT4-4OL-ADP-GZ1O-LP840	HLI COLUMBIA LIGHTING, SIGNIFY DAY-BRITE	1
"F2B"	2'X4' LED RECESSED VOLUMENTRIC TROFFER, CURVED LINEAR PRISMS DIFFUSER, 4,800	RECESSED	LED	277 V	39.3	LITHONIA LIGHTING #2BLT4-48L-ADP-GZ10-LP840	HLI COLUMBIA LIGHTING, SIGNIFY DAY-BRITE	1
"F2C"	2'X4' LED RECESSED VOLUMENTRIC TROFFER, CURVED LINEAR PRISMS DIFFUSER, 6,000	RECESSED	LED	277 V	46.6	LITHONIA LIGHTING #2BLT4-GOL-ADP-GZ10-LP840	HLI COLUMBIA LIGHTING, SIGNIFY DAY-BRITE	1
"F3A"	4" SQUARE LED DOWNLIGHT I 150 NOMINAL LUMENS	RECESSED	LED	277 V	~ 	USAI LIGHTING #B4SDF-09C3-40KS-50-S-WH-NC-UNV-DGE	HLI PRESCOLITE, SIGNIFY LIGHTOLIER	1 1 1 1 1 1 1 1 1 1 1 1 1 1 1 1 1 1 1
"F3B"	4" SQUARE LED DOWNLIGHT I I 50 NOMINAL LUMENS	RECESSED	LED	277 V	9	USAI LIGHTING #B4SDM-09C3-40KS-50-S-NC-UNV-D6E	HLI PRESCOLITE, SIGNIFY LIGHTOLIER	ı
"F3C"	4" SQUARE LED DOWNLIGHT 2400 NOMINAL LUMENS	RECESSED	LED	277 V	24	USAI LIGHTING #B4SDF-24C3-40KS-50-S-WH-NC-UNV-DGE	HLI PRESCOLITE, SIGNIFY LIGHTOLIER	ı
"F3D"	4" SQUARE LED DOWNLIGHT 3025 NOMINAL LUMENS	RECESSED	LED	277 V	33	USAI LIGHTING #B4SDF-33C3-40KS-50-S-WH-NC-UNV-DGE	HLI PRESCOLITE, SIGNIFY LIGHTOLIER	ı
"F3E"	4" SQUARE LED DOWNLIGHT 2400 NOMINAL LUMENS	RECESSED	LED	277 V	24	USAI LIGHTING #B4SDL-24C3-40KS-50-S-NC-UNV-D6E	HLI PRESCOLITE, SIGNIFY LIGHTOLIER	
"F4A-18"	18'-0" LONG LINEAR LED 600 LUMENS/FT	RECESSED	LED	277 V	88.2	AXIS LIGHTING #BBRLED-600-80-40-0.5G-S(18)-W-UNV-DP-1-TB15	FOCAL POINT, LUMENWERX	1,3
"F4A-18- EM"	I 8'-0" LONG LINEAR LED WITH EMERGENCY LIGHT SECTION 600 LUMENS/FT	RECESSED	LED	277 V	88.2	AXIS LIGHTING #BBRLED-600-80-40-0.5G-5(18)-W-UNV-DP-1+E(1)-TB15	FOCAL POINT, LUMENWERX	1,3,4
"F4B-4"	4'-0" LONG LINEAR LED 800 LUMENS/FT	RECESSED	LED	277 V	26.2	AXIS LIGHTING #BBRLED-800-80-40-0.5G-4-W-UNV-DP-1-TB15	FOCAL POINT,	1,3
"F4B-8"	8'-0" LONG LINEAR LED	RECESSED	LED	277 V	52.2	AXIS LIGHTING	FOCAL POINT,	1,3
"F4B-16"	I 6'-0" LONG LINEAR LED	RECESSED	LED	277 V	104.4	AXIS LIGHTING	FOCAL POINT,	1,3
"F4B-1 <i>8</i> "	18'-0" LONG LINEAR LED	RECESSED	LED	277 V	117.5	AXIS LIGHTING	FOCAL POINT,	1,3
"F4B-18- EM"	I 8'-0" LONG LINEAR LED WITH EMERGENCY LIGHT SECTION	RECESSED	LED	277 V	117.5	AXIS LIGHTING #BBRLED-800-80-40-0.5G-S(18)-W-UNV-DP-1+E(1)-TB15	FOCAL POINT, LUMENWERX	1,3,4
"F4B-20"	20'-0" LONG LINEAR LED	RECESSED	LED	277 V	130.6	AXIS LIGHTING #BBPLED 800 80 40 0 50 6(20) W LINIV DP 1 TB 15	FOCAL POINT,	1,3
"F4C-6"	6'-0" LONG LINEAR LED	RECESSED	LED	277 V	49	AXIS LIGHTING	FOCAL POINT,	1,3
"F5"	THIN 4'-O" LONG LINEAR LED	RECESSED	LED	277 V	33.2	PINNACLE LIGHTING	HLI LITECONTROL,	I
"F6"	2'x2' FLAT PANEL LED	RECESSED	LED	277 V	41.8	LITHONIA LIGHTING	HLI COLUMBIA LIGHTING,	I
"F7-47"	47'-O" LONG LINEAR LED WITH PERIMETER ROOM FILL DISTRIBUTION	RECESSED	LED	277 V	263.2	PRUDENTIAL LIGHTING #BPRO3-REC-FLSH-LED4-MO-R47-TMW-PFL-LP-SC-UNV-X1T-DMO1-E	FOCAL POINT,	1,3,4
"F7-65"	65'-0" LONG LINEAR LED WITH PERIMETER ROOM FILL DISTRIBUTION	RECESSED	LED	277 V	364	PRUDENTIAL LIGHTING #BPRO3-REC-FLSH-LED4-MO-R65-TMW-PFL-LP-SC-UNV-X1T-DMO1-E	FOCAL POINT, LUMENWERX	1,3,4
"F8"	8' LED STRIP LIGHT, 8000 LUMENS	SURFACE	LED	277 V	51.1	LITHONIA LIGHTING	HLI COLUMBIA LIGHTING,	-
"F9A-3"	3'-0" LONG LINEAR LED	SURFACE	LED	277 V	20.4	AXIS LIGHTING	-	-
"F9A-7"	7'-0" LONG LINEAR LED	SURFACE	LED	277 V	47.5	AXIS LIGHTING	-	-
"F9A-8"	8'-0" LONG LINEAR LED	SURFACE	LED	277 V	54.3	AXIS LIGHTING	-	-
"F9A-10"	800 LUMENS/FT I O'-O" LONG LINEAR LED	SURFACE	LED	277 V	67.8	AXIS LIGHTING	-	-
"F9B-10"	20'-0" LONG LINEAR LED	SURFACE	LED	277 V	84.8	AXIS LIGHTING	-	-
	18-0" LONG LINEAR LED WITH WALL WASH DISTRIBUTION	RECESSED .	LED	277	57.6	#PRSLED-1000-80-35-5-5(10)-(FINISH)-UNV-DP-1-5 AXIS LIGHTING #BBRLED-400-80-40-WW-5(18)-W-UNV-DP-1-TB15	POCAL POINT, LUMENWERX	4,3
"F11"	600 LUMENS/FT DECORATIVE LED PENDANT	PENDANT	LED	120 V	20	EUREKA LIGHTING	-	2
"F12"	DECORATIVE LED PENDANT	PENDANT	LED	120 V	24	SECTO DESIGN	-	2
"F13-17"	17'-0" LONG SUSPENDED LINEAR LED 400 LUMENS/FT	SUSPENDED	LED	277 V	54.4	KONTRO 6000 AXIS LIGHTING #TB4DLED-400-80-40-50-5(17)-W-UNV-DP-1-CT15(48)	FOCAL POINT, LUMENWERX	1,2,3
"F13-25"	25'-0" LONG SUSPENDED LINEAR LED WITH EMERGENCY LIGHT SECTION 400 LUMENS/FT	SUSPENDED	LED	277 V	83.1	AXIS LIGHTING #TB4DLED-400-80-40-50-5(25)-W-UNV-DP-1+E(1)-CT15(48)	FOCAL POINT, LUMENWERX	1,2,3,4
"F13-26"	26'-0" LONG SUSPENDED LINEAR LED WITH EMERGENCY LIGHT SECTION 400 LUMENS/FT	SUSPENDED	LED	277 V	86.4	AXIS LIGHTING #TB4DLED-400-80-40-S0-S(26)-W-UNV-DP-1+E(1)-CT15(48)	FOCAL POINT, LUMENWERX	1,2,3,4
"F13-28"	28'-0" LONG SUSPENDED LINEAR LED 400 LUMENS/FT	SUSPENDED	LED	277 V	93	AXIS LIGHTING #TB4DLED-400-80-40-50-5(28)-W-UNV-DP-1-CT15(48)	FOCAL POINT, LUMENWERX	1,2,3
"F13-30"	30'-0" LONG SUSPENDED LINEAR LED 400 LUMENS/FT	SUSPENDED	LED	277 V	99.6	AXIS LIGHTING #TB4DLED-400-80-40-50-5(30)-W-UNV-DP-1-CT15(48)	FOCAL POINT, LUMENWERX	1,2,3
	100 LOWILMON I		LED	277 V	106.3	AXIS LIGHTING	FOCAL POINT,	1,2,3
"F13-32"	32'-0" LONG SUSPENDED LINEAR LED 400 LUMENS/FT	SUSPENDED	LED	2// V	106.5	#TB4DLED-400-80-40-50-5(32)-W-UNV-DP-1-CT15(48)	LUMENWERX	1,2,0
	"FIA" "FIB" "F2A" "F2B" "F3A" "F3B" "F3C" "F3B" "F4A-18" "F4B-8" "F4B-8" "F4B-16" "F4B-16" "F4B-20" "F4C-6" "F3C" "F7-47" "F7-65" "F9A-7" "F9A-7" "F9A-10" "F13-25" "F13-26" "F13-26"	"F1A" 2'Y2' LED RECESSED VOLUMENTRIC TROFFER, CURVED LINEAR PRISMS DIFFUSER, 3300 NOMINAL LUMENS 1'F1B" 2'Y2' LED RECESSED VOLUMENTRIC TROFFER, CURVED LINEAR PRISMS DIFFUSER, 4000 NOMINAL LUMENS 1'F2A" 2'Y4' LED RECESSED VOLUMENTRIC TROFFER, CURVED LINEAR PRISMS DIFFUSER, 4,000 NOMINAL LUMENS 1'F2B" 2'Y4' LED RECESSED VOLUMENTRIC TROFFER, CURVED LINEAR PRISMS DIFFUSER, 4,000 NOMINAL LUMENS 1'F2B" 2'Y4' LED RECESSED VOLUMENTRIC TROFFER, CURVED LINEAR PRISMS DIFFUSER, 4,000 NOMINAL LUMENS 1'F3A" 4'F3QUARE LED DOWNLIGHT 1 150 NOMINAL LUMENS 1'F3A" 4'F3QUARE LED DOWNLIGHT 1 150 NOMINAL LUMENS 1'F3B" 4'F3QUARE LED DOWNLIGHT 1 150 NOMINAL LUMENS 1'F3B" 4'F3QUARE LED DOWNLIGHT 1 150 NOMINAL LUMENS 1'F3B" 4'F3QUARE LED DOWNLIGHT 2400 NOMINAL LUMENS 1'F3B" 1'F3QUARE LED DOWNLIGHT 2'Y4D LONG LIMEAR LED 300 LUMENS/FT 1'F4B-1B" 1'F4B-	Timestage	Timestage	THA 232 LED RECESSED VOLUMENTER TOPPER RECESSED LED 277 V	TYPE	Proc. Proc	The control of the

LUMINAIRE SCHEDULE

CONTRACTOR TO PROVIDE ALL OPTIONS AND ACCESSORIES AS REQUIRED TO INSTALL LUMINAIRE IN VARYING CEILING TYPES AS SHOWN ON THE PLANS.

2. REFER TO ARCHITECTURAL PLANS AND ELEVATIONS FOR EXACT SUSPENSION LENGTHS. 3. REFER TO ARCHITECTURAL RCP PLANS FOR EXACT LENGTH OF LUMINAIRE REQUIRED.

4. LUMINAIRE INCLUDES 4'-0" SECTION(S) WIRED TO EMERGENCY LIGHTING CIRCUIT. PROVIDE OPTIONS FOR SEPARATE ELECTRICAL FEEDS AS REQUIRED. REFER TO PLANS FOR QUANTILES AND LOCATIONS.

GENERAL NOTES:

a. CONTRACTOR TO PROVIDE NECESSARY MOUNTING HARDWARE AND LABOR FOR LUMINAIRES.

b. LAY IN CEILING GRID LUMINAIRES SHALL BE FOR USE WITH STANDARD 15/16" GRID SYSTEM.

c. CEILING TYPES, FINISHES AND HEIGHTS MAY VARY. SEE ARCHITECTURAL RCP PLANS FOR MORE INFO. CONTRACTOR TO COORDINATE \$ PROVIDE PROPER MOUNTING HARDWARE, FLANGE, AND ACCESSORIES AS

d. ALL FINISH COLORS AND COLOR TEMPERATURES TO BE CONFIRMED BY THE ARCHITECT.

		LI	IGHTING CONT	ROL	SEQ	UENC	E OF	OPER	ATIC	N				
	OCCUPANCY SENSOR					PHC	PHOTOSENSOR				YPE	TIME		
	VACANCY MODE	OCCUPANCY MODE	SENSOR TIMEOUT PERIOD (MINUTES)	OCCUPIED LEVEL %	UNOCCUPIED LEVEL %	SWITCHING (ON/OFF)	DIMMING	TARGET LIGHT LEVEL (FC)	MANUAL (ON/OFF)	MANUAL (ON/OFF/DIM)	KEY SWITCH	SCHEDULED ON AT	SCHEDULED OFF AT	NOTES
TYPICAL CLASSROOM	Х		20 MIN							Х				
TYPICAL OFFICE	Х		20 MIN							X				
TYPICAL STORAGE / MECHANICAL / ELECTRICAL	Х		20 MIN						Х					
TYPICAL RESTROOMS		Х	20 MIN	100	0				X					
CORRIDOR		Х	20 MIN	100	0					X				
COPPIDOD NICHT LICHTS		V		100	50				V					

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ARCHITECT OF RECORD DEMONICA KEMPER ARCHITECTS 125 N. HALSTED STREET, SUITE 301 CHICAGO, IL 60661 P: 312.496.0000

MEP-FP-T-ENGINEERS 20/10 ENGINEERING GROUP, LLC 1216 TOWER ROAD SCHAUMBURG,IL 60173 P: 847.882.2010F: 847.882.2201

KEY PLAN:

SHEET STATUS: **ISSUED FOR BID - NOT** FOR CONSTRUCTION

Addendum #2 SHEET TITLE:

ELECTRICAL SCHEDULES

SHEET NUMBER:

11/1/2024 2:18:40 PM

PANEL SCHEULE: "	S/J2"(E>	()		LC	DCA ⁻	TION:					C.B. RA	TING: VIF KAI
VOLT: 208/120V, 3Ø, 4W				A MLO			ITING:	SUF	RFA	CE		TYPE:	BOLT-ON
REMARKS: EXISTING PANEL	MANUF	ACT	URE	D BY EAT	(ON): 22	<u> </u>						!	
					V.A.								
USE AND/OR AREA SERVED	C/E	3	CIR. NO.	Α	В		С	CIR. NO.		C/B	USE AN	D/OR AF	REA SERVED
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								2					
			3					1					
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			29										
							180	30	۱P	20 A	R: D167	7 AMBU	LANCE TRAINER
R: D 66 OFFICE SUITE	20 A	ΙP	31	540									
D. D.I.C. OFFICE CLUTE	20.4	 LD	22	180	F 40	+		32	IP	20 A	R: D167	7 AMBU	LANCE TRAINER
R: D166 OFFICE SUITE	20 A	1	33		540 1 <i>8</i> 0			34	I P	20 A	R. DIC	7 TRAINI	ER CONTROL
R: D166B OFFICE	20 A	IP	35		100		540	34		20 7	1.016/	/ 110/41141	LK CONTROL
							720	36	ΙP	20 A	R: D167	7 EMS L	AB
R: D166B OFFICE	20 A	ΙP	37	720									
				1080				38	۱P	20 A	R: D167	7 EMS L	AB
R: D I 66A OFFICE	20 A	IР	39		540						D D : 5-	7D -	1077 0
P. DICCA OFFICE	20 A	 I D	11		720)	720	40	11	20 A	R: D167	/b.1+D	16/8.2
R: D166A OFFICE	20 A		41				720 900	42	I P	20 A	R: DIG	7B MOC	K APARTMENT
											7,560		INTERIOR DE LA CONTRACTOR DE LA CONTRACT
TOTAL CONNECTED LOAD	PER PHA	4SE	Ξ :	2520	1980	0	3060	_	20.9		AMPS	• • •	
					I						- 11411		

PANEL SCHEULE: "				A MLO		ATION: JNTING:	GUD	F۸	CF.		TYPE:	ATING: VIF KAIO BOLT-ON
/OLT: 208/120V, 3Ø, 4W						JINTING.	JUK	,FA			ITPE.	DOLI-ON
REMARKS: EXISTING PANEL	MANUF		URE	D BY 'I-T-	E'. 3 22							
			CID		V.A.		CIP					
JSE AND/OR AREA SERVED	C/E	3	CIR. NO.	Α	В	С	CIR. NO.	(C/B	USE AND	OOR AF	REA SERVED
			ı									
							2					
			3									
							4					
			5									
							6					
			7									
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			19									
							20					
			21									
							22					
			23									
							24					
C: D151 COPIER	20 A	IP	25	1200								
				720			26	ΙP	20 A	R: D151	A + D	151E
6: SPARE	20 A	IP	27		0			~ ~	\sim	\sim	\sim	~~~~
					800		28	<u>IP</u>	20 A	R: CORR	IDOR (I	EWC)
			29					کیر				
							30					
			31									
			0.0				32					
			33									
			0				34					
			35									
							36			2 = 2 = 1		
TOTAL CONNECTED LOAD	PER PH	4SF		1920	800	0	TC	ŊΤ	L =	2,720 V	Α	
	TOTAL CONNECTED LOAD FERTINGE.						7	7.5	5	AMPS		

MEP-FP-T-ENGINEERS

20/10 ENGINEERING GROUP, LLC
1216 TOWER ROAD
SCHAUMBURG,IL 60173
P: 847.882.2010F: 847.882.2201

McHenry County College
2024 RENOVATIONS - BID PACKAG

SHEET STATUS: 10/17/20:

KEY PLAN:

ISSUED FOR BID - NOT FOR CONSTRUCTION

NO: DESCRIPTION: DATE:
2 Addendum #2 11/01/24

SHEET TITLE:

ELECTRICAL

ELECTRICAL SCHEDULES

SHEET NUMBER:

L4.1

11/1/2024 2:14:13 PM

SPARE CIRCUIT BREAKER NOTE:

PROVIDE A MINIMUM OF (6) SPARE 20A-1 P CIRCUIT BREAKERS IN NEW ELECTRICAL

PANELS

PANEL SCHEDULE NOTE:

SCHEDULES FOR EXISTING PANELS ARE SHOWN FOR REFERENCE TO INDICATE SIZE AND QUANTITY OF NEW CIRCUIT BREAKERS REQUIRED. CONTRACTOR TO FIELD VERIFY EXISTING PANEL CHARACTERISTICS AND BRANCH CIRCUIT BREAKER LAYOUT.

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