McHenry County College

HEALTH SCIENCE 2024 RENOVATIONS

8600 ROUTE 14, SUITE 205 CRYSTAL LAKE, IL 60012

DKA PROJECT NO: 24-032

MCC BID NO: RFP#03182025

ISSUED FOR BID - NOT FOR CONSTRUCTION 02/18/2025



ARCHITECT:

DEMONICA KEMPER ARCHITECTS 125 N. HALSTED ST., SUITE 301 CHICAGO, IL 60661 T: 312.496.0000 F: 312.496.0001



S / MEP / FP / T ENGINEERS:

IMEG CORP. 1100 WARRENVILLE RD., SUITE 400W NAPERVILLE, IL 60563 P: 630.527.2320

ABBREVIATIONS

CPT

CT

CLR

CLO

COL

CONC

CONN

CARPET

CLEAR

CLOSET

COLUMN

CONCRETE

CONNECTION

CERAMIC TILE

AP	ACCESS PANEL	HDW	HARDWARE	TEL	TELEPHONE
ACOUST	ACOUSTICAL	HDWD	HARDWOOD	TV	TELEVISION
ACT	ACOUSTICAL CEILING TILE	HDR	HEADER	TRZ	TERRAZZO
ADJ	ADJACENT	HTG	HEATING	TB	TILE BASE
A.F.F.	ABOVE FINISH FLOOR	HVAC	HEATING, VENTILATING, AIR CONDITIONING	THK	THICK
AGGR	AGGREGATE	HT	HEIGHT	T.O.C.	TOP OF CURB
A/C	AIR CONDITIONING	HC	HOLLOW CORE	TOP	TOP OF PAVEMENT
ALT	ALTERNATE	HM	HOLLOW METAL	TOW	TOP OF WALL
ALUM	ALUMINUM	HMF	HOLLOW METAL FRAME	T&G	TONGUE AND GROOVE
L	ANGLE	HORZ	HORIZONTAL	TYP	TYPICAL
APPD	APPROVED	HB	HOSE BIB		
APPROX	APPROXIMATE	HR	HOUR	UNF	UNFINISHED
ARCH	ARCHITECTURAL OR ARCHITECT			U.N.O.	UNLESS NOTED OTHERWISE
AD	AREA DRAIN	INC	INCLUDE	UR	URINAL
ASB	ASBESTOS	I.D.	INSIDE DIAMETER		
ASPH	ASPHALT	INSUL	INSULATION	VB	VINYL BASE
A/V	AUDIO VISUAL	INTR	INTERIOR	VERT	VERTICAL
		INV	INVERT	VEST	VESTIBULE
BSMT	BASEMENT			VCT	VINYL COMPOSITION TILE
BRG	BEARING	JAN	JANITOR	VW	VINYL WALLCOVERING
BM	BEAM	JT	JOINT		
BTW	BETWEEN	KIT	KITCHEN	WSCT	WAINSCOT
BITUM	BITUMINOUS	LAM	LAMINATE	WC	WATER CLOSET
BLK	BLOCK	LAV	LAVATORY	WLK	WALK-OFF MAT
BLKG	BLOCKING	LH	LEFT HAND	WR	WATER RESISTANT
BD	BOARD	LGTH	LENGTH	WT	WALL TILE OR WEIGHT
BRK	BRICK	LT	LIGHT	W	WEST
BLDG	BUILDING	LWC	LIGHT WEIGHT CONCRETE	W	WIDE FLANGE "W16x21"
		LTL	LINTEL	W	WIDTH
CAB	CABINET	LN	LINOLEUM	W/	WITH
CIP	CAST IN PLACE	LL	LIVE LOAD	W/O	WITHOUT
CIPC	CAST IN PLACE CONCRETE			WD	WOOD
CI	CURB INLET	MH	MANHOLE	WDP	WOOD PANEL
СВ	CATCH BASIN	MFR	MANUFACTURER	Χ	EXISTING
CLG	CEILING	MAS	MASONRY		
CTR	CENTER	MO	MASONRY OPENING		
CJ	CONTROL JOINT	MTL	METAL		
CL	CENTER LINE	MAX	MAXIMUM		
ODT	OADDET	MEOU	MEGLIANICAL		

MECHANICAL

MEMBRANE

MARBLE TILE

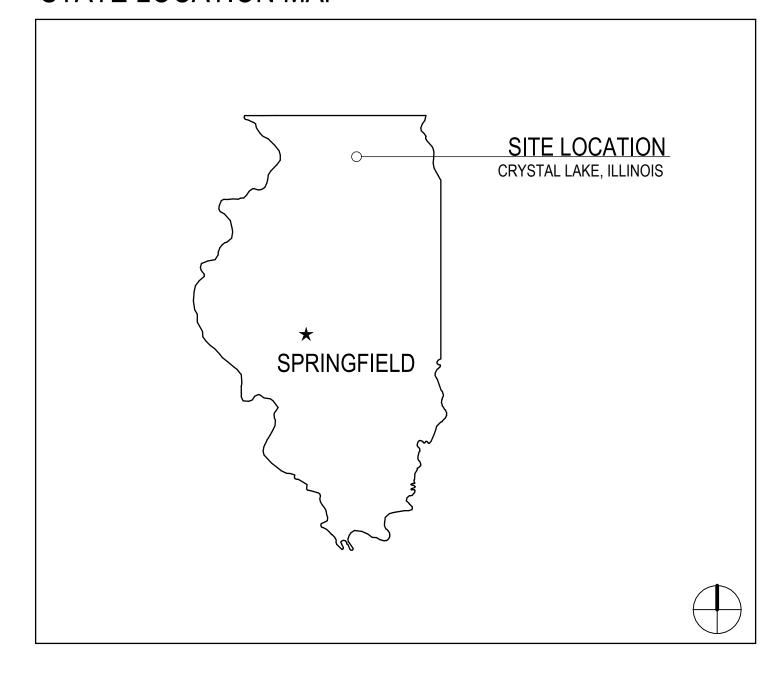
MISCELLANEOUS

MINIMUM

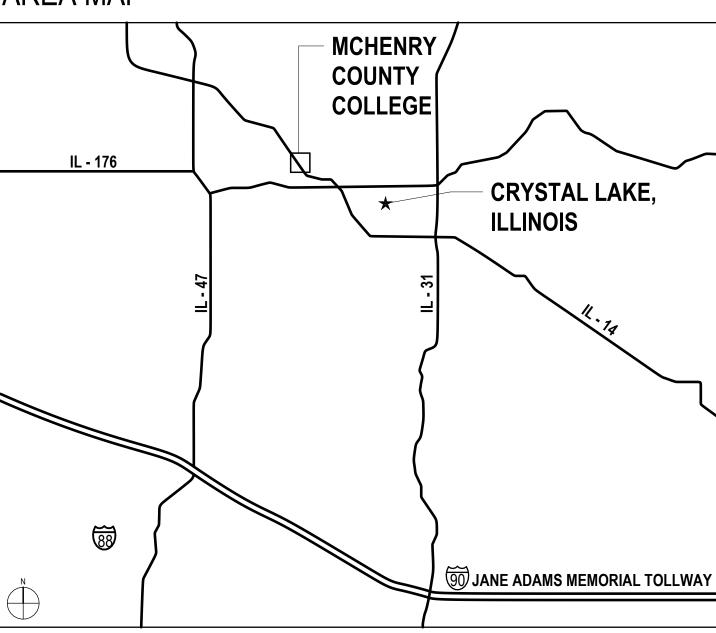
MOUNDED

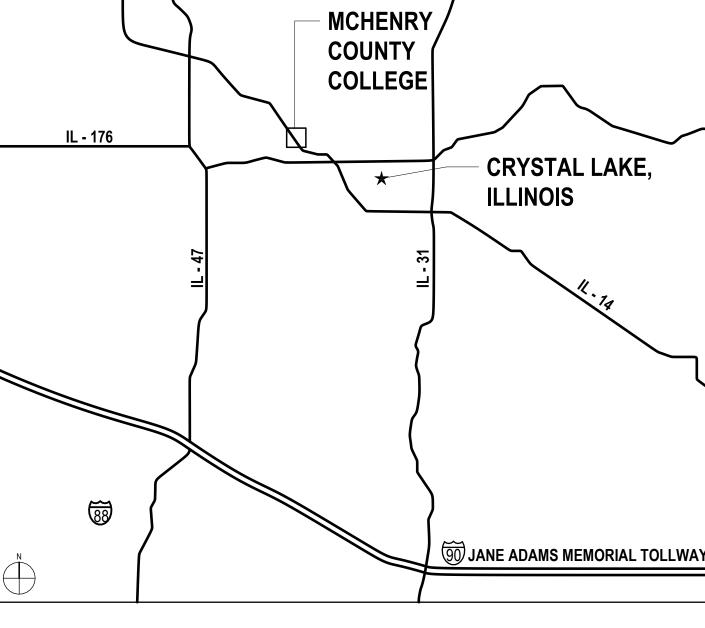
MECHANICAL TRADES CONTRACTOR

STATE LOCATION MAP

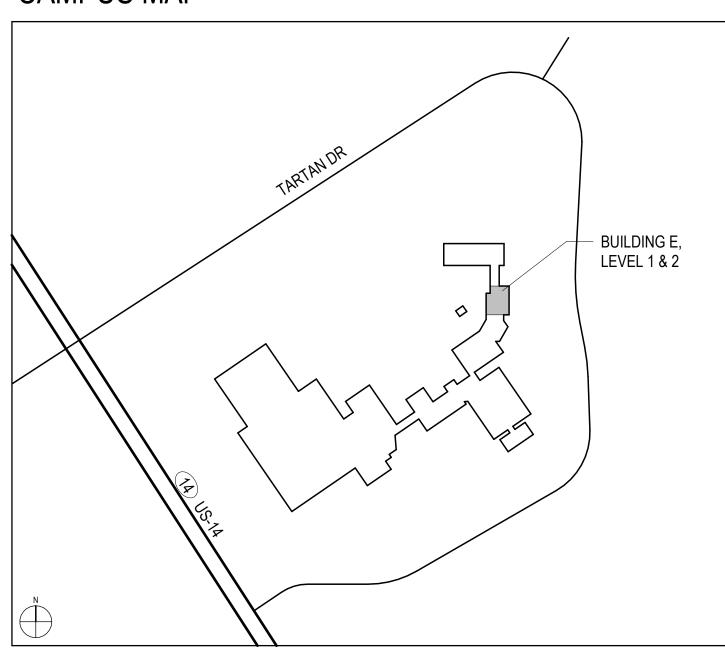


AREA MAP





CAMPUS MAP



SHEET INDEX

E3.00

E4.00

T0.00

T1.00

T1.01

T2.00

T2.01

T5.00

TD1.00

TECHNOLOGY

ELECTRICAL ONE LINE DIAGRAM

ELECTRICAL SCHEDULES

TECHNOLOGY COVER SHEET

FLOOR PLANS - TECHNOLOGY

TECHNOLOGY SCHEDULES

TECHNOLOGY ENLARGED PLANS

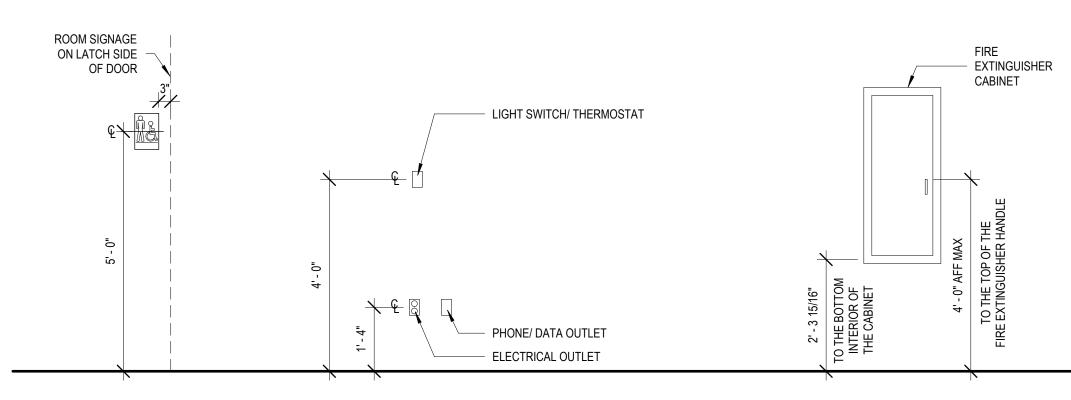
TECHNOLOGY ENLARGED PLANS

DEMOLITION PLANS - TECHNOLOGY

OVERALL FLOOR PLANS - TECHNOLOGY

OVERALL DEMOLITION PLANS - TECHNOLOGY

G1.00 SHEET INDEX, ABBREVIATIONS, SYMBOLS & NOTES ARCHITECTURAL A1.00 OVERALL FLOOR PLAN AD1.10 **DEMOLITION PLANS** AD2.10 DEMOLITION RCPS A1.10 FLOOR PLANS A2.10 REFLECTED CEILING PLANS A7.51 PLAN AND CEILING DETAILS A9.01 INTERIOR ELEVATIONS A9.51 MILLWORK PLANS & DETAILS A9.52 MILLWORK SECTIONS A10.00 DOOR SCHEDULE, WINDOW ELEV, & WALL TYPES A11.01 FINISH PLAN MECHANICAL M0.00 HVAC COVERSHEET MD1.00 OVERALL DEMOLITION PLANS - HVAC MD1.02 DEMOLITION PLANS - HVAC M1.10 OVERALL FLOOR PLANS - HVAC M1.11 FLOOR PLANS - HVAC M2.00 HVAC DETAILS AND SCHEDULES PLUMBING P0.00 PLUMBING COVERSHEET PD1.00 OVERALL DEMOLITION UNDERFLOOR PLAN - PLUMBING PD1.01 OVERALL DEMOLITION PLANS - PLUMBING PD1.02 DEMOLITION PLANS - PLUMBING P1.00 OVERALL UNDERFLOOOR PLAN - PLUMBING P1.01 OVERALL FLOOR PLAN - PLUMBING P1.02 FLOOR PLANS - PLUMBING P2.00 PLUMBING DETAILS FIRE PROTECTION F0.00 FIRE PROTECTION COVERSHEET FD1.01 OVERALL DEMOLITION PLANS - FIRE PROTECTION F1.00 OVERALL FLOOR PLANS - FIRE PROTECTION F2.00 FIRE PROTECTION DETAILS AND SCHEDULES ELECTRICAL E0.00 ELECTRICAL COVERSHEET E0.01 OVERALL CAMPUS PLAN - ELECTRICAL E1.00 OVERALL FLOOR PLANS - ELECTRICAL ED1.10 DEMOLITION PLANS - ELECTRICAL E1.10 FLOOR PLANS - LIGHTING E1.20 FLOOR PLANS - POWER E1.30 FLOOR PLANS - SYSTEMS E2.00 ELECTRICAL DETAILS



NOTE: IN THE EVENT OF A CONFLICT BETWEEN DIMENSIONS SHOWN ON THIS DRAWING AND ANY OTHER ARCHITECTURAL, ELECTRICAL, OR MECHANICAL SHEETS OR SPECIFICATIONS, NOTIFY ARCHITECT OF DISCREPANCY.

ARCHITECT OF DEMONICA KEMPER ARCHITECTS 125 N. HALSTED STREET, SUITE 301 **CHICAGO, IL 60661** P: 312.496.0000

S / MEP / FP / T ENGINEERS: IMEG CORP. 1100 WARRENVILLE RD., SUITE 400W NAPERVILLE, IL 60563 P: 630.527.2320

IN County SCIENCE 202

KEY PLAN:

SHEET STATUS: **ISSUED FOR BID - NOT** FOR CONSTRUCTION

NO: DESCRIPTION: DATE: SHEET TITLE: SHEET INDEX,

ABBREVIATIONS, **SYMBOLS & NOTES**

SHEET NUMBER:

2/18/2025 1:10:04 PM

MTG CONST CONSTRUCTION MOUNTING CONSTRUCTION MANAGER MUL MULLION CONT CONTINUOUS OR CONTINUE CONTR CONTRACTOR NOM NOMINAL NORTH CK CORK CORRIDOR NOT IN CONTRACT COUNTERSUNK NOT TO SCALE CNSK N.T.S. CRS NO OR# COURSE NUMBER OBS OFF DEMOLISH OR DEMOLITION OBSCURE OFFICE DEPT DEPARTMENT ON CENTER DEAD LOAD **OPENING** OPNG DIAMETER DIM **OPPOSITE** DIMENSION DISP ORIENTED STRAND BOARD DISPENSER DIV DIVISION OUTSIDE DIAMETER DOOR OA OVERALL OVERFLOW DRAIN DOOR OPENING DBL DS DOUBLE DOWNSPOUT PAINTED PTD DRW DRAWER DWG DRAWING PAIR PANEL DRINKING FOUNTAIN DS PBD DRY STANDPIPE PARTICLE BOARD DWT DETECTABLE WARNING TILE PTN PARTITION PLAS PLASTIC PLASTIC LAMINATE P-LAM EACH **EIFS** EXTERIOR INSULATION FINISH SYSTEM PTC PLUMBING TRADES CONTRACTOR ELECTRICAL PLYWD PLYWOOD POUNDS PER SQUARE INCH PSI PC **ELECTRICAL TRADES CONTRACTOR** ELECTRICAL WATER COOLER **PRECAST** PCC PRECAST CONCRETE ELECTRICAL PANEL BOARD **ELEVATION ELEVATION QUARRY TILE ELEVATOR RADIUS** ELVTR **ENCL ENCLOSURE** RAIN WATER LEADER **EMERGENCY** REFRIGERATOR RGTR REGISTER EP PT **EPOXY PAINT** REINF **EPOXY FLOORING** REINFORCED RQD REQUIRED **EQUIPMENT** RESILIENT **EXISTING** RETURN AIR **EXSTG** EXP **EXPANSION** RETURN AIR GRILLE **EXPANSION JOINT** RIGHT HAND EXPD RIGHT OF WAY EXTR **EXTERIOR** RISER **ROOF DRAIN** ROOM R.O. FACE OF CONCRETE **ROUGH OPENING** FOF RB FACE OF FINISH RUBBER BASE FACE OF STUD FIBERGLASS REINFORCED PANEL SECTION FIN SINK FINISH OR FINISHED SCHED SCHEDULE FIRE ALARM FIRE EXTINGUISHER SHEATHING FIRE EXTINGUISHER CABINET SHEET FHC FIRE HOSE CABINET SHEET VINYL SHOWER FIREPROOF SIMILAR FLAT BAR STOCK SEALED CONCRETE FLOOR FLOOR DRAIN SPM SINGLE PLY MEMBRANE **FLUORESCENT** SFRM SPRAY APPLIED FIRE RESISTIVE MATERIAL FOOT OR FEET FOOTING SPECIFICATION FOUNDATION FDN

MECH

MTC

MEMB

ΜT

MIN

MISC

MTD

SQUARE STAINLESS STEEL S.S. STANDARD STATION STA STL STEEL STOR

STORAGE STRUCT STRUCTURE OR STRUCTURAL SUSP SUSPENDED SUSPENDED ACOUSTICAL TILE

SYMMETRICAL

GENERAL TRADES CONTRACTOR

GLASS OR GLAZING GRADE GROUND

GALVANIZED

GENERAL

FRAMING

FULL SIZE

FURRING

FUTURE

FABRIC WALLCOVERING

GENERAL CONTRACTOR

FS

FUTR

GALV

GEN

GTC

GD

GND

GL

GYPSUM BOARD



DEMO RCP SYMBOLS LEGEND:

NOTE: REFER TO M.E.P.F.P. DRAWINGS FOR ADDITIONAL INFORMATION ON MECHANICAL, ELECTRICAL, AND FIRE PROTECTION SYSTEMS HATCH INDICATES AREA NOT IN SCOPE GYPSUM BOARD OR PLASTER PARTITION TO BE REMOVED FRAME AND DOOR TO BE REMOVED, SALVAGE HARDWARE TO OWNER SUSPENDED ACOUSTICAL TILE CEILING TO BE REMOVED

SUSPENDED ACOUSTICAL TILE CEILING TO REMAIN GYPSUM BOARD OR PLASTER CEILING TO BE REMOVED

GYPSUM BOARD OR PLASTER CEILING TO REMAIN RECESSED 2'x4' LAY-IN LIGHT FIXTURE TO BE REMOVED

RECESSED 2'x2' LAY-IN LIGHT FIXTURE TO BE REMOVED

REMOVE CEILING MOUNTED PROJECTOR - SALVAGE TO OWNER

RECESSED 2'x4' LAY-IN LIGHT FIXTURE TO REMAIN RECESSED 2'x2' LAY-IN LIGHT FIXTURE TO REMAIN

LINEAR LIGHT FIXTURE TO BE REMOVED REMOVE MOTORIZED SCREEN - SALVAGE TO OWNER

RETURN AIR GRILLE TO REMAIN

SUPPLY AIR GRILLE TO REMAIN

DEMO GENERAL NOTES:

. PRIOR TO AND DURING ANY DEMOLITION THE CONTRACTOR SHALL VERIFY AND MAINTAIN THE BUILDING'S STRUCTURAL INTEGRITY. . CONTRACTOR SHALL BE RESPONSIBLE FOR ALL DEMOLITION AS REQUIRED TO INSTALL ALL NEW WORK. REPAIR, PATCH AND FINISH EXISTING FLOORS, WALLS AND CEILINGS DESIGNATED TO REMAIN TO MATCH EXISTING CONDITIONS.

- REMOVE ALL HANGERS, SUSPENSION SYSTEMS, SUPPORT FRAMING, EQUIPMENT PADS, ANCHORS, ATTACHMENT HARDWARE AND RELATED APPURTENANCES CONNECTED WITH THE WORK TO BE DEMOLISHED. IF COMPLETE REMOVAL IS NOT POSSIBLE, CUT DEVICES AS CLOSE AS POSSIBLE TO ADJOINING SURFACES OR ORIGIN OF SUPPORT. 4. DURING THE BIDDING PERIOD, EACH BIDDING CONTRACTOR SHALL VISIT THE SITE AND THE FACILITY TO DETERMINE EXISTING CONDITIONS. CONTRACTOR 'S FAILURE TO REASONABL' DETERMINE AND/OR ANTICIPATE THE EFFECT OF EXISTING CONDITIONS AND THE WORK INVOLVED THEREBY SHALL NOT BE JUSTIFICATION FOR ADDITIONAL COMPENSATION.
- NOTIFY ARCHITECT OF ANY DISCREPANCIES. 5. ALL MATERIALS, EQUIPMENT, FIXTURES, SYSTEMS, AND ACCESSORIES WHICH ARE TO REMAIN IN SERVICE SHALL BE CLEANED, REPAIRED, ADJUSTED AND PLACED INTO PROPER OPERATIONS IN ALL MODES WITH THE ORIGINAL SYSTEM. WHEN TEMPORARY SHORING AND BRACING IS REQUIRED, CONTRACTOR SHALL RETAIN AND PAY FOR THE SERVICES OF A PROFESSIONAL ENGINEER-LICENSED TO PRACTICE IN
- THE STATE WHERE THE PROJECT IS LOCATED- TO DESIGN AND PREPARE DETAILED CONTRACTOR SHALL COORDINATE SCHEDULE OF DEMOLITION WORK WITH THE OVERALL PHASING PLAN. ALL AREAS SURROUNDING EACH PHASE OF DEMOLITION/CONSTRUCTION WILL BE OCCUPIED BY THE OWNER DURING THE OWNER'S NORMAL BUSINESS HOURS.
- DEMOLITION WORK SHALL NOT ENCUMBER THE USE OF EXISTING ADJACENT SPACES. . EACH CONTRACTOR SHALL FOLLOW THE PROGRESS OF THE GENERAL DEMOLITION AND REMODELING WORK TO ASSURE THE ACCESSIBILITY AND SAFETY OF EQUIPMENT AND SYSTEMS IN SERVICE IN ORDER TO PROVIDE FOR THE TIMELY REMOVAL AND/OR RELOCATION OF EQUIPMENT, PIPING, ETC. . REMOVE ALL ABANDONED CONDUIT BOXES, CONDUCTORS, TELEPHONE LINES, ELECTRIC
- PANELS, AND ANY OTHER MISCELLANEOUS EQUIPMENT NOT REQUIRED FOR THE NEW 10. REMOVE ALL RECESSED FLOOR BOXES, WALKER DUCTS, FLOORS SINKS, HUB DRAINS,
- ELECTRICAL RECEPTACLES, ETC. AND FILL VOIDS AS REQUIRED. 1. REMOVE ALL DOOR STOPS AT ASSOCIATED DOORS TO BE DEMOLISHED. 12. NO TOXIC SUBSTANCES HAVE BEEN NOTED ON THE SITE. SHOULD THE CONTRACTOR ENCOUNTER ANY ASBESTOS, ASBESTOS PRODUCTS, PCBs OR OTHER TOXIC SUBSTANCES, THE CONTRACTOR SHOULD REPORT THIS IMMEDIATELY TO THE OWNER IN WRITING PRIOR TO CONTINUING WORK IN THIS AREA. WORK SHALL NOT BE RESUMED EXCEPT BY WRITTEN
- AUTHORIZATION OR AGREEMENT. 13. ALL CONSTRUCTION DEBRIS AND EXCESS MATERIAL IS TO BE REMOVED BY THE CONTRACTOR AT THE END OF EACH WORK DAY. THE JOB SITE IS TO BE LEFT
- SUFFICIENTLY CLEAN AS TO WARRANT OWNER'S APPROVAL. 4. CONTRACTOR SHALL SALVAGE ALL EXISTING CEILING TILES FOR POSSIBLE REUSE OR AS EXTRA STOCK FOR OWNER. SALVAGE ONLY UN-CUT TILES WITH NO VISIBLE DAMAGE. ONCE REMOVED, OWNER AND ARCHITECT WILL FIELD REVIEW AND APPROVE SALVAGED TILES PRIOR TO REUSE OR STORAGE.

DEMO RCP REFERENCED NOTES:

FLOOR DEMOLITION KEYED NOTES

- REMOVE EXISTING FLOOR BOX COVER AND ALL ASSOCIATED WIRING AND DEVICES. LEAVE FLOOR BOX AND UNDERFLOOR RACEWAY INTACT. PROVIDE A HEAVY GAUGE PLATE OVER EXISTING FLOOR BOX AND ATTACH TO ADJACENT FLOOR SLAB. PREP AS REQUIRED FOR NEW FLOOR FINISHES.
- REMOVE EXISTING POWER / DATA VERTICAL UTILITY CHASE, INCLUDING ALL WIRING AND MOUNTING ACCESSORIES COMPLETE. REMOVE CARPET, BACKER, TRANSITIONS, RESILIENT BASE AND ALL ADHESIVES
- COMPLETE. CLEAN AND PREP FLOOR AREA FOR NEW FLOOR FINISH. REMOVE RESILIENT FLOORING, TRANSITIONS, RESILIENT BASE AND ALL ADHESIVES COMPLETE. CLEAN AND PREP AS REQUIRED FOR NEW FLOOR FINISH.

WALL DEMOLITION KEYED NOTES

- REMOVE HOLLOW METAL DOOR AND WINDOW SYSTEM COMPLETE. REMOVE HOLLOW METAL WINDOW SYSTEM AND ASSOCIATED GLAZING AND THE GYP SUPPORT WALL BELOW COMPLETE. PREP REMAINING WALL HEADER / JAMBS FOR NEW
- REMOVE EXISTING MARKERBOARD, CORK BOARD, PROJECTOR SCREEN, OR MISC WALL MOUNTED SHELVING COMPLETE. PATCH AND PREP EXISTING WALL AS REQUIRED FOR NEW WORK.
- REMOVE GYP / MTL STUD PARTITION TO EXTENTS INDICATED. RELOCATE ANY PIPING OR WIRING FEEDING ANY EXISTING TO REMAIN DEVICES OR FIXTURES.. PATCH AND PREP ADJACENT WALLS TO REMAIN FOR NEW WORK.
- REMOVE PORTION OF MTL. STUD WALL AS REQUIRED FOR NEW OPENING. PATCH EXISTING WALL AS REQUIRED FOR NEW WORK.
- PROVIDE FULL HEIGHT DUST-PARTITION AT CORRIDOR TO EXTENTS INDICATED. INSTALL FOR THE DURATION OF CONSTRUCTION.

CEILING DEMOLITION KEYED NOTES

- C1. REMOVE EXISTING SUSPENDED CEILING SYSTEM COMPLETE, INCLUDING ALL
- EXISTING CEILING TO REMAIN. PROTECT THROUGHOUT CONSTRUCTION AND TIE INTO NEW CEILING SYSTEM AS REQUIRED. REMOVE EXISTING BLINDS COMPLETE. PREP WALL / CEILING AS REQUIRED FOR NEW
- REMOVE EXISTING CEILING TILES AND MODIFY EXISTING GRID AS REQUIRED FOR NEW
- WORK (REFER TO RCP / ELEC) REMOVE EXISTING SUPPLY AIR DIFFUSERS AND RETURN AIR GRILLE.
- EXISTING RADIANT HEATING TILE SYSTEM TO REMAIN. PROTECT THROUGHOUT CONSTRUCTION.
- REMOVE SPEAKER AND SALVAGE FOR REINSTALLATION IN NEW WORK (REFER TO REMOVE AND SALVAGE EXISTING CEILING LIGHTING FOR REINSTALLATION, LEAVE GRID INTACT AND PROTECT AS REQUIRED FOR NEW WORK.

MISCELLANEOUS DEMOLITION KEYED NOTES

- REMOVE EXISTING COUNTERTOPS, SHELVES, BOOKCASES, AND BASE CABINETS
- NOT USED. REMOVE PAPER TOWEL / SOAP DISPENSER AND TURN OVER TO OWNER.
 - REMOVE SINK AND ASSOCIATED PLUMBING COMPLETE. REFER TO NEW WORK FOR EXTENT OF REMOVAL REQUIRED. REMOVE WALL MOUNTED RACEWAY COMPLETE - PREP WALL FOR NEW WORK.



ARCHITECT OF DEMONICA KEMPER ARCHITECTS 125 N. HALSTED STREET, SUITE 301 **CHICAGO, IL 60661**

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KEY PLAN:

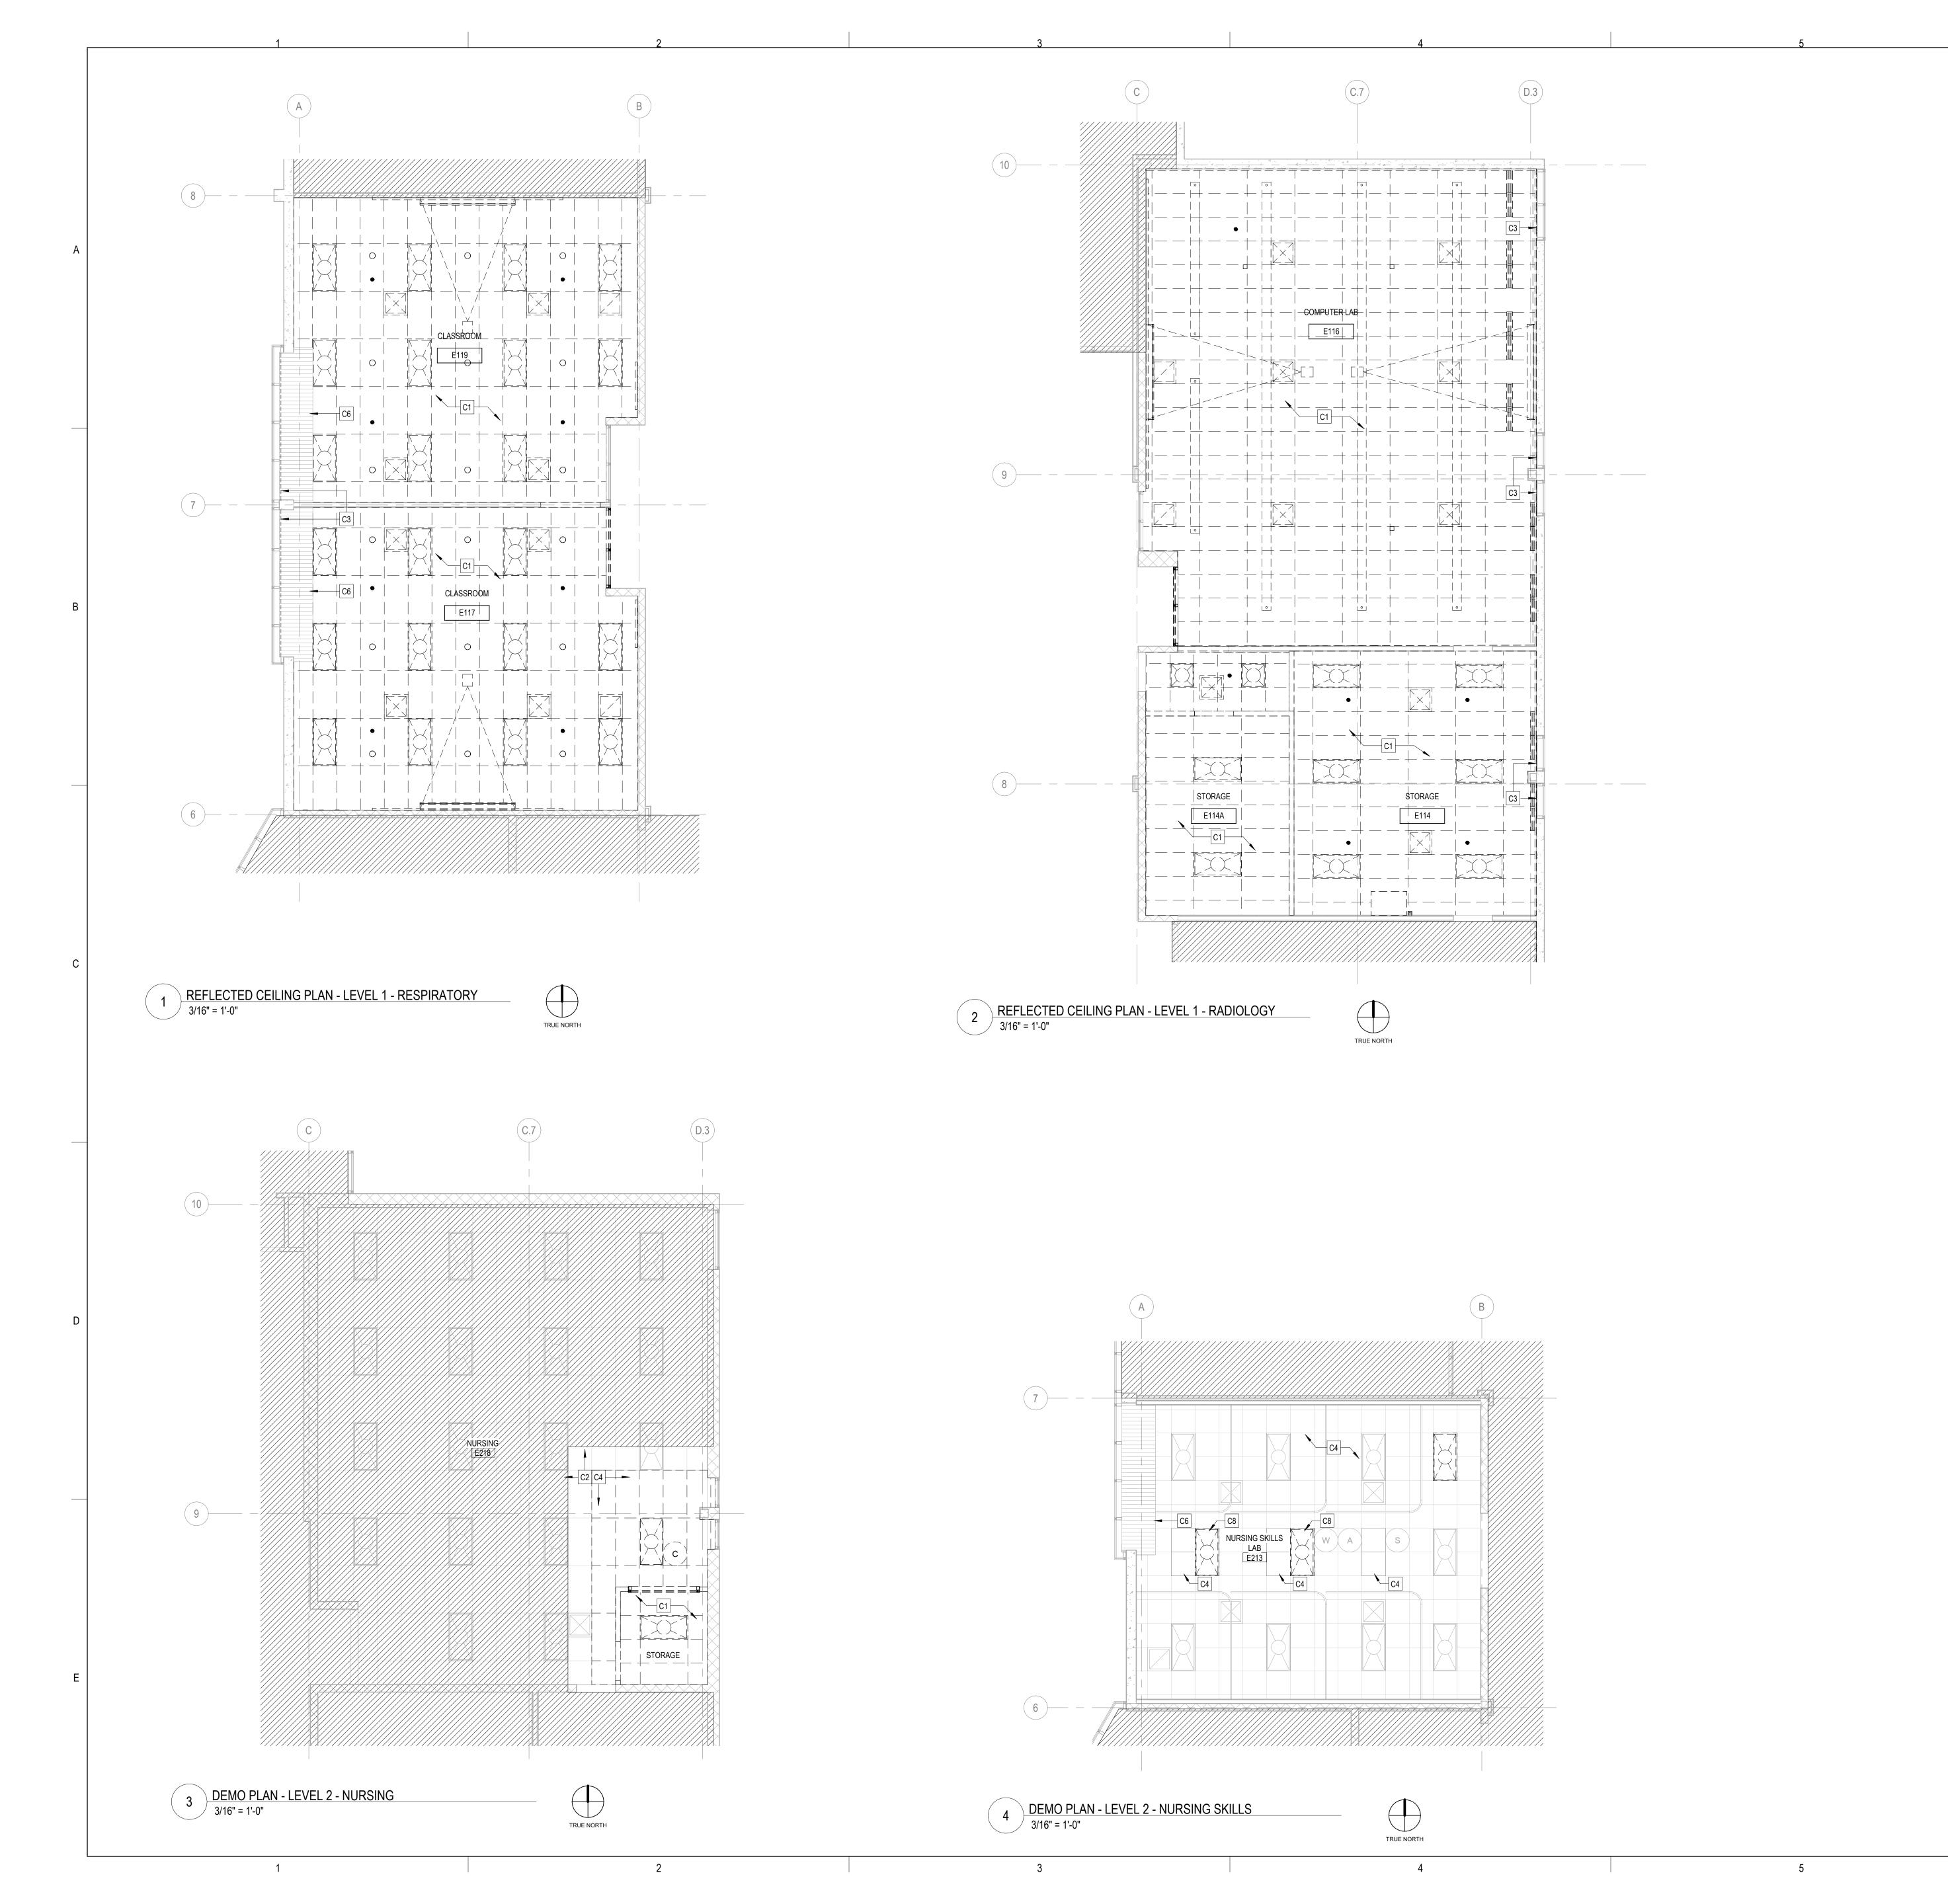
SHEET STATUS: 02/18/2025 **ISSUED FOR BID - NOT** FOR CONSTRUCTION

DESCRIPTION: SHEET TITLE:

DEMOLITION PLANS

SHEET NUMBER:

2/18/2025 1:10:20 PM





DEMO RCP SYMBOLS LEGEND:

MECHANICAL, ELECTRICAL, AND FIRE PROTECTION SYSTEMS

NOTE: REFER TO M.E.P.F.P. DRAWINGS FOR ADDITIONAL INFORMATION ON

HARDWARE TO OWNER

HATCH INDICATES AREA NOT IN SCOPE

GYPSUM BOARD OR PLASTER PARTITION TO BE REMOVED

SUSPENDED ACOUSTICAL TILE CEILING TO BE REMOVED

GYPSUM BOARD OR PLASTER CEILING TO BE REMOVED

RECESSED 2'x4' LAY-IN LIGHT FIXTURE TO BE REMOVED

RECESSED 2'x2' LAY-IN LIGHT FIXTURE TO BE REMOVED

RECESSED 2'x4' LAY-IN LIGHT FIXTURE TO REMAIN

RECESSED 2'x2' LAY-IN LIGHT FIXTURE TO REMAIN

REMOVE MOTORIZED SCREEN - SALVAGE TO OWNER

REMOVE CEILING MOUNTED PROJECTOR - SALVAGE TO OWNER

LINEAR LIGHT FIXTURE TO BE REMOVED

RETURN AIR GRILLE TO REMAIN

SUPPLY AIR GRILLE TO REMAIN

PRIOR TO AND DURING ANY DEMOLITION THE CONTRACTOR SHALL VERIFY AND MAINTAIN

CONTRACTOR SHALL BE RESPONSIBLE FOR ALL DEMOLITION AS REQUIRED TO INSTALL ALL NEW WORK. REPAIR, PATCH AND FINISH EXISTING FLOORS, WALLS AND CEILINGS

REMOVE ALL HANGERS, SUSPENSION SYSTEMS, SUPPORT FRAMING, EQUIPMENT PADS. ANCHORS, ATTACHMENT HARDWARE AND RELATED APPURTENANCES CONNECTED WITH THE WORK TO BE DEMOLISHED. IF COMPLETE REMOVAL IS NOT POSSIBLE, CUT DEVICES

4. DURING THE BIDDING PERIOD, EACH BIDDING CONTRACTOR SHALL VISIT THE SITE AND THE FACILITY TO DETERMINE EXISTING CONDITIONS. CONTRACTOR 'S FAILURE TO REASONABL'

DETERMINE AND/OR ANTICIPATE THE EFFECT OF EXISTING CONDITIONS AND THE WORK INVOLVED THEREBY SHALL NOT BE JUSTIFICATION FOR ADDITIONAL COMPENSATION.

. ALL MATERIALS, EQUIPMENT, FIXTURES, SYSTEMS, AND ACCESSORIES WHICH ARE TO REMAIN IN SERVICE SHALL BE CLEANED, REPAIRED, ADJUSTED AND PLACED INTO PROPER

WHEN TEMPORARY SHORING AND BRACING IS REQUIRED, CONTRACTOR SHALL RETAIN AND PAY FOR THE SERVICES OF A PROFESSIONAL ENGINEER- LICENSED TO PRACTICE IN THE STATE WHERE THE PROJECT IS LOCATED- TO DESIGN AND PREPARE DETAILED

CONTRACTOR SHALL COORDINATE SCHEDULE OF DEMOLITION WORK WITH THE OVERALL PHASING PLAN. ALL AREAS SURROUNDING EACH PHASE OF DEMOLITION/CONSTRUCTION WILL BE OCCUPIED BY THE OWNER DURING THE OWNER'S NORMAL BUSINESS HOURS.

DEMOLITION WORK SHALL NOT ENCUMBER THE USE OF EXISTING ADJACENT SPACES. . EACH CONTRACTOR SHALL FOLLOW THE PROGRESS OF THE GENERAL DEMOLITION AND REMODELING WORK TO ASSURE THE ACCESSIBILITY AND SAFETY OF EQUIPMENT AND SYSTEMS IN SERVICE IN ORDER TO PROVIDE FOR THE TIMELY REMOVAL AND/OR

. REMOVE ALL ABANDONED CONDUIT BOXES, CONDUCTORS, TELEPHONE LINES, ELECTRIC

PANELS, AND ANY OTHER MISCELLANEOUS EQUIPMENT NOT REQUIRED FOR THE NEW

10. REMOVE ALL RECESSED FLOOR BOXES, WALKER DUCTS, FLOORS SINKS, HUB DRAINS,

12. NO TOXIC SUBSTANCES HAVE BEEN NOTED ON THE SITE. SHOULD THE CONTRACTOR

13. ALL CONSTRUCTION DEBRIS AND EXCESS MATERIAL IS TO BE REMOVED BY THE CONTRACTOR AT THE END OF EACH WORK DAY. THE JOB SITE IS TO BE LEFT

ENCOUNTER ANY ASBESTOS, ASBESTOS PRODUCTS, PCBs OR OTHER TOXIC SUBSTANCES, THE CONTRACTOR SHOULD REPORT THIS IMMEDIATELY TO THE OWNER IN WRITING PRIOR TO CONTINUING WORK IN THIS AREA. WORK SHALL NOT BE RESUMED EXCEPT BY WRITTEN

4. CONTRACTOR SHALL SALVAGE ALL EXISTING CEILING TILES FOR POSSIBLE REUSE OR AS EXTRA STOCK FOR OWNER. SALVAGE ONLY UN-CUT TILES WITH NO VISIBLE DAMAGE. ONCE REMOVED, OWNER AND ARCHITECT WILL FIELD REVIEW AND APPROVE SALVAGED

REMOVE EXISTING FLOOR BOX COVER AND ALL ASSOCIATED WIRING AND DEVICES. LEAVE FLOOR BOX AND UNDERFLOOR RACEWAY INTACT. PROVIDE A HEAVY GAUGE PLATE OVER EXISTING FLOOR BOX AND ATTACH TO ADJACENT FLOOR SLAB. PREP AS

REMOVE EXISTING POWER / DATA VERTICAL UTILITY CHASE, INCLUDING ALL WIRING

REMOVE RESILIENT FLOORING, TRANSITIONS, RESILIENT BASE AND ALL ADHESIVES

REMOVE HOLLOW METAL WINDOW SYSTEM AND ASSOCIATED GLAZING AND THE GYP SUPPORT WALL BELOW COMPLETE. PREP REMAINING WALL HEADER / JAMBS FOR NEW

REMOVE EXISTING MARKERBOARD, CORK BOARD, PROJECTOR SCREEN, OR MISC

REMOVE GYP / MTL STUD PARTITION TO EXTENTS INDICATED. RELOCATE ANY PIPING OR WIRING FEEDING ANY EXISTING TO REMAIN DEVICES OR FIXTURES.. PATCH AND

WALL MOUNTED SHELVING COMPLETE. PATCH AND PREP EXISTING WALL AS

PROVIDE FULL HEIGHT DUST-PARTITION AT CORRIDOR TO EXTENTS INDICATED.

EXISTING CEILING TO REMAIN. PROTECT THROUGHOUT CONSTRUCTION AND TIE INTO

REMOVE EXISTING BLINDS COMPLETE. PREP WALL / CEILING AS REQUIRED FOR NEW

REMOVE EXISTING CEILING TILES AND MODIFY EXISTING GRID AS REQUIRED FOR NEW

EXISTING RADIANT HEATING TILE SYSTEM TO REMAIN. PROTECT THROUGHOUT

REMOVE SPEAKER AND SALVAGE FOR REINSTALLATION IN NEW WORK (REFER TO

REMOVE AND SALVAGE EXISTING CEILING LIGHTING FOR REINSTALLATION, LEAVE

REMOVE EXISTING COUNTERTOPS, SHELVES, BOOKCASES, AND BASE CABINETS

REMOVE SINK AND ASSOCIATED PLUMBING COMPLETE. REFER TO NEW WORK FOR

REMOVE WALL MOUNTED RACEWAY COMPLETE - PREP WALL FOR NEW WORK.

REMOVE PAPER TOWEL / SOAP DISPENSER AND TURN OVER TO OWNER.

REMOVE PORTION OF MTL. STUD WALL AS REQUIRED FOR NEW OPENING.

C1. REMOVE EXISTING SUSPENDED CEILING SYSTEM COMPLETE, INCLUDING ALL

REMOVE EXISTING SUPPLY AIR DIFFUSERS AND RETURN AIR GRILLE.

GRID INTACT AND PROTECT AS REQUIRED FOR NEW WORK.

REMOVE CARPET, BACKER, TRANSITIONS, RESILIENT BASE AND ALL ADHESIVES

COMPLETE. CLEAN AND PREP FLOOR AREA FOR NEW FLOOR FINISH.

COMPLETE. CLEAN AND PREP AS REQUIRED FOR NEW FLOOR FINISH.

REMOVE HOLLOW METAL DOOR AND WINDOW SYSTEM COMPLETE.

PREP ADJACENT WALLS TO REMAIN FOR NEW WORK.

PATCH EXISTING WALL AS REQUIRED FOR NEW WORK.

INSTALL FOR THE DURATION OF CONSTRUCTION.

NEW CEILING SYSTEM AS REQUIRED.

WORK (REFER TO RCP / ELEC)

ELECTRICAL RECEPTACLES, ETC. AND FILL VOIDS AS REQUIRED.

SUFFICIENTLY CLEAN AS TO WARRANT OWNER'S APPROVAL.

DEMO RCP REFERENCED NOTES:

REQUIRED FOR NEW FLOOR FINISHES.

AND MOUNTING ACCESSORIES COMPLETE.

1. REMOVE ALL DOOR STOPS AT ASSOCIATED DOORS TO BE DEMOLISHED.

AS CLOSE AS POSSIBLE TO ADJOINING SURFACES OR ORIGIN OF SUPPORT.

DEMO GENERAL NOTES:

THE BUILDING'S STRUCTURAL INTEGRITY.

NOTIFY ARCHITECT OF ANY DISCREPANCIES.

RELOCATION OF EQUIPMENT, PIPING, ETC.

AUTHORIZATION OR AGREEMENT.

TILES PRIOR TO REUSE OR STORAGE.

FLOOR DEMOLITION KEYED NOTES

WALL DEMOLITION KEYED NOTES

CEILING DEMOLITION KEYED NOTES

CONSTRUCTION.

MISCELLANEOUS DEMOLITION KEYED NOTES

EXTENT OF REMOVAL REQUIRED.

NOT USED.

REQUIRED FOR NEW WORK.

DESIGNATED TO REMAIN TO MATCH EXISTING CONDITIONS.

OPERATIONS IN ALL MODES WITH THE ORIGINAL SYSTEM.

GYPSUM BOARD OR PLASTER CEILING TO REMAIN

SUSPENDED ACOUSTICAL TILE CEILING TO REMAIN

FRAME AND DOOR TO BE REMOVED, SALVAGE

ARCHITECT OF DEMONICA KEMPER ARCHITECTS 125 N. HALSTED STREET, SUITE 301 CHICAGO, IL 60661 P: 312.496.0000

S / MEP / FP / T ENGINEERS: IMEG CORP. 1100 WARRENVILLE RD., SUITE 400W NAPERVILLE, IL 60563 P: 630.527.2320

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McHenry County College HEALTH SCIENCE 2024 RENOVA

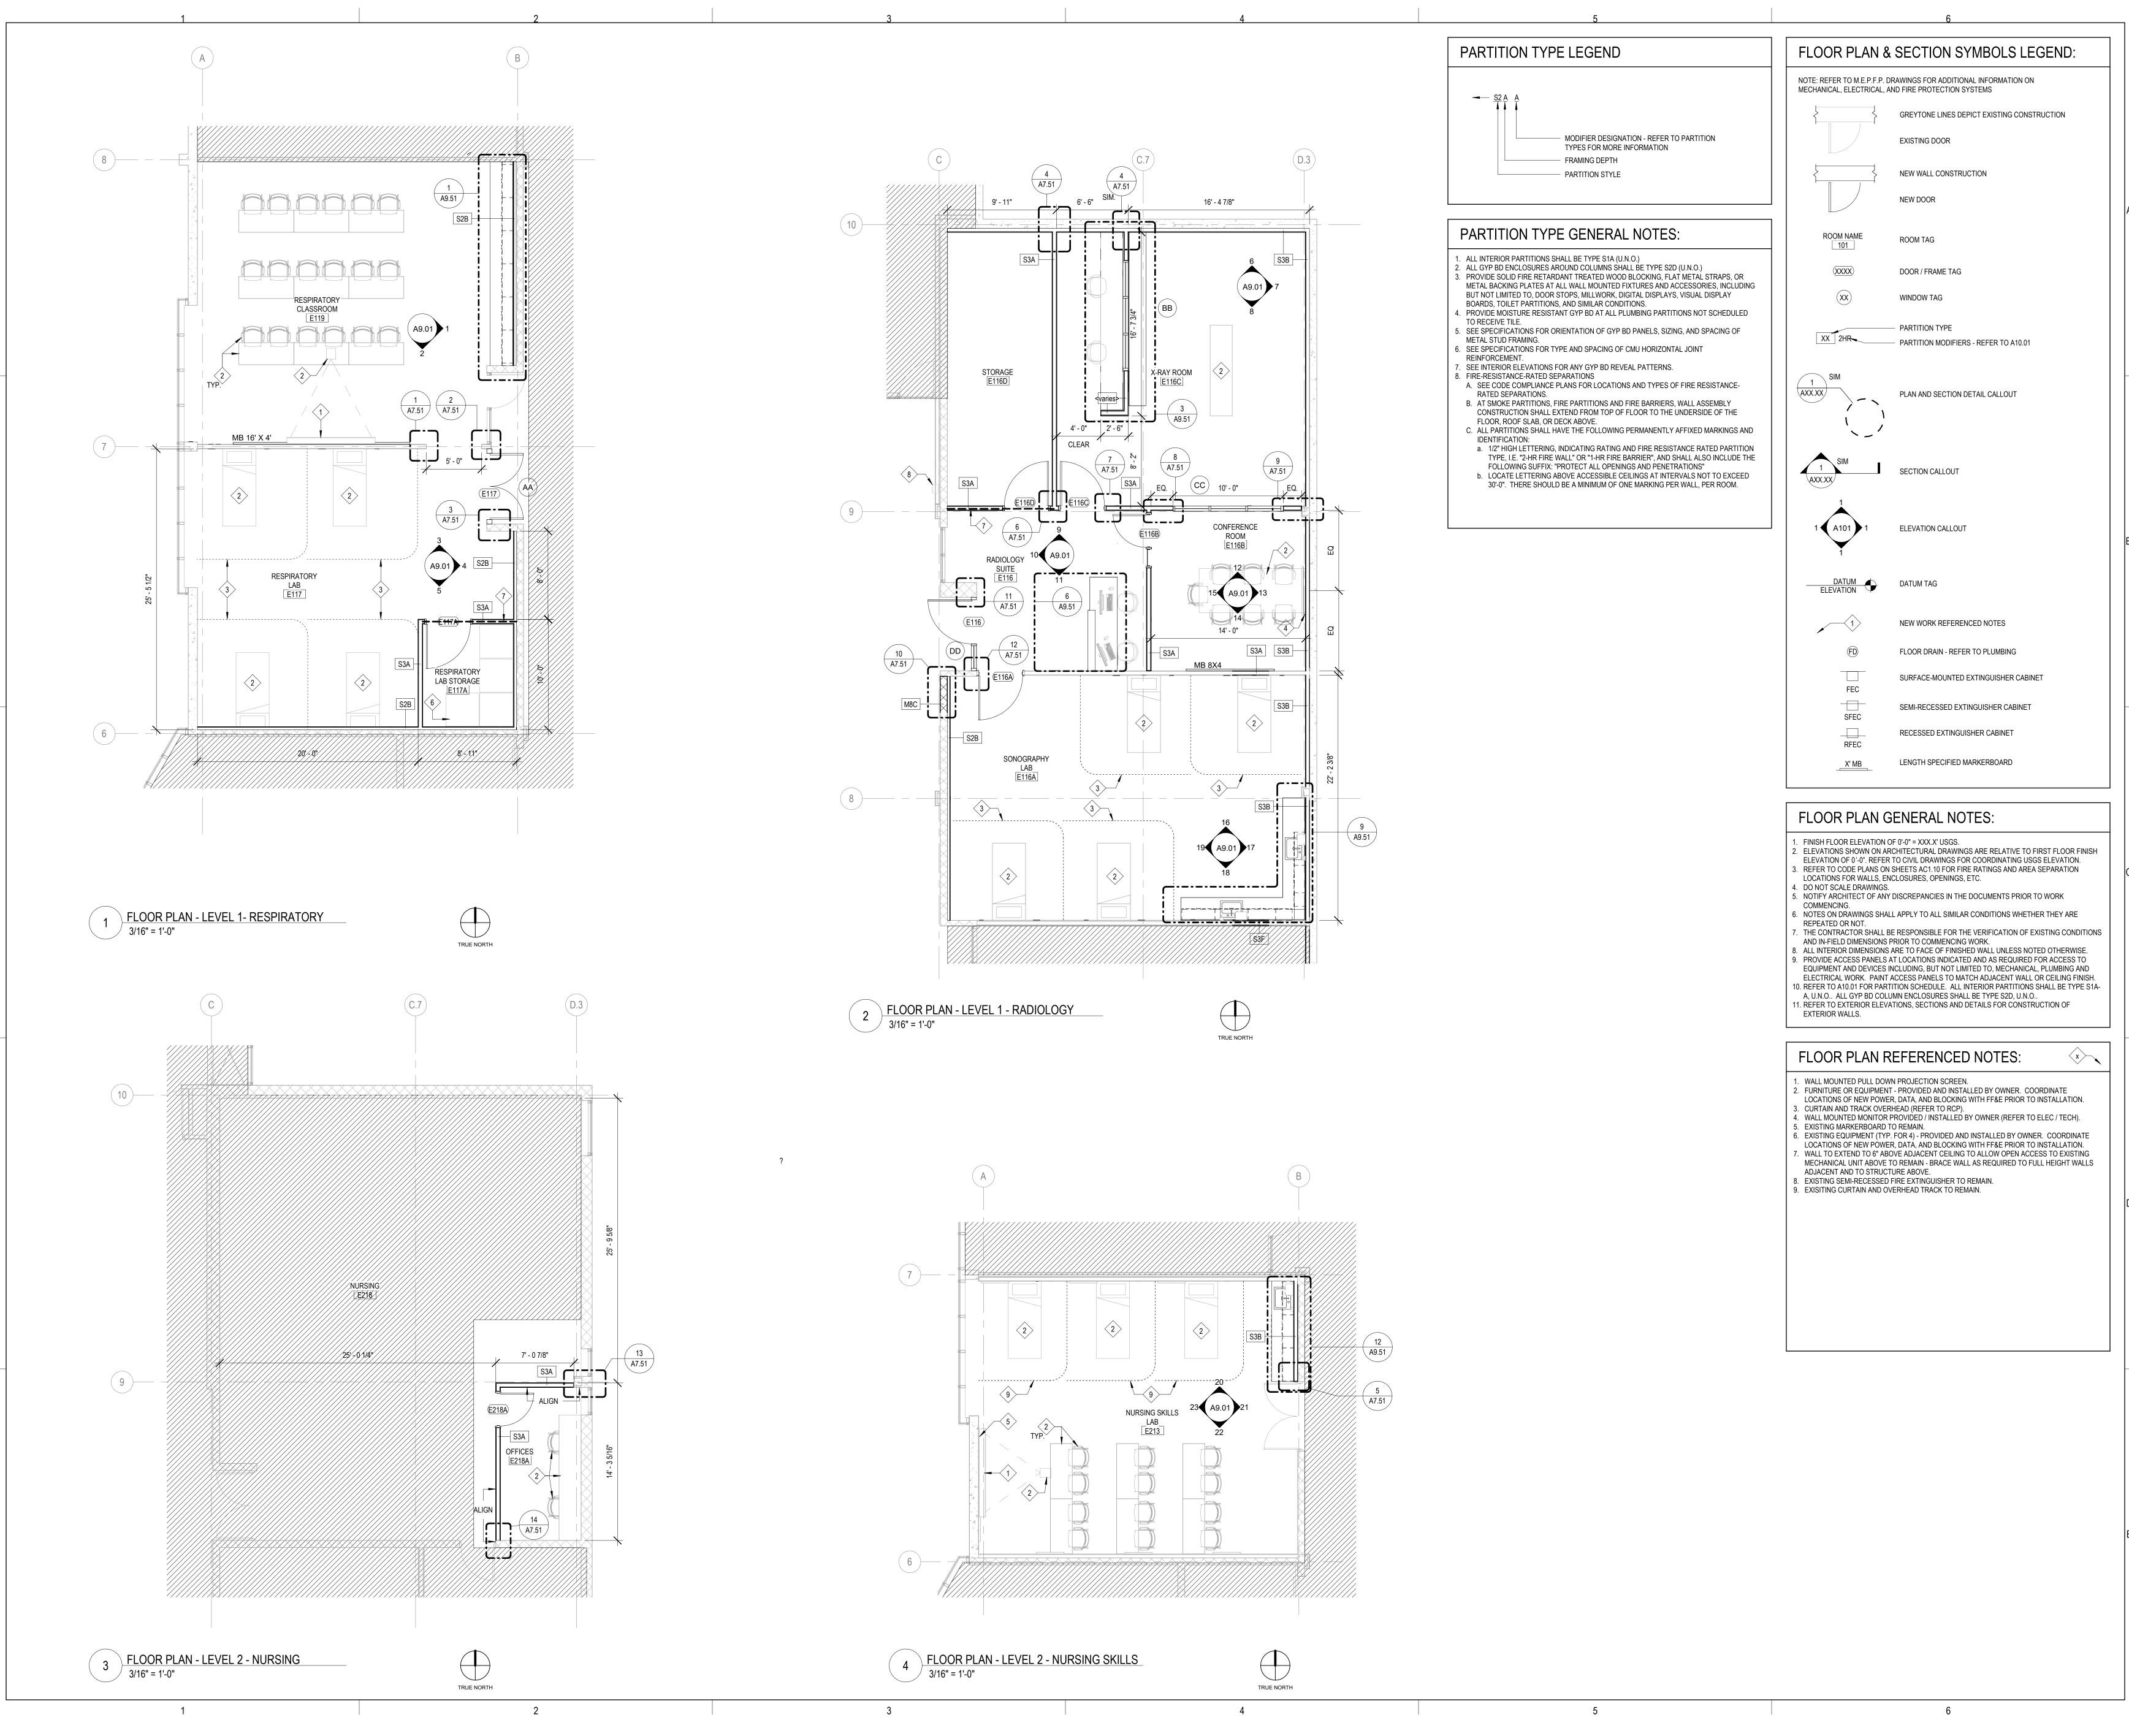
KEY PLAN:

SHEET STATUS: ISSUED FOR BID - NOT FOR CONSTRUCTION

NO: DESCRIPTION: DATE:

SHEET TITLE: OVERALL FLOOR PLAN

SHEET NUMBER:





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1100 WARRENVILLE RD., SUITE
400W NAPERVILLE, IL 60563
P: 630.527.2320

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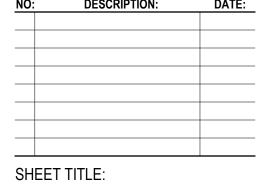
8600 ROUTE 14, SU CRYSTAL LAKE, IL DKA PROJECT NO:24

KEY PLAN:

SHEET STATUS: 02/18/2025

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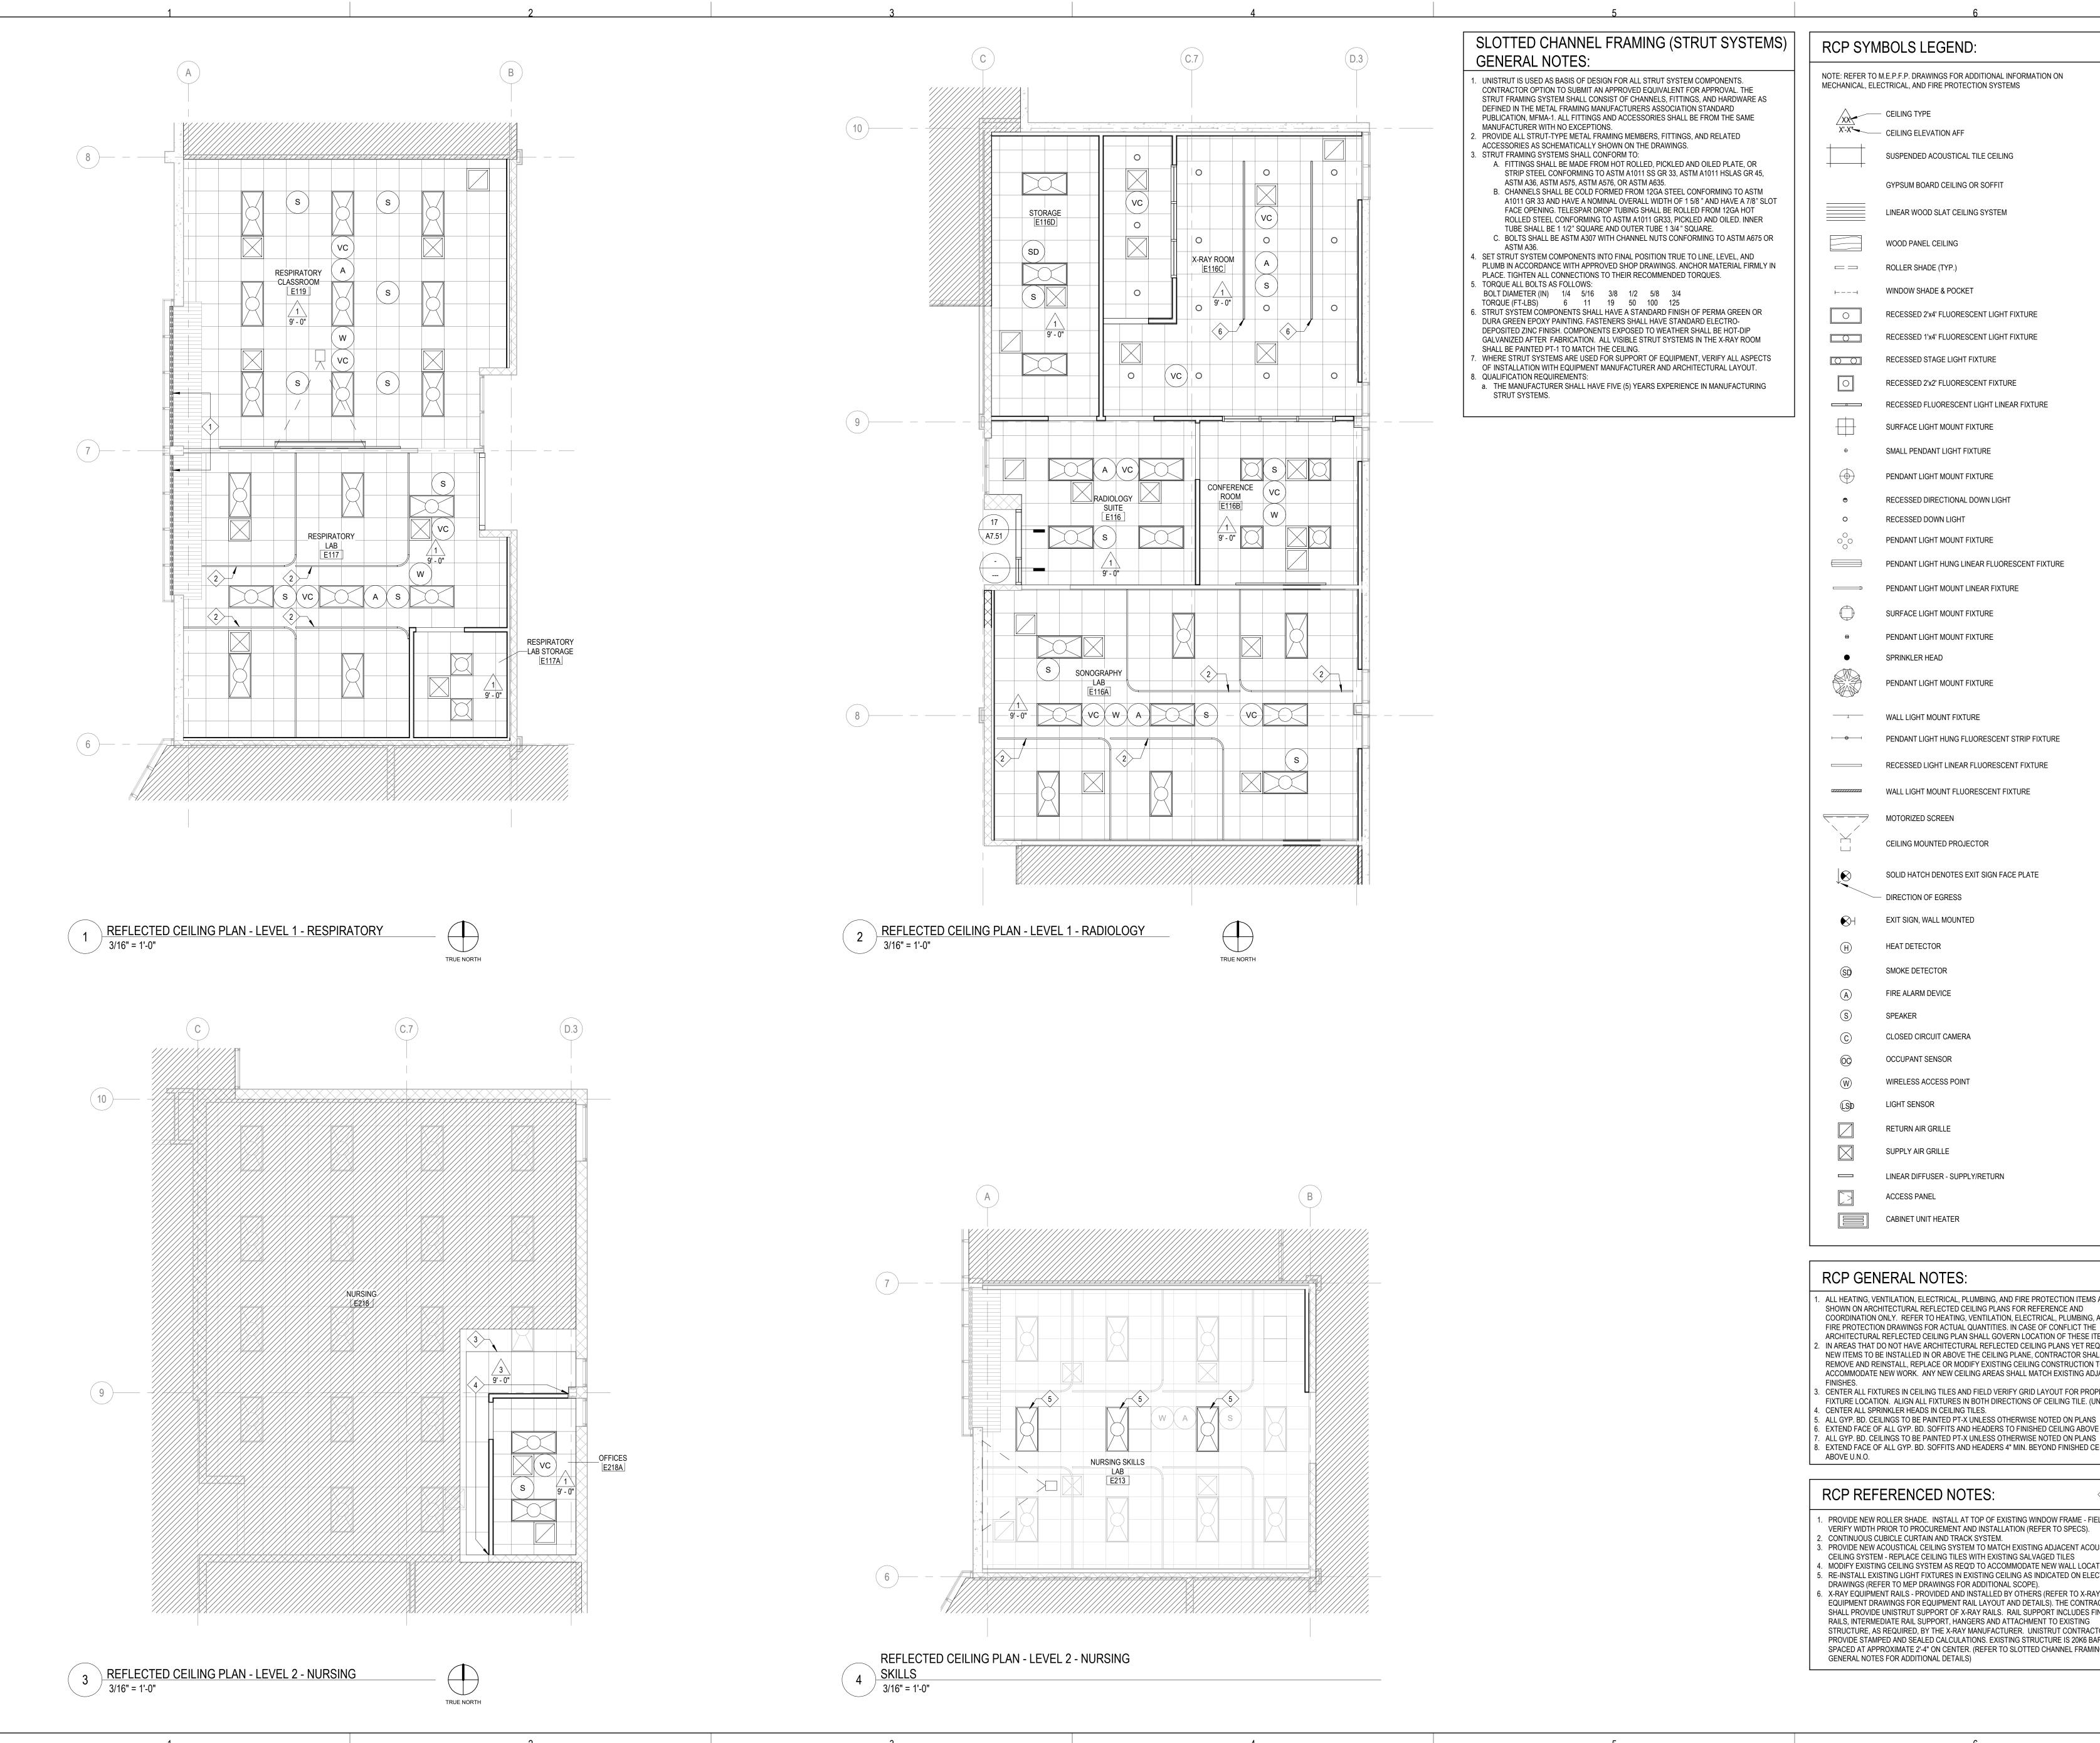


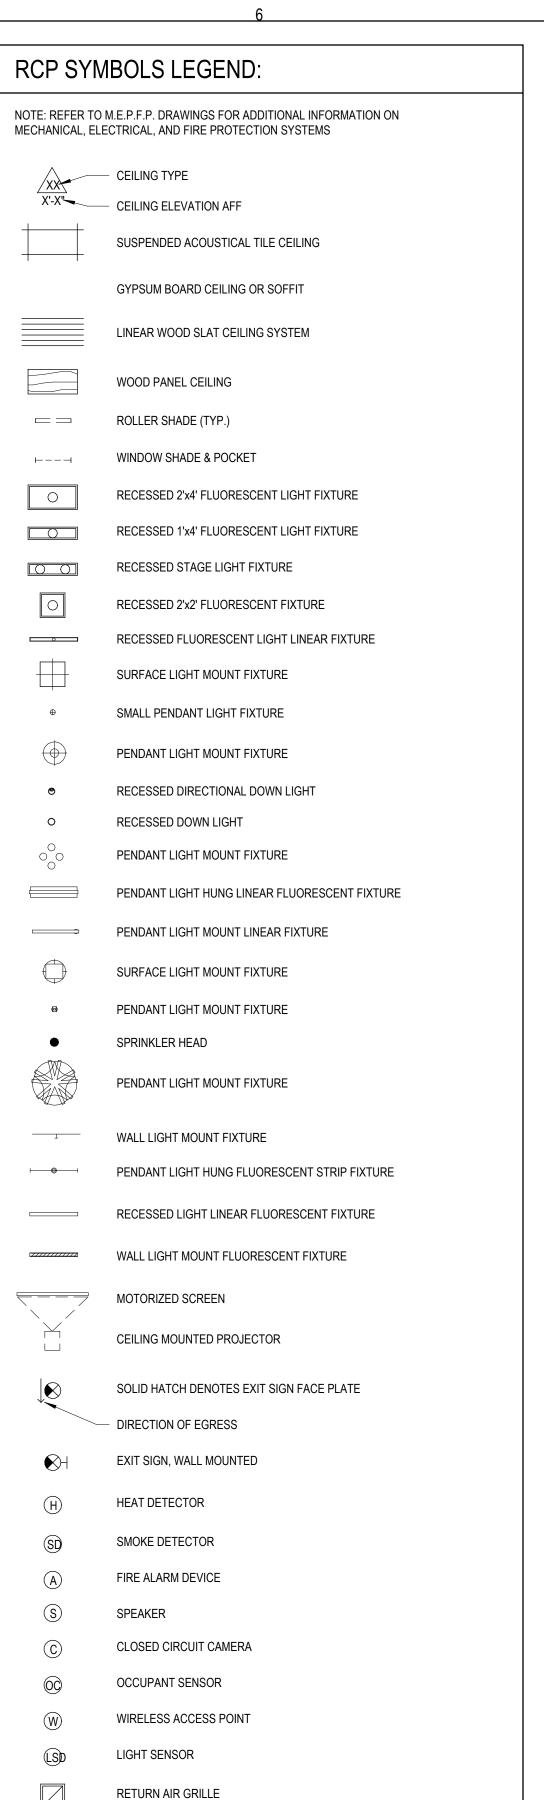
FLOOR PLANS

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RCP GENERAL NOTES:

SUPPLY AIR GRILLE

ACCESS PANEL

CABINET UNIT HEATER

LINEAR DIFFUSER - SUPPLY/RETURN

ALL HEATING, VENTILATION, ELECTRICAL, PLUMBING, AND FIRE PROTECTION ITEMS ARE SHOWN ON ARCHITECTURAL REFLECTED CEILING PLANS FOR REFERENCE AND COORDINATION ONLY. REFER TO HEATING, VENTILATION, ELECTRICAL, PLUMBING, AND FIRE PROTECTION DRAWINGS FOR ACTUAL QUANTITIES. IN CASE OF CONFLICT THE ARCHITECTURAL REFLECTED CEILING PLAN SHALL GOVERN LOCATION OF THESE ITEMS. IN AREAS THAT DO NOT HAVE ARCHITECTURAL REFLECTED CEILING PLANS YET REQUIRE NEW ITEMS TO BE INSTALLED IN OR ABOVE THE CEILING PLANE, CONTRACTOR SHALL REMOVE AND REINSTALL, REPLACE OR MODIFY EXISTING CEILING CONSTRUCTION TO ACCOMMODATE NEW WORK. ANY NEW CEILING AREAS SHALL MATCH EXISTING ADJACENT

- . CENTER ALL FIXTURES IN CEILING TILES AND FIELD VERIFY GRID LAYOUT FOR PROPER
- FIXTURE LOCATION. ALIGN ALL FIXTURES IN BOTH DIRECTIONS OF CEILING TILE. (UNO) . CENTER ALL SPRINKLER HEADS IN CEILING TILES.
- 6. EXTEND FACE OF ALL GYP. BD. SOFFITS AND HEADERS TO FINISHED CEILING ABOVE U.N.O. . ALL GYP. BD. CEILINGS TO BE PAINTED PT-X UNLESS OTHERWISE NOTED ON PLANS B. EXTEND FACE OF ALL GYP. BD. SOFFITS AND HEADERS 4" MIN. BEYOND FINISHED CEILING ABOVE U.N.O.

RCP REFERENCED NOTES:

- . PROVIDE NEW ROLLER SHADE. INSTALL AT TOP OF EXISTING WINDOW FRAME FIELD
- VERIFY WIDTH PRIOR TO PROCUREMENT AND INSTALLATION (REFER TO SPECS). . CONTINUOUS CUBICLE CURTAIN AND TRACK SYSTEM.
- . PROVIDE NEW ACOUSTICAL CEILING SYSTEM TO MATCH EXISTING ADJACENT ACOUSTICAL CEILING SYSTEM - REPLACE CEILING TILES WITH EXISTING SALVAGED TILES 4. MODIFY EXISTING CEILING SYSTEM AS REQ'D TO ACCOMMODATE NEW WALL LOCATION. 5. RE-INSTALL EXISTING LIGHT FIXTURES IN EXISTING CEILING AS INDICATED ON ELECTRICAL
- DRAWINGS (REFER TO MEP DRAWINGS FOR ADDITIONAL SCOPE). 6. X-RAY EQUIPMENT RAILS - PROVIDED AND INSTALLED BY OTHERS (REFER TO X-RAY EQUIPMENT DRAWINGS FOR EQUIPMENT RAIL LAYOUT AND DETAILS). THE CONTRACTOR SHALL PROVIDE UNISTRUT SUPPORT OF X-RAY RAILS. RAIL SUPPORT INCLUDES FINISH RAILS, INTERMEDIATE RAIL SUPPORT, HANGERS AND ATTACHMENT TO EXISTING STRUCTURE, AS REQUIRED, BY THE X-RAY MANUFACTURER. UNISTRUT CONTRACTOR TO PROVIDE STAMPED AND SEALED CALCULATIONS. EXISTING STRUCTURE IS 20K6 BAR JOISTS SPACED AT APPROXIMATE 2'-4" ON CENTER. (REFER TO SLOTTED CHANNEL FRAMING

ARCHITECT OF DEMONICA KEMPER ARCHITECTS 125 N. HALSTED STREET, SUITE 301 **CHICAGO, IL 60661** P: 312.496.0000

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Count

KEY PLAN:

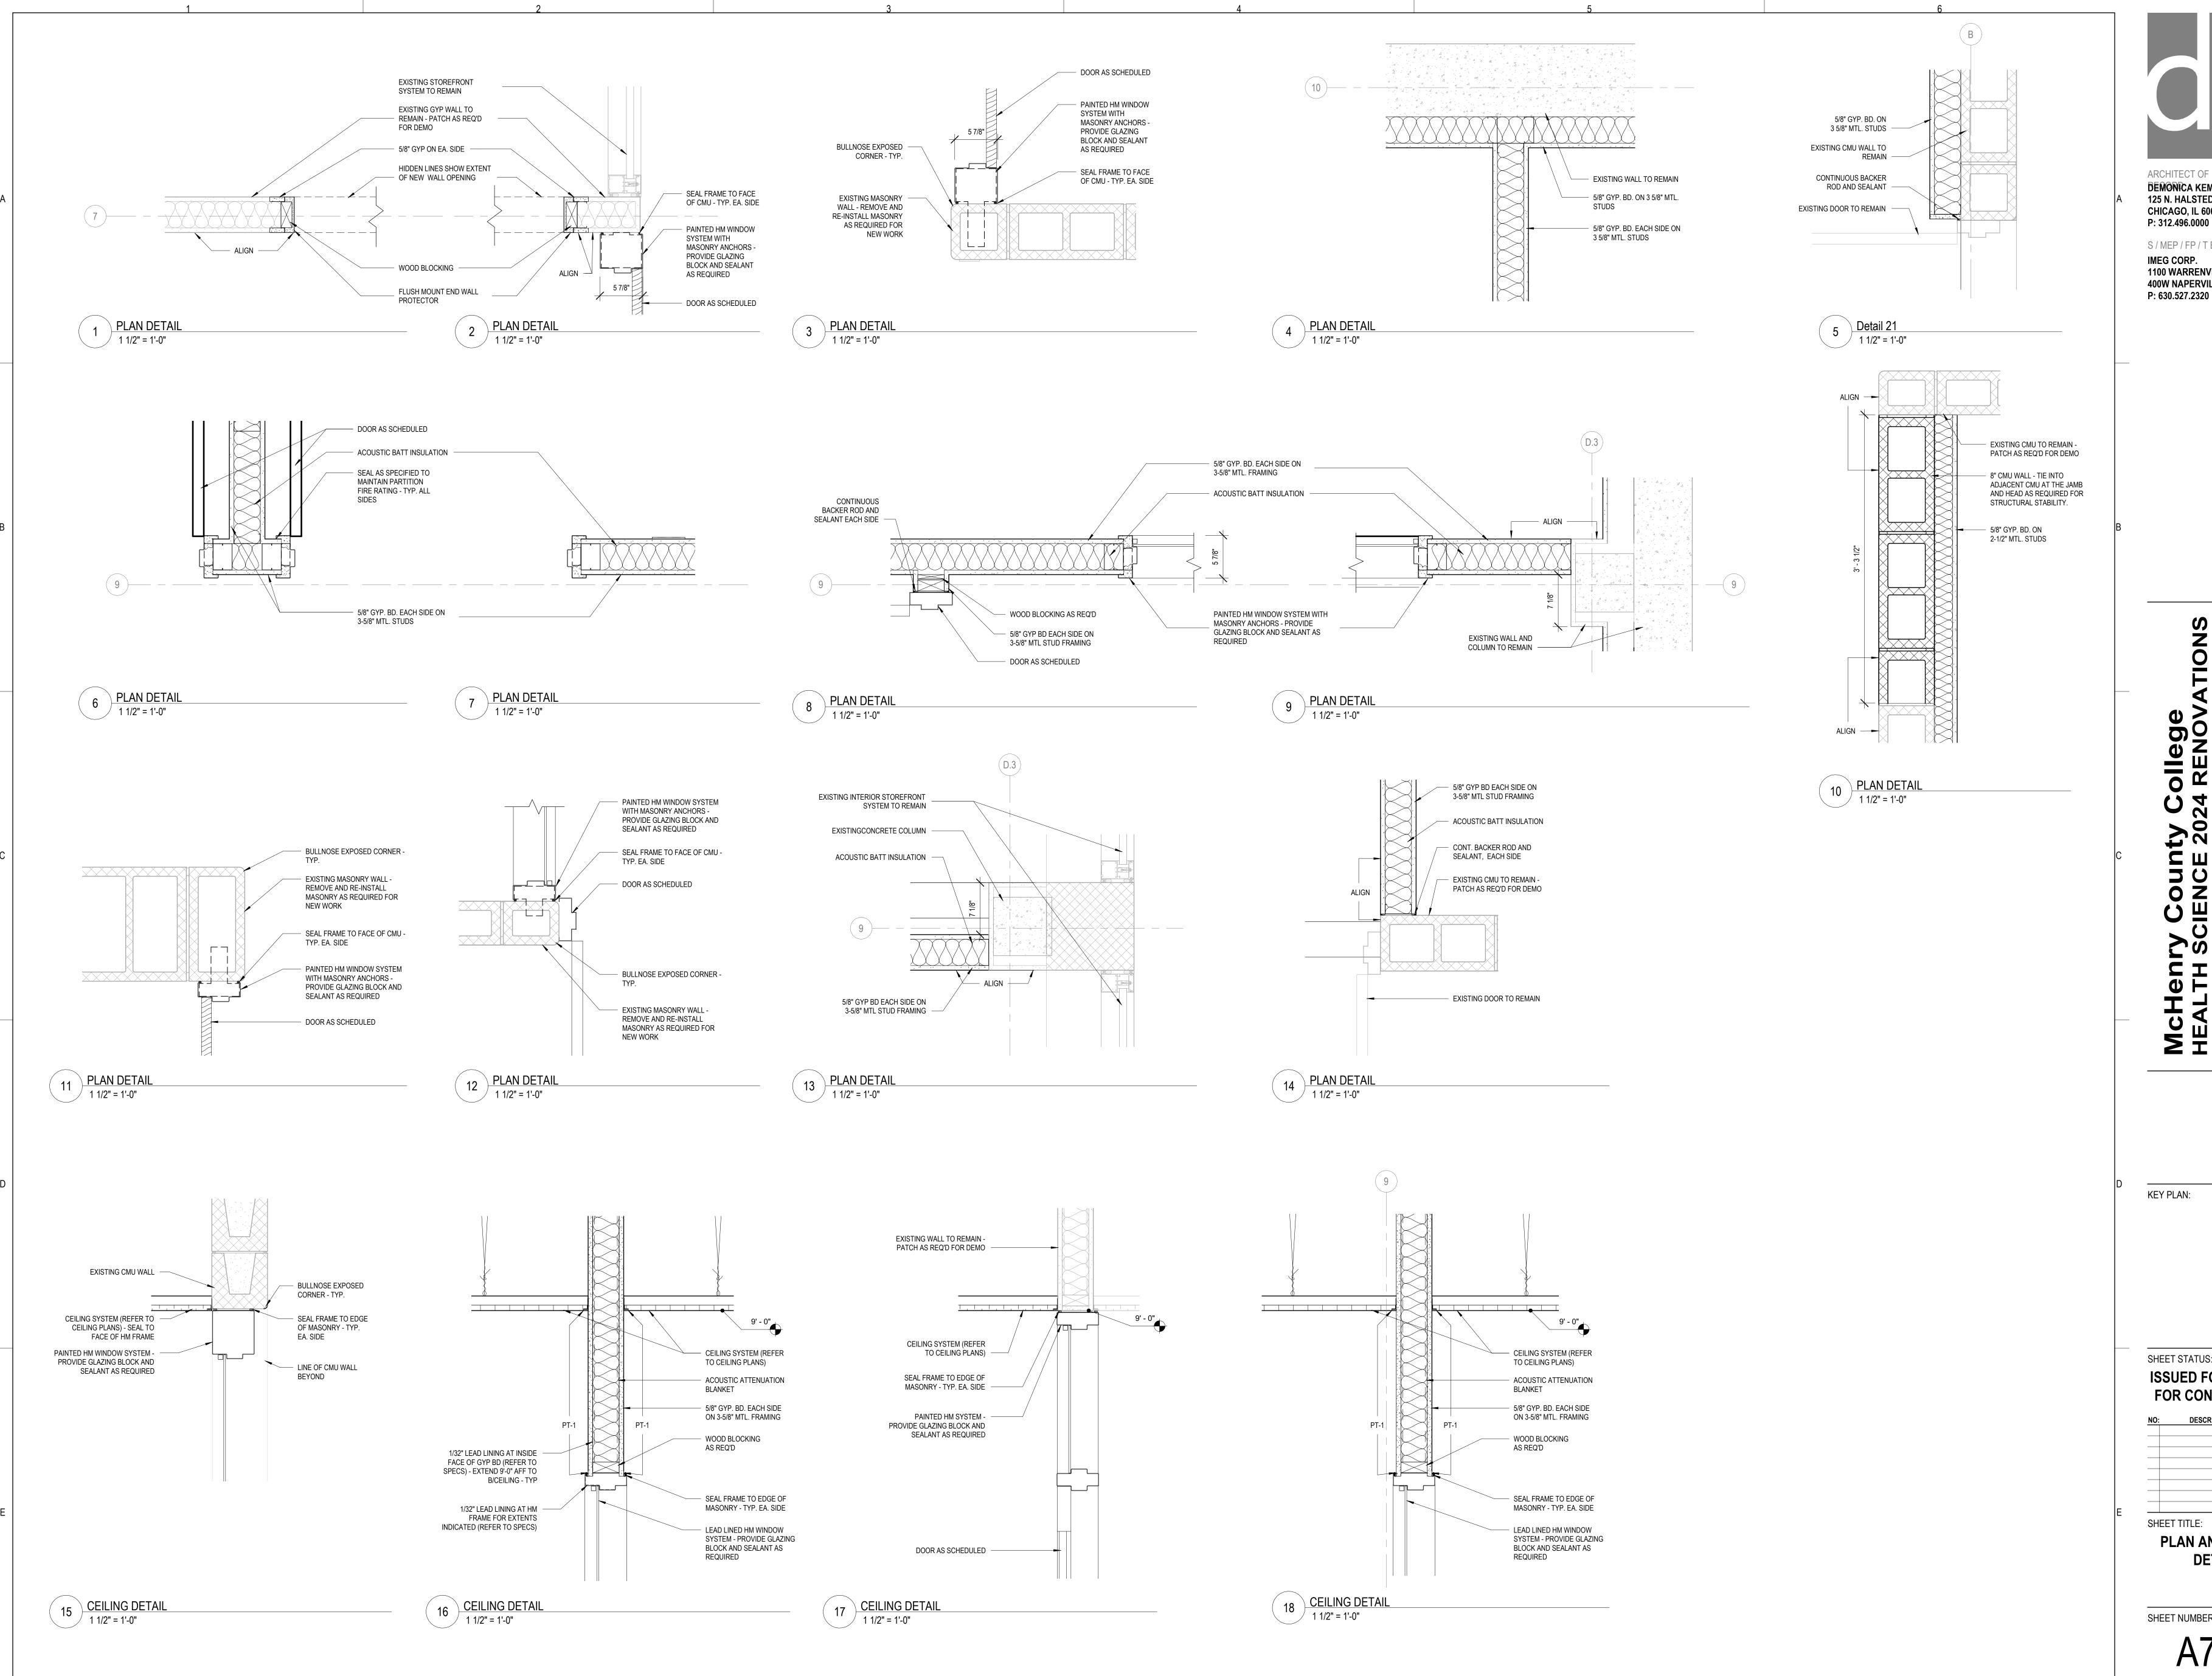
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SHEET TITLE: REFLECTED CEILING **PLANS**

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Count

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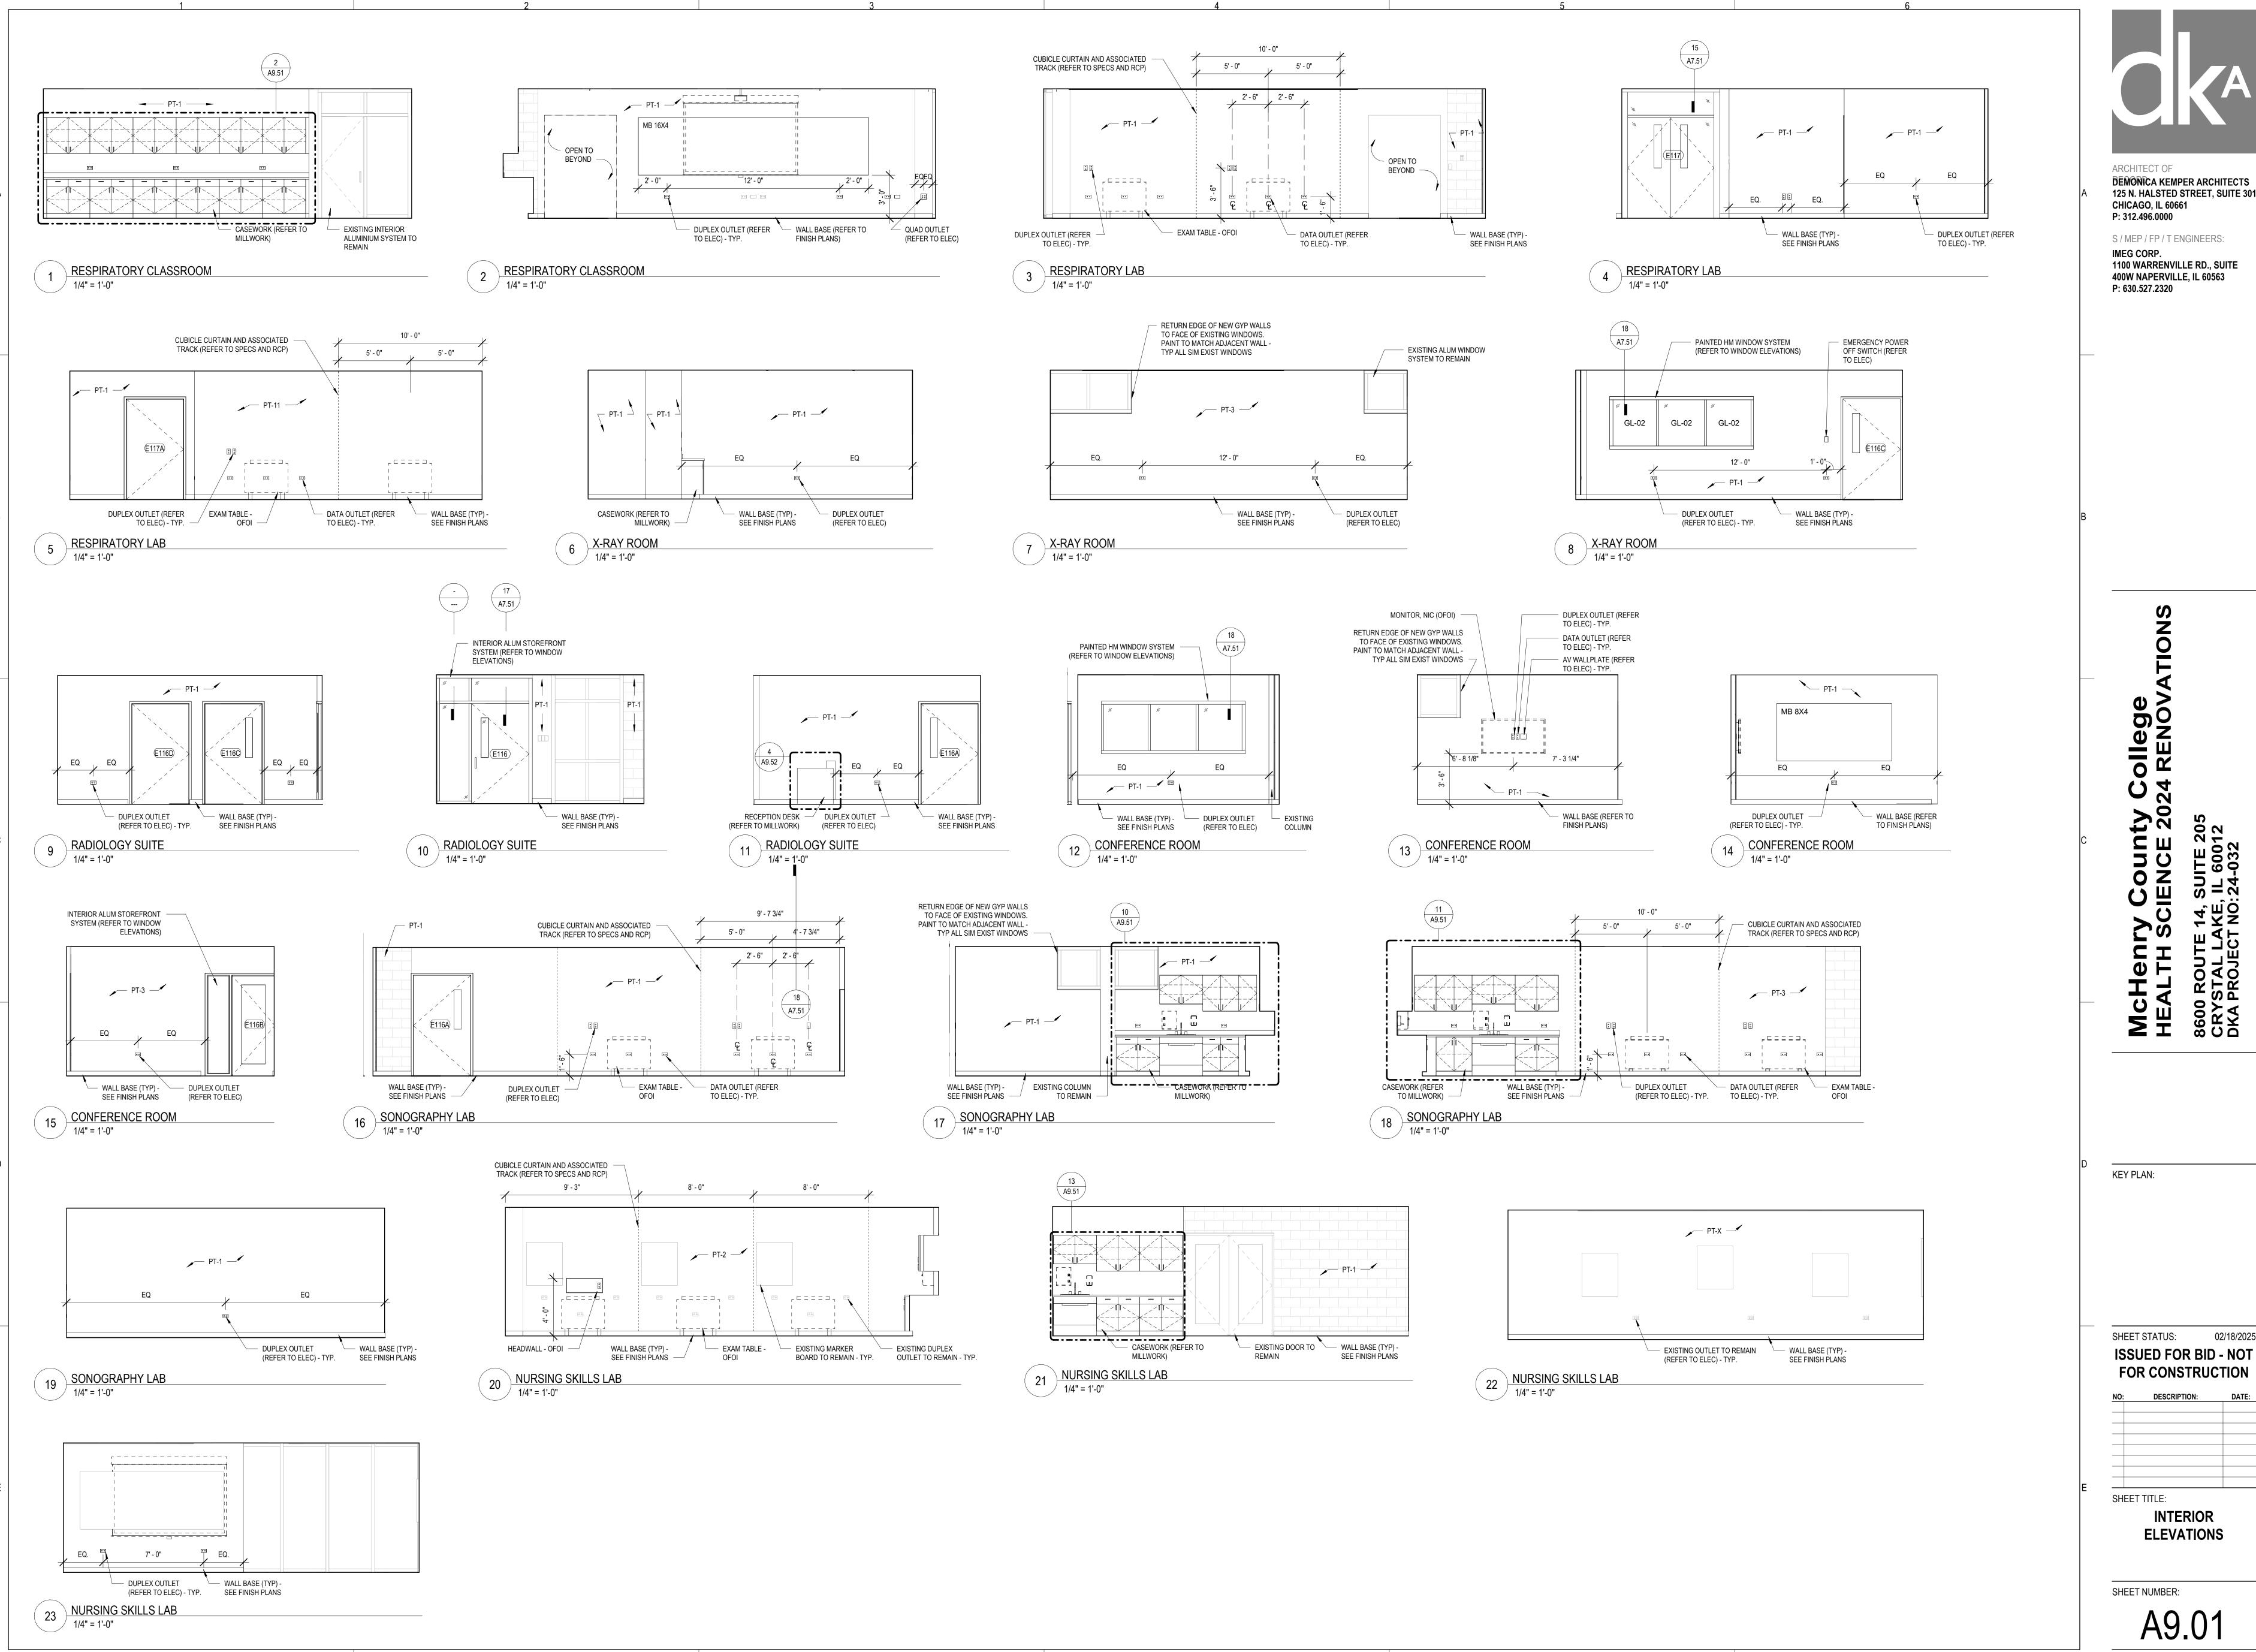
SHEET STATUS: 02/18/2025 **ISSUED FOR BID - NOT** FOR CONSTRUCTION

NO: DESCRIPTION: DATE:

SHEET TITLE: **PLAN AND CEILING DETAILS**

SHEET NUMBER:

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McHenry County College HEALTH SCIENCE 2024 RENOV

KEY PLAN:

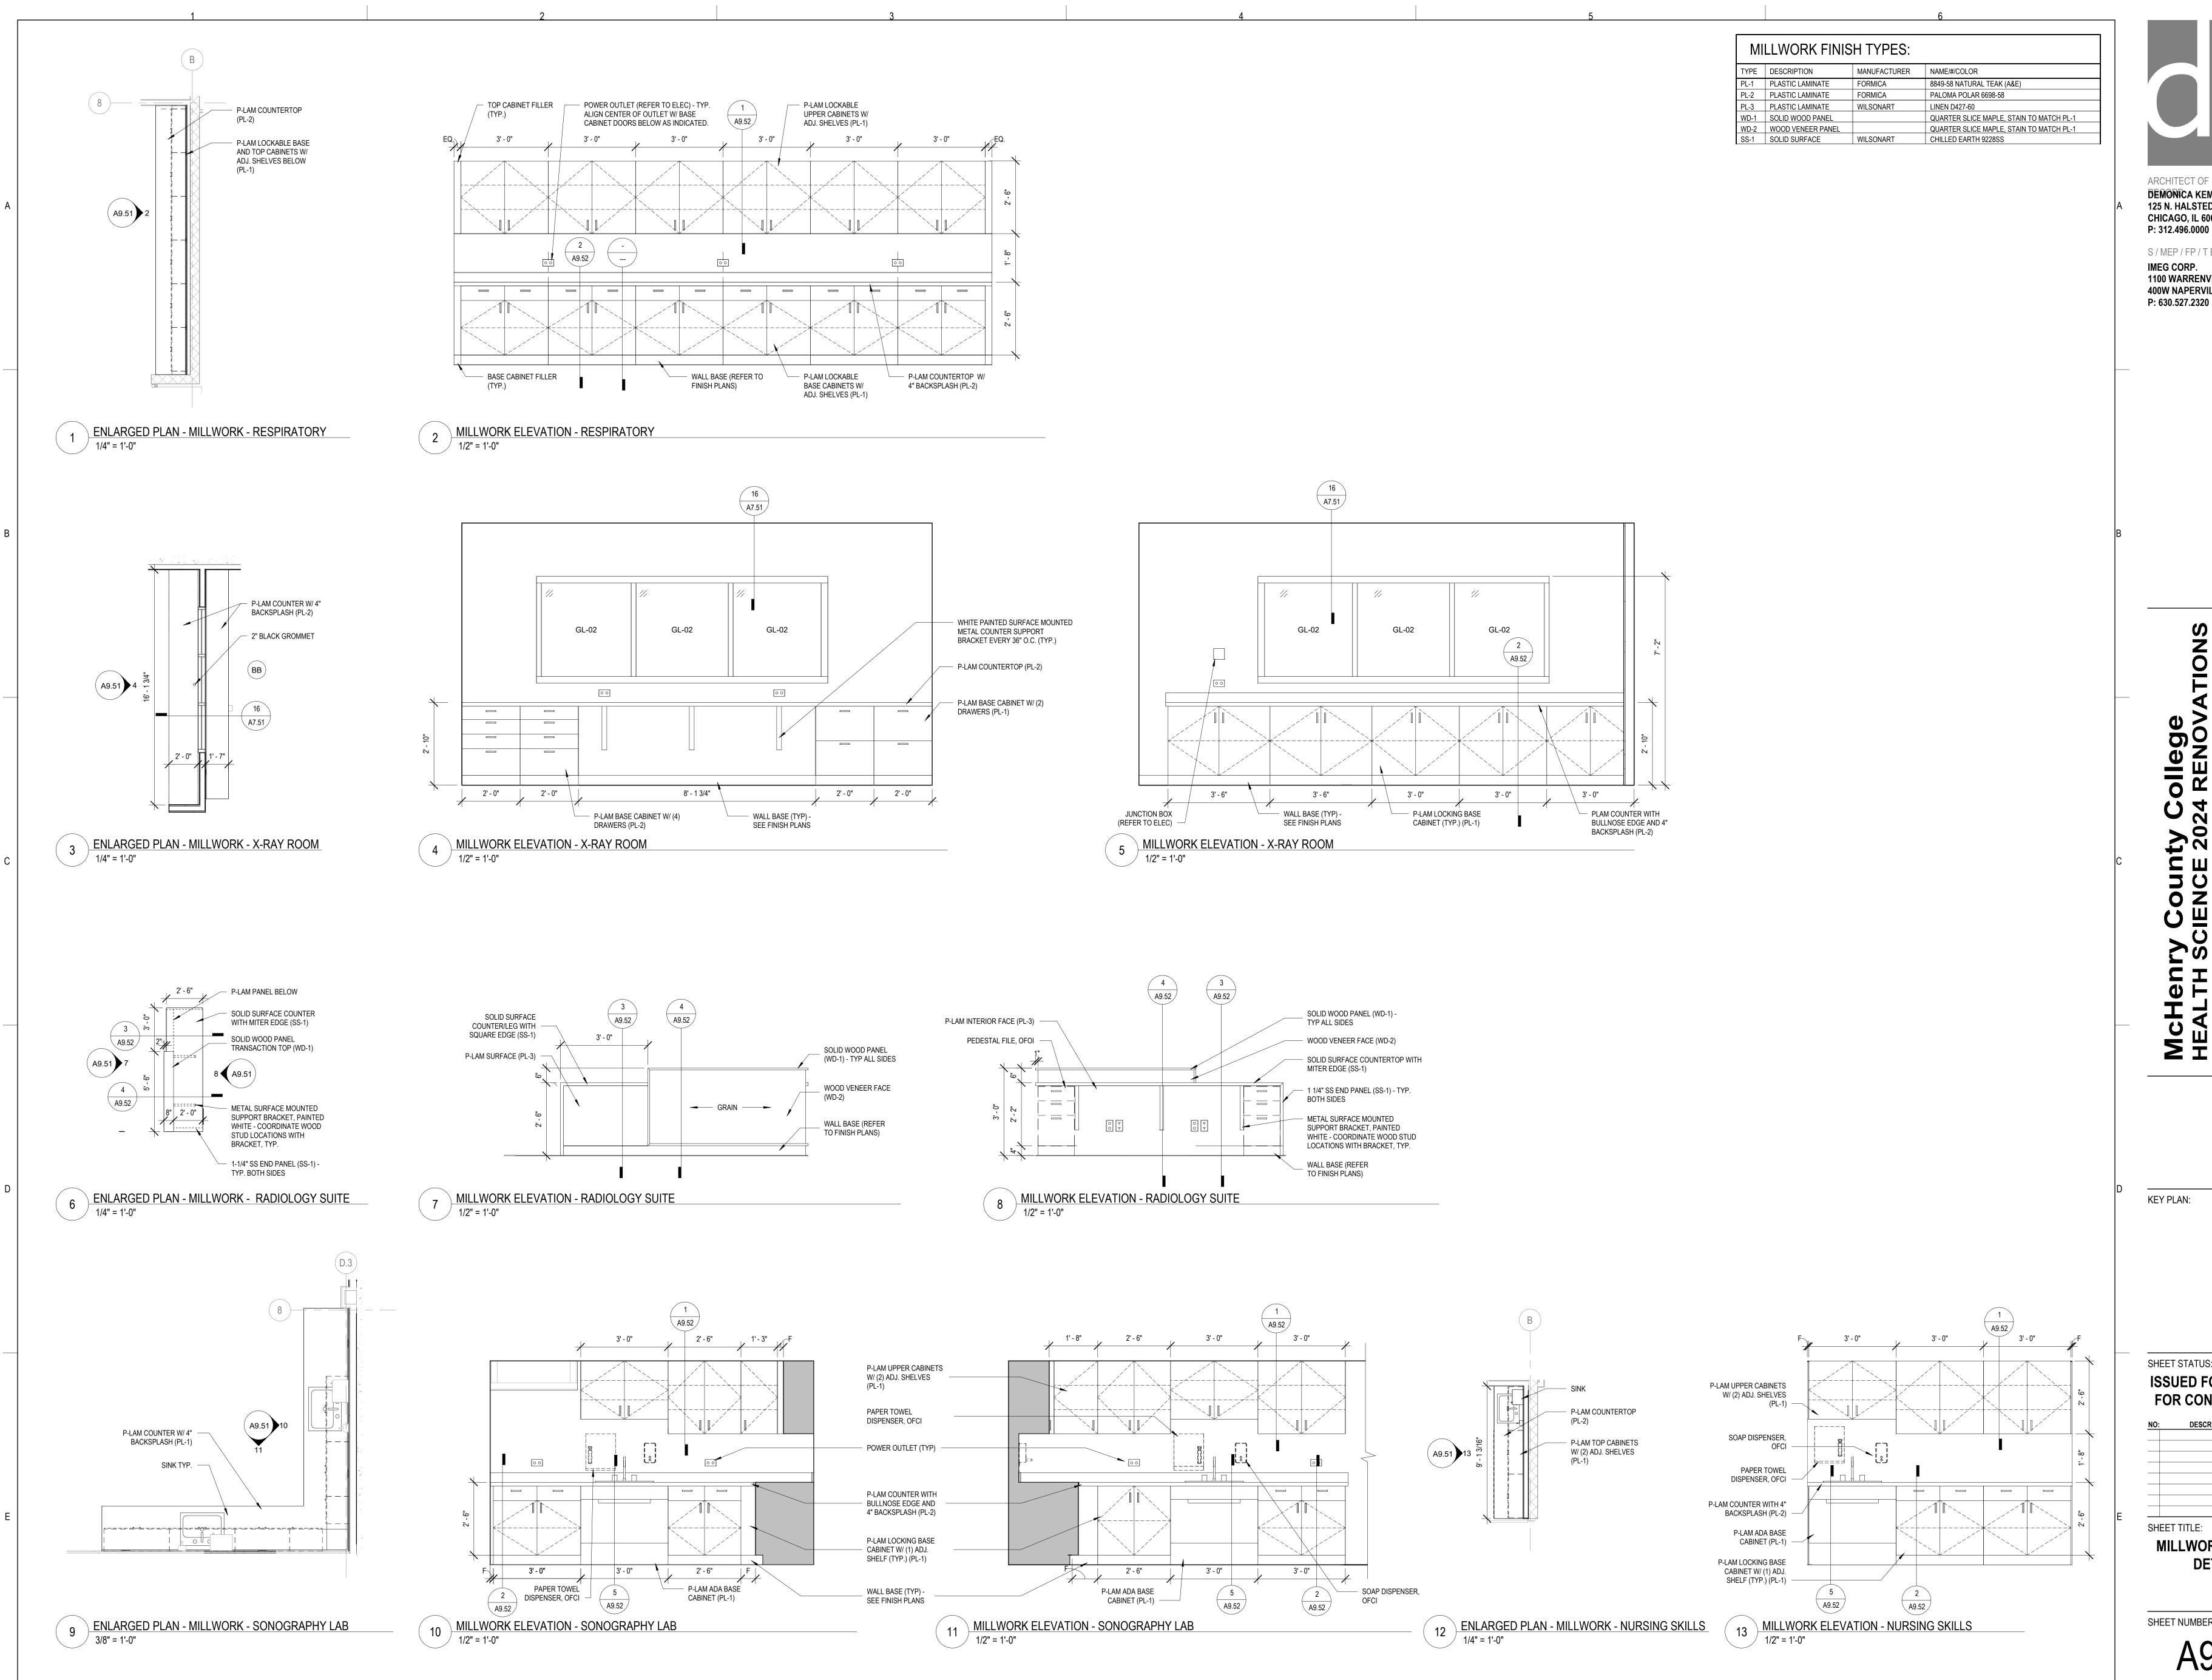
SHEET STATUS: **ISSUED FOR BID - NOT** FOR CONSTRUCTION

NO: DESCRIPTION: DATE:

SHEET TITLE: **ELEVATIONS**

SHEET NUMBER:

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KEY PLAN:

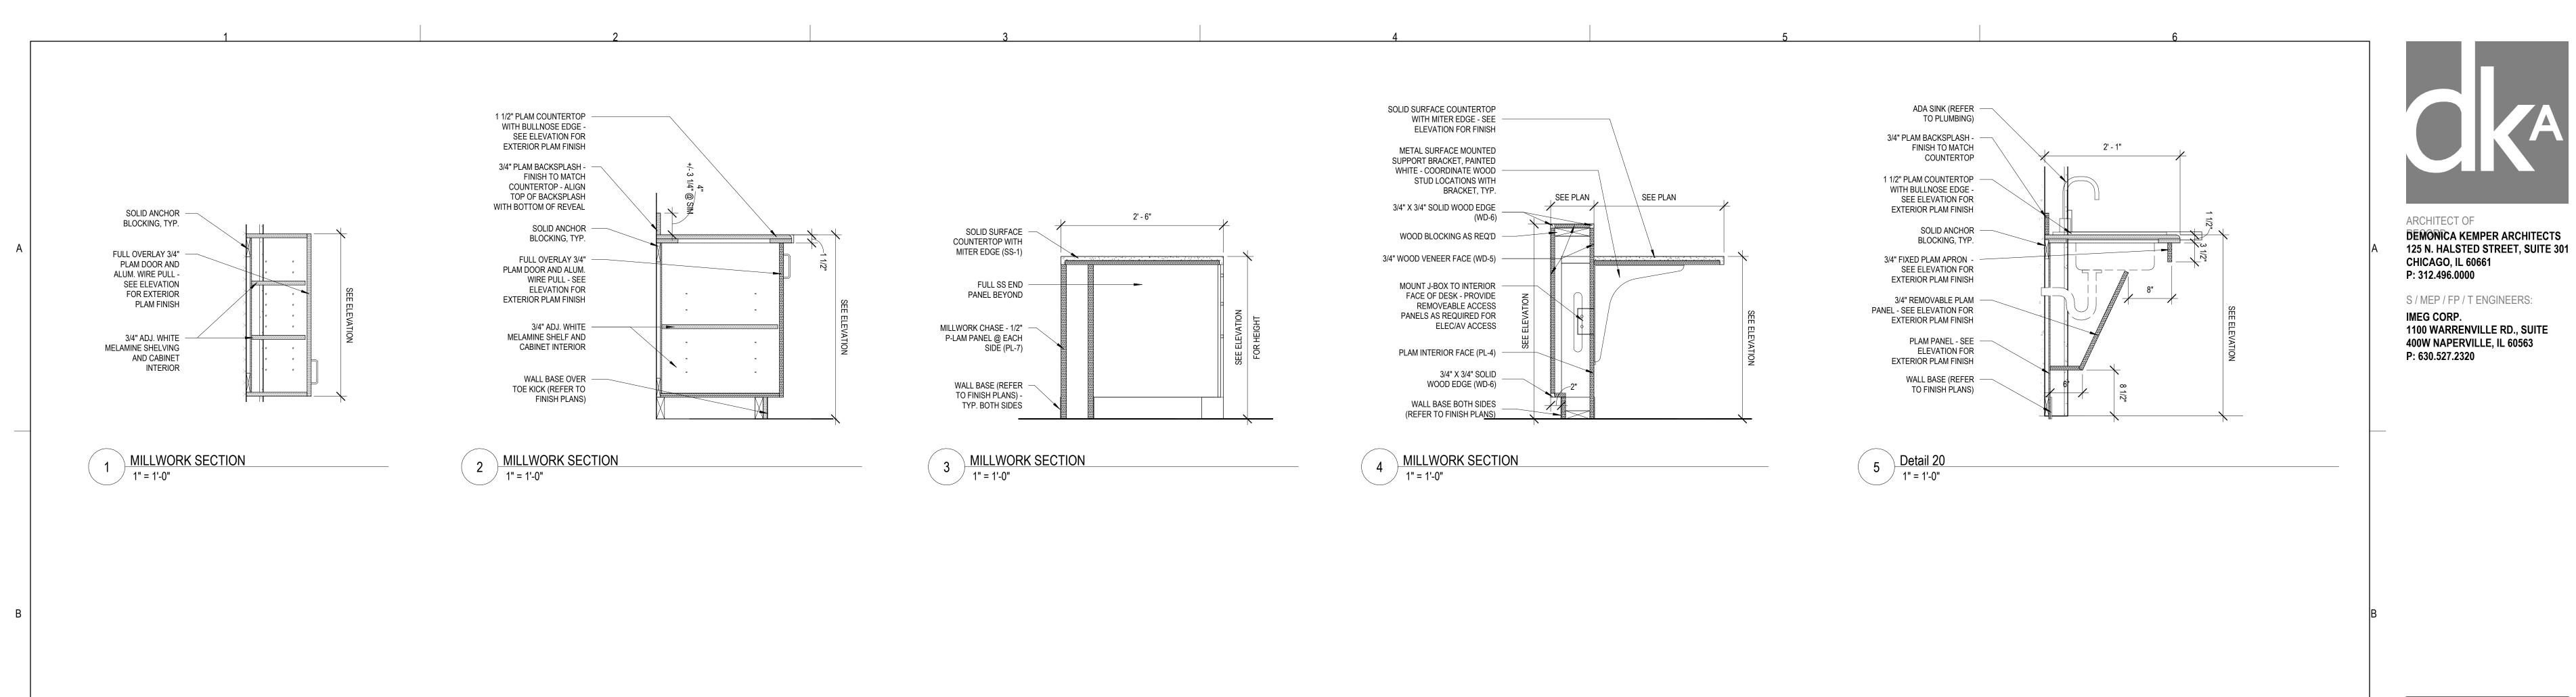
SHEET STATUS: **ISSUED FOR BID - NOT** FOR CONSTRUCTION DESCRIPTION: DATE:

SHEET TITLE: MILLWORK PLANS & **DETAILS**

SHEET NUMBER:

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2/18/2025 1:10:19 PM

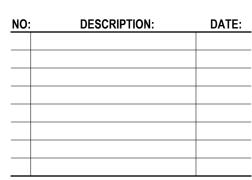


y County College
SCIENCE 2024 RENOVATIONS
14, SUITE 205

REALIN SCIENCE ZUZ
8600 ROUTE 14, SUITE 205
CRYSTAL LAKE, IL 60012
DKA PROJECT NO: 24-032

KEY PLAN:

SHEET STATUS: 02/18/2025
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SHEET TITLE:
MILLWORK SECTIONS

SHEET NUMBER:

A9.52

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	DOOR AND FRAME SCHEDULE											
					DOO		WINE OUT ILL	OLL				
			DOOR					FRAME				
				FIRE								
NUMBER	ROOM NAME	WIDTH	HEIGHT	RATING	MATERIAL	ELEV	GLAZING TYPE	MATERIAL	ELEV	GLAZING TYPE	HARDWARE SET	REMARKS
				-		-	-		-	-		
E116	RADIOLOGY SUITE	4' - 0"	7' - 0"	-	WD	NHG	GL-01	HM	-	GL-02		HM STOREFRONT SYSTEM (REFER TO ELEV)
E116A	SONOGRAPHY LAB	4' - 0"	7' - 0"	-	WD	NHG	GL-01	HM	A	-		
E116B	CONFERENCE ROOM	3' - 0"	7' - 0"	-	WD	FG	GL-02	HM	В	GL-02		
E116C	X-RAY ROOM	4' - 0"	7' - 0"	-	WD	NHG	GL-01	HM	A	-		
E116D	STORAGE	4' - 0"	7' - 0"	-	WD	FL	-	HM	A	-		
E117	RESPIRATORY LAB	6' - 0"	7' - 0"	-	WD	NHG	GL-01	HM	-	GL-02		HM STOREFRONT SYSTEM (REFER TO ELEV)
E117A	RESPIRATORY LAB STORAGE	4' - 0"	7' - 0"	-	WD	FL	-	HM	A	-		
E218A	OFFICES	3' - 0"	7' - 0"	-	WD	FG	GL-02	HM	A	-		

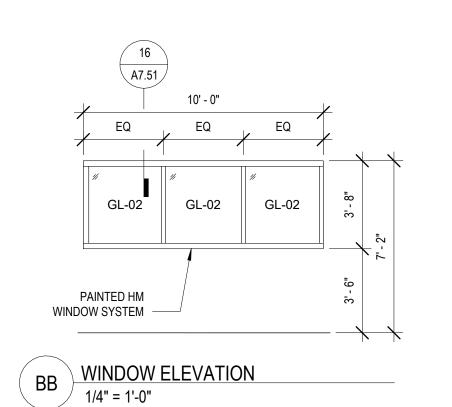
GLAZING SCHEDULE GL-01 1/4" CLEAR TEMPERED GLASS
GL-02 1/2" CLEAR TEMPERED GLASS

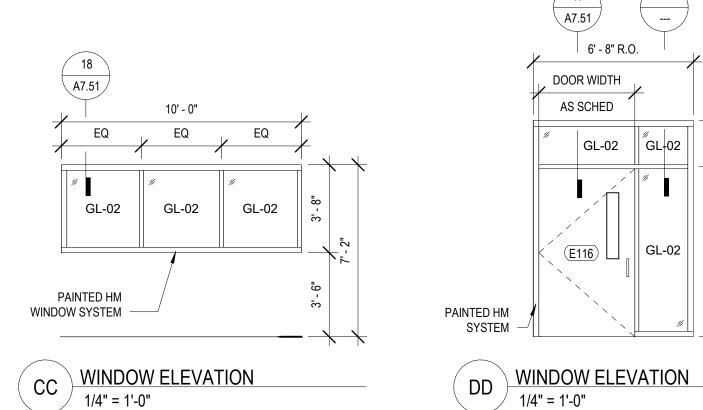
15 A7.51

AA WINDOW ELEVATION
1/4" = 1'-0"

PAINTED HM

SYSTEM





⁾ 1/4" = 1'-0"

17 A7.51

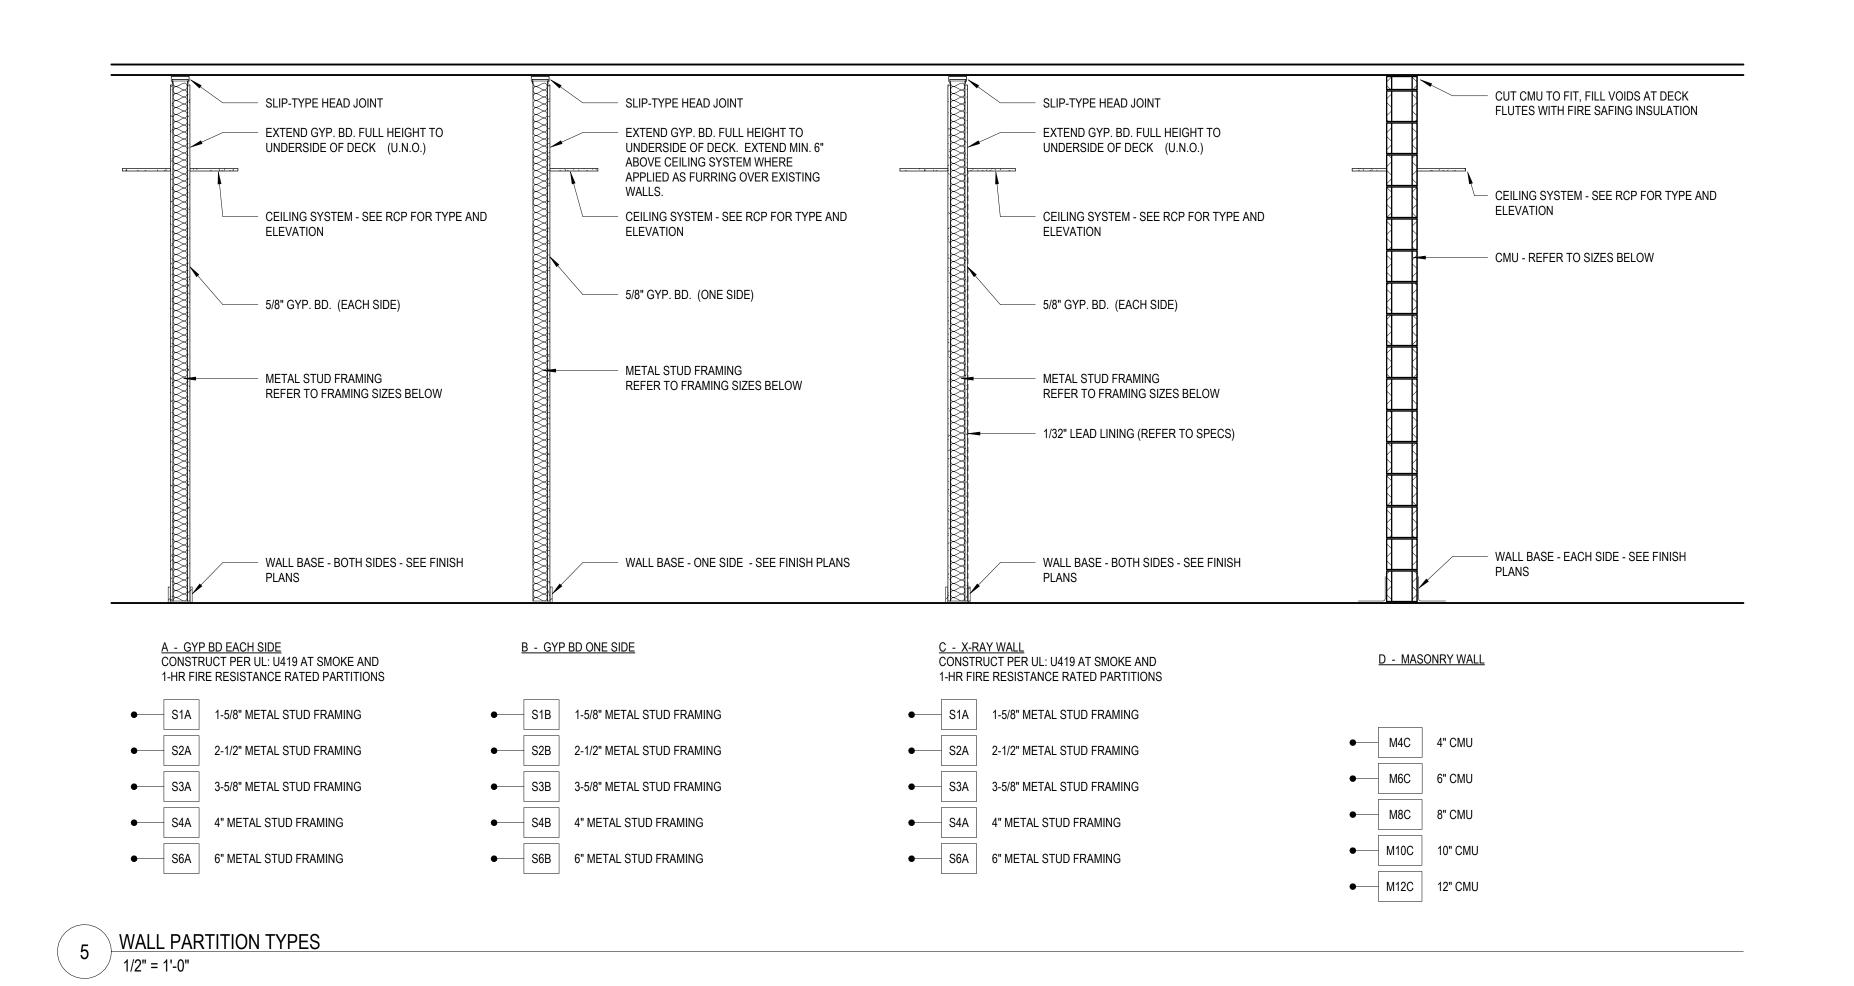
DOOR WIDTH

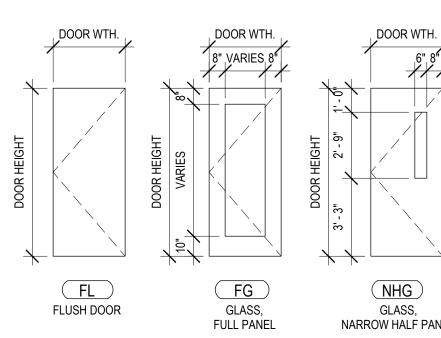
AS SCHED

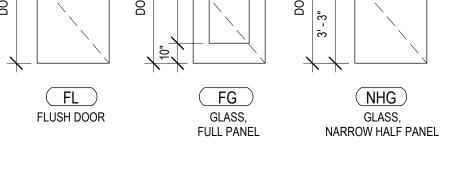
6' - 8" R.O.

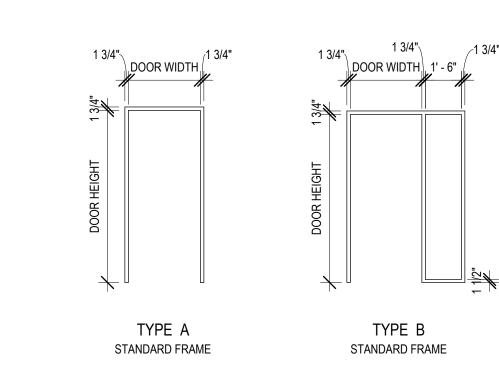
GL-02 | GL-02 | №

GL-02

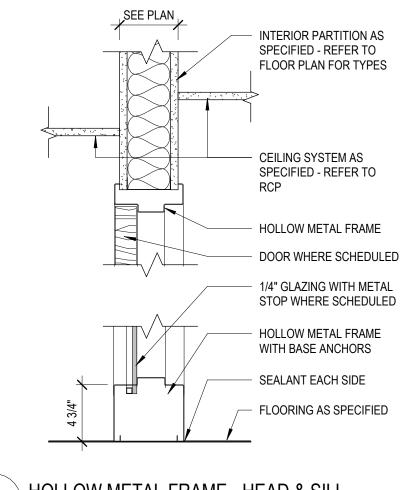








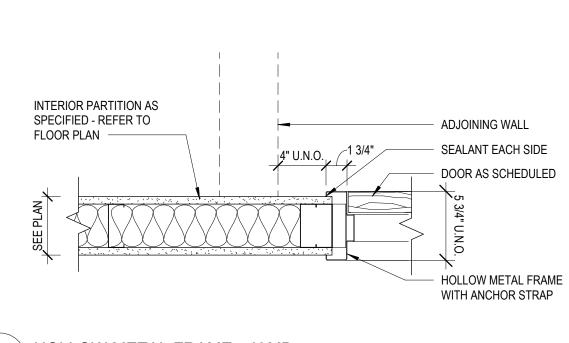




DOOR ELEVATIONS

1/4" = 1'-0"





4 HOLLOW METAL FRAME - JAMB
1 1/2" = 1'-0"

ARCHITECT OF DEMONICA KEMPER ARCHITECTS 125 N. HALSTED STREET, SUITE 301 **CHICAGO, IL 60661** P: 312.496.0000

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> County SIENCE 202 SC

KEY PLAN:

SHEET STATUS: 02/18/2025 **ISSUED FOR BID - NOT** FOR CONSTRUCTION

NO: DESCRIPTION: DATE: SHEET TITLE:

DOOR SCHEDULE, WINDOW ELEV, & **WALL TYPES**

SHEET NUMBER:

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FINISH PLAN SYMBOLS LEGEND:

 $oxed{X}$ WALL FINISH TYPE $oxed{X}$ WALL BASE TYPE $oxed{X}$ FLOOR FINISH TYPE

FINISH PLAN GENERAL NOTES:

- PAINT ALL EXPOSED CONDUIT, DUCTWORK, PIPING, ETC. IN ALL FINISHED SPACES. REFER TO INTERIOR FINISH PLANS AND REFLECTED CEILING PLANS
- FOR CLARIFICATIONS.
- PAINT ALL EXPOSED METAL ON EXTERIOR INCLUDING, BUT NOT LIMITED TO: CONDUIT, PIPING, FLASHING, MECHANICAL FLUES AND DUCTS, AND HOLLOW METAL FRAMES AND DOORS.
- B. PROVIDE CEMENTITIOUS SELF-LEVELING UNDERLAYMENT AT REMOVAL OF EXISTING FLOOR DRAINS AS REQUIRED TO PROVIDE A LEVEL SUBSTRATE FOR NEW FLOOR FINISH.
- 4. ALL FINISHES ARE MONUMENTAL PER ROOM UNLESS NOTED OTHERWISE. 5. HOLLOW METAL DOORS AND FRAMES TO BE PAINTED PT-4 UNLESS NOTED
- OTHERWISE. 6. AT ALL LOCATIONS WHERE CASEWORK IS TO BE INSTALLED, THE SUBSEQUENT BASE TYPE SPECIFIED FOR EACH ROOM SHALL BE INSTALLED OVER CASEWORK
- TOE KICKS UNLESS NOTED OTHERWISE. REFER TO FLOOR PLANS FOR CASEWORK LOCATIONS.
- '. PAINT ALL GYP. BD. CEILINGS PT-1 UNLESS NOTED OTHERWISE. 8. ALL CARPET TILE TO BE INSTALLED QUARTER TURNED UNLESS SPECIFIED
- 9. PAINT INFILL TO MATCH ADJACENT WALL FINISH COORDINATE WITH OWNER FOR
- REQUIRED PAINT COLOR FOR COLOR MATCH. 10. PROVIDE BASE TO MATCH ADJACENT WALLS - COORDINATE WITH OWNER FOR BASE COLOR SELECTION.

WA	ALL FINISH TY	PES:	X		
TYPE	DESCRIPTION	MANUFACTURER	NAME/#/COLOR		
PT-1	GENERAL PAINT	SHERWIN WILLIAMS SUPERPAINT, SATIN FINISH	COLOR MATCH BENJAMIN MOORE 2126-70 CHAULK WHIT		
PT-2	ACCENT PAINT	SHERWIN WILLIAMS SUPERPAINT, SATIN FINISH	COLOR MATCH BENJAMIN MOORE 757 BAYVILLE BLUE		
PT-3	ACCENT PAINT	SHERWIN WILLIAMS SUPERPAINT, SATIN FINISH	COLOR MATCH BENJAMIN MOORE 254-5 BLUE CALYPSO		
PT-4	HM PAINT	SHERWIN WILLIAMS SUPERPAINT, SATIN FINISH	COLOR MATCH TO EXISTING DARK BROWN; COORD WITH OWNER FOR COLOR MATCH CODE		

WALL BASE TYPES: MANUFACTURER NAME/#/COLOR TYPE DESCRIPTION RB-1 4"H COVE RUBBER BASE JOHNSONITE 63 BURNT UMBER RB-2 4"H STRAIGHT RUBBER BASE JOHNSONITE 63 BURNT UMBER

FL	OOR FINISH	X	
TYPE	DESCRIPTION	MANUFACTURER	NAME/#/COLOR
CPT-1	CARPET TILE	PATCRAFT	10467 SLOPE SIZE 12" X 48" COLOR: 00599 POINT INSTALL: MONOLITHIC
SV-1	SHEET VINYL	TEKNOFLOR	NAME: TIMBERSCAPES COLOR: 51025 BEECH

FLO	OR TRANSITION	TRANS-X —	
TYPE	DESCRIPTION	MANUFACTURER	NAME/#/COLOR
TRANS-1	1/8" TO 1/4"	JOHNSONITE	SLT-63-A; BURNT UMBER
TRANS-2	1/8" TO 1/8"	JOHNSONITE	STL-63-B; BURNT UMBER

CO	RNER GUARI	CG-X	
TYPE	DESCRIPTION	MANUFACTURER	NAME/#/COLOR
CG-1	WHITE	CS GROUP	VA VARIES, 3/4" X 3/4" ADHESIVE APPLIED, FULL HEIGHT, COLOR: WHITE 949
CG-2	WHITE	INPRO	FLUSH MOUNT END WALL PROTECTOR - INPRO, COLOR: WHITE

ARCHITECT OF DEMONICA KEMPER ARCHITECTS 125 N. HALSTED STREET, SUITE 301

CHICAGO, IL 60661

P: 312.496.0000

P: 630.527.2320

S / MEP / FP / T ENGINEERS: IMEG CORP. 1100 WARRENVILLE RD., SUITE 400W NAPERVILLE, IL 60563

KEY PLAN:

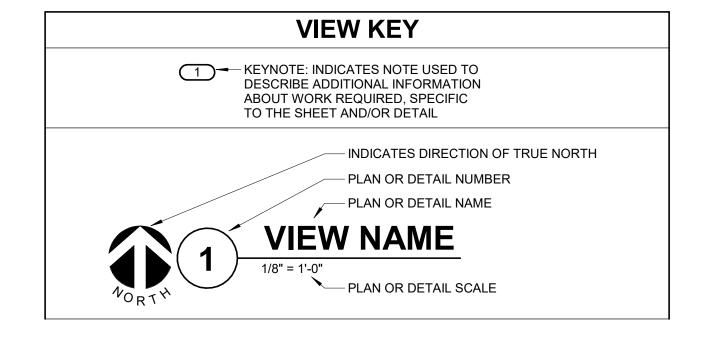
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FINISH PLAN

SHEET NUMBER:

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MECHANICAL SYMBOL LIST							
	NOT ALL SYMBOLS MAY APPLY.						
SYMBOL:	DESCRIPTION:						
HWR	HEATING WATER RETURN						
HWS	HEATING WATER SUPPLY						
 3	PIPE CAP						
	PIPE DOWN						
o	PIPE UP OR UP/DOWN						
──	SHUTOFF VALVE NORMALLY OPEN						
<u>\$</u>	BALANCING VALVE (NUMBER INDICATES GPM)						
── \$──	CONTROL VALVE (TWO-WAY)						
	SOLENOID VALVE						
	CHECK VALVE						
	FLEXIBLE DUCT						
	MANUAL VOLUME DAMPER						
	DUCT CAP						
	DUCT DOWN						
	DUCT UP						
\boxtimes	SUPPLY/OUTSIDE AIR DUCT SECTION						
	RETURN AIR DUCT SECTION						
	EXHAUST/RELIEF AIR DUCT SECTION						
<u>CD-1</u> 6/115	AIR TERMINAL PROPERTIES SYMBOL NECK SIZE/CFM						
	FAN POWERED TERMINAL AIR BOX w/REHEAT COIL (REFER TO SCHEDULE)						
T	THERMOSTAT/SENSOR						

MECHANICAL ABBREVIATION KEY

ABBR:	DESCRIPTION:
E	EXISTING
RA	RETURN/RELIEF AIR
SA	SUPPLY AIR
TD	TRANSFER DUCT
TYP	TYPICAL

TAB PRE-DEMOLITION NOTES:

- 1. BEFORE ANY DEMOLITION WORK IS BEGUN A COMPLETE AIR BALANCE TEST SHALL BE PERFORMED BY THE TESTING, ADJUSTING AND BALANCING (TAB) CONTRACTOR ON EXISTING AIR HANDLERS AND EXHAUST FANS SERVING THE AREAS AFFECTED BY CONSTRUCTION. EQUIPMENT TO BE DEMOLISHED DOES NOT REQUIRE TESTING. PROVIDE AIR BALANCE TESTING ONLY ON EQUIPMENT THAT WILL CONTINUE TO BE USED TO SERVE RENOVATED AREAS AFTER THE CONSTRUCTION PHASE IS COMPLETED.
- TAB CONTRACTOR SHALL COMPILE AND SUBMIT FOUR COPIES OF THE FINAL PRE-DEMOLITION REPORT WITHIN 10 WORKING DAYS AFTER THE FIELD MEASUREMENTS ARE COMPLETED. FINAL TAB REPORT SHALL BE SUBMITTED FOR REVIEW TO THE ARCHITECT/ENGINEER. TESTING SHALL INCLUDE ALL ITEMS REQUIRED IN THE SPECIFICATIONS.
- 3. BALANCING CONTRACTOR SHALL PRE-BALANCE ALL EXISTING SYSTEMS TO REMAIN PER SPECIFICATION SECTION 23 05 93. BALANCE READINGS WILL BE REQUIRED AT AIR OUTLETS AND DUCT TRAVERSES TO VERIFY EXISTING AIRFLOW TO UNAFFECTED SPACES.

TAB POST-CONSTRUCTION NOTES:

- AFTER CONSTRUCTION ACTIVITIES ARE COMPLETE, TESTING, ADJUSTING (TAB) AND BALANCING CONTRACTOR SHALL REBALANCE AIR HANDLING UNITS AND EXHAUST FANS AS REQUIRED TO ACHIEVE THE NEW AIRFLOW VALUES SHOWN ON THE CONSTRUCTION DRAWINGS.
- TAB CONTRACTOR SHALL COMPILE AND SUBMIT COPIES OF THE FINAL POST-CONSTRUCTION TAB REPORT AS REQUIRED BY SECTION 23 05 93.
 THE FINAL POST CONSTRUCTION REPORT SHALL INCLUDE ALL ITEMS REQUIRED IN THE SPECIFICATIONS.

MECHANICAL RENOVATION NOTES:

THESE NOTES APPLY TO ALL MECHANICAL SHEETS AND TRADES, INCLUDING BUT NOT LIMITED

EXISTING CONDITIONS ARE SHOWN BASED ON INFORMATION OBTAINED FROM FIELD SURVEYS, EXISTING BUILDING DOCUMENTS, AND STAFF. VERIFY EXISTING CONDITIONS AND REPORT ANY CONFLICTS BEFORE PROCEEDING.

TO FIRE PROTECTION, PLUMBING, VENTILATION AND PIPING.

- NOT ALL EXISTING DUCTWORK AND PIPING IS SHOWN. VERIFY EXISTING CONDITIONS
 BEFORE STARTING WORK. NOTIFY ENGINEER OF ANY CONFLICTS WITH NEW WORK.
 FIELD VERIFY THE AVAILABLE CLEARANCES FOR DUCTWORK AND PIPING BEFORE
 FABRICATION. RISES AND DROPS MAY BE NECESSARY BECAUSE OF EXISTING FIELD
- CONDITIONS.

 4. THE CONSTRUCTION MANAGER SHALL FIELD VERIFY ACCESSIBILITY TO THE AREA OF THEIR WORK AND SHALL NOTIFY THE ARCHITECT/ENGINEER PRIOR TO BIDDING IF OTHER UTILITIES ARE REQUIRED TO BE REMOVED OR RELOCATED TO ALLOW ACCESS TO THEIR AREA OF WORK.
- AREA OF WORK.

 5. EACH CONTRACTOR SHALL CUT AND PATCH ROOFS, WALLS, AND FLOORS ASSOCIATED WITH THEIR WORK.

 6. THE CONSTRUCTION MANAGER IS RESPONSIBLE FOR REMOVAL AND REPLACEMENT OF
- CEILINGS, CEILING TILES, AND CEILING GRIDS ASSOCIATED WITH AREAS OF WORK BY ALL CONTRACTORS.

 7. WHERE EXISTING MECHANICAL SYSTEMS ARE LOCATED IN AREAS THAT CONFLICT WITH NEW EQUIPMENT, PIPING, OR DUCTWORK TO BE INSTALLED, EACH CONTRACTOR SHALL EITHER ARRANGE NEW EQUIPMENT, PIPING, OR DUCTWORK IN SUCH A FASHION THAT IT
- DOES NOT CONFLICT WITH EXISTING SYSTEMS, OR REWORK EXISTING MECHANICAL SYSTEMS TO ALLOW FOR INSTALLATION OF NEW EQUIPMENT, PIPING, OR DUCTWORK.

 8. PROVIDE TEMPORARY CONNECTIONS TO MAINTAIN EXISTING SYSTEMS IN SERVICE DURING CONSTRUCTION. MAINTAIN ACCESS TO EXISTING MECHANICAL INSTALLATIONS THAT
- REMAIN ACTIVE.

 9. OBTAIN PERMISSION FROM OWNER BEFORE SHUTTING DOWN ANY SYSTEM FOR ANY REASON. MAINTAIN SERVICE TO ALL COMPONENTS THAT ARE TO REMAIN UNTIL NEW SYSTEMS ARE INSTALLED.
- 10. DISCONNECT AND REMOVE MECHANICAL DEVICES AND EQUIPMENT SERVING EQUIPMENT THAT HAS BEEN REMOVED.

VENTILATION GENERAL NOTES:

- UNLESS NOTED OTHERWISE, THE SIZE OF EACH BRANCH DUCT TO AN AIR TERMINAL SHALL MATCH THE INLET SIZE.
 ALIGN TEMPERATURE SENSORS WITH LIGHT SWITCHES AND WHEN IN CLOSE PROXIMITY TO EACH OTHER.
- PROVIDE ACCESS DOORS AT ALL DUCT MOUNTED EQUIPMENT.
 EXISTING AIR INLET AND OUTLET CFM SHOWN ON DRAWINGS ARE FROM EXISTING DRAWINGS, AND ARE FOR REFERENCE ONLY. CONTRACTOR SHALL USE PRE-BALANCE
- VALUES, AND NOT EXISTING CFM SHOWN ON DRAWINGS.

 5. CONTRACTOR MAY REUSE PORTIONS OF EXISTING DUCT PROVIDED SIZES AND PRESSURE CLASSES ARE CORRECT, DUCT IS THOROUGHLY CLEANED AND FREE OF DEFECTS, AND ALL TRANSVERSE JOINTS, LONGITUDINAL SEAMS, AND DUCT WALL PENETRATIONS ARE SEALED
- 6. CLEAN ALL SUPPLY, RETURN, AND EXHAUST DUCTWORK UPSTREAM OF ALL NEW CONNECTIONS PER SPECIFICATION SECTION 23 31 00.

AS SPECIFIED FOR NEW DUCTWORK.

MECHANICAL GENERAL NOTES:

THESE NOTES APPLY TO ALL MECHANICAL SHEETS AND TRADES, INCLUDING BUT NOT LIMITED TO, FIRE PROTECTION, PLUMBING, VENTILATION, PIPING AND TEMPERATURE CONTROL.

- 1. DRAWINGS SHOWING LOCATIONS OF EQUIPMENT, DUCTWORK, PIPING, ETC. ARE DIAGRAMMATIC AND MAY NOT ALWAYS REFLECT EXACT INSTALLATION CONDITIONS. DRAWINGS SHOW THE GENERAL ARRANGEMENT OF DUCTWORK, PIPING, EQUIPMENT, ETC., AND MAY NOT INCLUDE ALL OFFSETS AND FITTINGS REQUIRED FOR COMPLETE INSTALLATION. THE DRAWINGS SHALL BE FOLLOWED AS CLOSELY AS ACTUAL BUILDING
- INSTALLATION. THE DRAWINGS SHALL BE FOLLOWED AS CLOSELY AS ACTUAL BUILDING CONSTRUCTION AND THE WORK OF OTHERS WILL PERMIT.
 2. DO NOT SCALE DRAWINGS. VERIFY ALL DIMENSIONS AND CLEARANCESFROM ARCHITECTURAL, STRUCTURAL, SUBMITTALS, AND OTHER APPROPRIATE DRAWINGS OR PHYSICALLY AT SITE. REVIEW ALL DRAWINGS, INCLUDING THOSE OF OTHER TRADES.
- 3. COORDINATE ALL WORK WITH ALL OTHER TRADES PRIOR TO INSTALLATION TO PROVIDE CLEARANCES REQUIRED FOR OPERATION, MAINTENANCE, CODE COMPLIANCE, AND TO VERIFY NON-INTERFERENCE WITH OTHER WORK. DO NOT FABRICATE PRIOR TO VERIFICATION OF NECESSARY CLEARANCES FOR ALL TRADES. BRING ANY INTERFERENCES OR CONFLICTS TO THE ATTENTION OF THE ARCHITECT/ENGINEER BEFORE PROCEEDING

WITH FABRICATION OR EQUIPMENT ORDERS.

- 4. REVIEW SPACE REQUIREMENTS OF EQUIPMENT SPECIFIED OR SUBSTITUTED AND MAKE REASONABLE ACCOMMODATIONS IN LAYOUT AND POSITIONING TO PROVIDE PROPER ACCESS.
- 5. ANY CHANGES REQUIRED TO ELIMINATE CONFLICTS OR THAT RESULT FROM A FAILURE TO COORDINATE SHALL BE MADE BY THE CONTRACTOR WITHOUT ADDITIONAL COST OR
- EXPENSE TO OTHERS.

 6. EACH CONTRACTOR IS RESPONSIBLE FOR ALL COSTS ASSOCIATED WITH ELECTRICAL
- CHANGES REQUIRED FOR EQUIPMENT PROPOSED THAT DIFFERS FROM THE BASIS OF DESIGN.

 7. REFER TO ARCHITECTURAL REFLECTED CEILING PLAN, ELECTRICAL, TECHNOLOGY
- AUDIO/VISUAL, AND OTHER MECHANICAL PLANS FOR EXACT LOCATIONS OF ALL CEILING MOUNTED DEVICES, OTHER THAN SPRINKLERS.
 8. EACH CONTRACTOR IS RESPONSIBLE FOR DAMAGE CAUSED BY THEIR ACTIONS TO WALLS, FLOORS, CEILINGS, AND ROOFS. THE CONTRACTOR WHOSE WORK CAUSES DAMAGE IS RESPONSIBLE FOR PATCHING TO MATCH ORIGINAL CONSTRUCTION, FIRE RATING, AND
- 9. SEAL ALL FLOOR AND WALL AIRTIGHT WHERE CONDUITS, PIPING, AND DUCTS PENETRATE.
 PENETRATIONS THROUGH EXTERIOR WALLS AND ROOF SHALL BE SEALED AIRTIGHT WITH
 WATERPROOFING MATERIALS RECOMMENDED BY MANUFACTURER FOR OUTDOOR USE.
- 10. CAULK ALL PIPE AND DUCT PENETRATIONS OF FULL HEIGHT NON-FIRE RATED WALL, PARTITION, FLOOR, AND ROOF ASSEMBLIES. THIS IS ESSENTIAL TO PREVENT NOISE TRANSMISSION FROM ONE ROOM TO ANOTHER AND TO PROVIDE THE DESIRED NC LEVELS
- DO NOT BLOCK TUBE PULL OR EQUIPMENT SERVICE CLEARANCES.
 DO NOT EXCEED 25 LBS PER HANGER AND A MINIMUM SPACING OF 2'-0" ON CENTER WHEN ATTACHING TO METAL ROOF DECKING (LIMITATION NOT REQUIRED WITH CONCRETE ON METAL DECK). THIS 25 LBS. LOAD AND 2'-0" SPACING INCLUDE ADJACENT ELECTRICAL AND ARCHITECTURAL ITEMS HANGING FROM DECK. IF THE HANGER RESTRICTIONS CANNOT BE ACHIEVED, SUPPLEMENTAL FRAMING OFF STEEL FRAMING SHALL BE ADDED. ANCHORS EMBEDDED IN CONCRETE SHALL BE CRACKED CONCRETE APPROVED IN ACCORDANCE WITH SPECIFICATIONS.

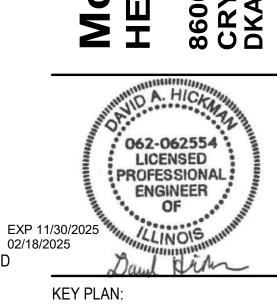
	MECHANICAL SHEET INDEX
	HVAC COVERSHEET
)	OVERALL DEMOLITION PLANS - HVAC
2	DEMOLITION PLANS - HVAC
	OVERALL FLOOR PLANS - HVAC
	FLOOR PLANS - HVAC
	HVAC DETAILS AND SCHEDULES
TOTAL: 6	

ARCHITECT OF RECORD

DEMONICA KEMPER ARCHITECTS
125 N. HALSTED STREET, SUITE 301
CHICAGO, IL 60661
P: 312.496.0000

S / MEP / FP / T ENGINEERS:
IMEG CORP.
253 SHUMAN BOULEVARD, SUITE
550 NAPERVILLE, IL 60563
P: 630.527.2320

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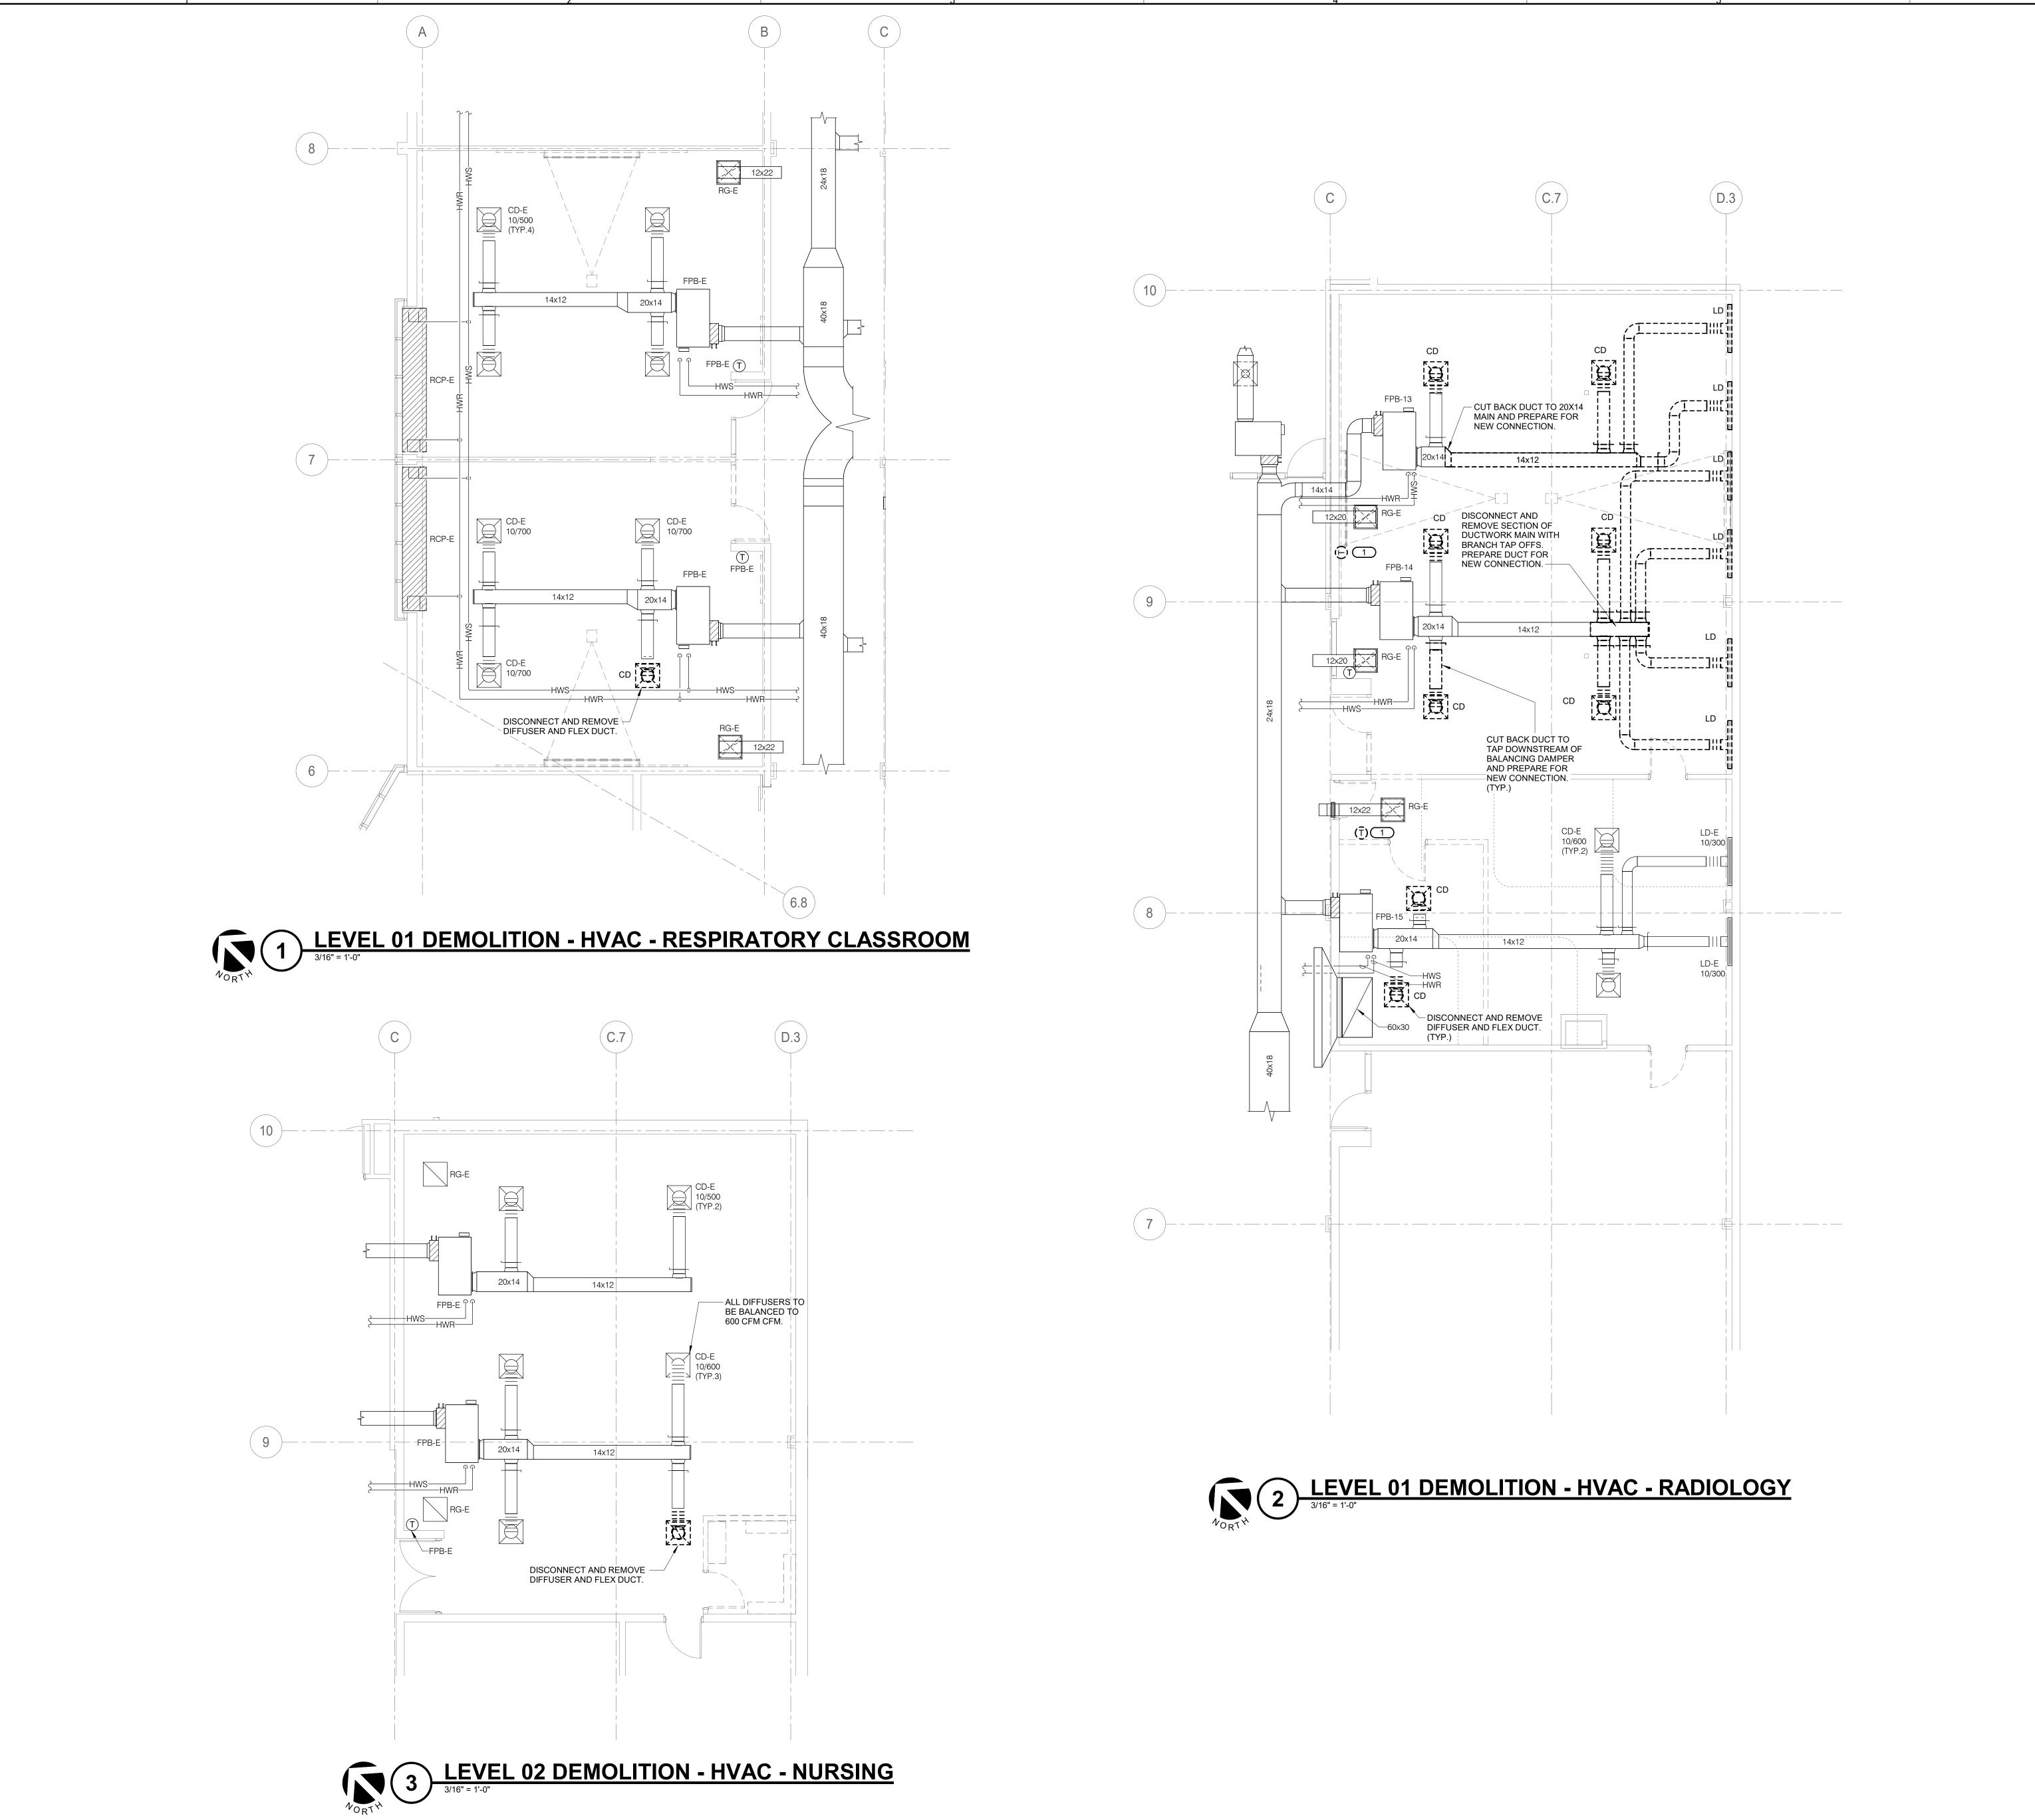
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SHEET TITLE:

OVERALL DEMOLITION PLANS -HVAC

SHEET NUMBER:

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GENERAL SHEET NOTES:

. PROVIDE PREBALANCE TEST. ENSURE ALL DAMPERS, VENTS, AND BALANCING DEVICES ARE PROPERLY ADJUSTED AND VERIFIED FOR AIRFLOW DISTRUBTION. PROVIDE REPORT TO ENGINEER PRIOR TO DEMOLITION. REFER TO 23 05 93 FOR MORE INFORMATION.

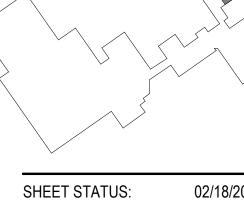
KEYNOTES: #

DISCONNECT AND REMOVE EXISTING TEMPERATURE SENSOR. CONTROLS AND WIRING TO BE REUSED TO NEW TEMPERATURE SENSOR LOCATION.

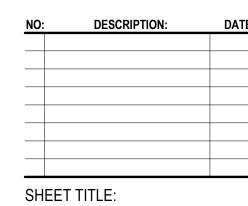
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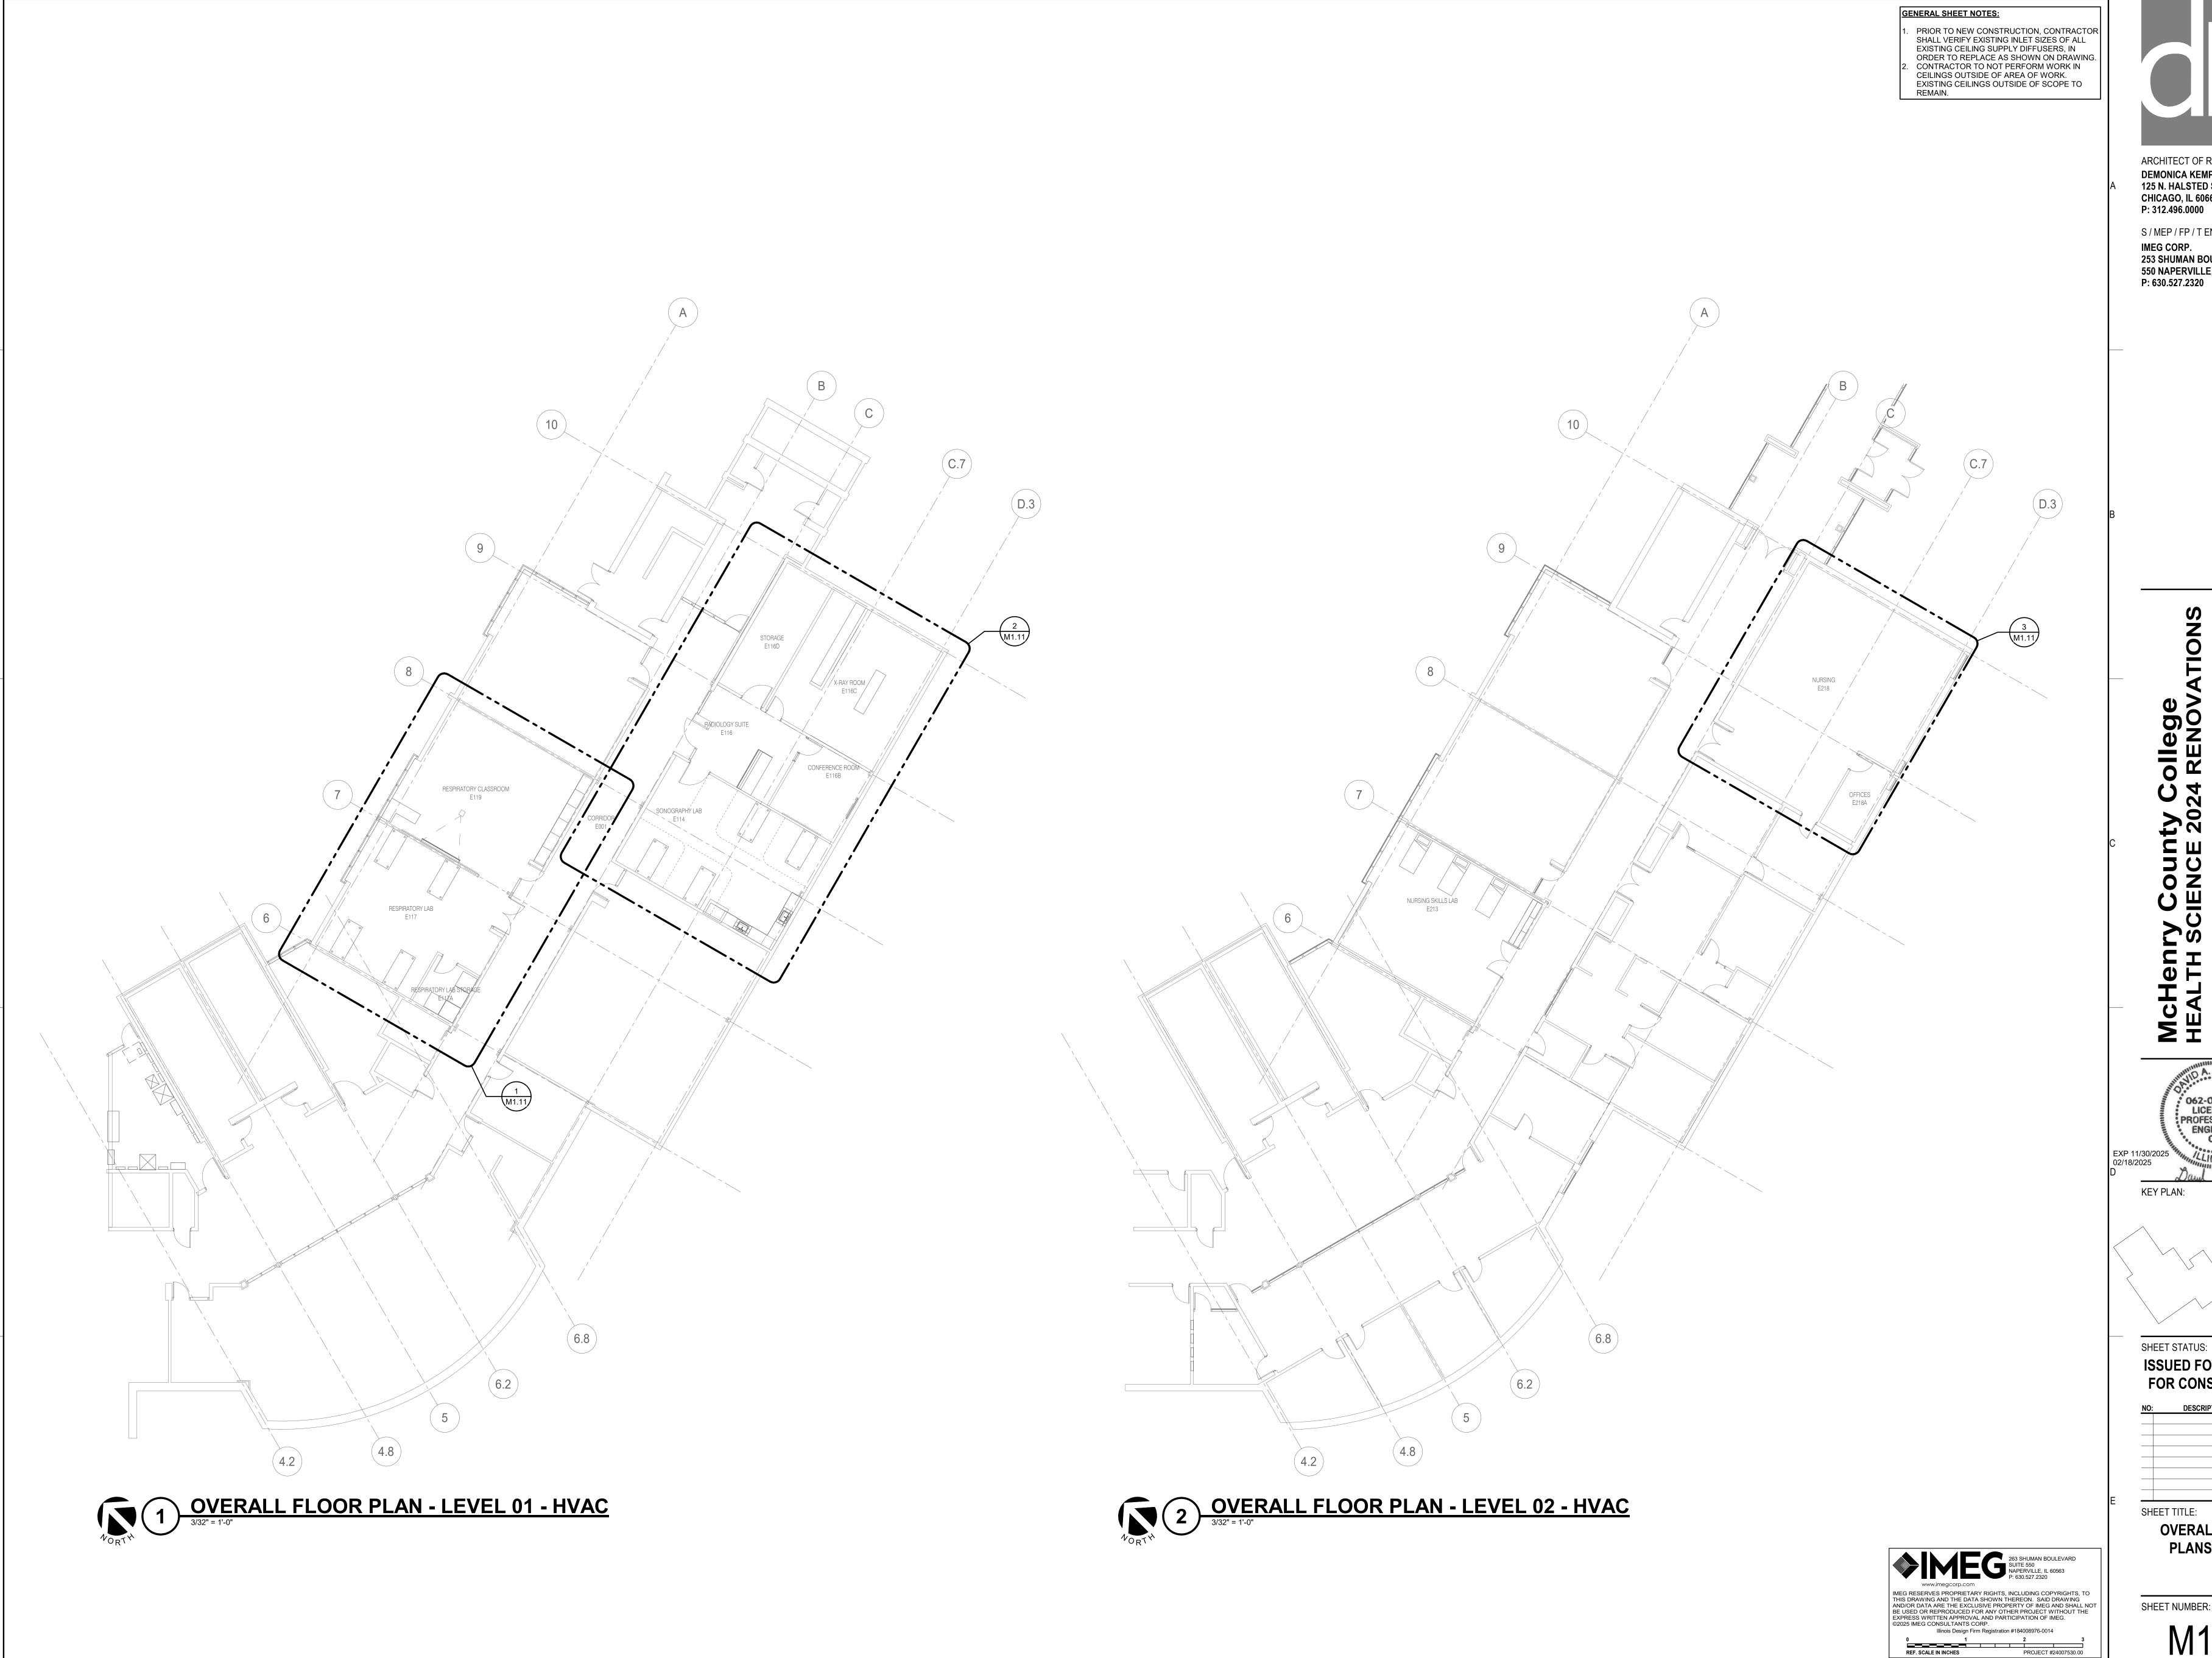
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SHEET TITLE:

OVERALL FLOOR PLANS - HVAC

SHEET NUMBER: M1.10

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KEYNOTES: # . RELOCATE TEMPERATURE SENSOR TO LOCATION SHOWN. EXTEND ALL CONTROLS WIRING AS REQUIRED.

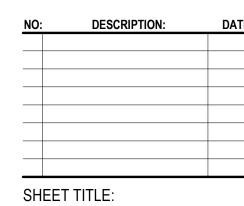
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FLOOR PLANS - HVAC

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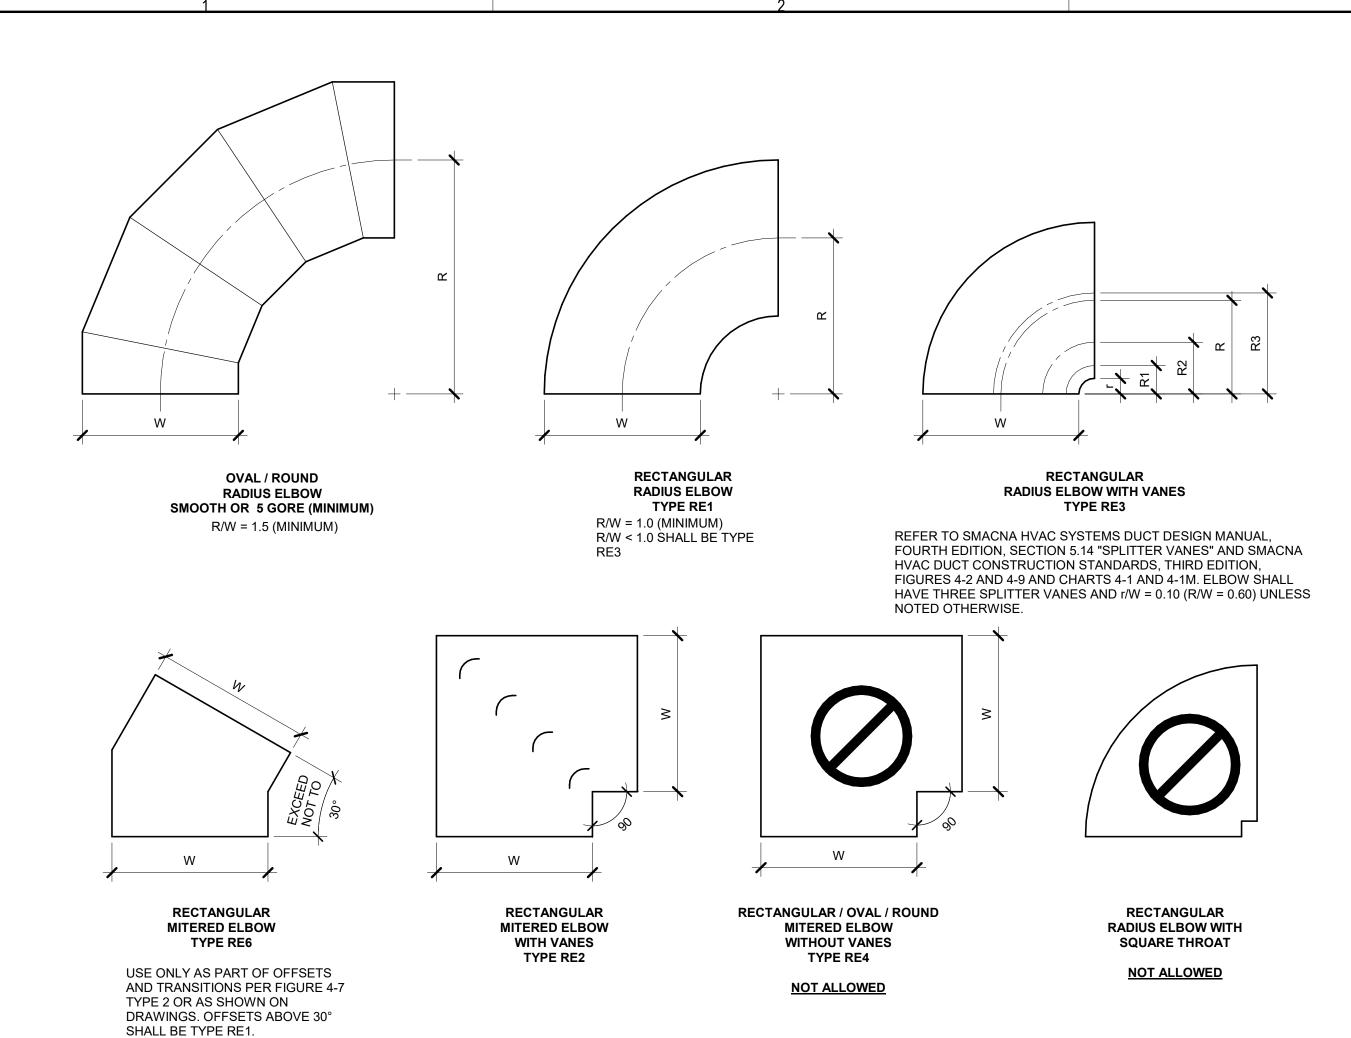
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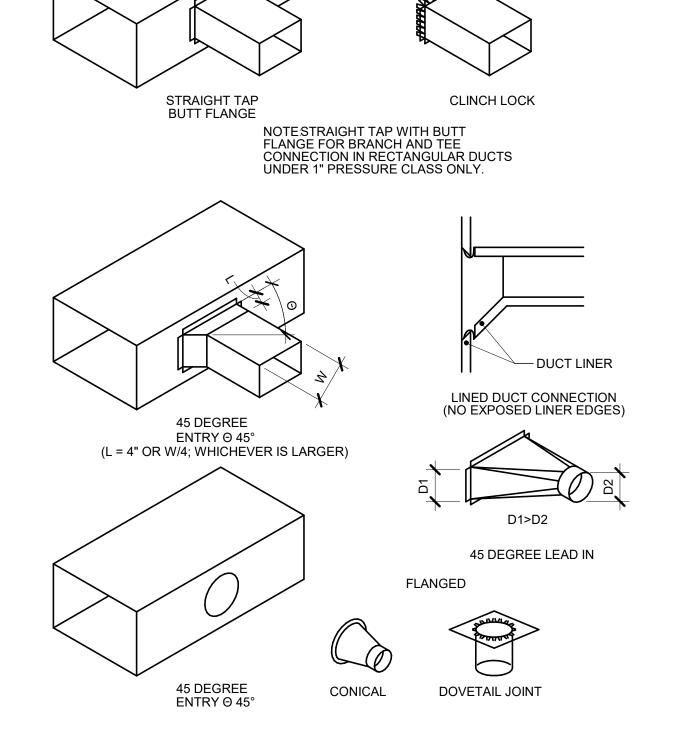
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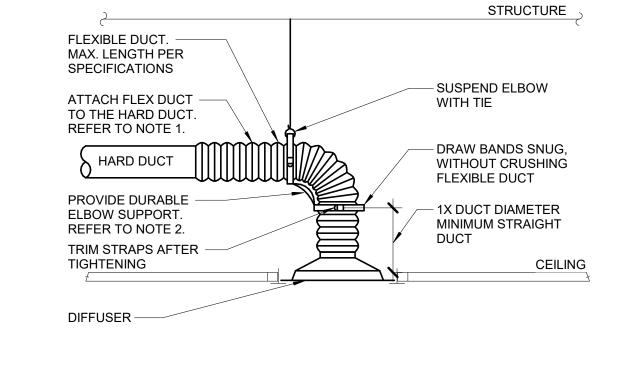
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- CORNER FILLER PIECE OR USE GASKET (TYP.)



ELBOW CONSTRUCTION

1. BEAD, CROSSBREAK, AND REINFORCE FLAT SURFACES AS IN

STRAIGHT DUCT. REFER TO SPECIFICATIONS FOR ADDITIONAL INFORMATION.

3. DEFAULT ELBOW SHALL BE TYPE "RE1". 4. ELBOW TYPES SHALL BE INSTALLED AS SHOWN AND NOT BE SUBSTITUTED WITHOUT PERMISSION. EXCEPTION: RE1 OR RE3 MAY BE SUBSTITUTED REFER TO DETAIL NOTES FOR RE2.

BRANCH CONNECTIONS

- 1. DO NOT USE CONNECTIONS WITH SCOOPS. 2. FIT ALL CONNECTIONS TO AVOID VISIBLE OPENINGS AND SECURE THEM SUITABLY FOR THE PRESSURE CLASS.
- 3. ADDITIONAL MECHANICAL FASTENERS ARE REQUIRED FOR 4"W.G. AND OVER. 4. SEE SPECIFICATIONS FOR ADDITIONAL INFORMATION.

DIFFUSER CONNECTION DETAIL NO SCALE

- 1. TO ATTACH FLEX DUCT TO THE HARD DUCT, TAPE THE INNER LINER TO THE HARD DUCT THEN ATTACH WITH TWO NYLON TIE WRAPS; ONE FOR THE INNER LINER AND ONE FOR THE OUTER SHELL. FOLD THE OUTER SHELL
- INSIDE ITSELF SO IT HAS NEAT EDGES PRIOR TO TIE WRAPPING. 2. DURABLE ELBOW SUPPORT ACCEPTABLE MANUFACTURER AND MODEL: HART AND COOLEY - SMARTFLOW, THERMAFLEX - FLEXFLOW, TITUS -FLEXRIGHT, OR APPROVED EQUAL.

IR T	ERMINAL	SCHEDULE							
	ES: ONTRACTOR SHALL DETERMINE PROPER BORDER TYPE TO MATCH CEILING CONSTRUCTION. EFER TO DRAWINGS FOR NECK SIZE. ALL BRANCH DUCTWORK TO AIR TERMINALS SHALL BE NECK SIZE UNLESS NOTED OTHERWISE.								
TAG NAME	FACE SIZE (IN.) (NOTE 2)	TYPE	BORDER (NOTE 1)	MATERIAL	FINISH	VOLUME DAMPER REQUIRED	MANUFACTURER	MODEL	NOTES
CD-1	24x24	PANEL	LAY-IN	STEEL	WHITE	NO	TITUS	OMNI	



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02/18/2025

SHEET STATUS: **ISSUED FOR BID - NOT** FOR CONSTRUCTION

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SHEET TITLE: **HVAC DETAILS AND SCHEDULES**

SHEET NUMBER:

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VIEW KEY
KEYNOTE: INDICATES NOTE USED TO DESCRIBE ADDITIONAL INFORMATION ABOUT WORK REQUIRED, SPECIFIC TO THE SHEET AND/OR DETAIL
INDICATES DIRECTION OF TRUE NORTH
INDICATES DIRECTION OF TRUE NORTH
PLAN OR DETAIL NUMBER
PLAN OR DETAIL NAME
1 VIEW NAME

	PLUMBING SYMBOL LIST
	NOT ALL SYMBOLS MAY APPLY.
SYMBOL:	DESCRIPTION:
CW	COLD WATER - POTABLE
——HW——	HOT WATER - POTABLE
—HWC—	HOT WATER CIRCULATING - POTABLE
——SAN——	SANITARY DRAINAGE
V	VENT
	PIPE CONTINUATION
	PIPE CAP
	PIPE DOWN
	PIPE UP OR UP/DOWN
—— о FD	PIPE SERVING FIXTURE ON FLOOR ABOVE (EXAMPLE: FD = FLOOR DRAIN)
	DIRECTION OF FLOW IN PIPE
──	SHUTOFF VALVE NORMALLY OPEN
—— <mark>⊠</mark> GPM_	BALANCING VALVE (NUMBER INDICATES GPM)
<u></u>	CHECK VALVE
	SAW CUT

	PLUMBING ABBREVIATION KEY
ABBR:	DESCRIPTION:
E	EXISTING
FCO	FLOOR CLEANOUT
SK	SINK
TYP	TYPICAL

MECHANICAL I	RENOVATION NOTES:
--------------	-------------------

THESE NOTES APPLY TO ALL MECHANICAL SHEETS AND TRADES, INCLUDING BUT NOT LIMITED

TO FIRE PROTECTION, PLUMBING, VENTILATION AND PIPING. 1. EXISTING CONDITIONS ARE SHOWN BASED ON INFORMATION OBTAINED FROM FIELD

SURVEYS, EXISTING BUILDING DOCUMENTS, AND STAFF. VERIFY EXISTING CONDITIONS AND REPORT ANY CONFLICTS BEFORE PROCEEDING. 2. NOT ALL EXISTING DUCTWORK AND PIPING IS SHOWN. VERIFY EXISTING CONDITIONS BEFORE STARTING WORK. NOTIFY ENGINEER OF ANY CONFLICTS WITH NEW WORK.

3. FIELD VERIFY THE AVAILABLE CLEARANCES FOR DUCTWORK AND PIPING BEFORE FABRICATION. RISES AND DROPS MAY BE NECESSARY BECAUSE OF EXISTING FIELD CONDITIONS.

4. THE CONSTRUCTION MANAGER SHALL FIELD VERIFY ACCESSIBILITY TO THE AREA OF THEIR WORK AND SHALL NOTIFY THE ARCHITECT/ENGINEER PRIOR TO BIDDING IF OTHER UTILITIES ARE REQUIRED TO BE REMOVED OR RELOCATED TO ALLOW ACCESS TO THEIR AREA OF WORK. 5. EACH CONTRACTOR SHALL CUT AND PATCH ROOFS, WALLS, AND FLOORS ASSOCIATED

WITH THEIR WORK. 6. THE CONSTRUCTION MANAGER IS RESPONSIBLE FOR REMOVAL AND REPLACEMENT OF CEILINGS, CEILING TILES, AND CEILING GRIDS ASSOCIATED WITH AREAS OF WORK BY ALL CONTRACTORS.

7. WHERE EXISTING MECHANICAL SYSTEMS ARE LOCATED IN AREAS THAT CONFLICT WITH NEW EQUIPMENT, PIPING, OR DUCTWORK TO BE INSTALLED, EACH CONTRACTOR SHALL EITHER ARRANGE NEW EQUIPMENT, PIPING, OR DUCTWORK IN SUCH A FASHION THAT IT DOES NOT CONFLICT WITH EXISTING SYSTEMS, OR REWORK EXISTING MECHANICAL SYSTEMS TO ALLOW FOR INSTALLATION OF NEW EQUIPMENT, PIPING, OR DUCTWORK.

8. PROVIDE TEMPORARY CONNECTIONS TO MAINTAIN EXISTING SYSTEMS IN SERVICE DURING CONSTRUCTION. MAINTAIN ACCESS TO EXISTING MECHANICAL INSTALLATIONS THAT REMAIN ACTIVE.

9. OBTAIN PERMISSION FROM OWNER BEFORE SHUTTING DOWN ANY SYSTEM FOR ANY REASON. MAINTAIN SERVICE TO ALL COMPONENTS THAT ARE TO REMAIN UNTIL NEW SYSTEMS ARE INSTALLED.

10. DISCONNECT AND REMOVE MECHANICAL DEVICES AND EQUIPMENT SERVING EQUIPMENT THAT HAS BEEN REMOVED.

TAG NAME	DESCRIPTION	MANUFACTURER AND MODE
FCO-1	FLOOR CLEANOUT - ADJUSTABLE, CAST IRON HOUSING, ANCHOR FLANGE, TAPERED THREAD PLUG, SECURED NICKEL BRONZE TOP. TOP STYLE SHALL MATCH FLOOR FINISH AS FOLLOWS:	ZURN (Z1400), JOSAM (55000 MIFAB (C1100), SMITH (4000), WADE (6000), WATTS (CO-200
	UNFINISHED FLOOR - ROUND SOLID SCORIATED TOP TILE OR TERRAZZO - ROUND RECESSED TOP CARPET - ROUND TOP WITH CARPET MARKER.	
SK-1		SINK - ELKAY (LRAD/LKAD18) JUST (SL-ADA/J-ADA-35-FS), FRANKE (ALBS), ACORN-SINKS (SDADA) SINK TRIM - DELTA (27C2),
	SINK TRIM - TWO HANDLE MIXING FAUCET, BRASS CONSTRUCTION, CHROME-PLATED FINISH, GOOSENECK RIGID SPOUT, NOMINAL 6" REACH, AERATOR 4" WRISTBLADE HANDLES AT 8" CENTERS, 1/4-TURN OPERATION CERAMIC DISC CARTRIDGE. MAXIMUM FLOW TO BE 1.0 GPM IN COMPLIANCE WITH PROJECT WATER CONSERVATION REQUIREMENTS (LEED). FAUCET SHALL COMPLY WITH FEDERAL ACT S.3874. PROVIDE RESTRICTIVE DEVICE AND ESCUTCHEON PLATE AS REQUIRED.	AMERICAN STANDARD (6540 CHICAGO FAUCET (786), SPEAKMAN (SC-3000 SERIES SYMMONS (S-254), T&S BRAS (B-2866-05CR), ZURN (Z831-X
	ACCESORIES - OFFSET 1-1/2" 17 GAUGE CHROME PLATED BRASS TAIL PIECE AND P-TRAP, QUARTER-TURN BALL VALVE TYPE 3/8" CHROME-PLATED BRASS ANGLE SUPPLIES WITH LOOSE KEY STOPS, CHROME-PLATED SOFT COPPER OR FLEXIBLE STAINLESS STEEL SUPPLY LINES.	
	INSULATION KIT - INCLUDE FOR EXPOSED TRAPS, REFER TO 22 40 00. ARMAFLEX WITH TAPE IS NOT ACCEPTABLE IN LIEU OF INSULATION KIT.	

PIPE INSULATION SCHEDULE

1. REFER TO THE SPECIFICATIONS FOR TYPE DESCRIPTIONS AND JACKETING REQUIREMENTS. VALUES LISTED BELOW ARE BASED ON IECC REQUIREMENTS. 2. PROVIDE RIGID INSERT AT HANGERS, EITHER PRE-MANUFACTURED COUPLINGS (REFER TO PIPE HANGER AND SUPPORTS SPECIFICATIONS) OR TYPE C, D, OR E INSULATION. SEE SPEC. FOR MORE

PIPE SYSTEM	INSULATION TYPE		ECC) INSULATION	ON THICKNESS R TUBE SIZE	NOTES
		< 1"	1" TO < 1.5"	1.5" TO < 4"	
22 PLUMBING - WASTE	·				
V - VENT	A (GlsFbr)	0.5"	0.5"	1"	
22 PLUMBING - WATER	·	•			
CW - COLD WATER - POTABLE	A (GlsFbr)	0.5"			
HW - HOT WATER - POTABLE	A (GlsFbr)	1"			
HWC - HOT WATER CIRCULATING - POTABLE	A (GlsFbr)	1"			
Grand total: 4		-			

PLUMBING ROUGH-IN SCHEDULE

NOTES: (APPLIES TO ALL PLUMBING FIXTURES LISTED BELOW) 1) SIZES SHOWN ARE MINIMUMS. LARGER SIZES SHOWN ON THE DRAWING SHALL DICTATE THE ROUGH-IN SIZE. 2) SANITARY RISERS UP IN WALL TO FIXTURES SHALL BE A MINUMUM OF 2". 3) DOMESTIC WATER BRANCH PÍPING OUTSIDE OF THE WALL/CHASE SHALL BE A MINIMUM OF 3/4" UNLESS NOTED OTHERWISE. ONLY THE FINAL RISE-DROP SHALL BE SMALLER. 4) FINAL SANITARY SIZE SHALL MATCH P-TRAP SIZE (REFER TO MATERIA

	RIPTION TRAP WATER WATER SANITARY VEN	TRAP WATER	DESCRIPTION	TAG NAME
SK-1 SINK (ACCESSIBLE) 1/2" 1 1/2" 1 1/2" 1 1	1/2" 1/2" 1 1/2" 1 1/2	1/2"	SINK (ACCESSIBLE)	SK-1

PLUMBING GENERAL NOTES:

- 1. THE SYMBOLS AND THE MATERIAL LIST ARE FOR THE CONVENIENCE OF THE CONTRACTOR. CONTRACTOR SHALL VERIFY QUANTITIES AND FURNISH ALL MATERIALS REQUIRED FOR
- FULLY OPERATIONAL SYSTEMS. WHETHER SPECIFIED OR NOT. 2. CATALOG NUMBERS SHALL NOT BE CONSIDERED COMPLETE, BUT ARE GIVEN AS AN AID TO THE CONTRACTOR AND TO INDICATE THE QUALITY REQUIRED. CONTRACTOR IS RESPONSIBLE FOR A COMPLETE DESCRIPTION OF MATERIAL ON THESE DRAWINGS AND IN THE SPECIFICATIONS BEFORE ORDERING. THE DESCRIPTION OF THE MATERIAL TAKES PRECEDENCE OVER THE CATALOG NUMBER. THE FIRST MANUFACTURER LISTED IS THE
- BASIS OF DESIGN. 3. CONTRACTOR SHALL VERIFY THAT FIXTURES SUPPLIED ARE APPROVED PER ALL
- APPLICABLE STATE, LOCAL AND GOVERNING AUTHORITIES. ALL FIXTURES SHALL CONFORM TO FEDERAL ACT S.3874
- VERIFY UNDERGROUND PIPE SIZES, INVERT ELEVATIONS, AND LOCATIONS PRIOR TO BEGINNING ANY WORK. 6. REFER TO THE PLUMBING ROUGH-IN SCHEDULE FOR THE SIZES OF BRANCH PIPES TO
- PLUMBING FIXTURES. 7. FOR CLARITY, NOT ALL VALVES HAVE BEEN SHOWN. PROVIDE SHUTOFF VALVES IN DOMESTIC WATER PIPING SERVING EACH ROOM WITH FIXTURES. ANGLE STOPS SHALL NOT

BE CONSIDERED SHUTOFF VALVES.

- 8. EXISTING CONDITIONS ON DEMOLITION PLANS ARE PROVIDED TO INDICATE THE GENERAL SCOPE OF ITEMS TO BE REMOVED. REFER TO SPECIFICATION SECTION 22 05 05 FOR ADDITIONAL DEMOLITION INFORMATION.
- 9. P.C. SHALL CUT AND PATCH EXISTING AS REQUIRED FOR NEW OR DEMOLITION WORK UNLESS NOTED OTHERWISE. REFER TO SPECIFICATION SECTION 22 05 05 FOR ADDITIONAL INFORMATION.

MECHANICAL GENERAL NOTES:

THESE NOTES APPLY TO ALL MECHANICAL SHEETS AND TRADES, INCLUDING BUT NOT LIMITED TO, FIRE PROTECTION, PLUMBING, VENTILATION, PIPING AND TEMPERATURE CONTROL.

- 1. DRAWINGS SHOWING LOCATIONS OF EQUIPMENT, DUCTWORK, PIPING, ETC. ARE DIAGRAMMATIC AND MAY NOT ALWAYS REFLECT EXACT INSTALLATION CONDITIONS. DRAWINGS SHOW THE GENERAL ARRANGEMENT OF DUCTWORK, PIPING, EQUIPMENT, ETC., AND MAY NOT INCLUDE ALL OFFSETS AND FITTINGS REQUIRED FOR COMPLETE INSTALLATION. THE DRAWINGS SHALL BE FOLLOWED AS CLOSELY AS ACTUAL BUILDING
- CONSTRUCTION AND THE WORK OF OTHERS WILL PERMIT. 2. DO NOT SCALE DRAWINGS. VERIFY ALL DIMENSIONS AND CLEARANCESFROM ARCHITECTURAL, STRUCTURAL, SUBMITTALS, AND OTHER APPROPRIATE DRAWINGS OR
- PHYSICALLY AT SITE. REVIEW ALL DRAWINGS, INCLUDING THOSE OF OTHER TRADES. 3. COORDINATE ALL WORK WITH ALL OTHER TRADES PRIOR TO INSTALLATION TO PROVIDE CLEARANCES REQUIRED FOR OPERATION, MAINTENANCE, CODE COMPLIANCE, AND TO VERIFY NON-INTERFERENCE WITH OTHER WORK. DO NOT FABRICATE PRIOR TO VERIFICATION OF NECESSARY CLEARANCES FOR ALL TRADES. BRING ANY INTERFERENCES OR CONFLICTS TO THE ATTENTION OF THE ARCHITECT/ENGINEER BEFORE PROCEEDING WITH FABRICATION OR EQUIPMENT ORDERS. 4. REVIEW SPACE REQUIREMENTS OF EQUIPMENT SPECIFIED OR SUBSTITUTED AND MAKE
- REASONABLE ACCOMMODATIONS IN LAYOUT AND POSITIONING TO PROVIDE PROPER ACCESS. . ANY CHANGES REQUIRED TO ELIMINATE CONFLICTS OR THAT RESULT FROM A FAILURE TO COORDINATE SHALL BE MADE BY THE CONTRACTOR WITHOUT ADDITIONAL COST OR
- EXPENSE TO OTHERS. 6. EACH CONTRACTOR IS RESPONSIBLE FOR ALL COSTS ASSOCIATED WITH ELECTRICAL
- CHANGES REQUIRED FOR EQUIPMENT PROPOSED THAT DIFFERS FROM THE BASIS OF REFER TO ARCHITECTURAL REFLECTED CEILING PLAN, ELECTRICAL, TECHNOLOGY
- AUDIO/VISUAL, AND OTHER MECHANICAL PLANS FOR EXACT LOCATIONS OF ALL CEILING MOUNTED DEVICES, OTHER THAN SPRINKLERS. 8. EACH CONTRACTOR IS RESPONSIBLE FOR DAMAGE CAUSED BY THEIR ACTIONS TO WALLS, FLOORS, CEILINGS, AND ROOFS. THE CONTRACTOR WHOSE WORK CAUSES DAMAGE IS RESPONSIBLE FOR PATCHING TO MATCH ORIGINAL CONSTRUCTION, FIRE RATING, AND
- 9. SEAL ALL FLOOR AND WALL AIRTIGHT WHERE CONDUITS, PIPING, AND DUCTS PENETRATE. PENETRATIONS THROUGH EXTERIOR WALLS AND ROOF SHALL BE SEALED AIRTIGHT WITH WATERPROOFING MATERIALS RECOMMENDED BY MANUFACTURER FOR OUTDOOR USE.
- 10. CAULK ALL PIPE AND DUCT PENETRATIONS OF FULL HEIGHT NON-FIRE RATED WALL, PARTITION, FLOOR, AND ROOF ASSEMBLIES. THIS IS ESSENTIAL TO PREVENT NOISE TRANSMISSION FROM ONE ROOM TO ANOTHER AND TO PROVIDE THE DESIRED NC LEVELS WITHIN ROOMS. 11. DO NOT BLOCK TUBE PULL OR EQUIPMENT SERVICE CLEARANCES.
- 12. DO NOT EXCEED 25 LBS PER HANGER AND A MINIMUM SPACING OF 2'-0" ON CENTER WHEN ATTACHING TO METAL ROOF DECKING (LIMITATION NOT REQUIRED WITH CONCRETE ON METAL DECK). THIS 25 LBS. LOAD AND 2'-0" SPACING INCLUDE ADJACENT ELECTRICAL AND ARCHITECTURAL ITEMS HANGING FROM DECK. IF THE HANGER RESTRICTIONS CANNOT BE ACHIEVED, SUPPLEMENTAL FRAMING OFF STEEL FRAMING SHALL BE ADDED. ANCHORS EMBEDDED IN CONCRETE SHALL BE CRACKED CONCRETE APPROVED IN ACCORDANCE WITH SPECIFICATIONS.

PL	UMBING SHEET INDEX
00	PLUMBING COVERSHEET
.00	OVERALL DEMOLITION UNDERFLOOR PLAN - PLUMBING
.01	OVERALL DEMOLITION PLANS - PLUMBING
.02	DEMOLITION PLANS - PLUMBING
00	OVERALL UNDERFLOOR PLAN - PLUMBING
)1	OVERALL FLOOR PLANS - PLUMBING
)2	FLOOR PLANS - PLUMBING
00	PLUMBING DETAILS

GRAND TOTAL: 8



ARCHITECT OF RECORD DEMONICA KEMPER ARCHITECTS 125 N. HALSTED STREET, SUITE 301 **CHICAGO, IL 60661** P: 312.496.0000

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PLUMBING COVERSHEET

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550 NAPERVILLE, IL 60563
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OF

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02/18/2025
D

KEY PLAN:

EY PLAN:

HEET STATUS: 02/18/20

SHEET STATUS: 02/18/2025
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NO: DESCRIPTION: DATE

SHEET TITLE:

OVERALL

DEMOLITION UNDERFLOOR PLAN -PLUMBING

SHEET NUMBER:

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062-062554 LICENSED PROFESSIONAL ENGINEER OF EXP 11/30/2025 02/18/2025 KEY PLAN:

SHEET STATUS: **ISSUED FOR BID - NOT** FOR CONSTRUCTION

SHEET TITLE:

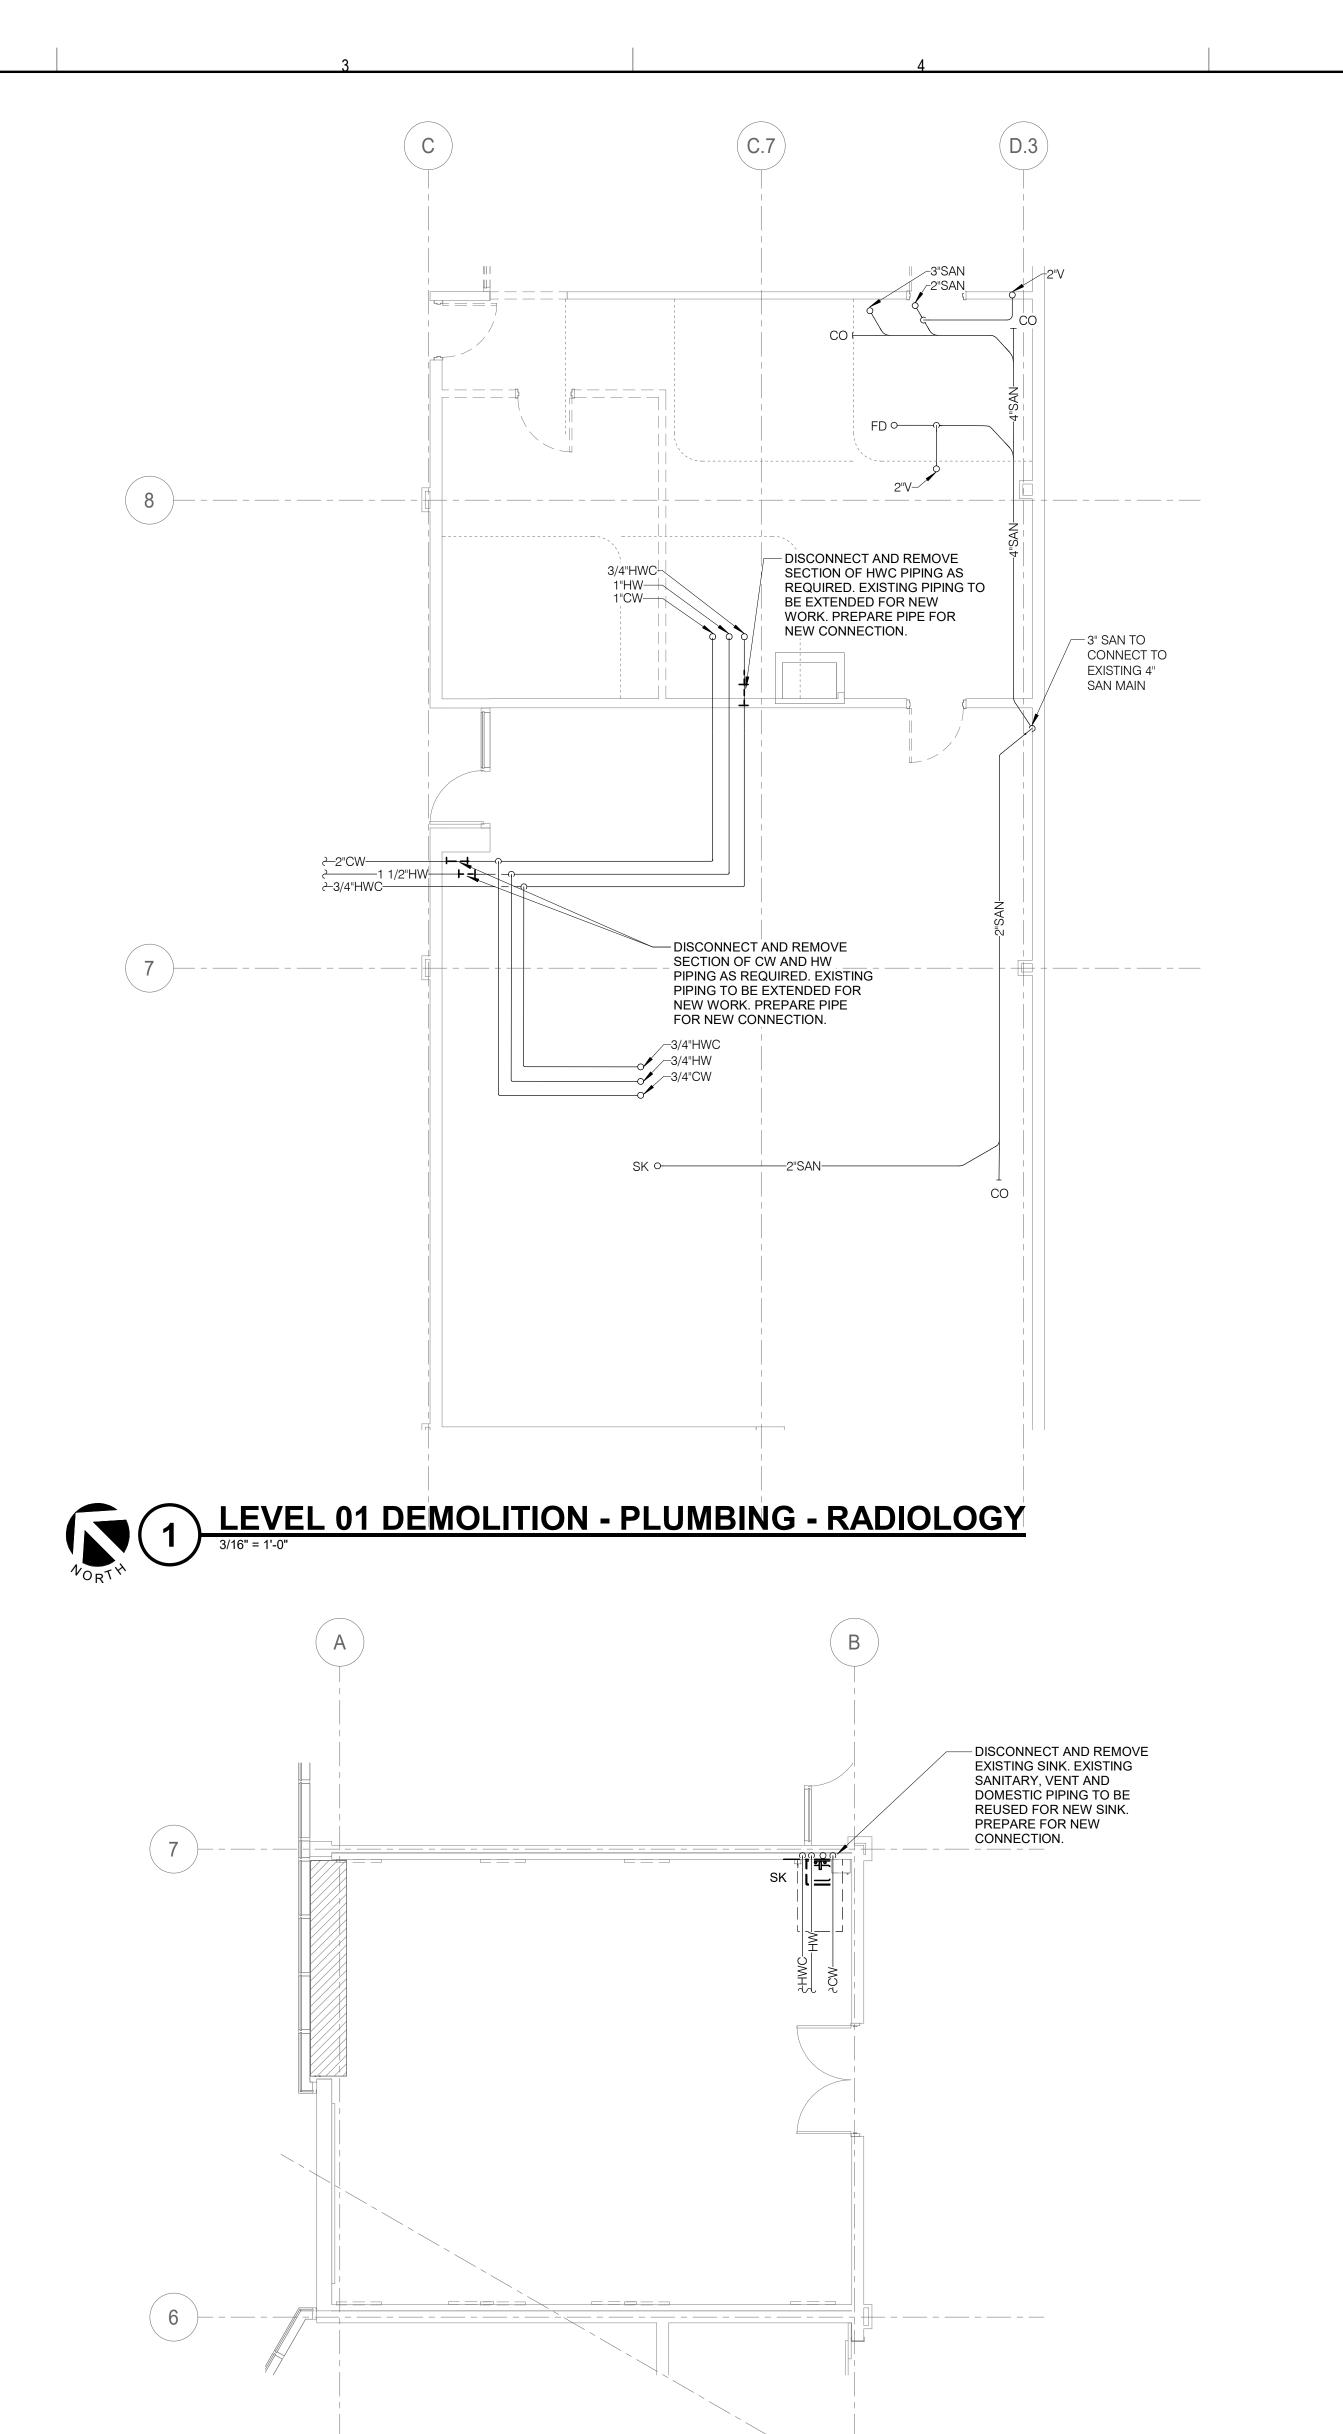
OVERALL DEMOLITION PLANS -

SHEET NUMBER:

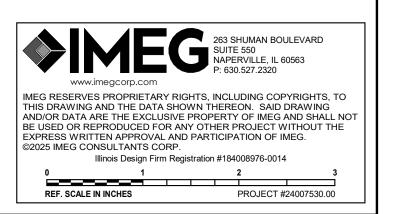
PLUMBING

PD1.01

2/17/2025 10:24:35 AM



LEVEL 02 DEMOLITION - PLUMBING - NURSING SKILLS LAB



ARCHITECT OF RECORD DEMONICA KEMPER ARCHITECTS 125 N. HALSTED STREET, SUITE 301 CHICAGO, IL 60661 P: 312.496.0000

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SHEET STATUS: **ISSUED FOR BID - NOT**

FOR CONSTRUCTION

SHEET TITLE:

DEMOLITION PLANS -PLUMBING

SHEET NUMBER:

2/17/2025 10:24:35 AM

PD1.02





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EXP 11/30/2025 02/18/2025

SHEET STATUS: ISSUED FOR BID - NOT FOR CONSTRUCTION

SHEET TITLE:

OVERALL UNDERFLOOR PLAN -PLUMBING

SHEET NUMBER:

2/17/2025 10:24:36 AM



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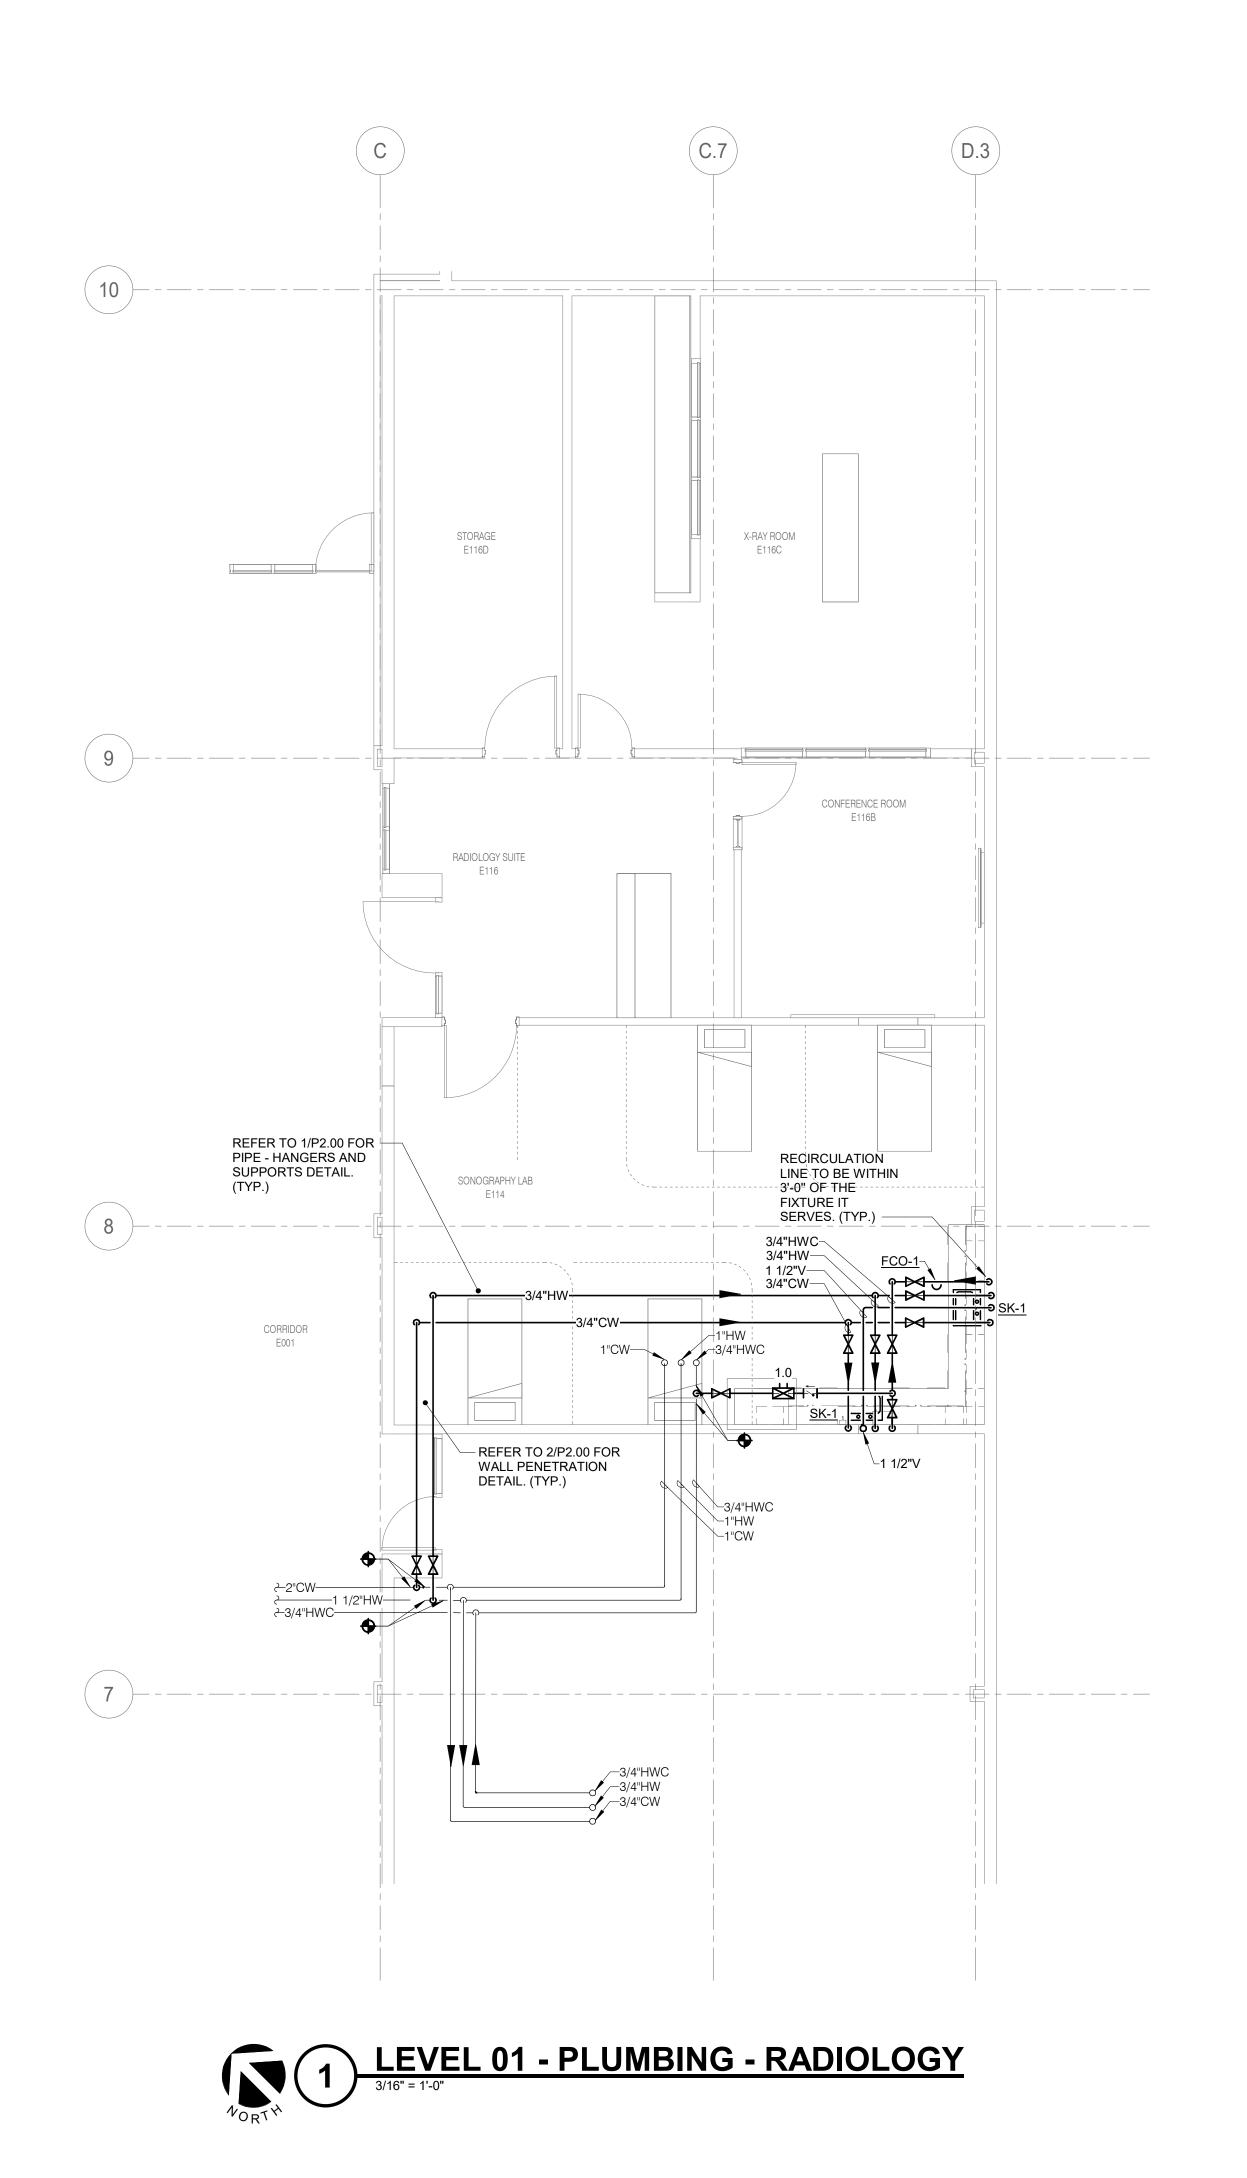
SHEET STATUS: ISSUED FOR BID - NOT FOR CONSTRUCTION

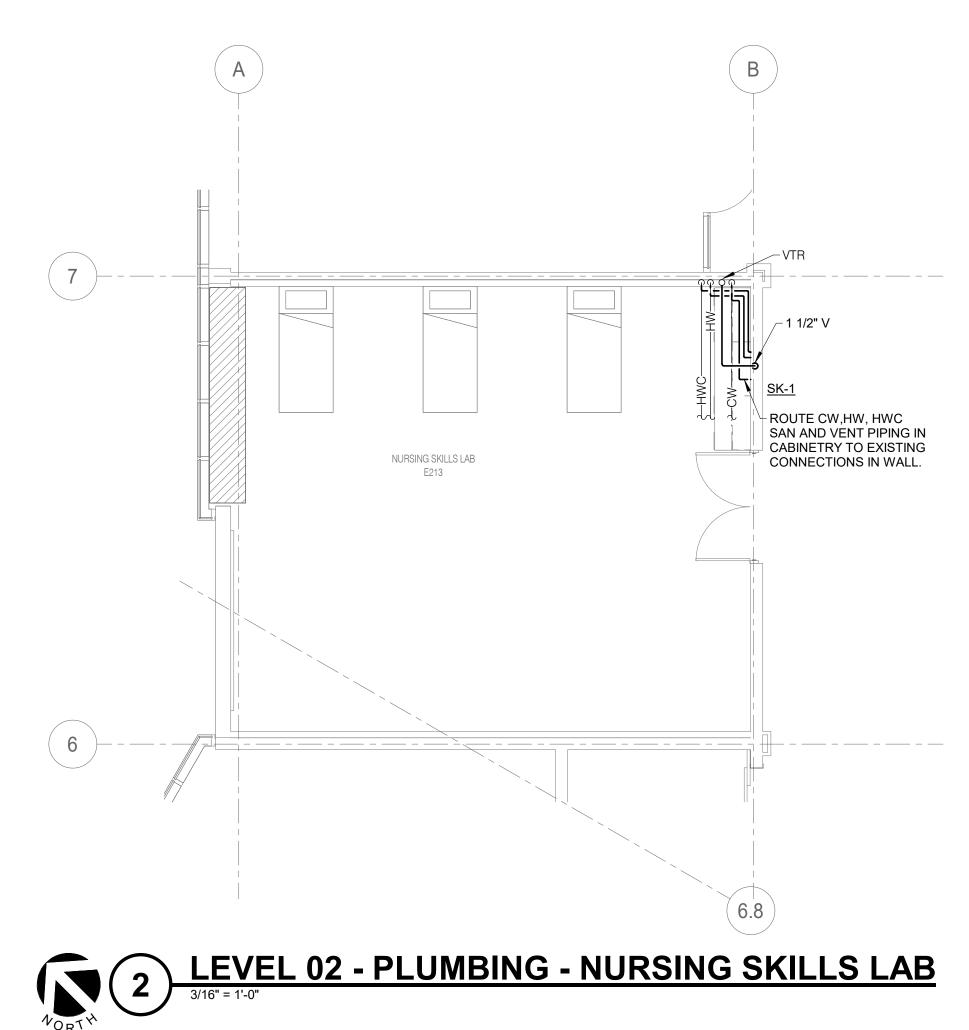
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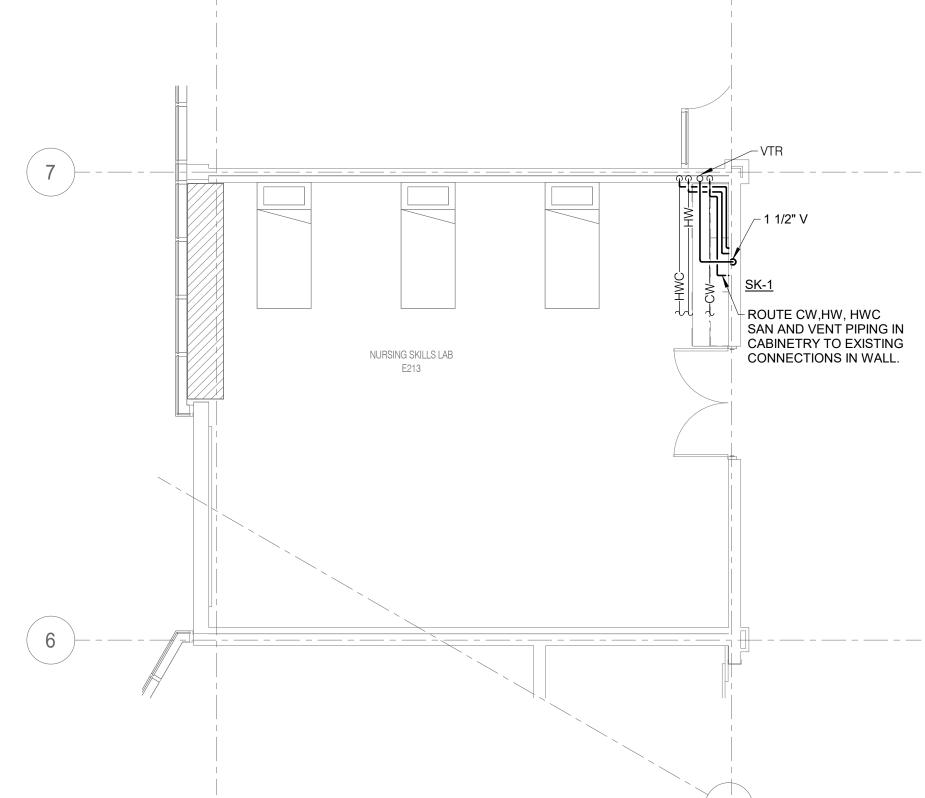
OVERALL FLOOR PLANS - PLUMBING

SHEET NUMBER:

P1.01 2/17/2025 10:24:36 AM







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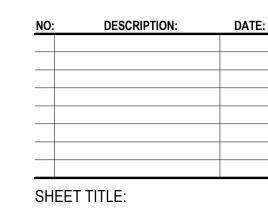


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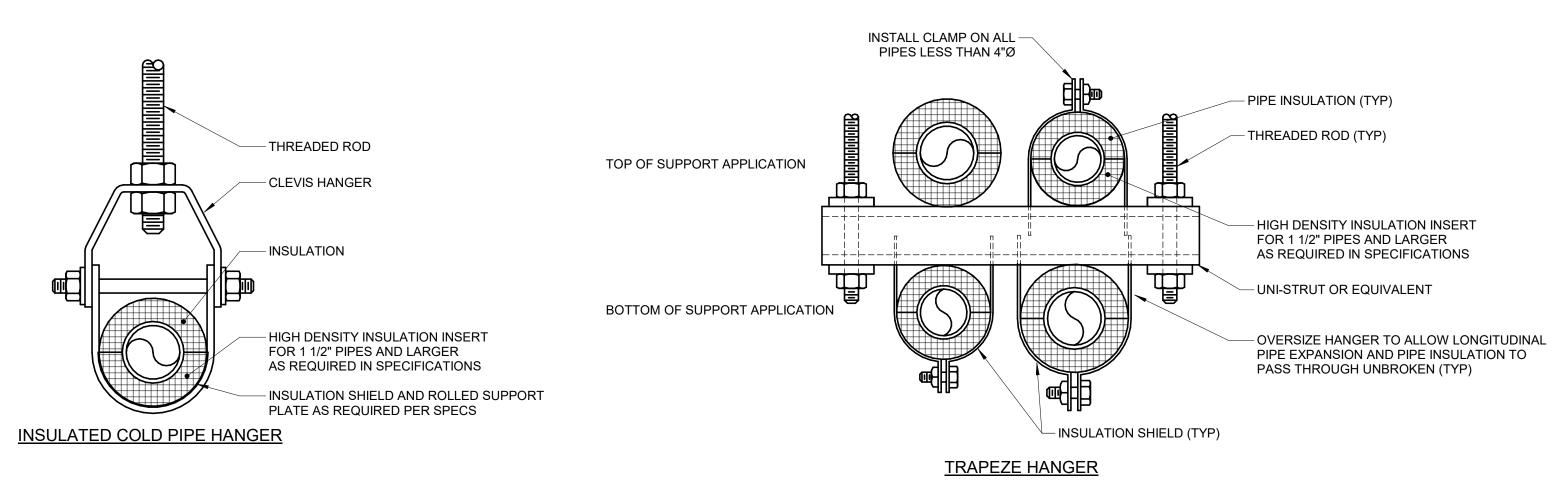
EXP 11/30/2025 02/18/2025

SHEET STATUS: **ISSUED FOR BID - NOT** FOR CONSTRUCTION



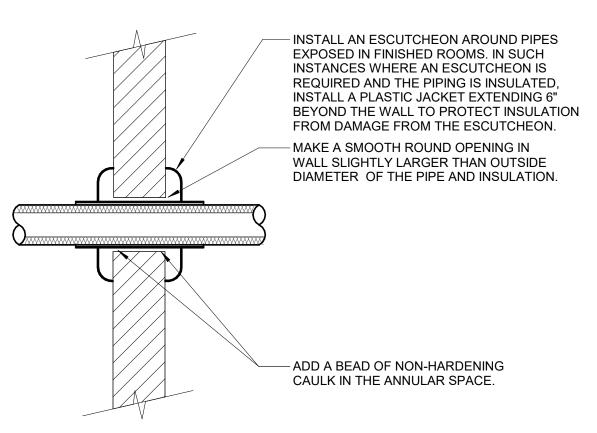
FLOOR PLANS -PLUMBING

SHEET NUMBER:



1. REFER TO SPECIFICATION SECTION 22 05 29-PLUMBING & SECTION 22 07 19-PLUMBING.

1 PIPE - HANGERS AND SUPPORTS
NO SCALE



NOTES:

- THIS DETAIL APPLIES TO ALL PIPES. THE INTENTION IS TO CONTINUE THE INSULATION AND VAPOR BARRIER THROUGH ALL PENETRATIONS. PERMIT THERMAL EXPANSION WITHOUT DAMAGING INSULATION, AND TO SEAL AIRTIGHT AROUND INSULATED AND UNINSULATED PIPES FOR NOISE
- TRANSMISSION CONTROL. 2. SEE SPECIFICATION SECTION 22 05 29 - PLUMBING FOR ADDITIONAL INFORMATION.
- 3. FLOOR OPENINGS ARE SIMILAR, SEE SPECIFICATION SECTION SECTION 22 05 29 PLUMBING FOR DIFFERENCES BETWEEN FLOOR AND WALL PENETRATIONS.

WALL PENETRATION - NON-FIRE RATED
NO SCALE



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McHenry County College HEALTH SCIENCE 2024 RENOV

EXP 11/30/2025 02/18/2025

SHEET STATUS:

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SHEET TITLE: **PLUMBING DETAILS**

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SHEET NUMBER:

2/17/2025 10:24:37 AM

VIEW KEY
KEYNOTE: INDICATES NOTE USED TO DESCRIBE ADDITIONAL INFORMATION ABOUT WORK REQUIRED, SPECIFIC TO THE SHEET AND/OR DETAIL
INDICATES DIRECTION OF TRUE NORTH
PLAN OR DETAIL NUMBER
PLAN OR DETAIL NAME
VIEW NAME
1/8" = 1'-0" PLAN OR DETAIL SCALE

	FIRE PROTECTION SYMBOL LIST
	NOT ALL SYMBOLS MAY APPLY.
SYMBOL:	DESCRIPTION:
	AREA BOUNDARY
NO HATCH	LIGHT HAZARD
	ORDINARY GROUP 1

MECHANICAL RENOVATION NOTES:

THESE NOTES APPLY TO ALL MECHANICAL SHEETS AND TRADES, INCLUDING BUT NOT LIMITED TO FIRE PROTECTION, PLUMBING, VENTILATION AND PIPING.

- EXISTING CONDITIONS ARE SHOWN BASED ON INFORMATION OBTAINED FROM FIELD SURVEYS, EXISTING BUILDING DOCUMENTS, AND STAFF. VERIFY EXISTING CONDITIONS AND REPORT ANY CONFLICTS BEFORE PROCEEDING.

 2. NOT ALL EXISTING DUCTWORK AND PIPING IS SHOWN. VERIFY EXISTING CONDITIONS.
- REPORT ANY CONFLICTS BEFORE PROCEEDING.
 NOT ALL EXISTING DUCTWORK AND PIPING IS SHOWN. VERIFY EXISTING CONDITIONS BEFORE STARTING WORK. NOTIFY ENGINEER OF ANY CONFLICTS WITH NEW WORK.
 FIELD VERIFY THE AVAILABLE CLEARANCES FOR DUCTWORK AND PIPING BEFORE FABRICATION. RISES AND DROPS MAY BE NECESSARY BECAUSE OF EXISTING FIELD

CONDITIONS.

- 4. THE CONSTRUCTION MANAGER SHALL FIELD VERIFY ACCESSIBILITY TO THE AREA OF THEIR WORK AND SHALL NOTIFY THE ARCHITECT/ENGINEER PRIOR TO BIDDING IF OTHER UTILITIES ARE REQUIRED TO BE REMOVED OR RELOCATED TO ALLOW ACCESS TO THEIR AREA OF WORK.
- WITH THEIR WORK.

 6. THE CONSTRUCTION MANAGER IS RESPONSIBLE FOR REMOVAL AND REPLACEMENT OF CEILINGS, CEILING TILES, AND CEILING GRIDS ASSOCIATED WITH AREAS OF WORK BY ALL

5. EACH CONTRACTOR SHALL CUT AND PATCH ROOFS, WALLS, AND FLOORS ASSOCIATED

- CONTRACTORS.

 7. WHERE EXISTING MECHANICAL SYSTEMS ARE LOCATED IN AREAS THAT CONFLICT WITH NEW EQUIPMENT, PIPING, OR DUCTWORK TO BE INSTALLED, EACH CONTRACTOR SHALL EITHER ARRANGE NEW EQUIPMENT, PIPING, OR DUCTWORK IN SUCH A FASHION THAT IT
- DOES NOT CONFLICT WITH EXISTING SYSTEMS, OR REWORK EXISTING MECHANICAL SYSTEMS TO ALLOW FOR INSTALLATION OF NEW EQUIPMENT, PIPING, OR DUCTWORK.

 8. PROVIDE TEMPORARY CONNECTIONS TO MAINTAIN EXISTING SYSTEMS IN SERVICE DURING CONSTRUCTION. MAINTAIN ACCESS TO EXISTING MECHANICAL INSTALLATIONS THAT
- CONSTRUCTION. MAINTAIN ACCESS TO EXISTING MECHANICAL INSTALLATIONS THAT REMAIN ACTIVE.

 9. OBTAIN PERMISSION FROM OWNER BEFORE SHUTTING DOWN ANY SYSTEM FOR ANY REASON. MAINTAIN SERVICE TO ALL COMPONENTS THAT ARE TO REMAIN UNTIL NEW
- SYSTEMS ARE INSTALLED.

 10. DISCONNECT AND REMOVE MECHANICAL DEVICES AND EQUIPMENT SERVING EQUIPMENT THAT HAS BEEN REMOVED.

FIRE PROTECTION GENERAL NOTES:

- THE SYMBOLS AND THE MATERIAL LIST ARE FOR THE CONVENIENCE OF THE CONTRACTOR. CONTRACTOR SHALL VERIFY QUANTITIES AND FURNISH ALL MATERIALS REQUIRED FOR FULLY OPERATIONAL SYSTEMS, WHETHER SPECIFIED OR NOT.
 CATALOG NUMBERS SHALL NOT BE CONSIDERED COMPLETE, BUT ARE GIVEN AS AN AID TO THE CONTRACTOR AND TO INDICATE THE QUALITY REQUIRED. CONTRACTOR IS RESPONSIBLE FOR COMPLETE DESCRIPTION OF MATERIAL ON THESE DRAWINGS AND IN THE SPECIFICATIONS BEFORE ORDERING. THE DESCRIPTION OF THE MATERIAL TAKES PRECEDENCE OVER THE CATALOG NUMBER. THE FIRST MANUFACTURER IS THE
- RESPONSIBLE FOR COMPLETE DESCRIPTION OF MATERIAL ON THESE DRAWINGS AND IN THE SPECIFICATIONS BEFORE ORDERING. THE DESCRIPTION OF THE MATERIAL TAKES PRECEDENCE OVER THE CATALOG NUMBER. THE FIRST MANUFACTURER IS THE BASIS OF DESIGN.

 3. CENTER SPRINKLERS IN CEILING TILES IN BOTH DIRECTIONS IN ALL AREAS. IN AREAS WITH 2'X4' CEILING TILES CENTERING USING A 2'X2' CEILING PATTERN IS ACCEPTABLE.
- SPRINKLER HEADS SHALL BE ALIGNED WITH OTHER SPRINKLER HEADS, LIGHTING, DIFFUSERS, AND ANY OTHER FEATURES IN THE CEILING.

 4. NEW SPRINKLERS SHALL BE QUICK RESPONSE TYPE, UNLESS OTHERWISE NOTED.
- CONTRACTOR SHALL NOT MIX STANDARD RESPONSE SPRINKLERS WITH QUICK RESPONSE SPRINKLERS IN UNPARTITIONED SPACES.

 5. THE FIRE PROTECTION SYSTEM SHALL BE DESIGNED TO MEET OWNER'S INSURANCE
- COMPANY STANDARDS WHERE APPLICABLE. THE MORE STRINGENT OF THE OWNER'S INSURANCE UNDERWRITER'S DESIGN CRITERIA AND THE NFPA STANDARDS SHALL BE USED.
- WHERE FEASIBLE INSTALL PIPES HIGH AS POSSIBLE TO AVOID CONFLICT WITH OTHER DISCIPLINES, AND TO REDUCE THE AMOUNT OF REQUIRED ROD STIFFENER SUPPORTS.
 FOLLOW STRUCTURAL DETAILS WHEN PENETRATING OR PASSING THROUGH
- STRUCTURAL ELEMENTS. ALTERNATE DESIGNS WILL NEED TO BE APPROVED THROUGH THE STRUCTURAL ENGINEER.

 8. FINAL HEAD LOCATION, TYPE AND FINISH SHALL BE REVIEWED AND APPROVED BY THE
- ARCHITECT.

 9. THE OWNER MUST BE NOTIFIED PRIOR TO EACH AND EVERY DRAINING OR RECHARGING OF THE SPRINKLER SYSTEM.

 10. THE CONTRACTOR SHALL PREPARE A COORDINATED SET OF SHOP DRAWINGS AND
- SHALL OBTAIN APPROVAL FROM THE AUTHORITIES HAVING JURISDICTION AND THE LOCAL FIRE DEPARTMENT PRIOR TO ANY INSTALLATION.

 11. VERIFY ALL DIMENSIONS AND CLEARANCES FROM ARCHITECTURAL, STRUCTURAL, SUBMITTALS, AND OTHER APPROPRIATE DRAWINGS OR PHYSICALLY AT SITE. REVIEW

ALL DRAWINGS, INCLUDING THOSE OF OTHER TRADES.

MECHANICAL GENERAL NOTES:

THESE NOTES APPLY TO ALL MECHANICAL SHEETS AND TRADES, INCLUDING BUT NOT LIMITED TO, FIRE PROTECTION, PLUMBING, VENTILATION, PIPING AND TEMPERATURE CONTROL.

- DRAWINGS SHOWING LOCATIONS OF EQUIPMENT, DUCTWORK, PIPING, ETC. ARE DIAGRAMMATIC AND MAY NOT ALWAYS REFLECT EXACT INSTALLATION CONDITIONS. DRAWINGS SHOW THE GENERAL ARRANGEMENT OF DUCTWORK, PIPING, EQUIPMENT, ETC., AND MAY NOT INCLUDE ALL OFFSETS AND FITTINGS REQUIRED FOR COMPLETE INSTALLATION. THE DRAWINGS SHALL BE FOLLOWED AS CLOSELY AS ACTUAL BUILDING
- INSTALLATION. THE DRAWINGS SHALL BE FOLLOWED AS CLOSELY AS ACTUAL BUILDING CONSTRUCTION AND THE WORK OF OTHERS WILL PERMIT.

 DO NOT SCALE DRAWINGS. VERIFY ALL DIMENSIONS AND CLEARANCESFROM ARCHITECTURAL, STRUCTURAL, SUBMITTALS, AND OTHER APPROPRIATE DRAWINGS OR
- PHYSICALLY AT SITE. REVIEW ALL DRAWINGS, INCLUDING THOSE OF OTHER TRADES.

 3. COORDINATE ALL WORK WITH ALL OTHER TRADES PRIOR TO INSTALLATION TO PROVIDE CLEARANCES REQUIRED FOR OPERATION, MAINTENANCE, CODE COMPLIANCE, AND TO VERIFY NON-INTERFERENCE WITH OTHER WORK. DO NOT FABRICATE PRIOR TO VERIFICATION OF NECESSARY CLEARANCES FOR ALL TRADES. BRING ANY INTERFERENCES OR CONFLICTS TO THE ATTENTION OF THE ARCHITECT/ENGINEER BEFORE PROCEEDING WITH FABRICATION OR EQUIPMENT ORDERS.
- 4. REVIEW SPACE REQUIREMENTS OF EQUIPMENT SPECIFIED OR SUBSTITUTED AND MAKE REASONABLE ACCOMMODATIONS IN LAYOUT AND POSITIONING TO PROVIDE PROPER
- ACCESS.
 5. ANY CHANGES REQUIRED TO ELIMINATE CONFLICTS OR THAT RESULT FROM A FAILURE TO COORDINATE SHALL BE MADE BY THE CONTRACTOR WITHOUT ADDITIONAL COST OR
- EXPENSE TO OTHERS.

 6. EACH CONTRACTOR IS RESPONSIBLE FOR ALL COSTS ASSOCIATED WITH ELECTRICAL CHANGES REQUIRED FOR EQUIPMENT PROPOSED THAT DIFFERS FROM THE BASIS OF
- DESIGN.
 7. REFER TO ARCHITECTURAL REFLECTED CEILING PLAN, ELECTRICAL, TECHNOLOGY AUDIO/VISUAL, AND OTHER MECHANICAL PLANS FOR EXACT LOCATIONS OF ALL CEILING
- MOUNTED DEVICES, OTHER THAN SPRINKLERS.

 8. EACH CONTRACTOR IS RESPONSIBLE FOR DAMAGE CAUSED BY THEIR ACTIONS TO WALLS, FLOORS, CEILINGS, AND ROOFS. THE CONTRACTOR WHOSE WORK CAUSES DAMAGE IS RESPONSIBLE FOR PATCHING TO MATCH ORIGINAL CONSTRUCTION, FIRE RATING, AND
- 9. SEAL ALL FLOOR AND WALL AIRTIGHT WHERE CONDUITS, PIPING, AND DUCTS PENETRATE.
 PENETRATIONS THROUGH EXTERIOR WALLS AND ROOF SHALL BE SEALED AIRTIGHT WITH
- WATERPROOFING MATERIALS RECOMMENDED BY MANUFACTURER FOR OUTDOOR USE.

 10. CAULK ALL PIPE AND DUCT PENETRATIONS OF FULL HEIGHT NON-FIRE RATED WALL,
 PARTITION, FLOOR, AND ROOF ASSEMBLIES. THIS IS ESSENTIAL TO PREVENT NOISE
 TRANSMISSION FROM ONE ROOM TO ANOTHER AND TO PROVIDE THE DESIRED NC LEVELS
 WITHIN ROOMS.

 11. DO NOT BLOCK TUBE PULL OR EQUIPMENT SERVICE CLEARANCES.
- 12. DO NOT EXCEED 25 LBS PER HANGER AND A MINIMUM SPACING OF 2'-0" ON CENTER WHEN ATTACHING TO METAL ROOF DECKING (LIMITATION NOT REQUIRED WITH CONCRETE ON METAL DECK). THIS 25 LBS. LOAD AND 2'-0" SPACING INCLUDE ADJACENT ELECTRICAL AND ARCHITECTURAL ITEMS HANGING FROM DECK. IF THE HANGER RESTRICTIONS CANNOT BE ACHIEVED, SUPPLEMENTAL FRAMING OFF STEEL FRAMING SHALL BE ADDED. ANCHORS EMBEDDED IN CONCRETE SHALL BE CRACKED CONCRETE APPROVED IN ACCORDANCE WITH SPECIFICATIONS.

F	IRE PROTECTION SHEET INDEX
-0.00	FIRE PROTECTION COVERSHEET
D1.01	OVERALL DEMOLITION PLANS - FIRE PROTECTION
1.00	OVERALL FLOOR PLANS - FIRE PROTECTION
2.00	FIRE PROTECTION DETAILS AND SCHEDULES
GRAND TOTAL: 4	



ARCHITECT OF RECORD

DEMONICA KEMPER ARCHITECTS
125 N. HALSTED STREET, SUITE 301
CHICAGO, IL 60661
P: 312.496.0000

S / MEP / FP / T ENGINEERS: IMEG CORP. 253 SHUMAN BOULEVARD, SUITE 550 NAPERVILLE, IL 60563 P: 630.527.2320

Henry County College LTH SCIENCE 2024 RENOVAT

SHEET STATUS: 02/18/2025
ISSUED FOR BID - NOT

PROFESSIONAL

02/18/2025

KEY PLAN:

NO: DESCRIPTION: DATE:

SHEET TITLE:

FIRE PROTECTION

COVERSHEET

SHEET NUMBER:

F0.00

2/17/2025 10:26:06 AM

263 SHUMAN BOULEVARD SUITE 550 NAPERVILLE, IL 60563 P: 630.527.2320

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McHenry County College HEALTH SCIENCE 2024 RENOVA

EXP 11/30/2025 02/18/2025 KEY PLAN:

SHEET STATUS: **ISSUED FOR BID - NOT** FOR CONSTRUCTION

SHEET TITLE:

OVERALL DEMOLITION PLANS -FIRE PROTECTION

SHEET NUMBER:

FD1.01 2/17/2025 10:26:06 AM



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McHenry County College HEALTH SCIENCE 2024 RENOVA

EXP 11/30/2025 02/18/2025 KEY PLAN:

SHEET STATUS: **ISSUED FOR BID - NOT**

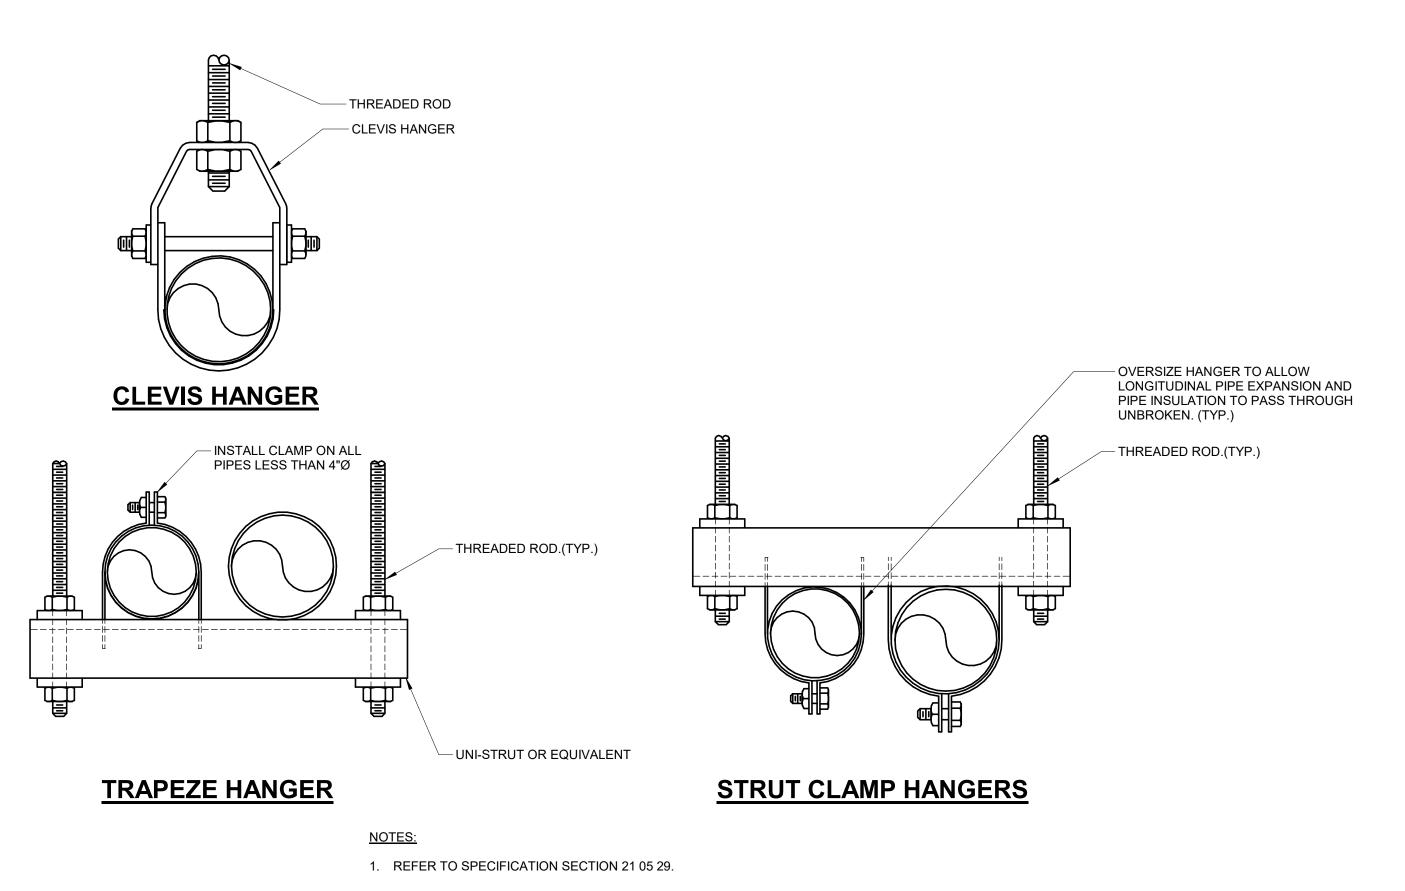
FOR CONSTRUCTION

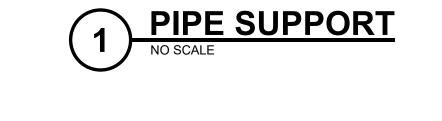
SHEET TITLE:

OVERALL FLOOR PLANS - FIRE **PROTECTION**

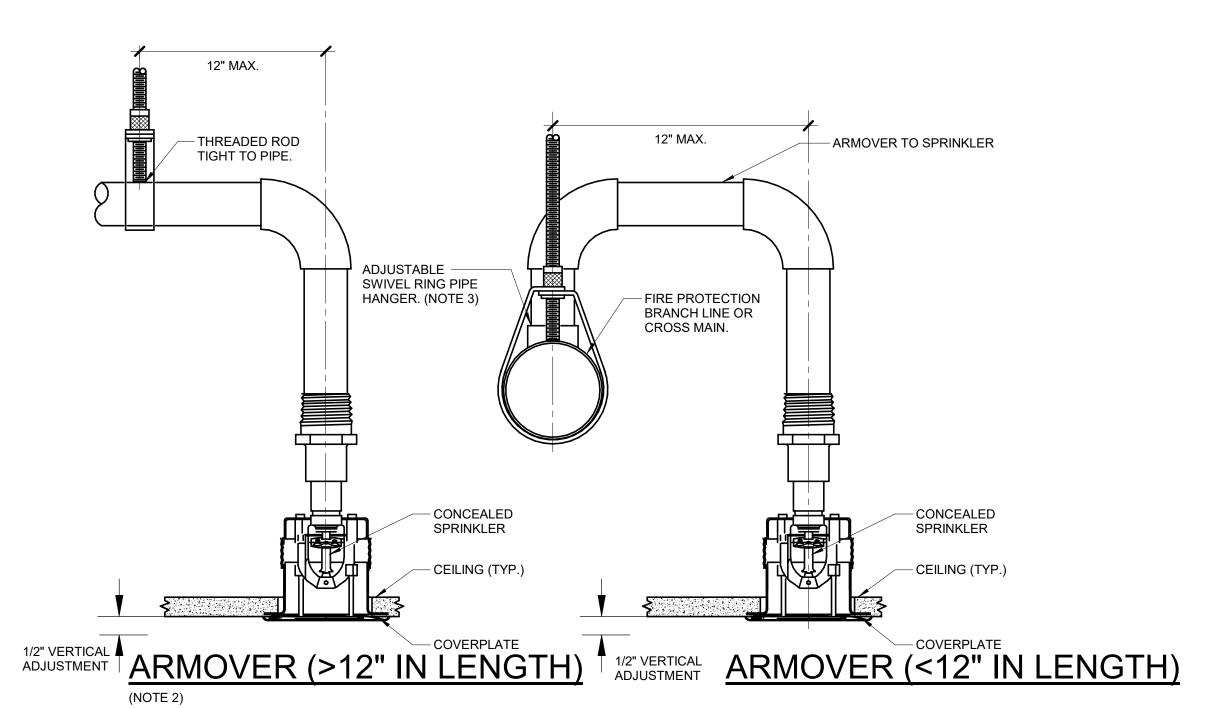
SHEET NUMBER:

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AREAS ARE GENERAL IN N							HE DRAWINGS. CONTRACTOR TO SUBMIT ALI	L SPRINKLER TYPES TO
			SPRIN	IKLER				
ADEA TVDE	AREA	TAG NAME	SPRINKLER	RESPONSE		TEMPERATURE	MANUFACTURER & MODEL	NOTES
AREA TYPE (NOTE 1 & 6)	HAZARD	(NOTE 4 & 5)	TYPE	CATEGORY	FINISH	RATING	INIANUTACI UKEK & MUDDEL	NOTES
(NOTE 1 & 6)		(NOTE 4 & 5) SPR-1	TYPE PENDENT	QUICK	ROUGH BRASS	155	VIKING VK, RELIABLE F1FR, TYCO TY-FRB, VICTAULIC V2708	NOTE 3
(NOTE 1 & 6) EXPOSED STRUCTURE WITH	HAZARD	` ,			ROUGH	155 155	VIKING VK, RELIABLE F1FR, TYCO TY-FRB,	



- 1. THIS DETAIL APPLIES TO SPRINKLER PIPES ABOVE CEILING THAT SUPPLY CONCEALED SPRINKLERS BELOW CEILINGS WHERE THE WATER PRESSURE
- EXCEEDS 100 PSIG (STATIC OR RESIDUAL). 2. ALSO APPLIES TO ARMOVER WHERE CUMULATIVE HORIZONTAL LENGTH IS
- 3. CLEVIS HANGERS AND ADJUSTABLE SWIVEL RING HANGERS WITH SURGE SUPPRESSOR OR RESTRAINING CLIP ARE ALSO ACCEPTABLE, SEE NFPA 13.
- 4. END-OF-LINE SPRINKLER CONNECTIONS ARE NOT ALLOWED. THE END OF A HORIZONTAL SPRINKLER BRANCH MUST BE CAPPED. ALL CONNECTIONS TO A SPRINKLER BRANCH MUST BE ARMOVER CONNECTIONS.

CONCEALED SPRINKLER PIPE DETAIL
NO SCALE



ARCHITECT OF RECORD DEMONICA KEMPER ARCHITECTS 125 N. HALSTED STREET, SUITE 301 **CHICAGO, IL 60661** P: 312.496.0000

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NO: DESCRIPTION: DATE:

SHEET TITLE: FIRE PROTECTION

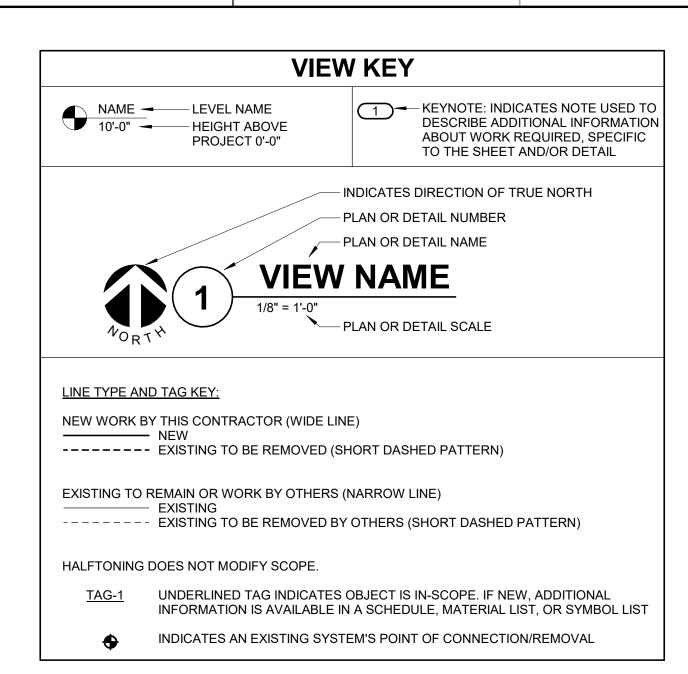
DETAILS AND SCHEDULES

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REF. SCALE IN INCHES PROJECT #24007530.00



ELECTRICAL SYMBOL LIST				
SYMBOL:	TAG:	SPEC SECTION:	DESCRIPTION:	
шш(<u>ECONN</u>	26 05 33	ELECTRICAL CONNECTION	
	<u>JB</u>	26 05 33	JUNCTION BOX	
	PANEL '###'	26 24 16	PANELBOARD - SURFACE MOUNT	
	<u>CB-#</u>	26 28 16	CIRCUIT BREAKER. REFER TO DISC/STA SCHEDULE	
f	EPO	26 09 16	EMERGENCY STOP / POWER OFF (N.C. AND N.O CONTACT)	
DS	SW-1P-DJ	26 09 33	DOOR JAMB SWITCH	
		1	1	

	ELEC	TRICAL	SYMBOL LIST
SYMBOL:	TAG:	SPEC SECTION:	DESCRIPTION:
=	REC-DUP	26 27 26	DUPLEX TAMPER RESISTANT RECEPTACLE, 125V
₩	REC-DUP-GFI	26 27 26	DUPLEX TAMPER RESISTANT GFI RECEPTACLE, 125V
=₩	REC-QUAD	26 27 26	QUAD TAMPER RESISTANT RECEPTACLE, 125V

	ELEC	CTRICAL	SYMBOL LIST
SYMBOL:	TAG:	SPEC SECTION:	DESCRIPTION:
(S)	<u>FA-120</u>	28 31 00	FIRE ALARM SMOKE DETECTOR, CEILING MOUNT
FX EX	<u>FA-221</u>	28 31 00	COMBINATION AUDIO (HORN) AND VISUAL ALARM DEVICE, CEILING OR WALL MOUNTED
# \(\Omega	<u>FA-200</u>	28 31 00	# = CANDELA RATING FIRE ALARM VISUAL ALARM DEVICE, CEILING MOUNT # = CANDELA RATING.

CONTRACTOR ABBREVIATION KEY			
ABBR:	DESCRIPTION:		
E.C.	ELECTRICAL CONTRACTOR		
M.C.	MECHANICAL CONTRACTOR		
P.C.	PLUMBING CONTRACTOR		
T.C.	TECHNOLOGY CONTRACTOR		

ELECTRICAL ABBREVIATION KEY

CONDUIT (BRANCH CIRCUIT OR FEEDER CONTEXT)

EQUIPMENT GROUNDING CONDUCTOR

ABBR: DESCRIPTION:

ABOVE FINISHED FLOOR

NORMALLY CLOSED

NOT IN CONTRACTED SCOPE

UNLESS OTHERWISE NOTED

NEMA RATING

NORMALLY OPEN

TYPICAL

ABV

AFF

EGC

NEMA#

UON

	ELEC	CTRICAL	SYMBOL LIST
SYMBOL:	TAG:	SPEC SECTION:	DESCRIPTION:
(S)	<u>FA-120</u>	28 31 00	FIRE ALARM SMOKE DETECTOR, CEILING MOUNT
	<u>FA-221</u>	28 31 00	COMBINATION AUDIO (HORN) AND VISUAL ALARM DEVICE, CEILING OR WALL MOUNTED
			# = CANDELA RATING
# \	<u>FA-200</u>	28 31 00	FIRE ALARM VISUAL ALARM DEVICE, CEILING MOUNT
			#= CANDELA RATING.

CONDUIT INSTALLATION SCHEDULE			
THE FOLLOWING SCHEDULE SHALL BE ADHERED TO UNLESS THEY CONST CODES OR ARE NOTED OTHERWISE ON THE DRAWINGS. THE INSTALLATIO PERMITTED IN PLACE OF ALL CONDUIT SPECIFIED IN THIS SCHEDULE. REF SPECIFICATION 26 05 33 FOR ADDITIONAL INFORMATION.	N OF RMC CC	NDUIT WILL	BE
INSTALLATION TYPE	RMC	IMC	EMT
BRANCH CIRCUITS: LIGHTING, RECEPTACLES, CONTROLS, ETC.		Х	х
CONTROLS (LIGHTING, POWER, BUILDING AUTOMATION, ETC.)		х	х
WET AND DAMP LOCATIONS: (CONDUIT, BOXES, FITTINGS, INSTALLED AND EQUIPPED TO PREVENT WATER ENTRY)	х		
INTERIOR LOCATIONS WITH FINISHED CEILING AND WALLS: CONCEALED IN WALLS AND ABOVE FINISHED CEILINGS			х
INTERIOR LOCATIONS WITHOUT FINISHED CEILINGS: CONCEALED IN WALL, EXPOSED ABOVE CEILINGS		х	х

EXISTING INTERIOR LOCATIONS WITH FINISHED CEILINGS AND WALLS:

CONCEALED IN WALLS AND ABOVE FINISHED CEILING UNLESS

OTHERWISE NOTED

	ELEC	TRICAL	SYMBOL LIST
SYMBOL:	TAG:	SPEC SECTION:	DESCRIPTION:
<u></u>	SW-OC-D	26 09 33	OCCUPANCY SENSOR - DUAL TECHNOLOGY
(VC)	SW-VC-D	26 09 33	VACANCY SENSOR - DUAL TECHNOLOGY
s_v	SW-VS	26 09 33	SWITCH - VACANCY SENSOR WALL SWITCH
WC	<u>SW</u>	26 09 33	WALL CONTROL STATION

ELECTRICAL SYMBOL LIST				
SYMBOL:	TAG:	SPEC SECTION:	DESCRIPTION:	
			LINEAR LUMINAIRES	
	REFER TO L	UMINAIRE	TROFFER	
0	SCHED	DULE	DOWNLIGHT LUMINAIRE	
8			SINGLE FACE EXIT SIGN	

TAG:	DESCRIPTION:	RELATED SPECIFICATION
SPD-#	SURGE PROTECTION DEVICE	26 43 00
<u>WD-#</u>	WALL DUCT	26 05 38

	RECEPTACLE SUBSCRIPT KEY:
DEVICE KEY	
DEVICE₽	# = MOUNTING (IF APPLICABLE) 1 = CIRCUIT NUMBER
	*IF LABEL IS ORIENTED HORIZONTALLY A SLASH WILL SEPARATE THIS INFORMATION. EX: A / 1
A N	. MOUNTING SUBSCRIPT KEY: MOUNT AT +6" TO CENTERLINE ABOVE COUNTER OR BACKSPLASH MOUNT AT CEILING (DEVICE OR ROUGH-IN CONTEXT)

ELECTRICAL INSTALLATION NOTES:

- 1. THE COMPLETE INSTALLATION SHALL BE IN ACCORDANCE WITH THE ADA STANDARDS FOR
- 2. CIRCUIT NUMBERS ARE SHOWN FOR CIRCUIT IDENTIFICATION. CIRCUITING SHALL AGREE WITH NUMBERING ON THE PANEL PROVIDED. COMMON NEUTRALS MAY NOT BE USED FOR BRANCH CIRCUITS. BALANCE THE LOAD ON PANEL AS EVENLY AS POSSIBLE BETWEEN EACH
- 3. LIFE SAFETY BRANCH WIRING FOR FEEDERS AND BRANCH CIRCUITS SHALL BE ROUTED IN SEPARATE RACEWAY, JUNCTION BOXES, PULL BOXES, AND CABINETS. WIRING FOR EACH
- 4. FLUSH MOUNT ALL LIGHTING CONTROL DEVICES AT +42" FROM FLOOR (CENTERLINE DIMENSION), EXCEPT WHERE OTHERWISE NOTED.
- 5. FLUSH MOUNT ALL DUPLEX RECEPTACLES AND TECHNOLOGY OUTLETS AT +18" FROM FLOOR (CENTERLINE DIMENSION), EXCEPT WHERE OTHERWISE NOTED. RECEPTACLES AND OUTLETS MAY BE SURFACE MOUNTED WHEN CONDUIT IS SPECIFIED EXPOSED.

BRANCH SHALL BE INDEPENDENT FROM OTHER BRANCHES, INCLUDING THE NORMAL

- 6. ALL MATERIALS USED TO SEAL PENETRATIONS OF FIRE RATED WALLS AND FLOORS SHALL BE TESTED AND CERTIFIED AS A SYSTEM PER ASTM E814 STANDARDS FOR FIRE TESTS OF THROUGH-PENETRATION FIRESTOPS. REFER TO 26 05 03 FOR ADDITIONAL INFORMATION AND REQUIREMENTS SPECIFIC TO FIRESTOPPING.
- 7. INSTALL ALL WALL MOUNTED FIRE ALARM NOTIFICATION DEVICES AT 90" ABOVE FINISHED FLOOR OR 6" BELOW THE CEILING, WHICHEVER IS LOWER, EXCEPT WHERE OTHERWISE
- NOTED. HEIGHT SHALL BE MEASURED TO THE TOP OF THE DEVICE. 8. CONTRACTOR SHALL COORDINATE THE LOCATION OF ALL CEILING MOUNTED DEVICES AND EQUIPMENT WITH LUMINAIRES, SPRINKLER, AND CEILING DIFFUSERS. CENTER ALL DEVICES IN CEILING TILE PATTERN. SMOKE DETECTORS, CARBON MONOXIDE DETECTORS, AND OCCUPANCY/VACANCY SENSORS SHALL BE LOCATED NO CLOSER THAN 3 FEET TO AN AIR SUPPLY DIFFUSER OR RETURN GRILLE. CARBON MONOXIDE DETECTORS SHALL BE LOCATED 10 PLUS FT FROM FIRE PLACES, COOKING, AND SIMILAR FUEL-BURNING APPLIANCES.
- 9. CONTRACTOR SHALL VERIFY ALL FURNITURE, MODULAR FURNITURE, AND EQUIPMENT LOCATIONS WITH ARCHITECTURAL PLANS, ELEVATIONS, AND REVIEWED SHOP DRAWINGS. PRIOR TO MAKING THE ACTUAL ELECTRICAL INSTALLATION, THIS CONTRACTOR SHALL ADJUST RECEPTACLES, OUTLETS, OR CONNECTION LOCATIONS TO ACCOMMODATE FURNITURE AND/OR EQUIPMENT.
- 10. ELECTRICAL AND TECHNOLOGY EQUIPMENT SHALL BE MOUNTED TO AVOID IMPEDANCE OF, OPERATION OF, AND/OR ACCESS TO ELECTRICAL AND MECHANICAL EQUIPMENT. ALL MOUNTING OF ELECTRICAL AND TELECOMMUNICATIONS EQUIPMENT, ON EQUIPMENT SUPPLIED BY ANOTHER CONTRACTOR, SHALL BE APPROVED IN ADVANCE BY THE OTHER CONTRACTOR.
- 11. CONTRACTOR SHALL BE RESPONSIBLE FOR ALL OPENINGS REQUIRED IN WALLS. ALL OPENINGS SHALL BE REPAIRED TO MATCH EXISTING BY A QUALIFIED CONTRACTOR AT THE EXPENSE OF THIS CONTRACTOR. ALL CONDUITS THROUGH WALLS SHALL BE GROUTED OR
- 12. EACH CONTRACTOR IS RESPONSIBLE FOR DAMAGE CAUSED BY THEIR ACTIONS TO THE WALLS, FLOORS, CEILINGS, AND ROOFS. THE CONTRACTOR WHOSE WORK CAUSES DAMAGE IS RESPONSIBLE FOR PATCHING TO MATCH ORIGINAL CONSTRUCTION, FIRE RATING, AND
- 13. REFER TO ARCHITECTURAL REFLECTED CEILING PLAN, ELECTRICAL, TECHNOLOGY AUDIO/VISUAL, AND OTHER ELECTRICAL PLANS FOR EXACT LOCATIONS OF ALL CEILING MOUNTED DEVICES, OTHER THAN SPRINKLERS.
- 14. ELECTRICAL IDENTIFICATION. REFER TO SPECIFICATION SECTION 26 05 53 FOR COLOR/LABEL REQUIREMENTS FOR CONDUIT, BOX, CABLE/WIRE, AND EQUIPMENT.

ELECTRICAL RENOVATION NOTES:

- THESE NOTES APPLY TO ALL ELECTRICAL SHEETS AND TRADES, INCLUDING BUT NOT LIMITED TO, LIGHTING, POWER, FIRE ALARM, AND OTHER LOW VOLTAGE SYSTEMS. 1. EXISTING CONDITIONS ARE SHOWN BASED ON INFORMATION OBTAINED FROM FIELD SURVEYS, EXISTING BUILDING DOCUMENTS. CONTRACTOR SHALL REVIEW EXISTING CONDITIONS AND REPORT CONFLICTS.
- 2. NOT ALL EXISTING EQUIPMENT, LUMINAIRES, AND CONDUIT ARE SHOWN. CONTRACTOR SHALL REVIEW EXISTING CONDITIONS AND REPORT CONFLICTS.
- 3. CONTRACTOR SHALL REVIEW EXISTING CONDITIONS PRIOR TO FABRICATION OF CONDUIT RACKS, AND OTHER SYSTEMS. RISES AND DROPS MAY BE NECESSARY BECAUSE OF EXISTING FIELD CONDITIONS.
- 4. ELECTRICAL CONTRACTOR SHALL REVIEW EXISTING CONDITIONS TO VERIFY ACCESSIBILITY TO THE AREAS OF THEIR WORK INCLUDING WALLS, FLOOR, CEILINGS, CEILING TILES/GRID, AND ROOF. ELECTRICAL CONTRACTOR IS RESPONSIBLE TO PROVIDE CUTTING, REMOVAL, PATCHING, AND REINSTALLATION OF AFFECTED AREAS ASSOCIATED WITH THEIR WORK BY

COORDINATING WITH THE GENERAL CONTRACTOR OR QUALIFIED CONTRACTOR.

WHERE EXISTING ELECTRICAL SYSTEMS ARE LOCATED IN AREAS THAT CONFLICT WITH NEW EQUIPMENT, PIPING, OR DUCTWORK TO BE INSTALLED, EACH CONTRACTOR SHALL EITHER ARRANGE NEW EQUIPMENT, CONDUIT, OR DUCTWORK IN SUCH A FASHION THAT IT DOES NOT CONFLICT WITH EXISTING SYSTEMS, OR REWORK EXISTING ELECTRICAL SYSTEMS TO ALLOW FOR INSTALLATION OF NEW EQUIPMENT, PIPING, OR DUCTWORK.

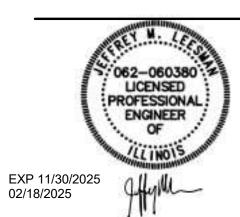
E0.00	ELECTRICAL COVERSHEET
E0.01	OVERALL CAMPUS PLAN - ELECTRICAL
E1.00	OVERALL FLOOR PLANS - ELECTRICAL
ED1.10	DEMOLITION PLANS - ELECTRICAL
E1.10	FLOOR PLANS - LIGHTING
E1.20	FLOOR PLANS - POWER
E1.30	FLOOR PLANS - SYSTEMS
E2.00	ELECTRICAL DETAILS
E3.00	ELECTRICAL ONE LINE DIAGRAM
E4.00	ELECTRICAL SCHEDULES



ARCHITECT OF RECORD **DEMONICA KEMPER ARCHITECTS** 125 N. HALSTED STREET, SUITE 301 **CHICAGO, IL 60661** P: 312.496.0000

S / MEP / FP / T ENGINEERS: IMEG CORP. 253 SHUMAN BOULEVARD, SUITE **550 NAPERVILLE, IL 60563** P: 630.527.2320





KEY PLAN:

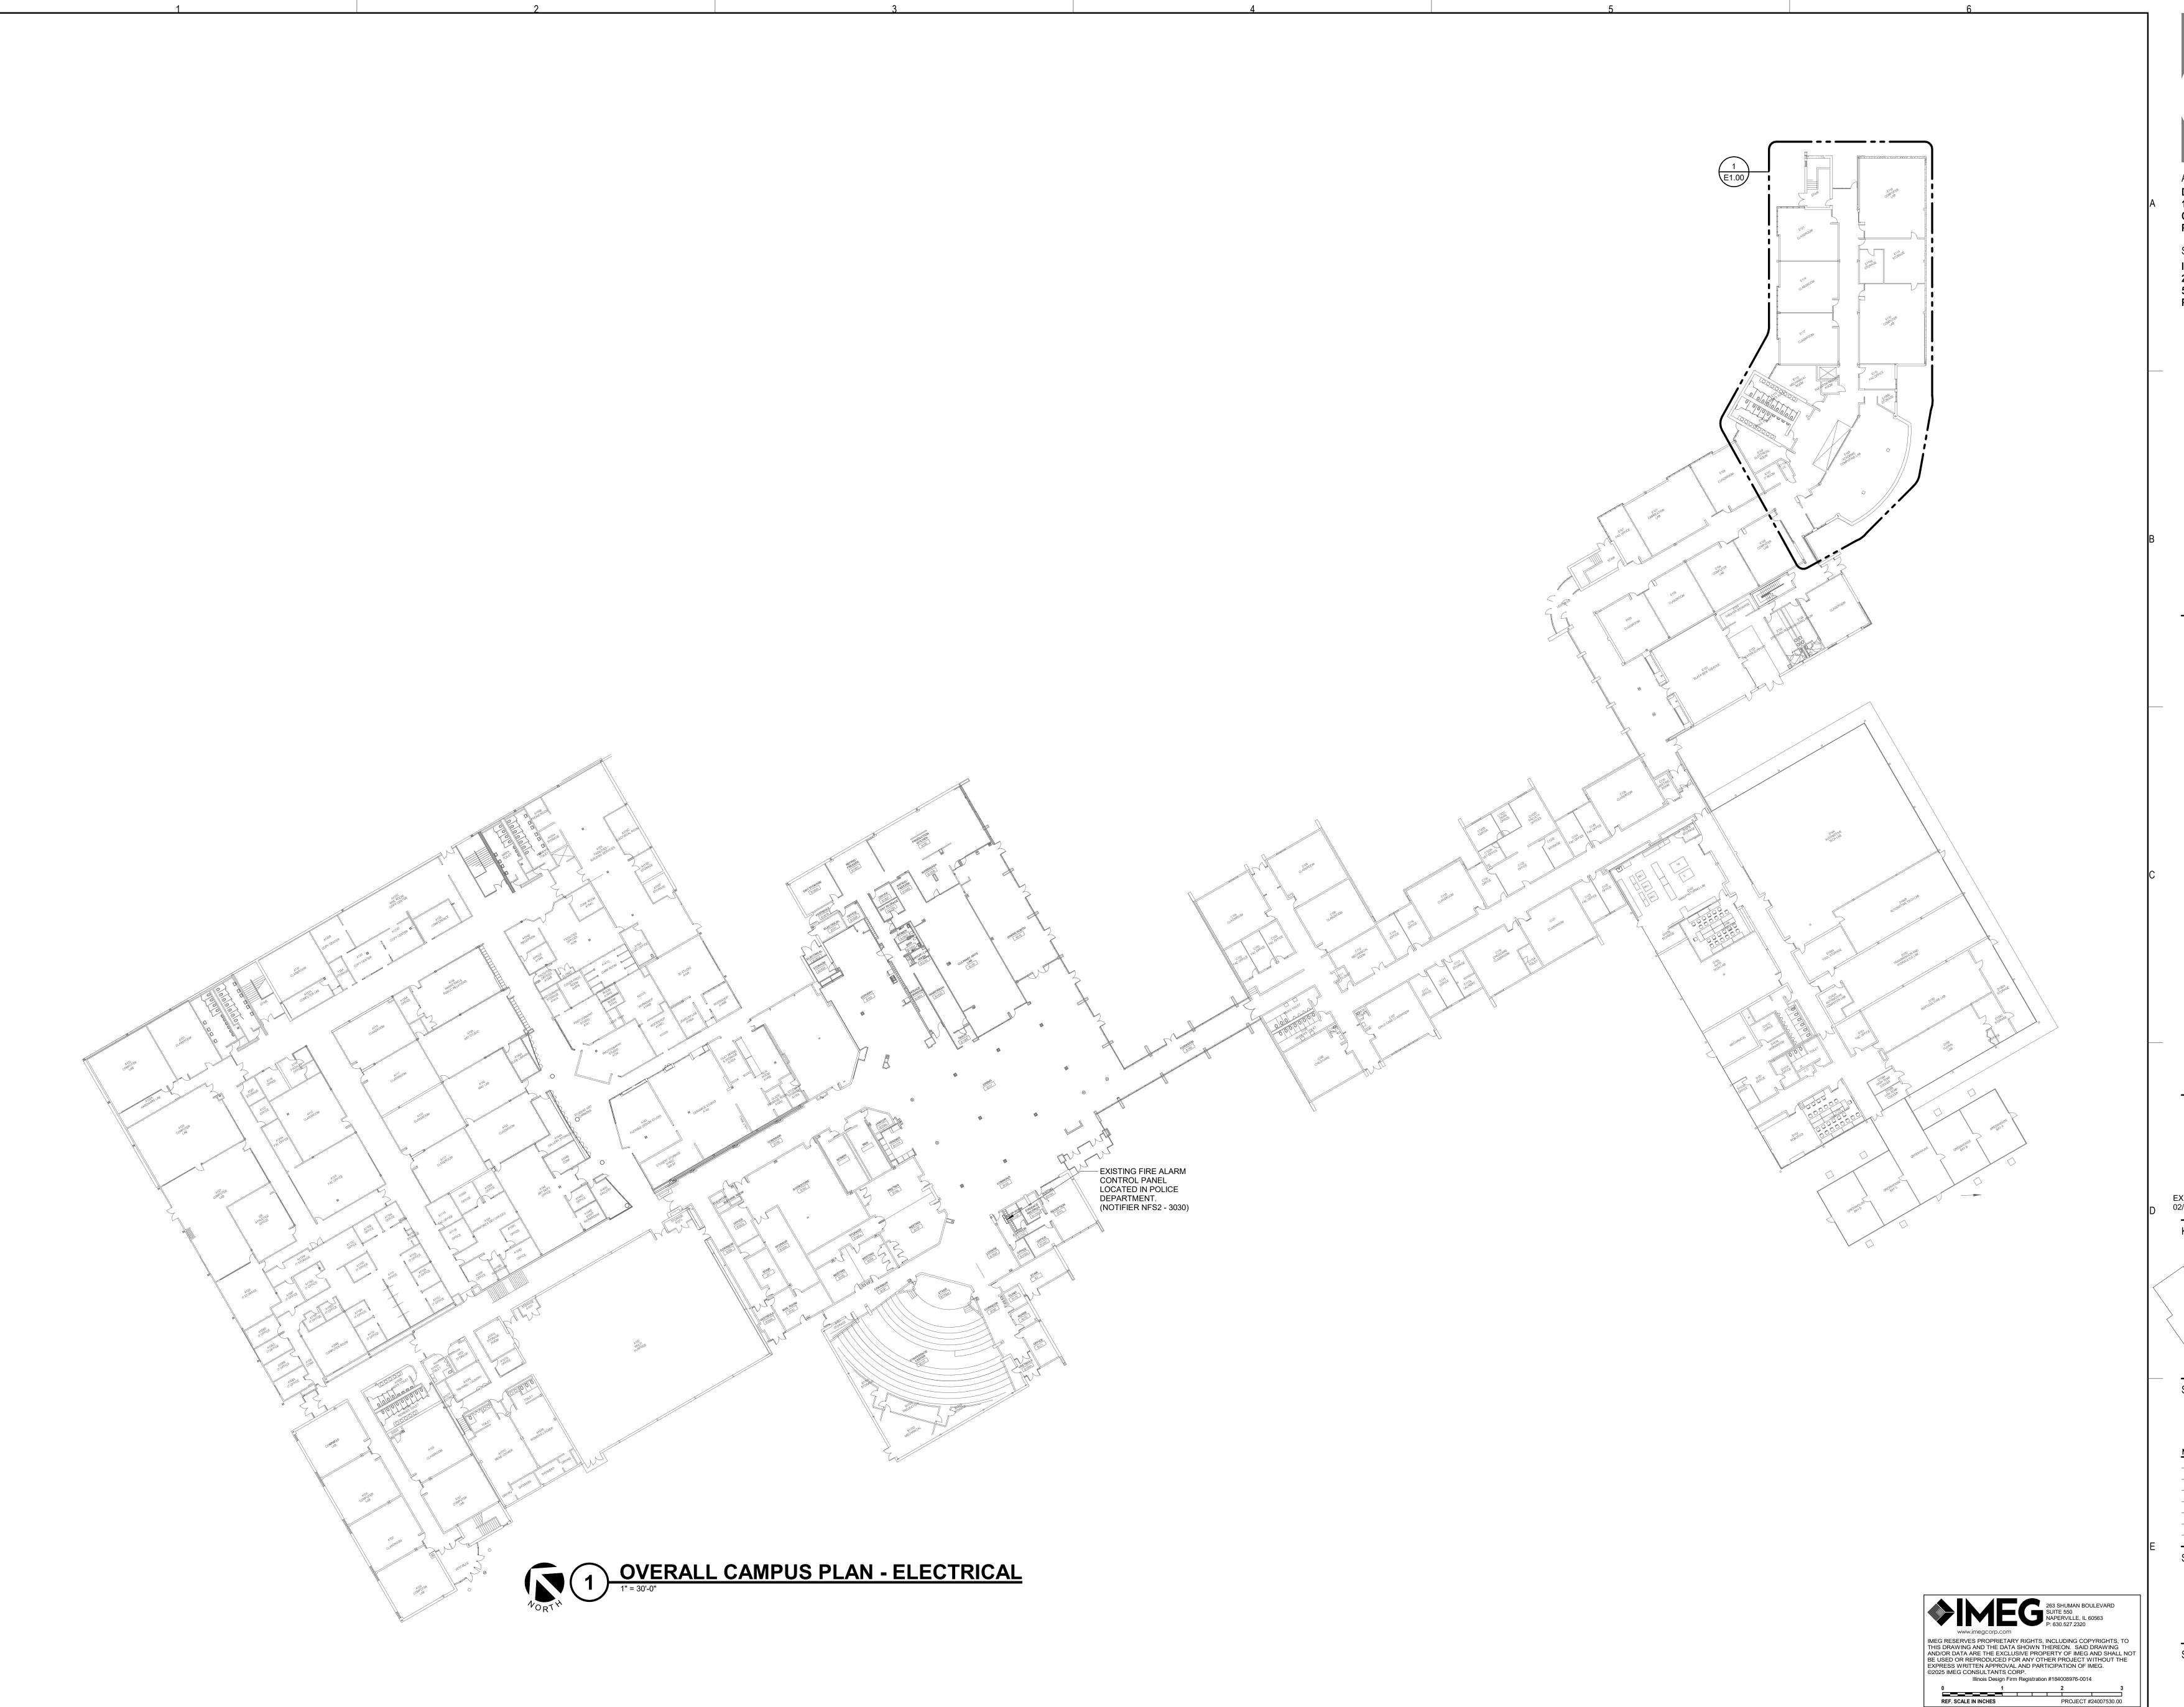
SHEET STATUS: **ISSUED FOR BID - NOT** FOR CONSTRUCTION

DESCRIPTION: DATE: SHEET TITLE:

> **ELECTRICAL** COVERSHEET

SHEET NUMBER:

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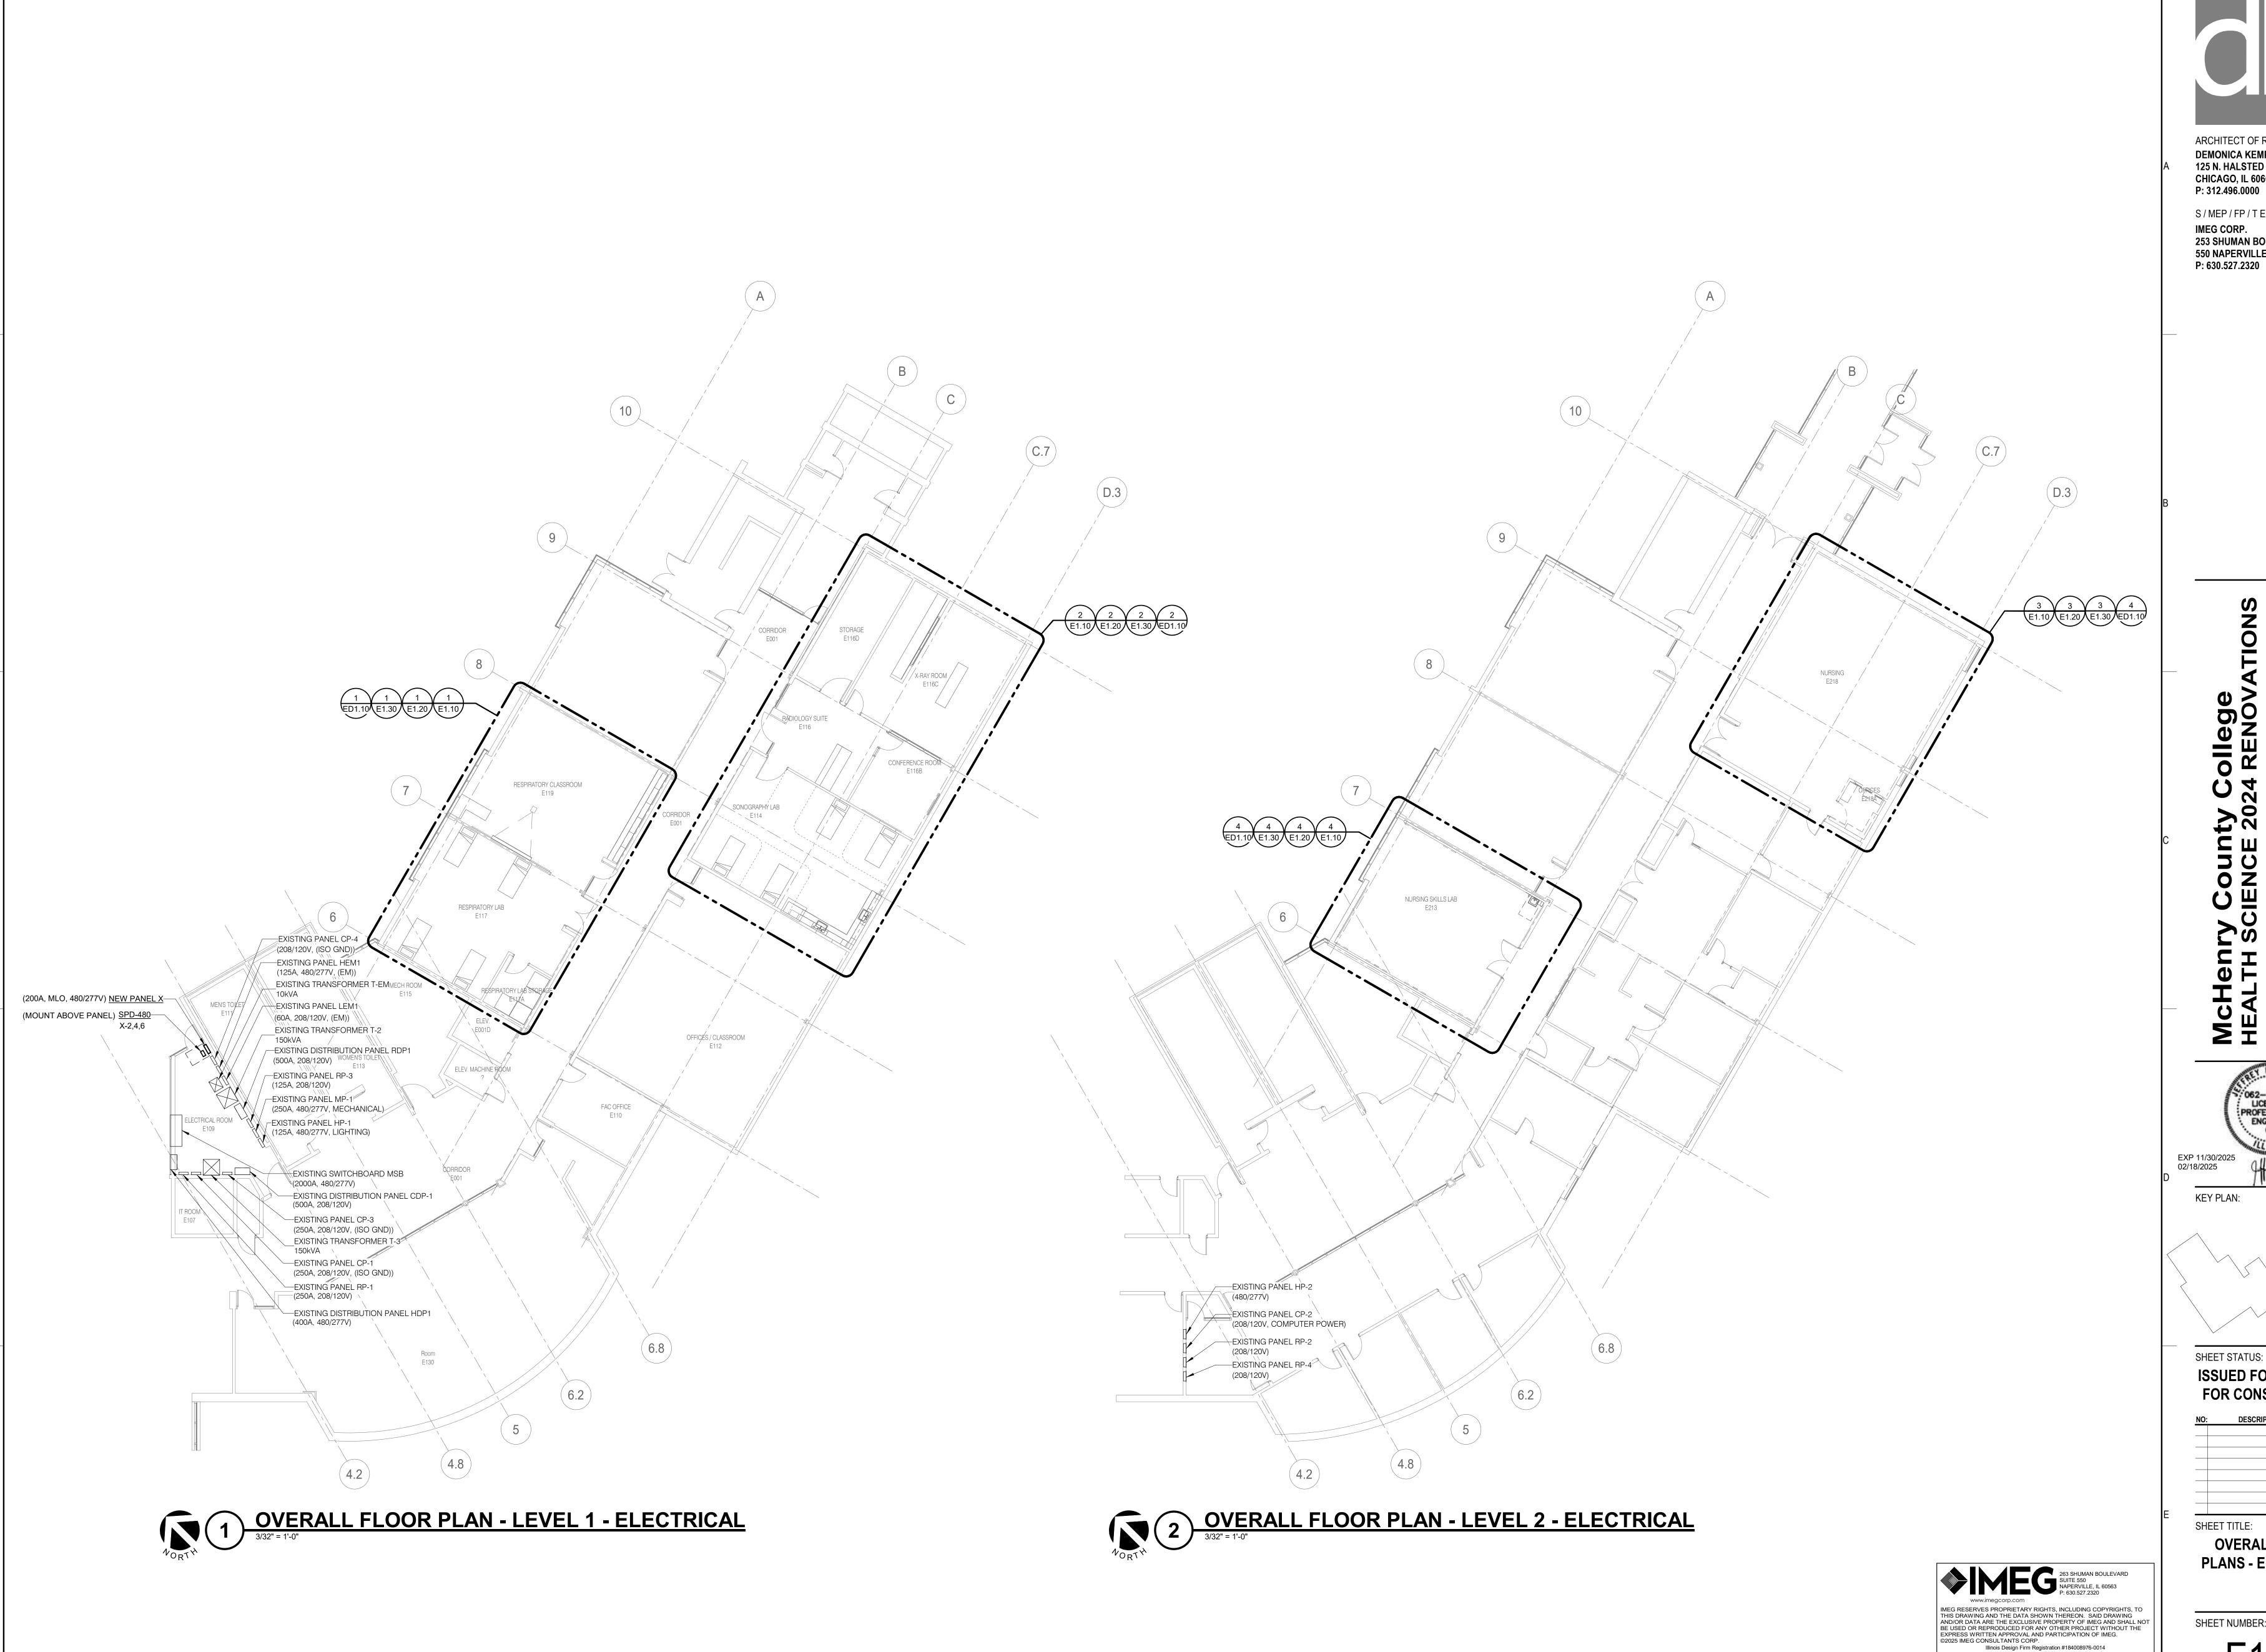
SHEET TITLE:

OVERALL CAMPUS PLAN - ELECTRICAL

SHEET NUMBER:

2/18/2025 11:15:48 AM

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NO: DESCRIPTION: DATE:

SHEET TITLE:

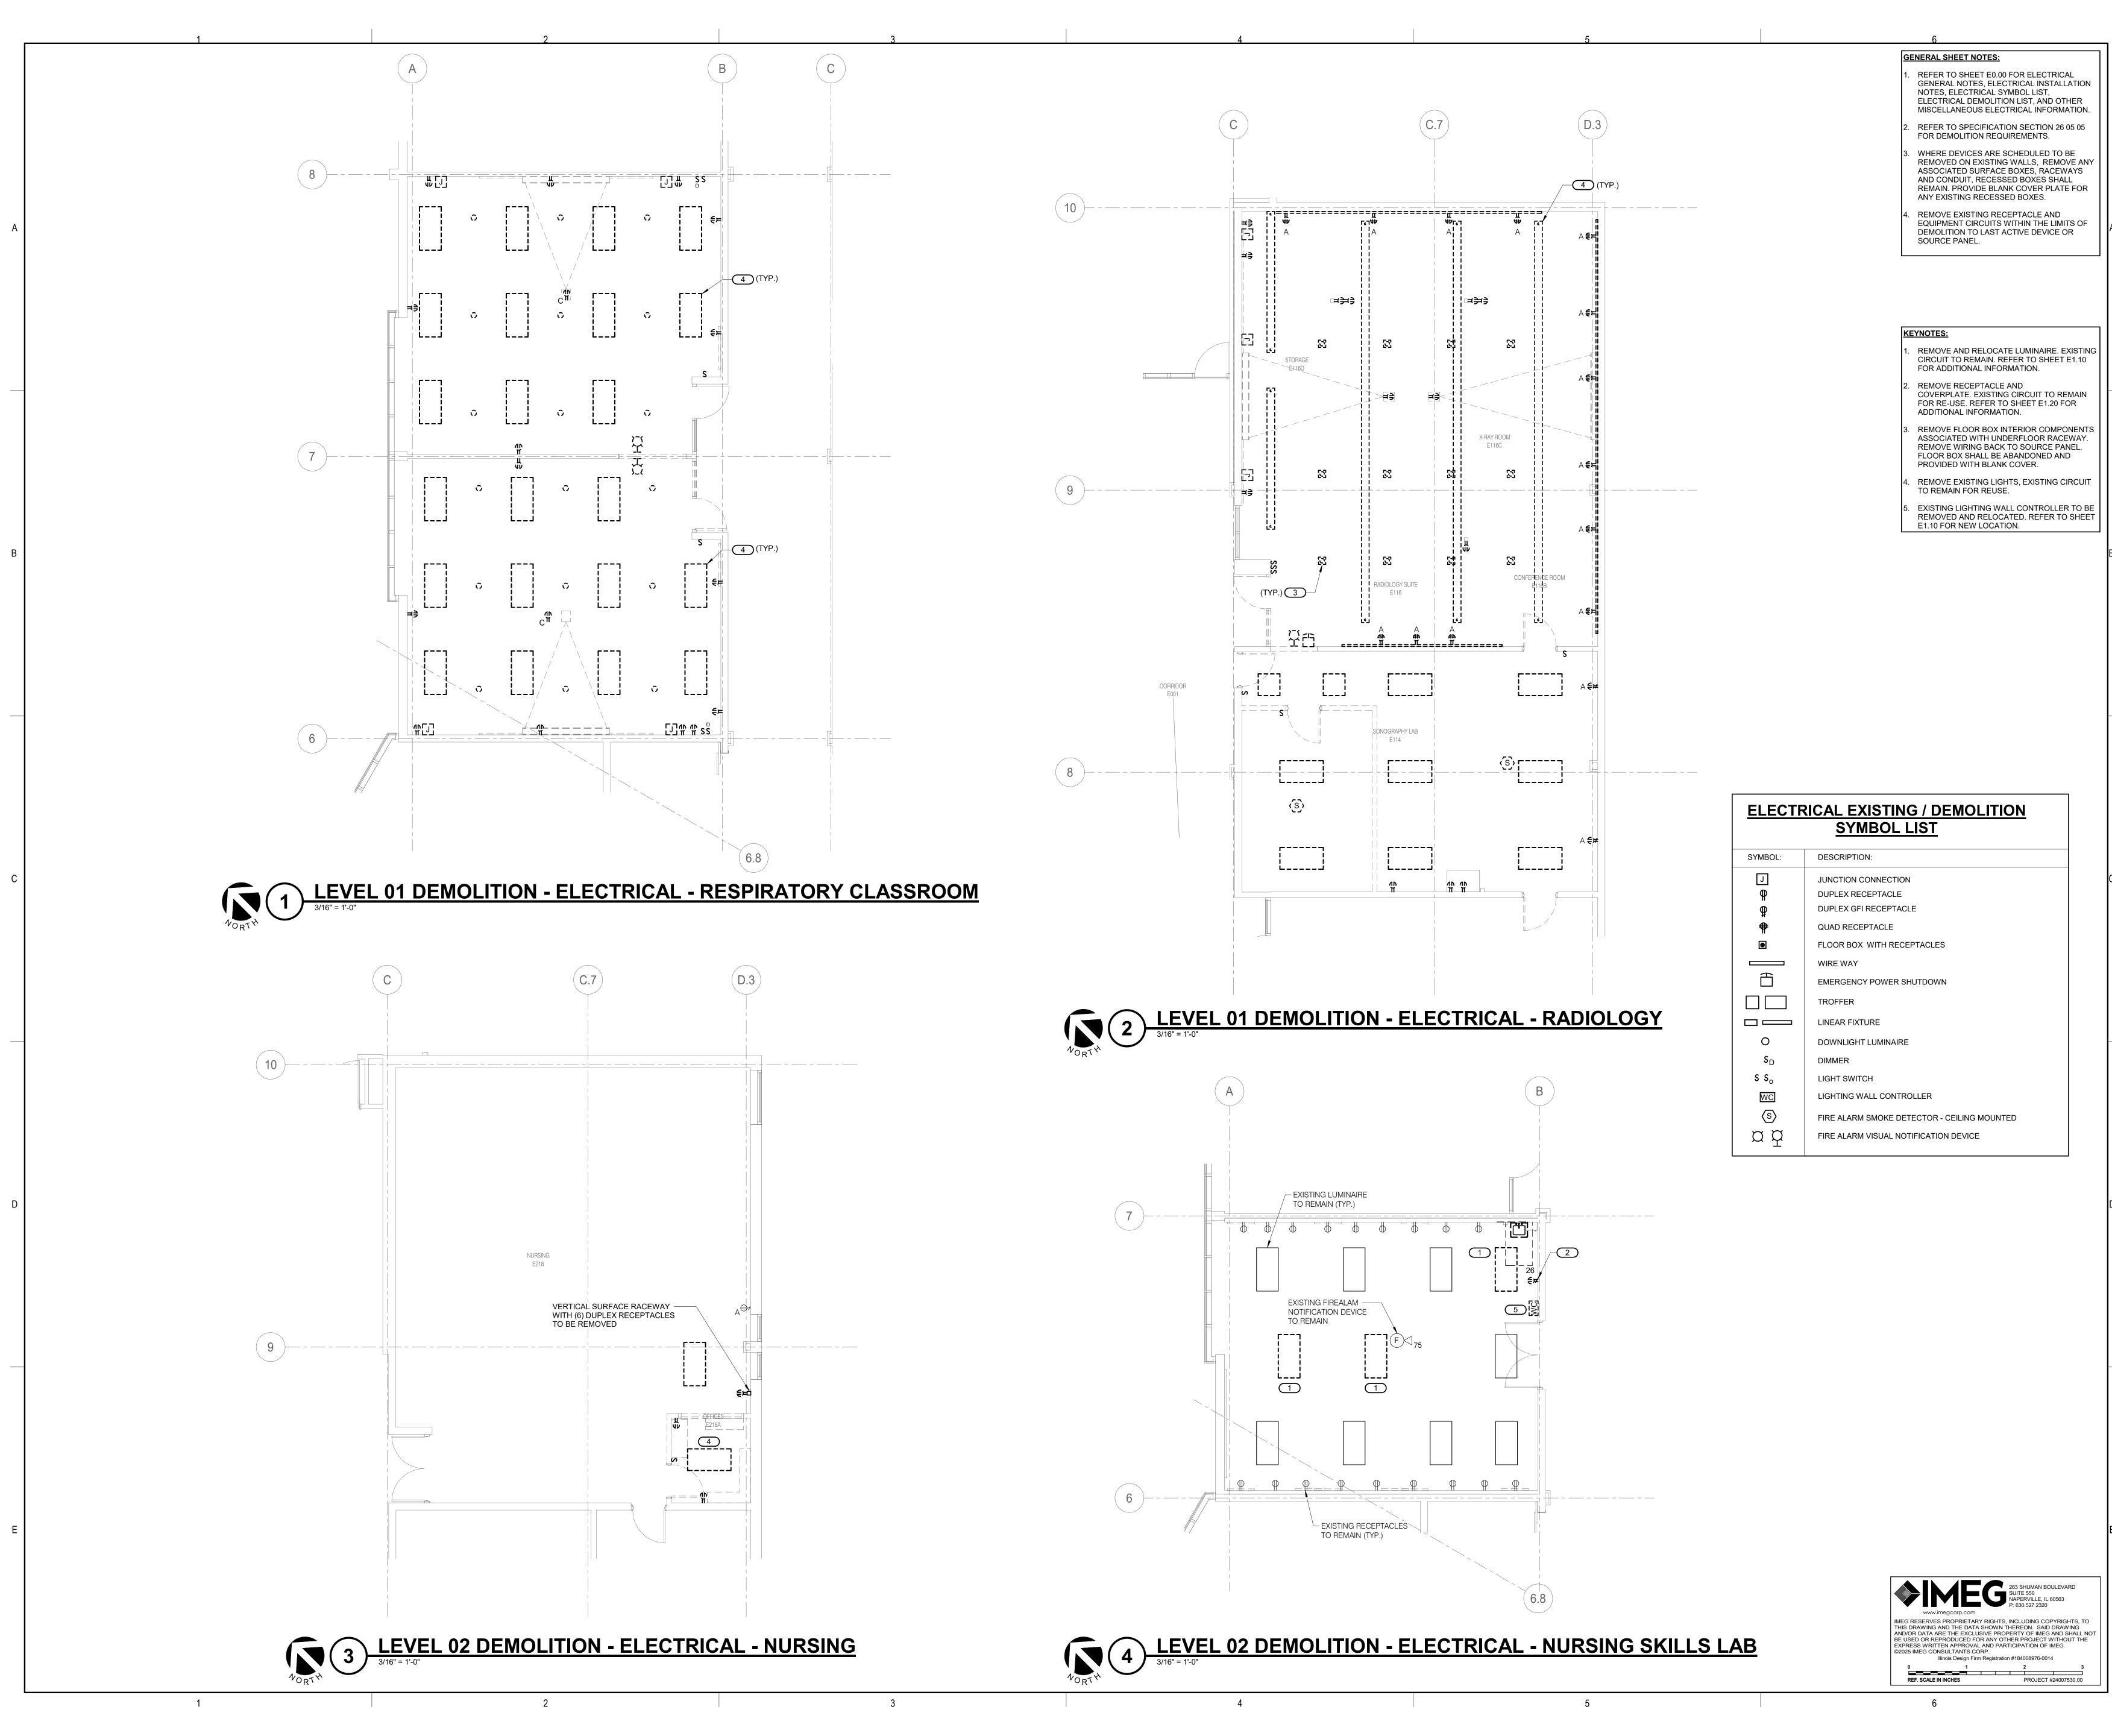
OVERALL FLOOR PLANS - ELECTRICAL

SHEET NUMBER:

E1.00 2/18/2025 11:15:51 AM

0 1 2 3

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550 NAPERVILLE, IL 60563
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ory County College

Science 2024 RENOVATIO

EXP 11/30/2025 02/18/2025 KEY PLAN:

SHEET STATUS: 02/18/2025
ISSUED FOR BID - NOT FOR CONSTRUCTION

NO: DESCRIPTION: DATE:

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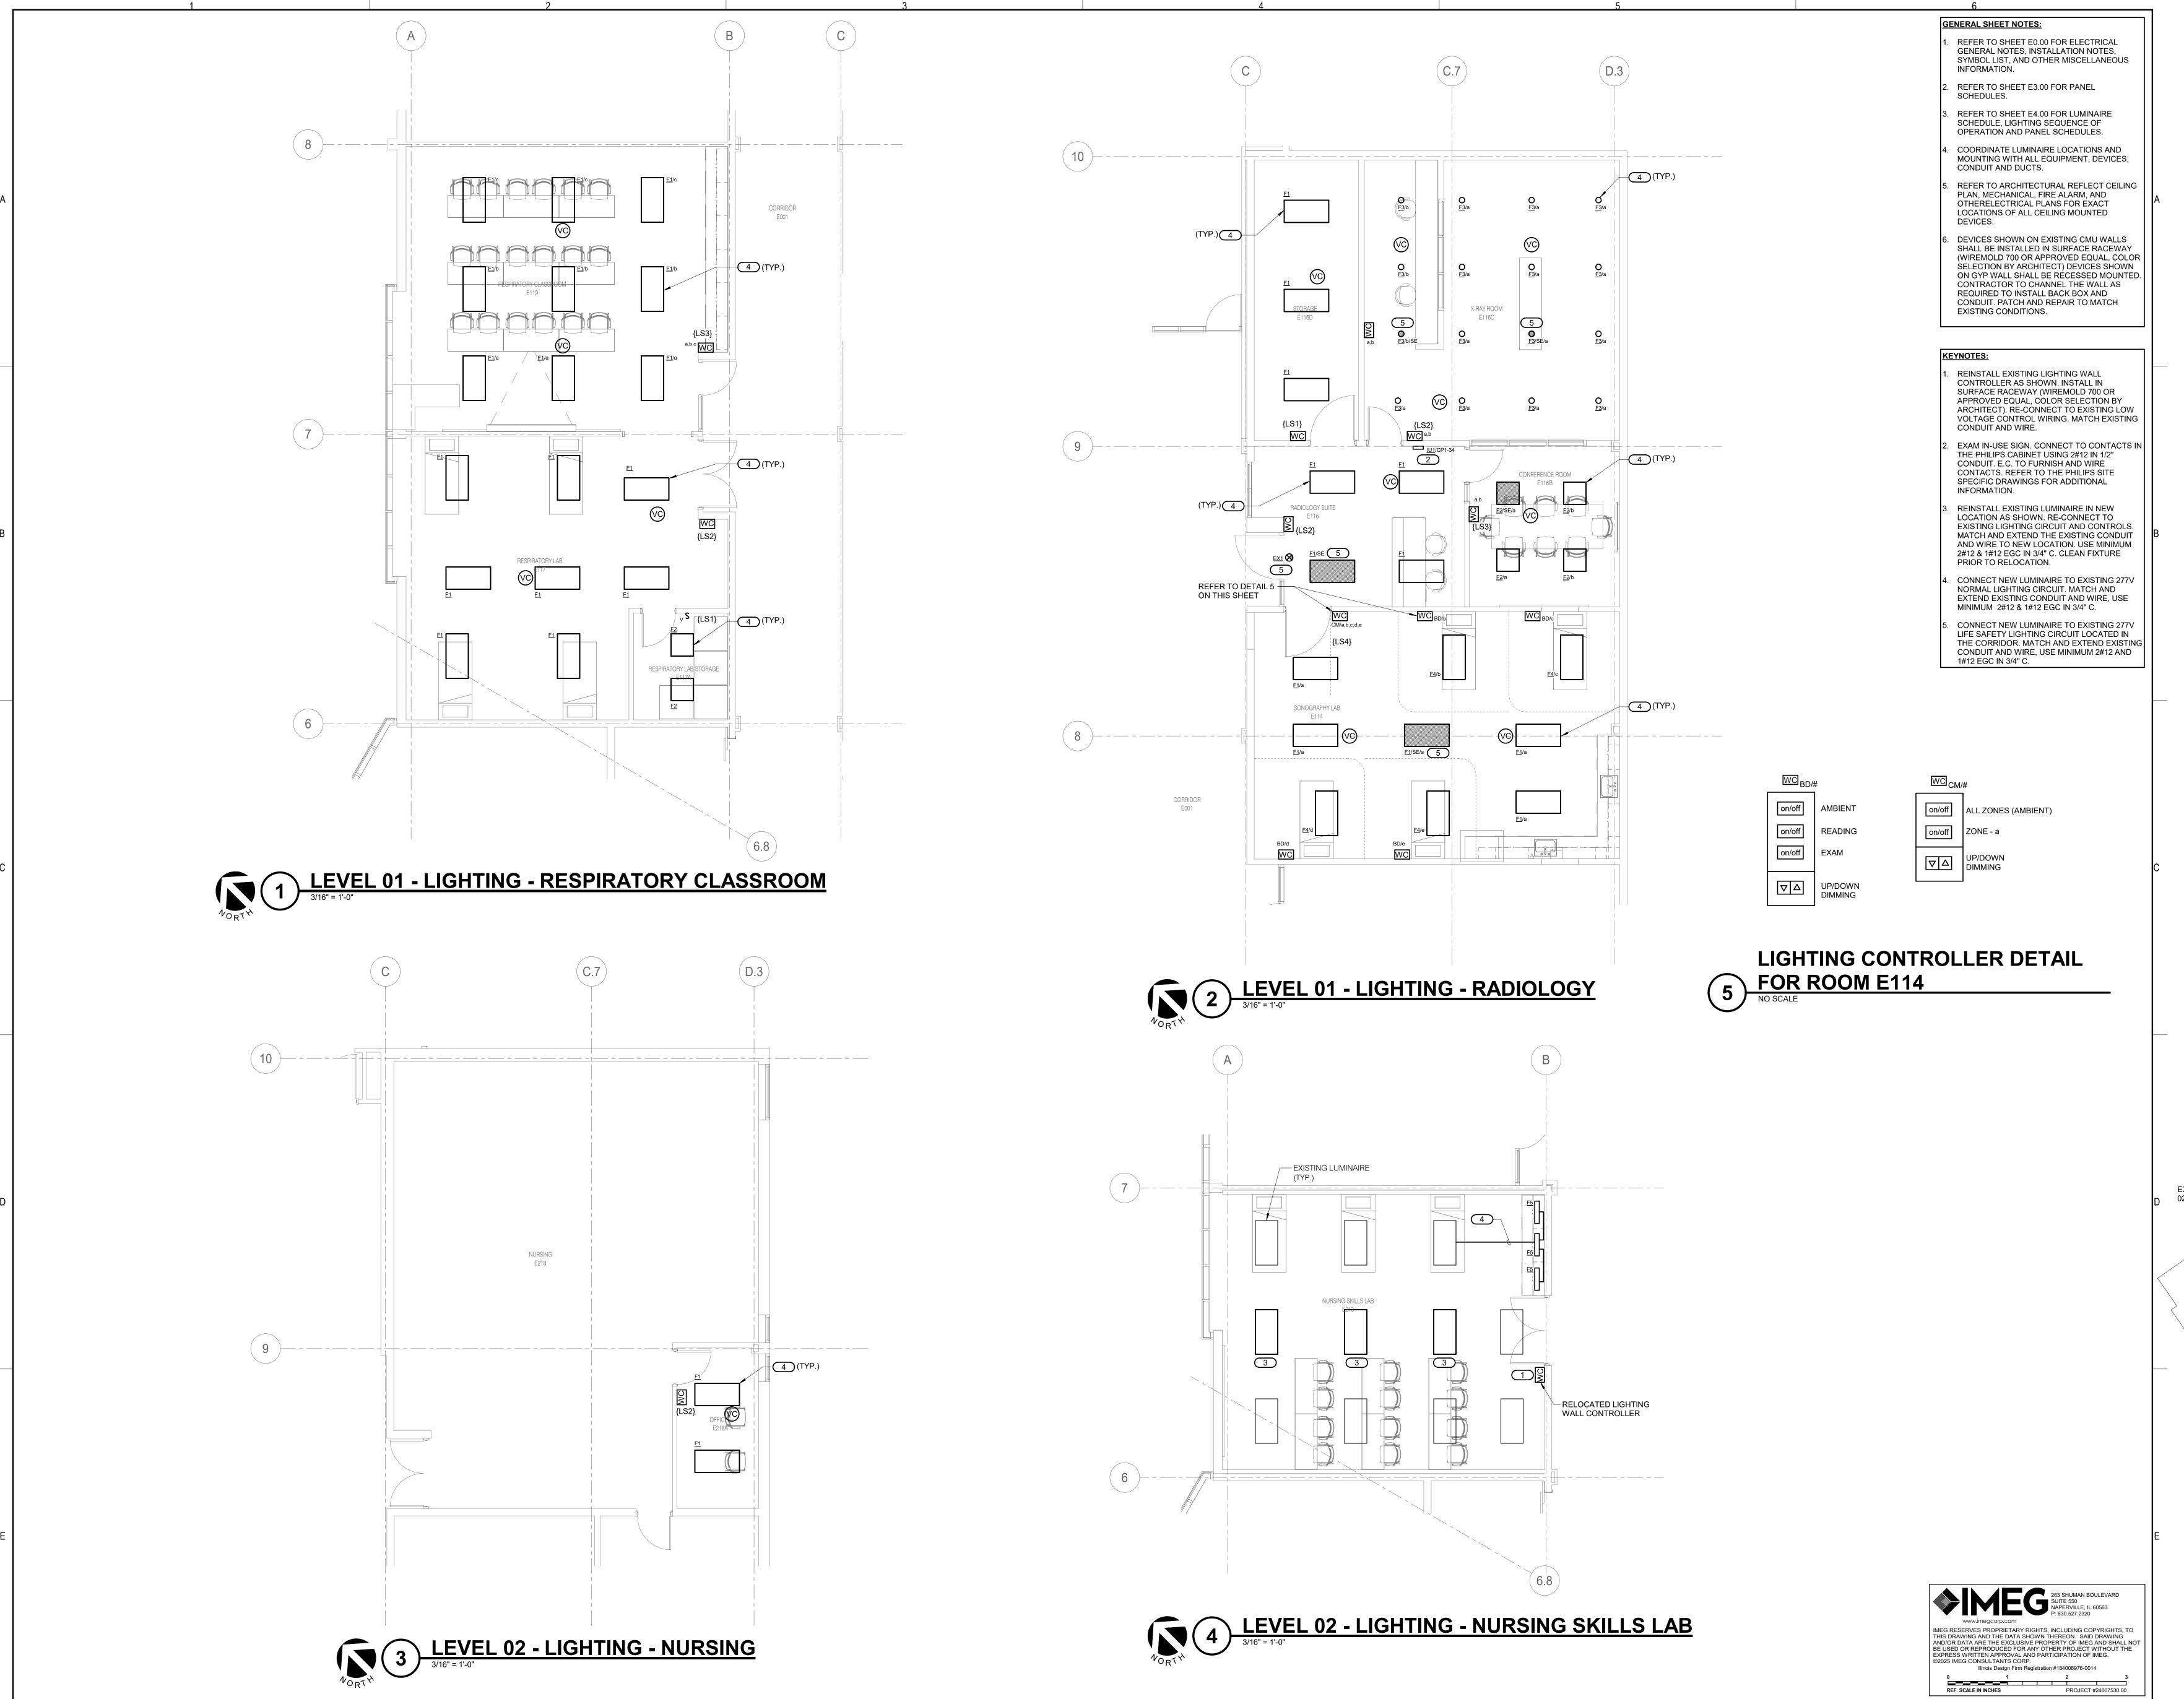
DEMOLITION PLANS -

ELECTRICAL

SHEET NUMBER:

ED1.10

2/18/2025 11:15:53 AM



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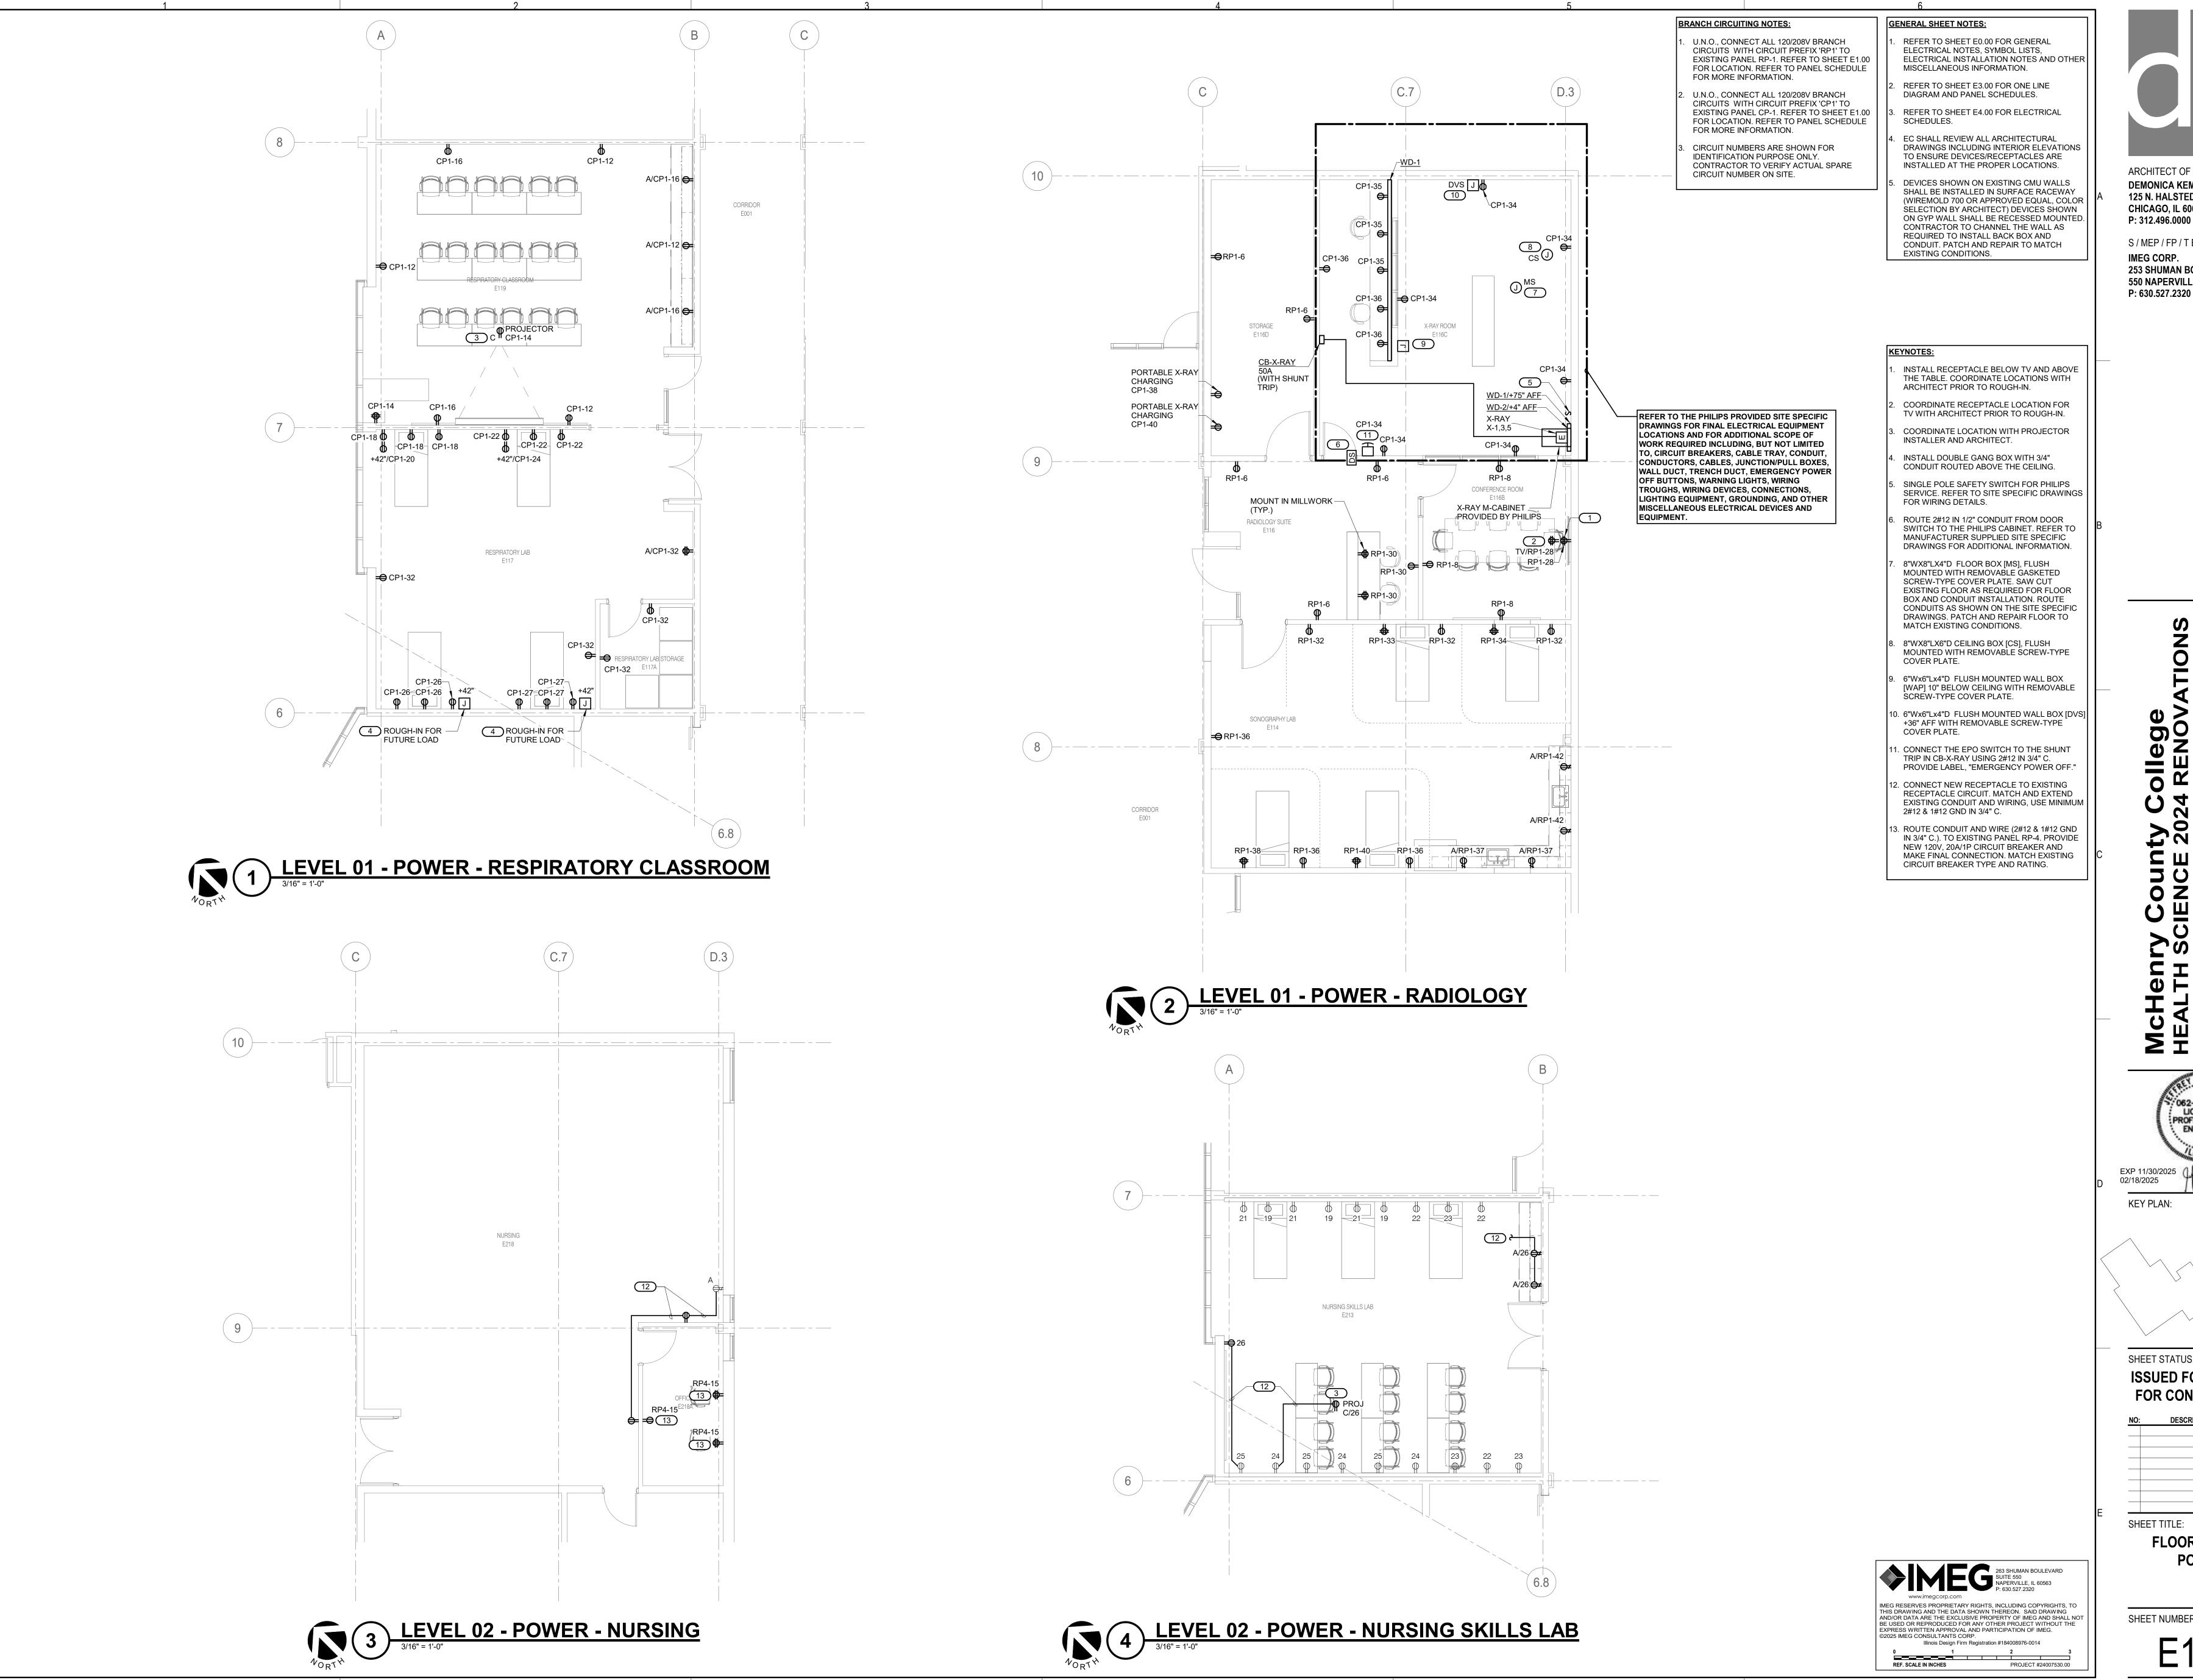
SHEET TITLE:

FLOOR PLANS -

LIGHTING

SHEET NUMBER:

2/18/2025 11:15:55 AM



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FOR CONSTRUCTION DESCRIPTION: DATE:

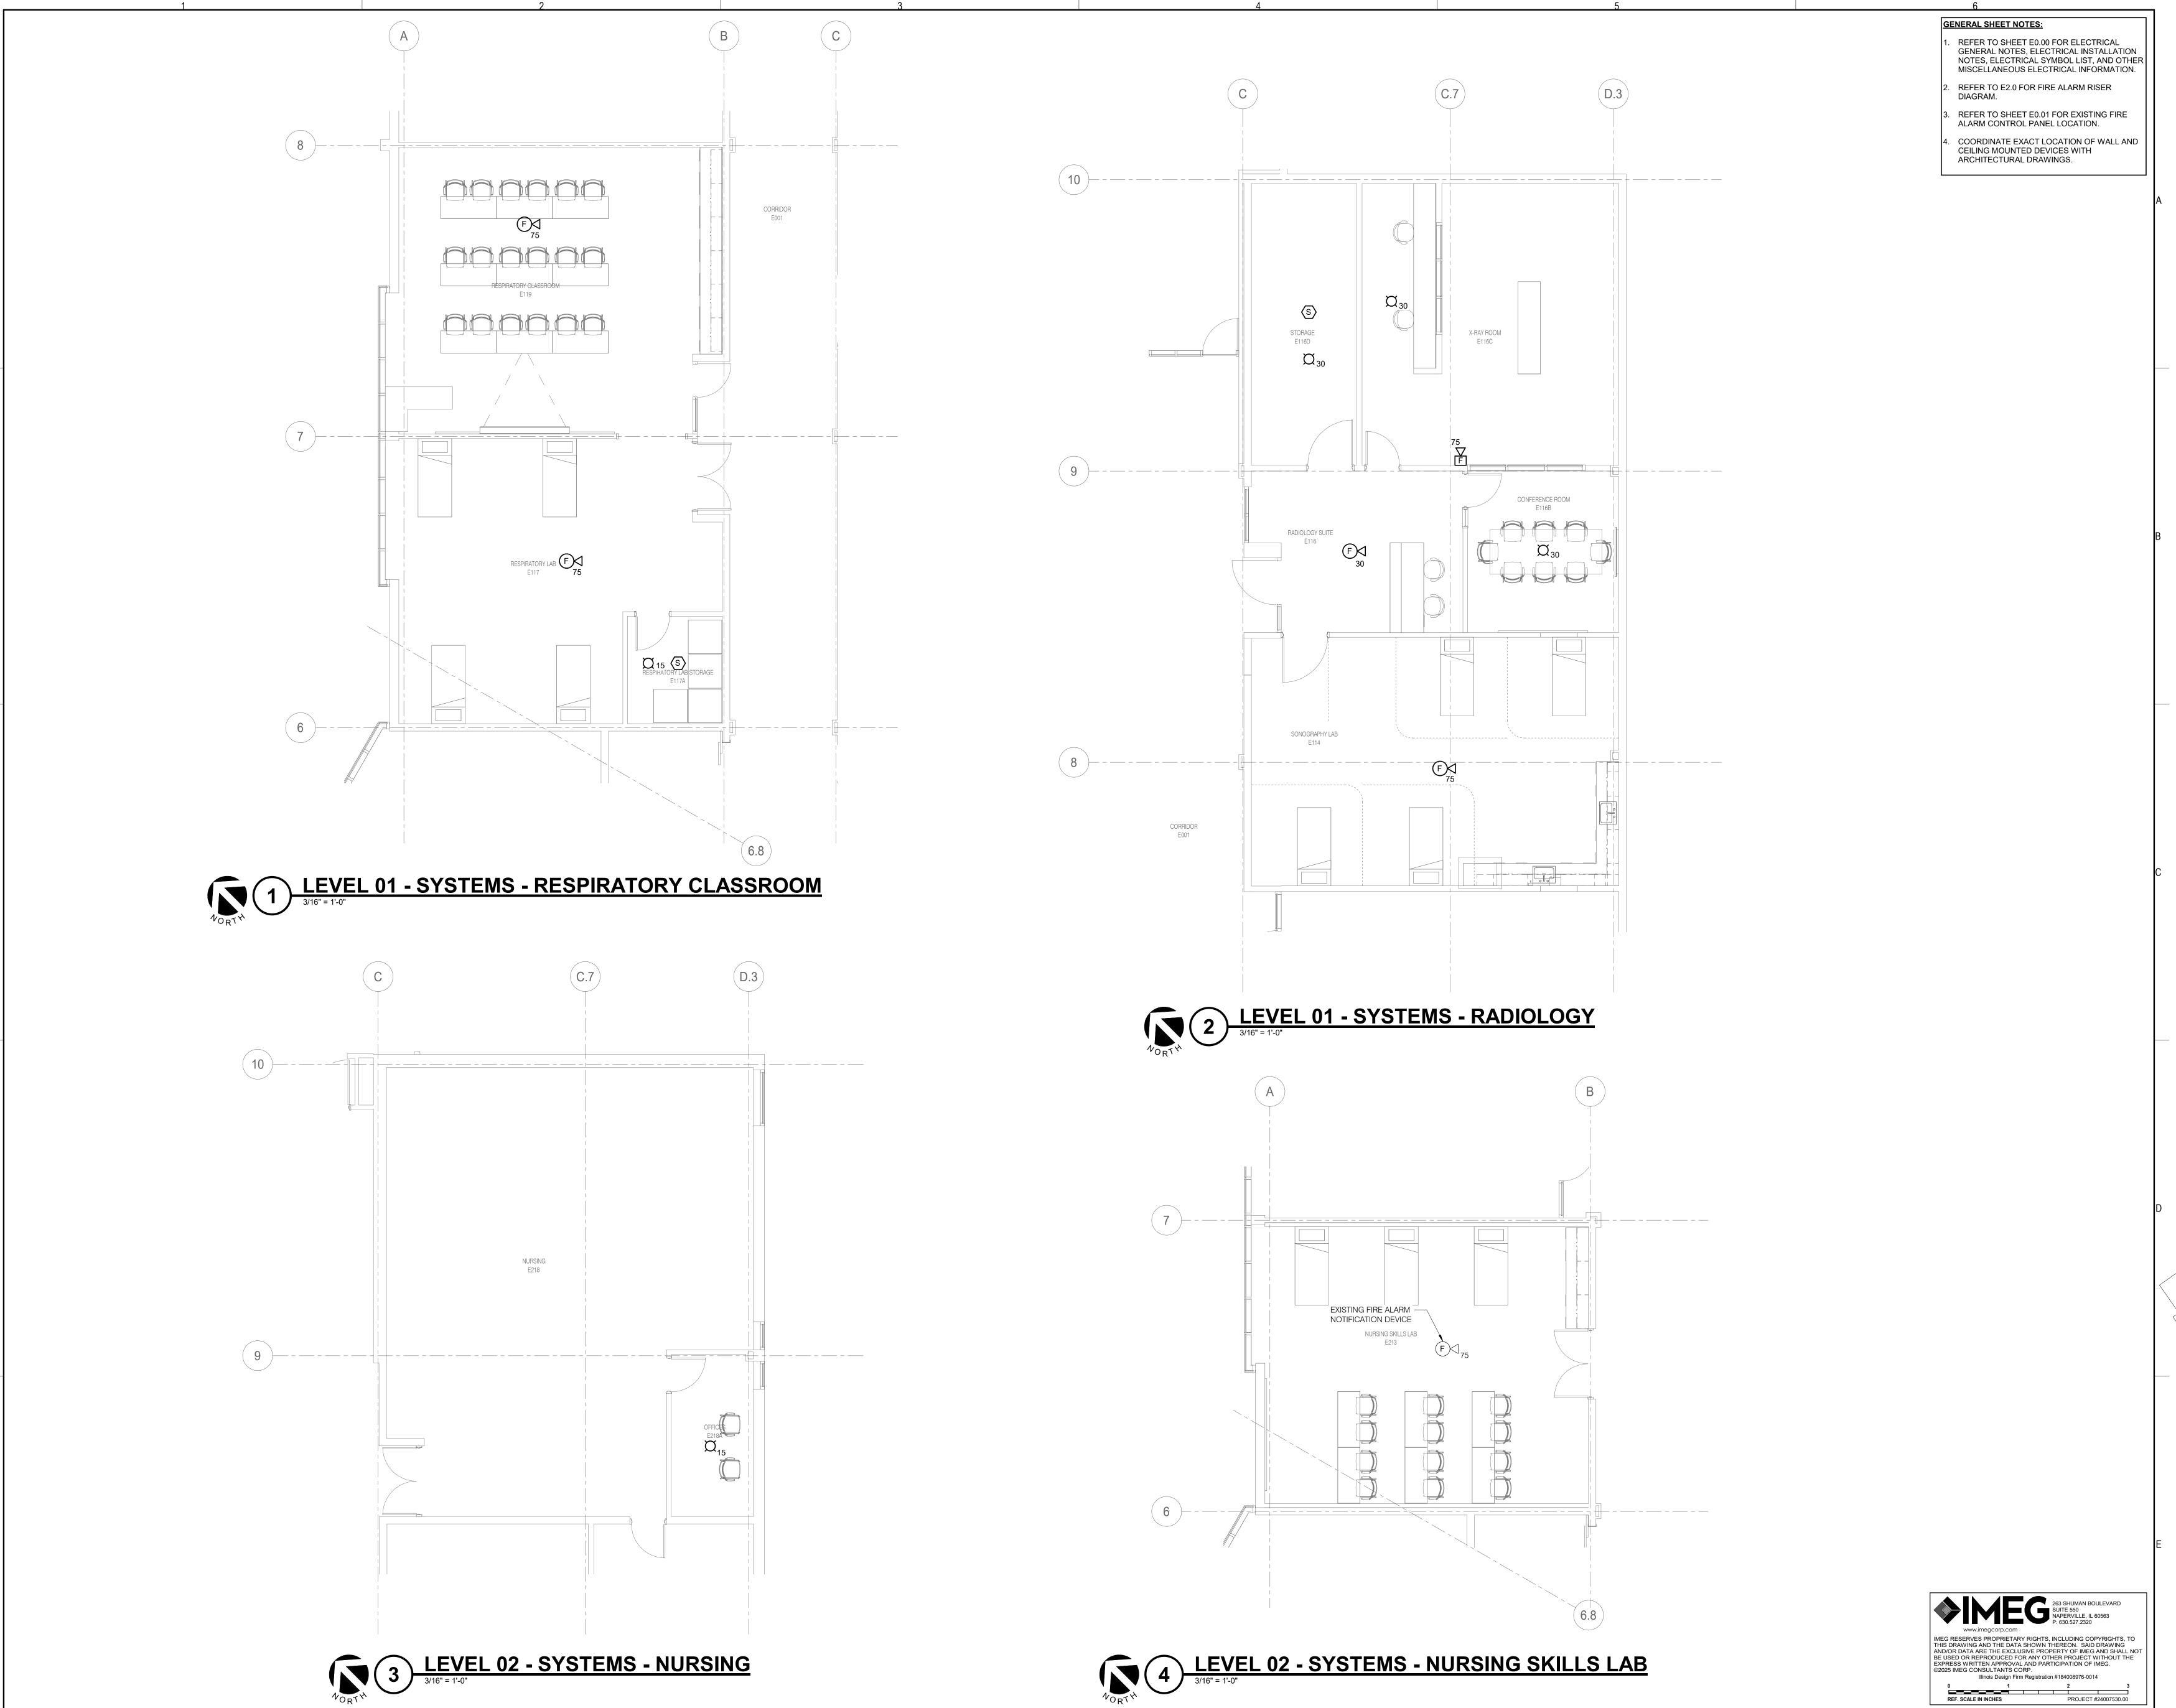
SHEET TITLE:

FLOOR PLANS -**POWER**

SHEET NUMBER:

E1.20

2/18/2025 11:15:58 AM



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SHEET STATUS:

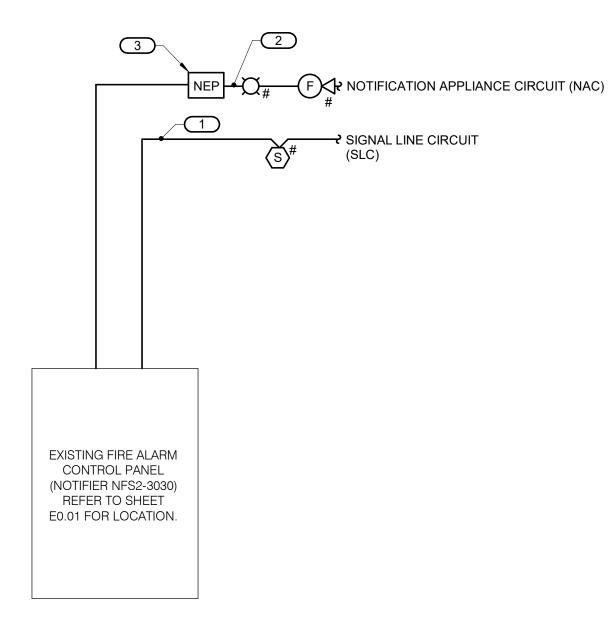
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SHEET TITLE:

FLOOR PLANS -SYSTEMS

SHEET NUMBER: E1.30

2/18/2025 11:16:00 AM

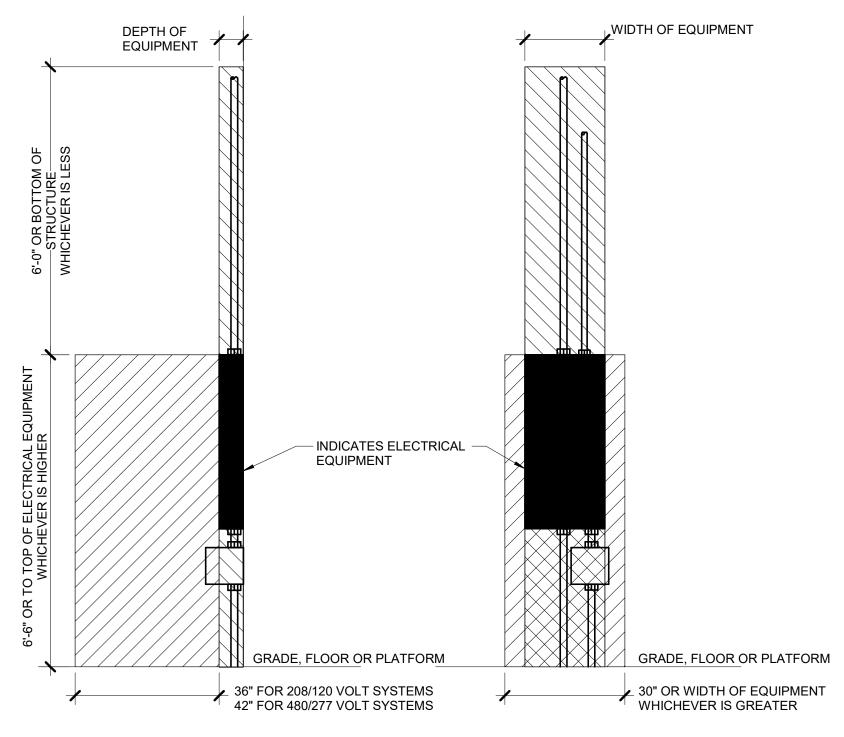


- 1. THE RISER DIAGRAM IS INTENDED TO CONVEY THE TYPES OF FIRE ALARM CONNECTIONS AND SPECIFICALLY DOES NOT INDICATE QUANTITIES, NUMBER OF CIRCUITS REQUIRED OR DISTANCES.
- 2. THE COMPLETE FIRE ALARM SYSTEM SHALL MEET ALL APPLICABLE CODES AND MANUFACTURER'S RECOMMENDATIONS.
- 3. CONTRACTOR SHALL COORDINATE ALL WIRE SIZES, TYPES AND REQUIREMENTS WITH THE VENDOR PRIOR TO BID. REFER TO SPECIFICATIONS TO DETERMINE CIRCUIT STYLES AND IF CONDUIT IS REQUIRED OR PLENUM RATED CABLE IS ACCEPTABLE.
- 4. ALL +120VAC WIRING REQUIRED FOR OPERATION OF THE SYSTEM AS DESCRIBED IN THE CONSTRUCTION DOCUMENTS SHALL BE PROVIDED BY THE ELECTRICAL CONTRACTOR.
- 5. ALL NECESSARY RELAYS MAY NOT BE SHOWN ON THIS PLAN, BUT WHERE REQUIRED FOR PROPER OPERATION OF THE SYSTEM THEY SHALL BE PROVIDED BY THE CONTRACTOR.

KEYNOTES:

- REFER TO SPECIFICATION FOR REQUIREMENTS OF EACH INITIATION LOOP AND WIRING STYLE. REFER TO FLOOR PLANS FOR DEVICES AND THEIR LOCATIONS.
- 2. REFER TO SPECIFICATION FOR REQUIREMENTS OF EACH NOTIFICATION APPLIANCE CIRCUIT AND WIRING STYLE. REFER TO FLOOR PLANS FOR DEVICES AND THEIR LOCATIONS.
- 3. PROVIDE NOTIFICATION APPLIANCE EXTENDER PANELS AS REQUIRED. DETERMINATION OF NEED TO BE MADE BY FIRE ALARM VENDOR. REFER TO SPECIFICATIONS FOR REQUIREMENTS AND ACCEPTABLE MOUNTING LOCATIONS.

E.C. SHALL HIRE FOX VALLEY FIRE FOR ALL FIRE ALARM WORK



SECTION

INDICATES WORKING SPACE REQUIRED PER LOCAL ELECTRICAL CODE. ELECTRICAL EQUIPMENT LOCATED ABOVE OR BELOW OTHER RELATED EQUIPMENT SHALL NOT EXTEND MORE THAN 6" IN FRONT OF SUCH EQUIPMENT.

ELEVATION

INDICATES DEDICATED ELECTRICAL SPACE REQUIRED PER LOCAL ELECTRICAL CODE

PANELBOARD EQUIPMENT CLEARANCES
NO SCALE



ARCHITECT OF RECORD DEMONICA KEMPER ARCHITECTS 125 N. HALSTED STREET, SUITE 301 CHICAGO, IL 60661 P: 312.496.0000

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SHEET TITLE: **ELECTRICAL DETAILS**

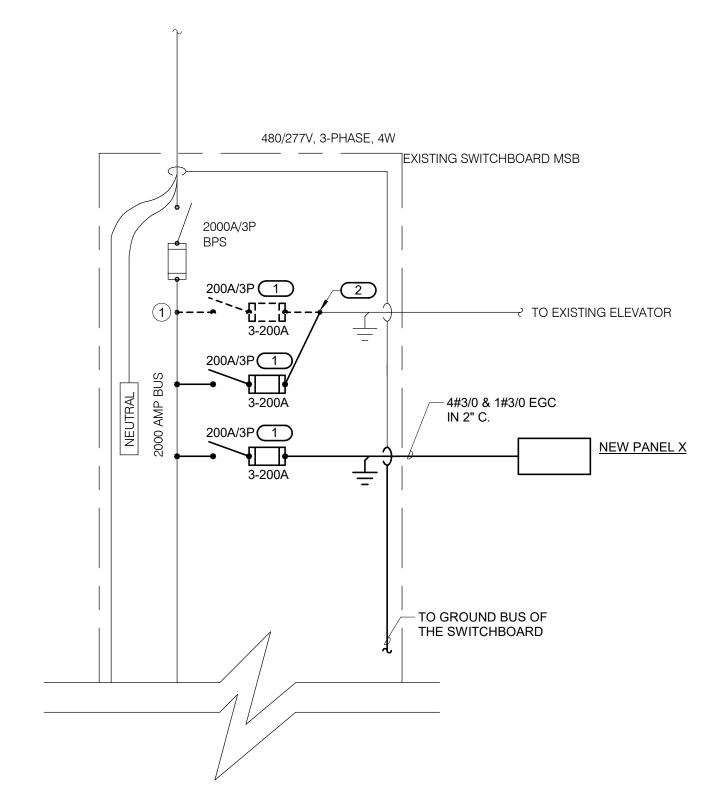
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ONE LINE DIAGRAM NOTES

- 1. AIC RATINGS LISTED FOR EQUIPMENT ARE MINIMUM REQUIREMENTS FOR BUS BRACING AND DEVICE RATING. ALL EQUIPMENT SHALL BE FULLY RATED UNLESS SPECIFICALLY NOTED AS SERIES RATED.
- CONDUCTOR AND CONDUIT SIZES ON THE LINE AND LOAD SIDES OF STARTERS, VFD'S AND DISCONNECT SWITCHES SHALL BE IDENTICAL UNLESS NOTED OTHERWISE.
- 3. $\frac{1}{2}$ INDICATES DIRECT CONNECTION OF GROUND CONDUCTOR TO GROUND BUS.
- 4. INDICATES O.Z. GEDNEY OR EQUAL GROUND BUSHING BONDED TO GROUND BUS WITH CONDUCTOR SIZED TO MAXIMUM FEEDER GROUND CAPACITY.
- 5. INDICATES FUSED DISCONNECT SWITCH, SIZE AS SPECIFIED.

\bigcirc	ONE	LINE	DIAGRAM
	NO SCALE		

					E	XI:	ST	INC	3 P/				1							
	ENCLOSI FED FF	TING: SURFACE URE: NEMA 1 ROM: EXISTING TION: ELECTRICAL ROOM E109	9							SOL	NGLE '	JTRAL						V P	MAIN: 250 MLO OLTS: 120/208 Wye HASE: 3 WIRE: 4 SCCR: EXISTING	
N	OTES:																			
K			OCP			WIR SIZI	■		A		В		C	;	WIRI SIZE	Ξ		OCPD		
_	CKT NO.	LOAD DESCRIPTION	AMPS	P	Н	1	G		1 -		1		1	G	N		Р	AMPS		CKT NO
-		EXISTING LOAD	20	1				0	0	_							1	20	EXISTING LOAD	CP1-2
-		EXISTING LOAD	20	1						0	0						1	20	EXISTING LOAD	CP1-4
· -		EXISTING LOAD	20	1								0	0				1	20	EXISTING LOAD	CP1-6
•		EXISTING LOAD	20	1				0	0								1	20	EXISTING LOAD	CP1-8
		EXISTING LOAD	20	1						0	0	_	0.70		40		1	20	EXISTING LOAD	CP1-1
+		EXISTING LOAD	20	1					0.54			0	0.72		10	_	1	20	Receptacles	CP1-1
		EXISTING LOAD EXISTING LOAD	20	1				0	0.54		0.70			_	10 10	_	1	20	Receptacles	CP1-1
•			20	1						0	0.72	0	0.54				ļ .	20	Receptacles	
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-		EXISTING LOAD EXISTING LOAD	20	1						0	0.54	0	0.18	12	12 10	12 10	1	20	Receptacles	CP1-2
+		EXISTING LOAD EXISTING LOAD	20	1				0	0.54			0	0.18		10	_	ļ '	20	Receptacles	CP1-2
-		Receptacles	20	1	12	12	12	U	0.04	0.54	0			12	12	12	1	20	Receptacles EXISTING LOAD	CP1-2
+		EXISTING LOAD	20	1		12	14			0.54	0	0	0		 		1	20	EXISTING LOAD	CP1-2
		EXISTING LOAD	20	1	 		+	0	1.08			U	U	12	12		1	20	Receptacles	CP1-3
-		EXISTING LOAD	20	1				U	1.00	0	1.08					10		20	Receptacles	CP1-3
+		Receptacles	20	1		1	10				1.00	0.54	0.54	_	10	_	_	20	Receptacles	CP1-3
+	CP1-37	ιτουτριασίου	20	+'	.0	1.0	10	0	0.8			0.04	0.04			10		20	Receptacles (X-RAY CHARGING)	CP1-3
_		EXISTING LOAD	30	3					0.0	0	0.8			_	10	_	_	20	Receptacles (X-RAY CHARGING)	CP1-4
+	CP1-41										0.0	0	0				1	20	EXISTING LOAD	CP1-4
		I			Tot	⊥ al L₄	oad:	3.14	⊥ 1 kVA	3.68	kVA	-	kVA			1	†		1 2 2	
							nps:		5.96		.48		.00				1			
					. 500									L			J			
									L(OAD S	UMMA	RY								
DΑ	D CLASSI	FICATION	CO				.OAD	DEN	MAND F		R ES		ED DE		1D				TOTALS*	
-	ing			0.	002				100.0				02 kVA							
OWe					0 k\			1	0.00				kVA						ECTED LOAD: 9.34	
ece	eptacles			9	.34 k	VA			100.0	0%		9.3	84 kVA							2 kVA
																			ECTED AMPS: 25.93	3 A
																			ATED DEMAND AMPS: 25.9	
	*TOT	AL DEMAND CALCS SUBTRAC	T ANY RE	DU	NDA	NTL	OAD	AND	THE SI	MALLE	R OF A	NY NC	NCOIN	ICID	EN	ΓHV	AC	LOADS.	THIS CALC IS DONE AT EACH	PANEL.
(CIRCUIT K	EY NOTES:								-	-	-								

KEYNOTES:

I. DISCONNECT AND REMOVE EXISTING 200A/3P FUSED DISCONNECT SWITCH FEEDING EXISTING ELEVATOR. INSTALL TWO NEW 200A/3P, 480V FUSED DISCONNECT SWITCHES (SIEMENS VACU-BREAK SWITCH TWIN UNIT CAT. NO. V7F3644J) AND FUSES IN THE EXISTING SPACE. PROVIDE ALL REQUIRED HARDWARE AND ACCESSORIES TO MAKE COMPLETED AND FUNCTIONAL INSTALLATION. NEW FUSES SHALL MATCH EXISTING TYPE AND RATING.

2. RE-CONNECT EXISTING ELEVATOR TO NEW FUSE DISCONNECT SWITCH AS SHOWN.

NEW PANEL X MOUNTING: SURFACE SINGLE TUB MAIN: 200 A MLO **ENCLOSURE**: NEMA 1 **SOLID NEUTRAL VOLTS:** 480/277 Wye **GROUND BUS** FED FROM: EXISTING SWITCHBOARD MSB PHASE: 3 **LOCATION:** ELECTRICAL ROOM E109 SCCR: 42 kA OCPD WIRE SIZE WIRE SIZE OCPD CKT E E CKT AMPS P H N G Y NO. LOAD DESCRIPTION G N H P AMPS LOAD DESCRIPTION NO. Y
 50
 3
 3/0
 - 3/0
 - 3/0
 - 26.67
 0
 - 10
 4
 4
 3
 60
 SPD-480

 50
 3
 - - - - - - - 1
 - SPACE

 50
 3
 - - - - - - - 1
 - SPACE

 - 1
 - - - - - - 1
 - SPACE

 - 1
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 - SPACE

 - 1
 - - - - - - - 1
 - SPACE

 - 1
 - - - - - - - 1
 - SPACE

 - 1
 - - - - - - - 1
 - SPACE

 - 1
 - - - - - 3 X-RAY -- 9 SPARE 11 -- 13 SPACE -- 15 SPACE -- 17 SPACE -- 19 SPACE -- 21 SPACE -- 23 SPACE -- 25 SPACE -- 27 SPACE -- 29 SPACE **Total Load:** 26.72 kVA 26.67 kVA 26.67 kVA **Total Amps:** 96.45 96.27 96.27 LOAD SUMMARY LOAD CLASSIFICATION CONNECTED LOAD | DEMAND FACTOR | ESTIMATED DEMAND TOTALS* 0.05 kVA 100.00% 0.05 kVA NEC 517.73 Imaging 80 kVA 50.00% 40 kVA TOTAL CONNECTED LOAD: 80.05 kVA

*TOTAL DEMAND CALCS SUBTRACT ANY REDUNDANT LOAD AND THE SMALLER OF ANY NONCOINCIDENT HVAC LOADS. THIS CALC IS DONE AT EACH PANEL

CIRCUIT KEY NOTES:

TOTAL ESTIMATED DEMAND LOAD: 40.05 kVA

TOTAL ESTIMATED DEMAND AMPS: 48.2

TOTAL CONNECTED AMPS:

	ENCLOSI FED FF LOCAT	ING: SURFACE JRE: NEMA 1 ROM: EXISTING ION: ELECTRICAL ROOM E109	9							SOL	NGLE ⁻ ID NEU OUND	JTRAL						P	MAIN: 250 MLO OLTS: 120/208 Wye HASE: 3 WIRE: 4 SCCR: EXISTING		
N C	OTES:		OCP	D		WIR SIZ			Α	E	В				WIR SIZI			DCPD			
- 1	CKT NO.	LOAD DESCRIPTION	AMPS	Ρ	Н	N	G							G	N	Н		AMPS	LOAD DESCRIPTI	ON CKT NO.	- 1
-	RP1-1	EXISTING LOAD	20	1				0	0								1	20	EXISTING LOAD	RP1-2	-
-	RP1-3	EXISTING LOAD	20	1						0	0						1	20	EXISTING LOAD	RP1-4	
-	RP1-5	EXISTING LOAD	20	1								0	0.9	10	10	10	1	20	Receptacles	RP1-6	
-	RP1-7	EXISTING LOAD	20	1				0	0.54					10	10	10	1	20	Receptacles	RP1-8	
	RP1-9	EXISTING LOAD	20	1						0	0						1	20	EXISTING LOAD	RP1-10	
	RP1-11	EXISTING LOAD	20	1								0	0				1	20	EXISTING LOAD	RP1-12	
	RP1-13	EXISTING LOAD	20	1				0	0								1	20	EXISTING LOAD	RP1-14	
	RP1-15	EXISTING LOAD	20	1						0	0						1	20	EXISTING LOAD	RP1-16	
	RP1-17	EXISTING LOAD	20	1								0	0				1	20	EXISTING LOAD	RP1-18	
	RP1-19	EXISTING LOAD	20	1				0	0								1	20	EXISTING LOAD	RP1-20	
	RP1-21	EXISTING LOAD	20	1						0	0						1	20	EXISTING LOAD	RP1-22	
		EXISTING LOAD	20	1								0	0				1	20	EXISTING LOAD	RP1-24	
.	RP1-25	EXISTING LOAD	20	1				0	0								1	20	EXISTING LOAD	RP1-26	
		EXISTING LOAD	20	1						0	0.72			10	10	10	1	20	Receptacles	RP1-28	
		EXISTING LOAD	20	1								0	0.9	10	10	10	1	20	Receptacles	RP1-30	_
		EXISTING LOAD	20	1				0	0.54					10		10		20	Receptacles	RP1-32	
		Receptacles	20	1	10	10	10			0.36	0.36			_	_	10		20	Receptacles	RP1-34	_
		EXISTING LOAD	20	1								0	0.54			10		20	Receptacles	RP1-36	_
ı		Receptacles	20	1	10	10	10	0.36	0.36					_	10		_	20	Receptacles	RP1-38	_
		EXISTING LOAD	20	1						0	0.36					10		20	Receptacles	RP1-40	_
	RP1-41	EXISTING LOAD	20	1								0	0.36	10	10	10	1	20	Receptacles	RP1-42	*
							oad:) kVA	1.80			kVA								
					Tota	al Ar	nps:	15	5.00	15	.00	22	.50		_						
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	AD CLASSI eptacles	FICATION	60			ED L	JAO.) DEI	100.00		K ES		ED DE 3 kVA	:iviAľ	אט				TOTALS*		
	υριαυίου				,.o r	. v / 1			100.00	<i>5</i> /0		0.				TOI	ΓΔΙ	CONNI	ECTED LOAD:	6.30 kVA	
																_			ATED DEMAND LOAD:	6.3 kVA	
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ARCHITECT OF RECORD

DEMONICA KEMPER ARCHITECTS
125 N. HALSTED STREET, SUITE 301
CHICAGO, IL 60661
P: 312.496.0000

S / MEP / FP / T ENGINEERS:

IMEG CORP.

253 SHUMAN BOULEVARD, SUITE

550 NAPERVILLE, IL 60563
P: 630.527.2320

ry County College SCIENCE 2024 RENOVATI

062-060380 UCENSED PROFESSIONAL ENGINEER OF

EXP 11/30/2025 02/18/2025 KEY PLAN:

SHEET STATUS: 02/18/2025
ISSUED FOR BID - NOT
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NO: DESCRIPTION: D

ELECTRICAL ONE
LINE DIAGRAM

SHEET NUMBER:

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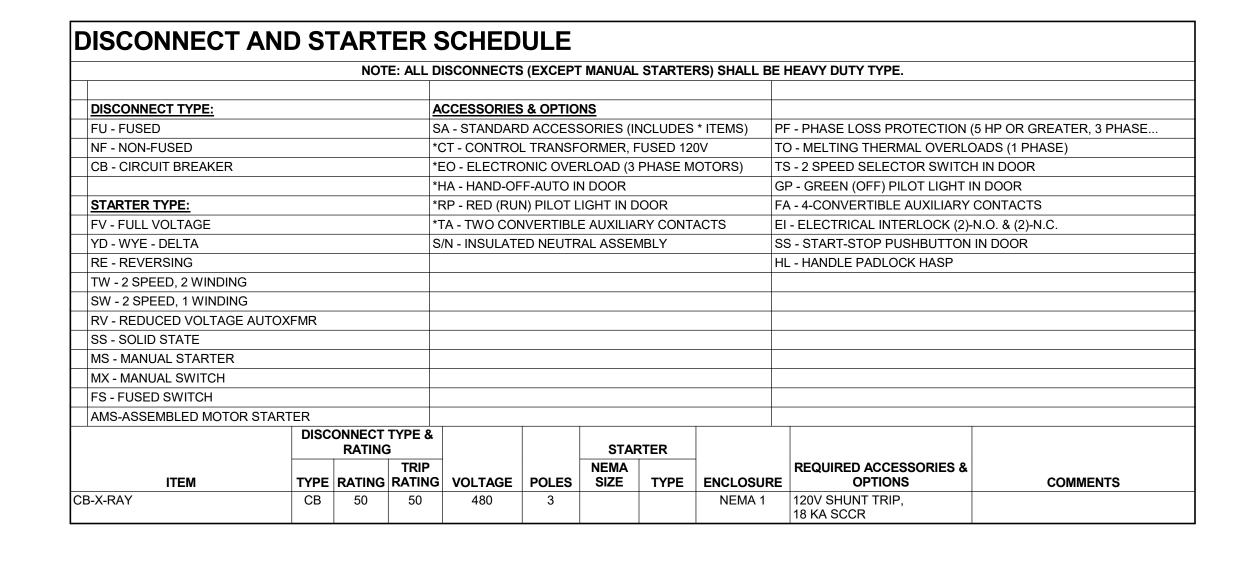
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DESC) DOOR:	DISTRIBUTION:	BEAMWIDTH:	(L/L) LENS/LOUVER:	K19 - KSH19 .156" ACRYLIC
FA - FLAT ALUMINUM	II - ANSI/IES TYPE 2 DISTRIBUTION	NSP - VERY NARROW SPOT	A125" ACRYLIC	M - MATTE DIFFUSE CLEAR
FS - FLAT STEEL	III - ANSI/IES TYPE 3 DISTRIBUTION	SP - SPOT	B - BAFFLE/LOUVER	N - NONE
RA - REGRESSED ALUMINUM	IV - ANSI/IES TYPE 4 DISTRIBUTION	MD - MEDIUM	C - CLEAR ALZAK	P - POLYCARBONATE
RS - REGRESSED STEEL	V - ANSI/IES TYPE 5 DISTRIBUTION	WD - WIDE	F - FROSTED ACRYLIC	R - HIGH IMPACT DR ACRYLIC
FINISH:		VWD - VERY WIDE	G - TEMPERED GLASS	SS - SEMI-SPECULAR CLEAR
PAF - PAINT AFTER FABRICATIO	N	WW - WALL WASH	K - KSH12 .125" ACRYLIC	O - OTHER (SEE DESCRIPTION)
CFSA - COLOR-FINISH SELECTIO	N BY ARCHITECT			[DESIGN SPECIFIC BLANKS]
MTG) MOUNTING:	RE - RECESSED		(WATT) PER: FIX - FIXTURE,	FT - FOOT, LAMP
CL - CEILING SURFACE	SP - SUSPENDED		(TYPE) LED	RGB - COLOR CHANGING LED
CV - COVE	SU - SURFACE		LED - LIGHT EMITTING DIODE	RGBW - COLOR CHANGING + WHITE
FR - FLANGED RECESSED	UC - UNDER CABINET		TLED - TUBULAR LED LAMP	RGBA - COLOR CHANGING + AMBEI
P - PERIMETER	WL - WALL		OLED - ORGANIC LED	RLED - RETROFIT LED
PL - POLE	O - OTHER (SEE DESCRIPTION)		DLED - DYNAMIC TUNABLE LED	WLED - WARM DIM LED
TYPE) DRIVER:				
0-10V - 0-10V DIMMING	EB - ELECTRONIC	HL - HIGH/LOW (100%/50%) STEP	DIM	MV - MULTI-VOLTAGE ELECTRONIC
DALI - DIGITAL ADDRESSABLE	ELV - ELECTRONIC LOW VOLTAGE	LINE - LINE VOLTAGE DIMMING		REM - REMOTE
DMX - DIGITAL MULTIPLEX	EM - EMERGENCY BATTERY	ML - MULTI-LEVEL SWITCHING		O - OTHER (SEE DESCRIPTION)

					DIMEN	ISIONS		WA	TT		L	.ED	DRIVE	₹	
ITEM	DESCRIPTION	L/L	MTG	L	w	н	DIA.	ANSI WATTS	PER	TYPE	QTY	DELIVERED LUMENS (MIN)	VOLTS	TYPE	MANUFACTURER AND MODEL
EX1	EDGE-LIT SINGLE FACED EXIT SIGN, INJECTION MOLDED ACRYLIC MIRROR LENS AND EXTRUDED ALUMINUM HOUSING. HOUSING FINISH AND COLORS SELECTED BY ARCHITECT. VERIFY RECESSED END,BACK OR CEILING MOUNTING AND ARROWS WITH PLANS.	0	CL	1'-1"	2"	9"		4	FIX	LED	1	LED	277	EB	SURE-LITE APXEL LITHONIA LRP EL N DUAL-LITE LE S MCPHILBEN 45V 1 EVENLITE SOV 1C
F1	RECESSED LED DIRECT TROFFER. HIGH OPTICAL GRADE LENS WITH CURVED SMOOTH DIFFUSER.	0	RE	4'-0"	2'-0"	2 3/8"		47	FIX	LED	1	6000 LM	277	0-10V	LITHONIA 2BLT4
F2	RECESSED LED DIRECT TROFFER. HIGH OPTICAL GRADE LENS WITH CURVED SMOOTH DIFFUSER.	0	RE	2'-0"	2'-0"	2 3/8"		31	FIX	LED	1	4000 LM	277	0-10V	LITHONIA 2BLT2
F3	6" APERTURE RECESSED OPEN LED DOWNLIGHT, MEDIUM DISTRIBUTION, SEMI-SPECULAR.	0	RE			9 1/2"	6"	20	FIX	LED	1	2000 LM	277	0-10V	GOTHAM EVO6 PORTFOLIO LD6 LIGHTOLIER P6R
F4	OVERBED MULTIFUNCTION TROFFER, DECORATIVE LENS, WITH READING, AMBIENT AND EXAM FUNCTIONS, DECORATIVE LENS SELECTED BY ARCHITECT.	0	RE	4'-0"	2'-0"	3 1/2"		162	FIX	LED	1	AMBIENT: 2500 EXAM: 6400 READING: 2800	277	0-10V	VISA SERENITY CM1946 NEWSTAR LUMANIQUE SPDH
F5	UNDER CABINET UNIT, STEEL HOUSING, DIFFUSE MATTE ACRYLIC LENS. ROCKER SWITCH	0	UC	2'-0"	4 7/8"	1"		12	FIX	LED	1	1200 LM	277	EB	H.E.WILLIAMS 1SF COOPER FAIL-SAFE UCL ACUITY HEAL SPECTRA- SF LED
IU1	IN USE SIGN, SIGNAGE TO READ "X-RAY IN USE."	0	WL	11"	3 1/8"	8"		2	FIX	LED	1	LED	120	EB	LITHONIA LE SURE-LITES CX DUAL-LITE SE

REFER TO SPECIFICATION SECTIONS LED LIGHTING 26 51 19 FOR ADDITIONAL INFORMATION AND REQUIREMENTS.

	ING SEQUENCE OF OPERATION
NOTES: 1. {L##} DEN	OTES THE LIGHTING SEQUENCE OF OPERATIONS FOR THIS SPACE.
PLAN ID	LIGHTING SWITCHED
{LS1}	Sequence: Switched lights are vacancy controlled from a ceiling sensor or wall switch sensor in this space. ON: The lights turn on using the wall controller. OFF: After the space has been vacant for 15 minutes, the lights will automatically turn off or manually by wall controller.
{LS2}	Sequence: Dimmed lights are vacancy controlled from a ceiling sensor in this space. ON: The lights turn on using the wall controller. ADJUST: The lights within the space are raised/lowered via wall controller. OFF: After the space has been vacant for 15 minutes, the lights will automatically turn off or manually by wall controller. Emergency: (if shown) Life safety lights (SE) are controlled with normal lights. When normal power fails, life safety lights shal go to 100% output.
{LS3}	Sequence: Dimmed lights are vacancy controlled from a ceiling mounted sensor in this space. ON: The lights are turn on using the wall controller. ADJUST: The lights within the space are raised/lowered via wall controller. Rooms with multiple zones have subscript to identify minimum in each zone. Each zone shall be connected to a separate power pack. Rooms with multiple wall controllers shall allow for full control at each location. Scenes: 1. 100% on (Zone a,b,c) 2. AV mode (Zone a: off, Zone b and c: 50%) 3. 50% on (Zone a,b,c) OFF: After the space has been vacant for 15 minutes, the lights will automatically turn off or manually by wall controller. Emergency: (if shown) Life safety lights (SE) are controlled with normal lights. When normal power fails, life safety lights shall go to 100% output.
{LS4}	Sequence: Dimmed lights are vacancy controlled from a ceiling mounted sensor in this space. ON: The lights are turn on using the wall controller. ADJUST: The lights within the space are raised/lowered via wall controller. Rooms with multiple zones have subscript to identify minimum in each zone. Each zone shall be connected to a separate power pack. Refer to lighting controller detail on sheet 5/E1.10. OFF: After the space has been vacant for 15 minutes, the lights will automatically turn off or manually by wall controller. Emergency: (if shown) Life safety lights (SE) are controlled with normal lights. When normal power fails, life safety lights shall go to 100% output.





ARCHITECT OF RECORD

DEMONICA KEMPER ARCHITECTS

125 N. HALSTED STREET, SUITE 301

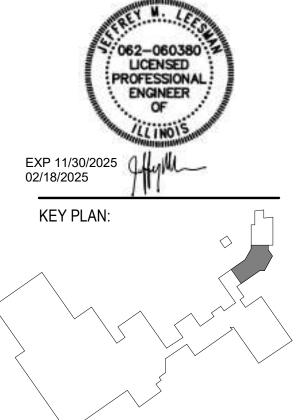
CHICAGO, IL 60661

P: 312.496.0000

S / MEP / FP / T ENGINEERS:

IMEG CORP.
253 SHUMAN BOULEVARD, SUITE
550 NAPERVILLE, IL 60563
P: 630.527.2320

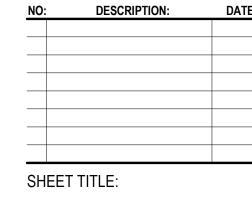
McHenry County College HEALTH SCIENCE 2024 RENOVATIO



SHEET STATUS: 02/18/2025

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ELECTRICAL SCHEDULES

SHEET NUMBER:

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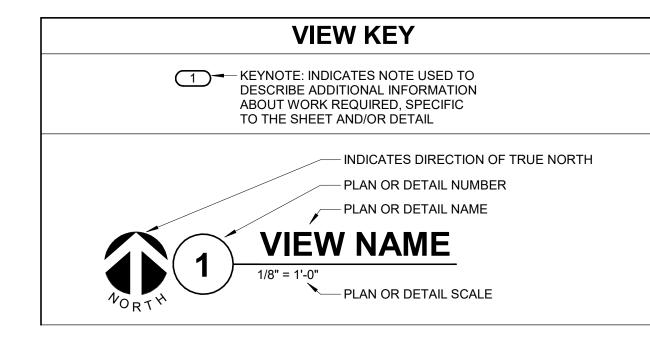
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	CONTRACTOR ABBREVIATION KEY
ABBR:	DESCRIPTION:
E.C.	ELECTRICAL CONTRACTOR
M.C.	MECHANICAL CONTRACTOR
P.C.	PLUMBING CONTRACTOR
T.C.	TECHNOLOGY CONTRACTOR

	-	ΓECHNOL	OGY SYMBOL LIST
SYMBOL	TAG	EQUIPMENT LIST ABBREVIATION	DESCRIPTION
S	SP1	AV-SP1-C	AV PERFORMANCE SPEAKER (CEILING)
S			AV PERFORMANCE SPEAKER (WALL) EXISTING
	WP1	AV-WP1-C	AV PLATE (CEILING/SURFACE)
•	WP1	AV-WP1-W	AV WALLPLATE/BACKBOX (WALL)
С			CLOCK (WALL) EXISTING
N			NURSE CALL SINGLE PATIENT BED STATION (WALL) EXISTING
(S)			FACILITY PAGING SPEAKER (CEILING) EXISTING
	S1	PA-S1-C	FACILITY PAGING SPEAKER (CEILING)
S			FACILITY PAGING SPEAKER (WALL) EXISTING
C#	C2	SC-IO-C	INFORMATION OUTLET (CEILING)
•	C2-WAP	SC-WAP-C	WIRELESS ACCESS POINT (CEILING)
\bigcirc	WAP		WIRELESS ACCESS POINT (CEILING) EXISTING
C#	C2	SC-IO-W	INFORMATION OUTLET (WALL)
•	C4	SC-IO-W	INFORMATION OUTLET (WALL)
∇			INFORMATION OUTLET (WALL) EXISTING
Ō			VIDEO SURVEILLANCE CAMERA SINGLE LENS FOV (CEILING) EXISTING

PA	THWAY SYMBOL LIST:
SYMBOL	DESCRIPTION
WIDTH X HEIGHT	CABLE TRAY, CHANNEL TRAY, BASKET TRAY
WIDTH X HEIGHT	LADDER RACK
—DIAMETERØ C——	CONDUIT
 ə	CONDUIT DOWN
	CONDUIT UP OR UP/DOWN
<u> </u>	CONDUIT SLEEVE
\$	CONTINUATION

TECHNOLOGY SYMBOL LIST GENERAL NOTES:

- 1. "C#" INDICATES INFORMATION OUTLET FACEPLATE CONFIGURATION. REFER TO INFORMATION OUTLET SCHEDULE ON T5.00 FOR ADDITIONAL INFORMATION
- 2. UNDERLINED SUBSCRIPTS NEXT TO SYMBOL INDICATES DEVICE TYPE. REFER TO TECHNOLOGY EQUIPMENT SCHEDULE T5.00 FOR ADDITIONAL INFORMATION.

	TECHNOLOGY ABBREVIATION KEY
ABBR:	DESCRIPTION:
AFF	ABOVE FINISHED FLOOR
AFG	ABOVE FINISHED GRADE
BFC	BELOW FINISHED CEILING
С	CONDUIT
DE	DELAYED EGRESS
DPDT	DOUBLE POLE DOUBLE THROW
FOV	FIELD OF VIEW
J-BOX	JUNCTION BOX
POE	POWER OVER ETHERNET
PTZ	PAN TILT ZOOM
SIM	SIMILAR
TYP	TYPICAL
UON	UNLESS OTHERWISE NOTED
+#	MOUNTING HEIGHT ABOVE FINISHED FLOOR
EF-#	ENTRANCE FACILITY
MC-#	MAIN CROSS-CONNECT
TR-#	TELECOMMUNICATIONS ROOM

ITEM:	SHOWN ON:	FURNISHED BY:	INSTALLED BY:	NOTES
TECHNOLOGY ROUGH-IN, REFER TO TECHNOLOGY EQUIPMENT SCHEDULE AND SPECIFICATIONS FOR DEFINITION	T-SERIES	E.C.	E.C.	3. 4.
INFORMATION OUTLET FACEPLATES, JACKS, AND TERMINATIONS	T-SERIES	T.C.	T.C.	
CONDUIT SLEEVES (WHEN SHOWN ON DRAWINGS)	T-SERIES	E.C.	E.C.	
CONDUIT SLEEVES (NOT SHOWN BUT REQUIRED FOR PROPER INSTALLATION OF SYSTEM)	N/A	T.C.	T.C.	2. 4.
TELECOMMUNICATION SYSTEMS ROUGH-IN	T-SERIES	E.C.	E.C.	1.
TELECOMMUNICATION EQUIPMENT, CABLING, AND TERMINATIONS	T-SERIES	T.C.	T.C.	
CONNECTION OF TECHNOLOGY BONDING SYSTEM TO THE ELECTRICAL GROUND SYSTEM	T-SERIES	E.C.	E.C.	
LOW VOLTAGE CABLING FOR TECHNOLOGY SYSTEMS	T-SERIES	T.C.	T.C.	
CABLE HANGERS AND SUPPORTS OR OTHER CABLE ROUTING METHODS (OTHER THAN CONDUIT AND CABLE TRAY)	T-SERIES	T.C.	T.C.	5.

SUGGESTED MATRIX OF RESPONSIBILITY NOTES

LOCATIONS OF TELECOMMUNICATIONS ROUGH-INS SHALL BE INDICATED BY THE INFORMATION OUTLET SYMBOLS ON THE DRAWINGS. REFER TO THE TECHNOLOGY SYMBOL LIST FOR ADDITIONAL INFORMATION.

BASED ON THE INHERENT DIFFERENCES IN PRODUCTS FROM VARIOUS MANUFACTURERS, ALL REQUIRED EQUIPMENT MAY NOT BE SHOWN ON THE DRAWINGS FOR ALL ACCEPTABLE MANUFACTURERS. INCLUDES BACKBOXES AND CONDUIT REQUIRED FOR THE TECHNOLOGY SYSTEMS INSTALLATION. THE E.C. SHALL BASE THE BID ON THE BASIS OF DESIGN SHOWN ON THE

CONTRACT DOCUMENTS. ALL CHANGES TO THE SLEEVES, BACKBOXES, CONDUITS, AND POWER REQUIRED BECAUSE OF THE T.C.'S SELECTION OF AN ALTERNATE ACCEPTABLE MANUFACTURER OR FROM SYSTEM CONFIGURATIONS THAT ARE LEFT TO THE CHOICE OF THE CONTRACTOR SHALL BE INCLUDED IN THE T.C.'S BID. THIS BID SHALL INCLUDE INSTALLATION BY A LICENSED ELECTRICIAN. UNLESS TRADE RULES DICTATE OTHERWISE.

TELECOM ROOM REFERENCES DETAIL / SHEET FLOOR PLAN TELECOM ROOM REFERENCE REFERENCE

EXISTING IT ROOM 1/T2.00

GRAND TOTAL: 8

	TECHNOLOGY SHEET INDEX	
T0.00	TECHNOLOGY COVERSHEET	
TD1.00	OVERALL DEMOLITION PLANS - TECHNOLOGY	
TD1.01	DEMOLITION PLANS - TECHNOLOGY	
T1.00	OVERALL FLOOR PLANS - TECHNOLOGY	
T1.01	FLOOR PLANS - TECHNOLOGY	
T2.00	TECHNOLOGY ENLARGED PLANS	
T2.01	TECHNOLOGY ENLARGED PLANS	
T5.00	TECHNOLOGY SCHEDULES	

TECHNOLOGY GENERAL NOTES:

- . ##-###-# INDICATES TECHNOLOGY EQUIPMENT SCHEDULE ITEM LABELED AS "EQUIPMENT LIST ABBREVIATION"
- 2. REFER TO TECHNOLOGY EQUIPMENT SCHEDULE AND SPECIFICATIONS FOR FULL DESCRIPTIONS AND MANUFACTURERS OF ALL DEVICES.
- TECHNOLOGY MOUNTING SUBSCRIPT KEY: MOUNT AT +6" TO CENTERLINE ABOVE COUNTER OR BACKSPLASH MOUNT ORIENTED HORIZONTALLY
 - MOUNT IN CASEWORK
 - MOUNT IN MODULAR FURNITURE MOUNT IN SURFACE RACEWAY
- A SLASH IS USED BETWEEN TWO SUBSCRIPTS, E.G., A/H. 3. REFER TO THE TECHNOLOGY EQUIPMENT SCHEDULE FOR MORE COMPLETE DESCRIPTION
- AND ITEMS. 4. REFER TO DIAGRAMS ON SHEET(S): [TXXX, TXXX, TXXX].

TECHNOLOGY INSTALLATION NOTES:

- 1. THE COMPLETE INSTALLATION SHALL BE IN ACCORDANCE WITH THE ADA STANDARDS FOR ACCESSIBLE DESIGN. REFER TO THE ADA GUIDELINES FOR ALL CONFIGURATION DETAILS ON THIS PAGE FOR ADDITIONAL INFORMATION.
- 2. CONCEAL ALL CONDUIT IN WALLS, PARTITIONS, ABOVE CEILING, IN FLOOR SLAB, ETC. UNLESS OTHERWISE INDICATED ON THE PLANS OR IN THE SPECIFICATIONS. CONDUIT IN MECHANICAL ROOMS AND STORAGE ROOMS WITHOUT CEILINGS MAY BE EXPOSED ON BUILDING STRUCTURE.
- BOXES LOCATED ON OPPOSITE SIDES OF NON-RATED WALLS SHALL BE OFFSET A MINIMUM OF 6" HORIZONTALLY. BOXES ON OPPOSITE SIDES OF FIRE RATED WALLS SHALL BE OFFSET A MINIMUM OF 24" HORIZONTALLY. "THRU-THE-WALL" BOXES SHALL NOT BE ALLOWED WITHOUT PRIOR WRITTEN APPROVAL OF THE ARCHITECT/ENGINEER.
- ARCHITECTURAL PLANS, ELEVATIONS, AND REVIEWED SHOP DRAWINGS. PRIOR TO MAKING THE ACTUAL TELECOMMUNICATIONS INSTALLATION, ADJUST OUTLETS OR CONNECTION LOCATIONS TO ACCOMMODATE FURNITURE AND/OR EQUIPMENT. 5. TELECOMMUNICATIONS EQUIPMENT SHALL BE MOUNTED TO ALLOW ACCESS TO ELECTRICAL AND MECHANICAL EQUIPMENT. ALL MOUNTING OF TELECOMMUNICATION

4. VERIFY ALL FURNITURE, MODULAR FURNITURE, AND EQUIPMENT LOCATIONS WITH

ADVANCE BY THE OTHER CONTRACTOR. 6. CONTRACTOR SHALL BE RESPONSIBLE FOR ALL OPENINGS REQUIRED IN WALLS. ALL OPENINGS SHALL BE REPAIRED TO MATCH EXISTING BY A QUALIFIED CONTRACTOR AT THE EXPENSE OF THIS CONTRACTOR. ALL CONDUITS THROUGH WALLS SHALL BE GROUTED OR

DEVICES ON EQUIPMENT SUPPLIED BY ANOTHER CONTRACTOR SHALL BE APPROVED IN

- ALL MATERIALS USED TO SEAL PENETRATIONS OF FIRE RATED WALLS AND FLOORS SHALL BE TESTED AND CERTIFIED AS A SYSTEM PER ASTM E814 STANDARDS FOR FIRE TESTS OF THROUGH-PENETRATION FIRESTOPS. REFER TO 27 05 03 FOR ADDITIONAL INFORMATION
- AND REQUIREMENTS SPECIFIC TO FIRESTOPPING. 8. THE TECHNOLOGY CONTRACTOR IS RESPONSIBLE FOR REMOVAL AND REPLACEMENT OF THE CEILINGS, CEILING TILES, AND CEILING GRID ASSOCIATED WITH THE AREAS OF WORK BY ALL CONTRACTORS. NOTIFY THE GENERAL CONTRACTOR OF AFFECTED AREAS PRIOR
- 9. EACH CONTRACTOR IS RESPONSIBLE FOR DAMAGE CAUSED BY THEIR ACTIONS TO THE WALLS, FLOORS, CEILINGS, AND ROOFS. THE CONTRACTOR WHOSE WORK CAUSES DAMAGE IS RESPONSIBLE FOR PATCHING TO MATCH ORIGINAL CONSTRUCTION, FIRE RATING, AND FINISH.

TECHNOLOGY DEMOLITION NOTES

- 1. THE DRAWINGS INDICATE EXISTING ITEMS TO BE REMOVED. THE DRAWINGS ARE INTENDED TO INDICATE THE SCOPE OF WORK REQUIRED AND DO NOT INDICATE EVERY BOX, CONDUIT, OR WIRE THAT MUST BE REMOVED. THE CONTRACTOR SHALL VISIT THE SITE PRIOR TO SUBMITTING A BID AND VERIFY EXISTING CONDITIONS.
- ITEMS (i.e. SPEAKERS, SWITCHES, ETC.) REMOVED AND NOT RELOCATED REMAIN THE PROPERTY OF THE OWNER. THE CONTRACTOR SHALL BE RESPONSIBLE FOR THE DISPOSAL OF MATERIAL THE OWNER DOES NOT WANT TO REUSE OR RETAIN. (i.e., FOR MAINTENANCE PURPOSES
- 3. EXISTING TO REMAIN DEVICES WITHIN OR ADJACENT TO THE PATH OF CONSTRUCTION SHALL BE PROTECTED IN PLACE. DEVICES THAT MUST BE REMOVED SHALL BE TESTED PRIOR TO REMOVAL, PROTECTED FROM DAMAGE, AND RE-INSTALLED IN ITS ORIGINAL LOCATION DURING THE NEW CONSTRUCTION PHASE OF THE PROJECT. 4. OBTAIN APPROVAL FROM THE OWNER BEFORE TURNING OFF THE POWER TO
- EQUIPMENT, SYSTEMS, PANELS, ETC. COORDINATE ALL OUTAGES WITH OWNER. CONDUIT CONCEALED IN WALL CONSTRUCTION MAY BE ABANDONED IN PLACE IF NOT AFFECTED BY OTHER CONSTRUCTION.
- 5. ALL CONDUIT SHALL BE REMOVED WHERE WALLS ARE BEING REMOVED. WHERE CONDUIT IS IN THE CONCRETE SLAB, CUT OFF FLUSH, PULL OUT WIRE, AND PLUG. WHERE CONDUIT IS RUN EXPOSED, ALL ASSOCIATED CLAMPS, SUPPORTS, HANGERS, ETC., SHALL ALSO BE REMOVED.
- 6. COORDINATE ALL WORK WITH OTHER CONTRACTORS AT THE JOB SITE BEFORE REMOVING EXISTING EQUIPMENT AND INSTALLING NEW ITEMS.
- 7. EXISTING CONDUIT IN GOOD CONDITION, MAY BE REUSED IN PLACE. RELOCATING EXISTING CONDUIT SHALL NOT BE ALLOWED. BONDING CONDUCTORS SHALL BE
- INSTALLED IN ALL REUSED CONDUIT TO ASSURE PROPER GROUND PATH. 8. EQUIPMENT REMOVAL IN CERTAIN LOCATIONS MAY REQUIRE THE INSTALLATION OF A JUNCTION BOX TO RECONNECT CIRCUITS THAT REMAIN IN OPERATION. EXTEND
- CONDUIT AND WIRING AS REQUIRED TO MAINTAIN POWER TO REMAINING EQUIPMENT. 9. DEVICES TO BE REMOVED SHALL HAVE ALL CONNECTED WIRING REMOVED TO THE
- 10. DEVICES NOT TO BE REMOVED SHALL BE PROTECTED FROM THE ENVIRONMENT, AND ALL ASSOCIATED CABLE/RACEWAYS ARE TO REMAIN AND BE PROTECTED. T.C. SHALL BE RESPONSIBLE FOR REPAIR OF ANY INTERRUPTIONS TO PROTECTED DEVICES.

11. REFER TO SPECIFICATIONS SECTION 27 05 00 FOR ADDITIONAL INFORMATION.



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ARCHITECT OF RECORD

S / MEP / FP / T ENGINEERS:

550 NAPERVILLE, IL 60563

CHICAGO, IL 60661

P: 312.496.0000

IMEG CORP.

P: 630.527.2320

DEMONICA KEMPER ARCHITECTS

253 SHUMAN BOULEVARD, SUITE

125 N. HALSTED STREET, SUITE 301



KEY PLAN:

SHEET STATUS: **ISSUED FOR BID - NOT** FOR CONSTRUCTION

SHEET TITLE: **TECHNOLOGY** COVERSHEET

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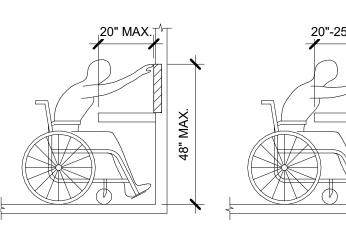
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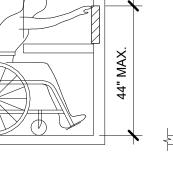
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INSTALL ABOVE COUNTER

DEVICE AT 44" ABOVE

FINISHED FLOOR.

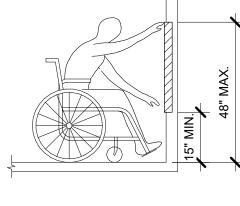


INSTALL ABOVE COUNTER

ADA GUIDELINES - FRONT ACCESS

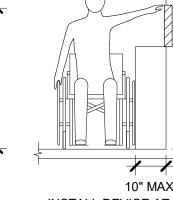
DEVICE AT 40" ABOVE

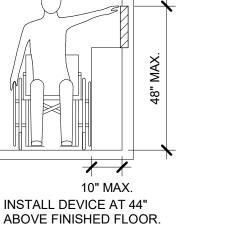
FINISHED FLOOR.



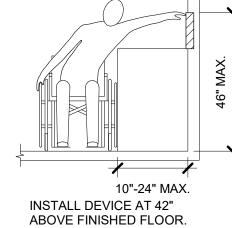
INSTALL DEVICE AT 18"

ABOVE FINISHED FLOOR.





ADA GUIDELINES - SIDE ACCESS

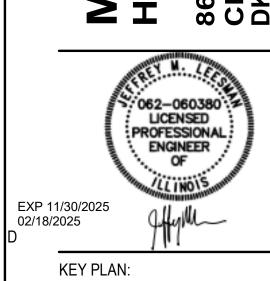






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IMEG CORP.
253 SHUMAN BOULEVARD, SUITE
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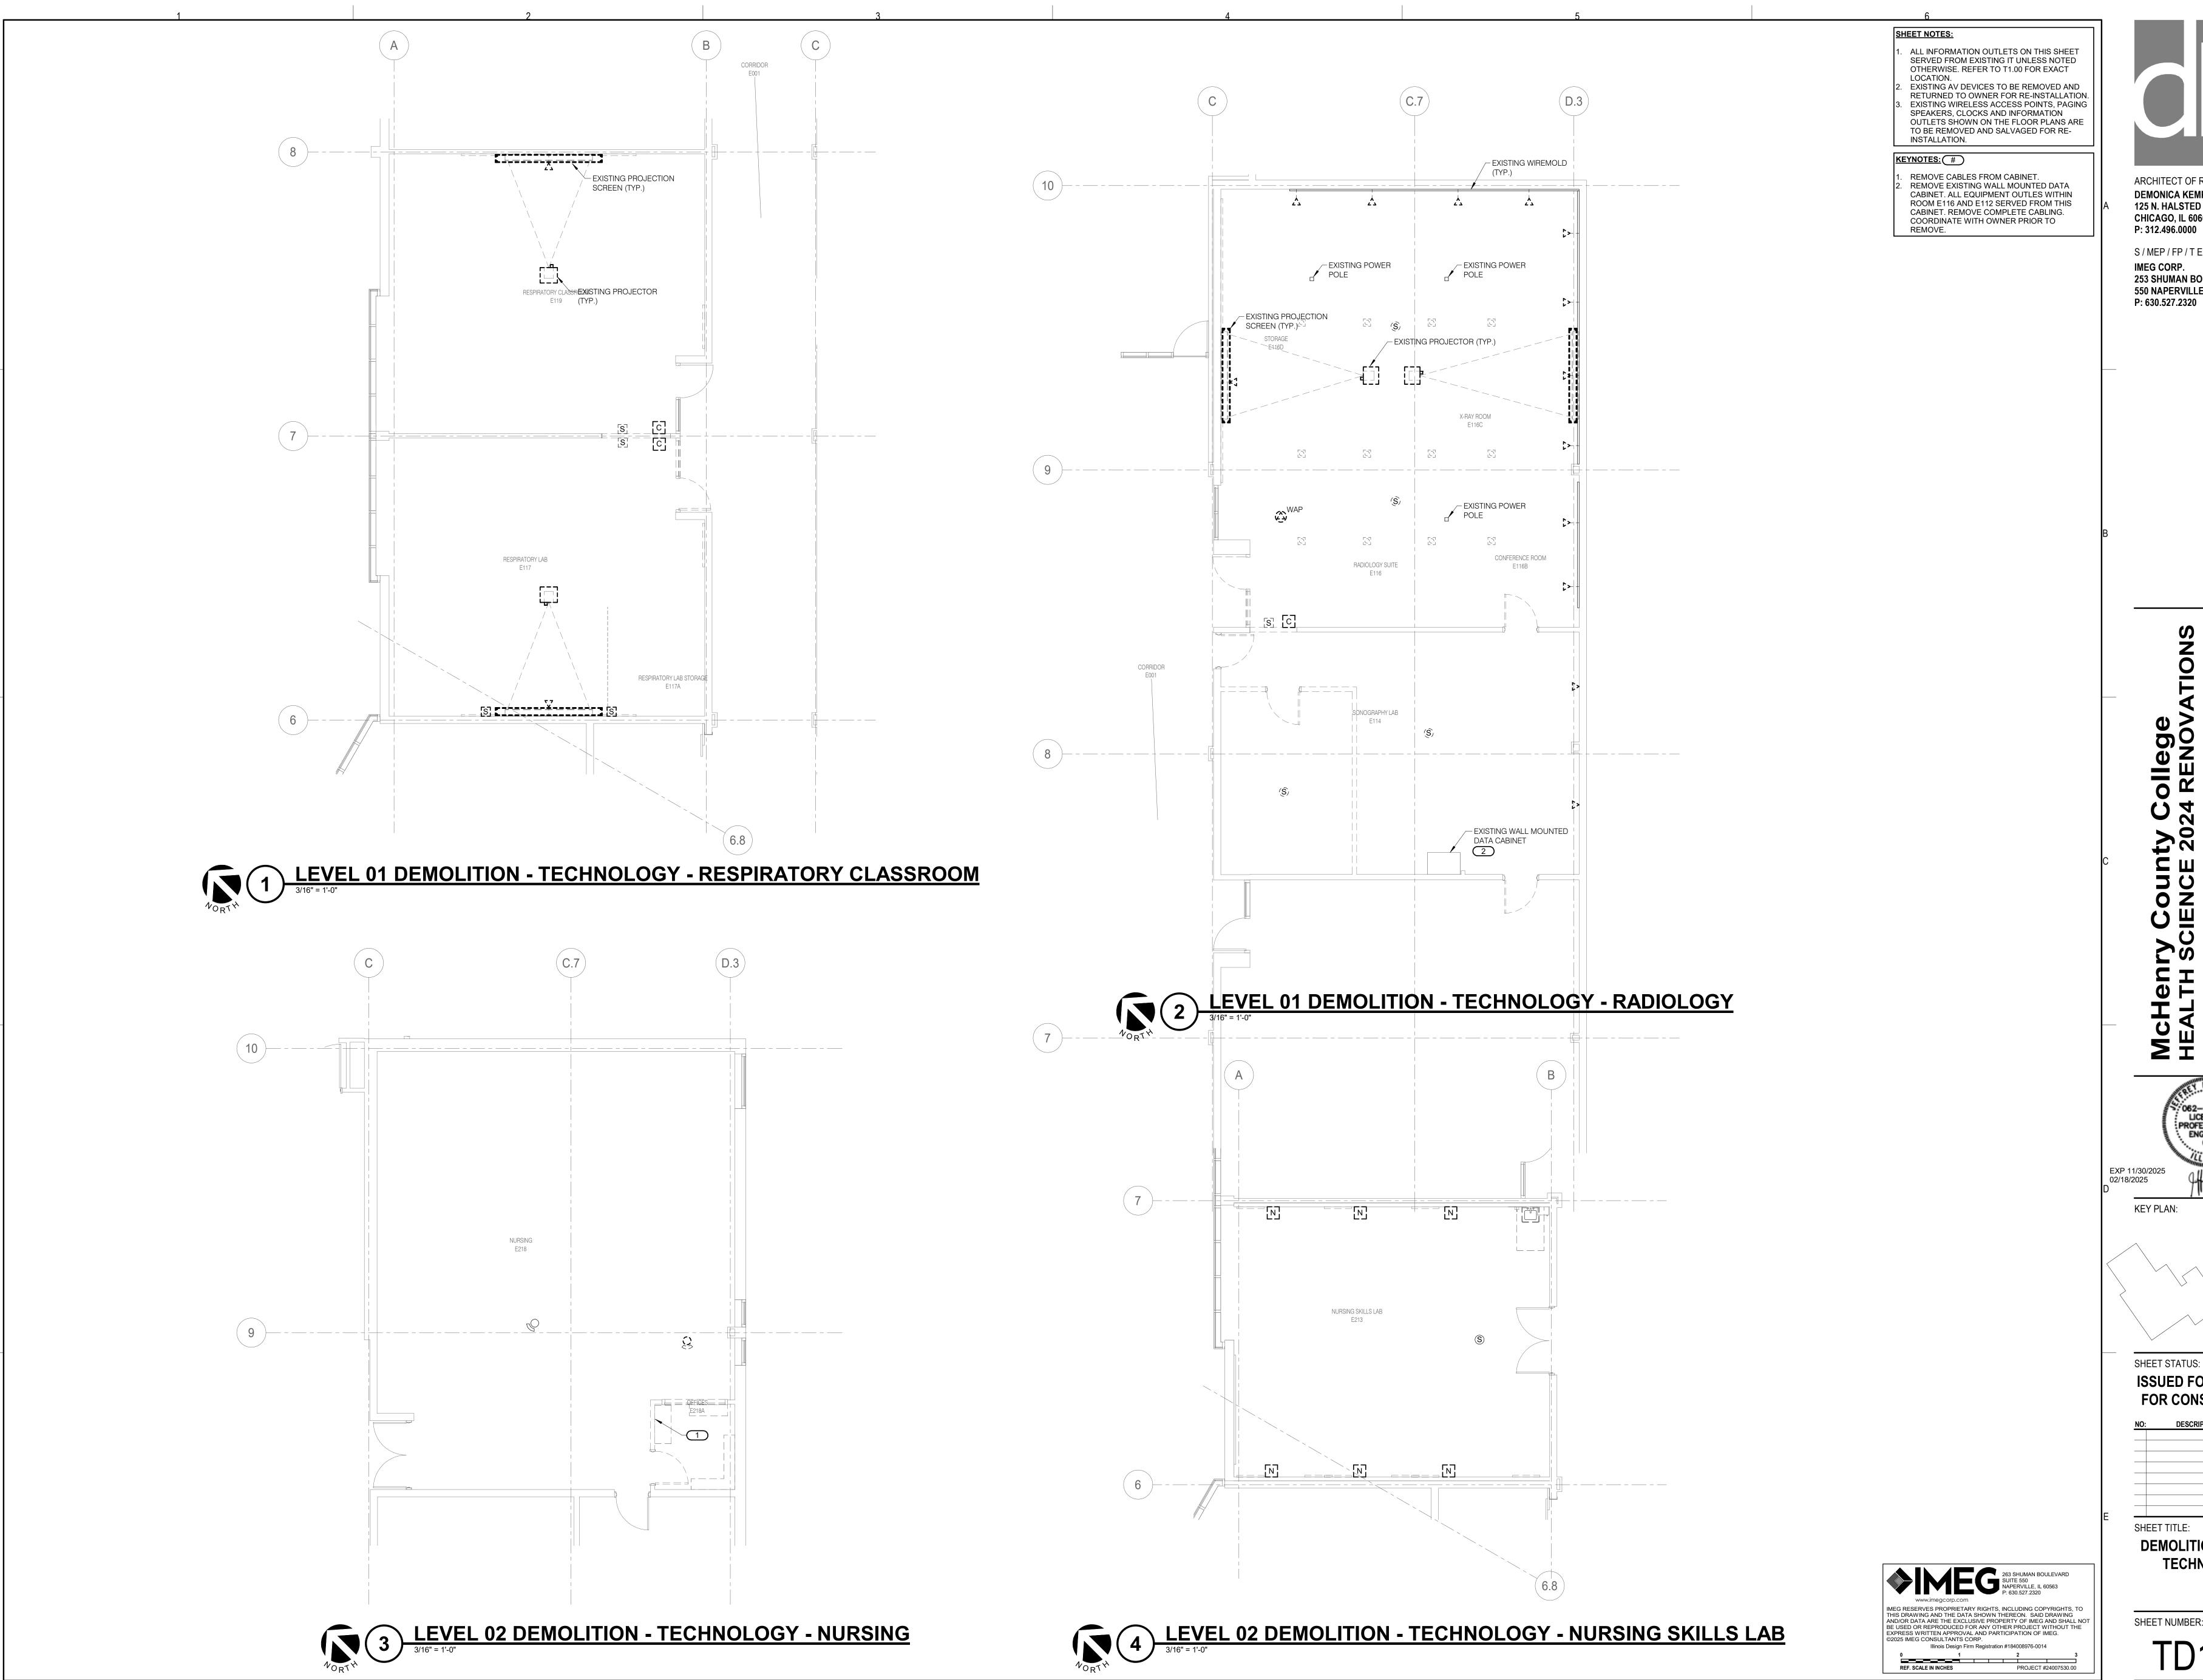
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OVERALL
DEMOLITION PLANS TECHNOLOGY

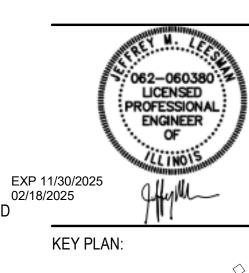
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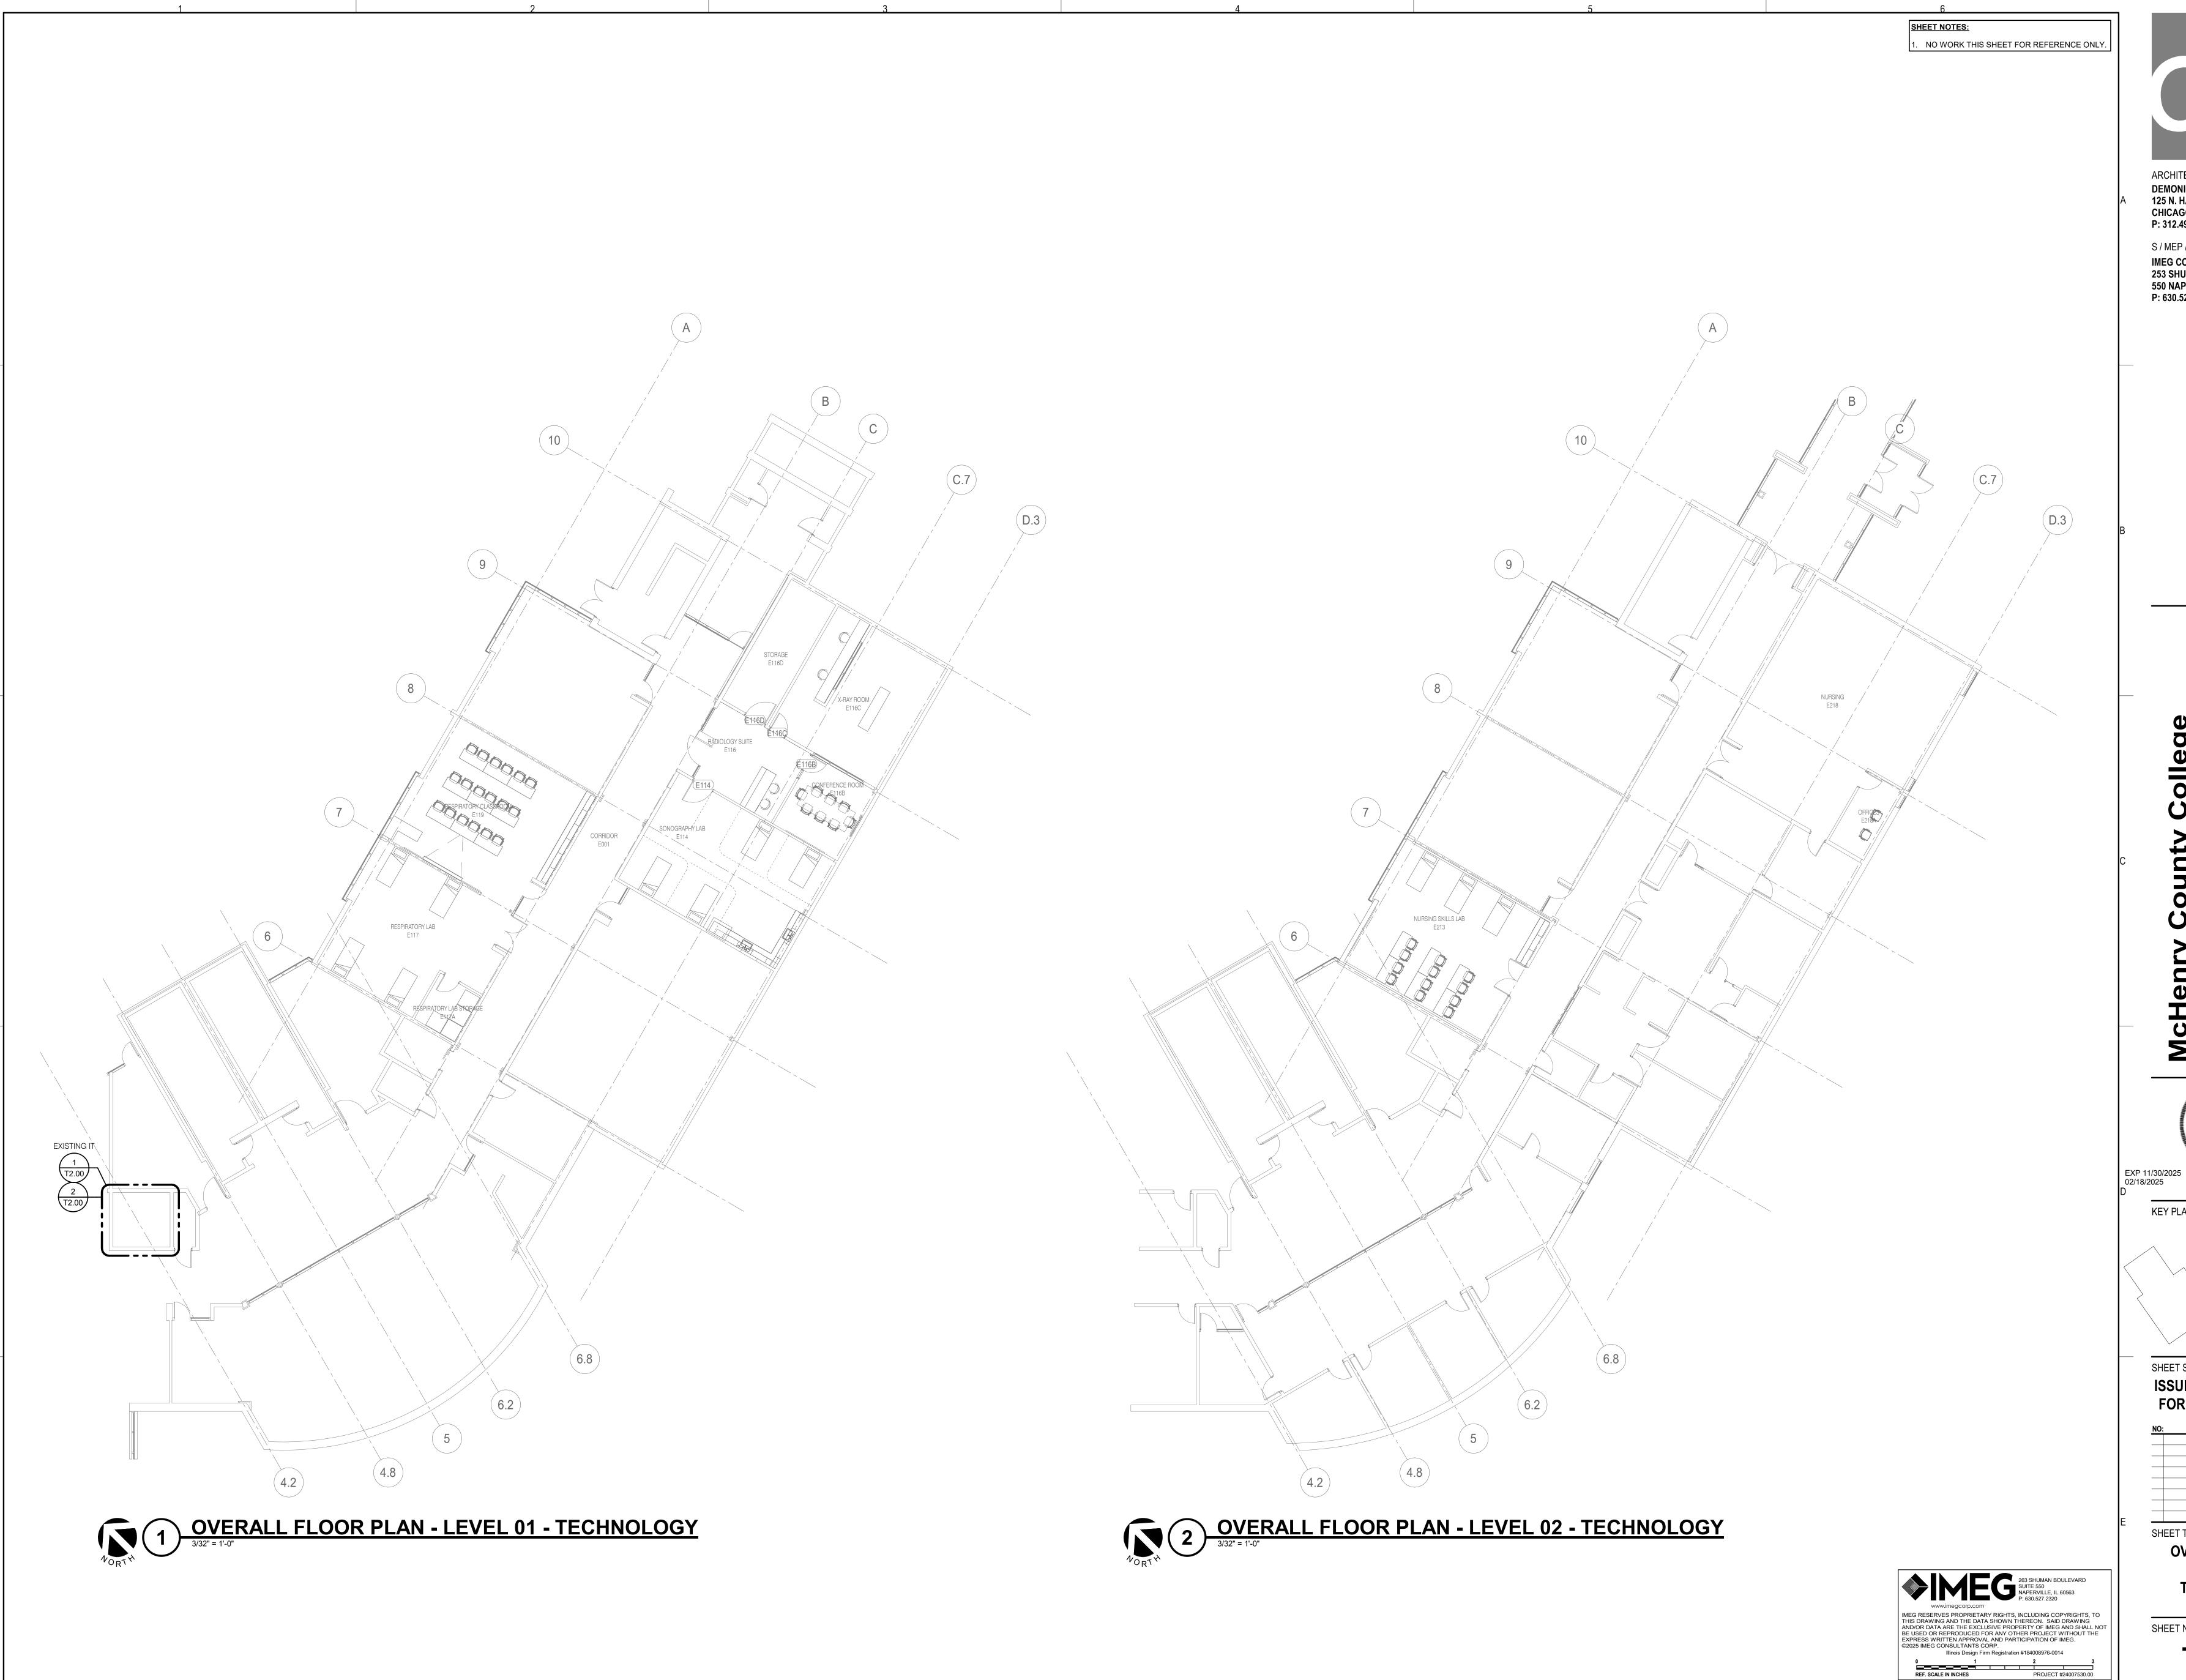
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SHEET TITLE: **DEMOLITION PLANS -TECHNOLOGY**

SHEET NUMBER:

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KEY PLAN:

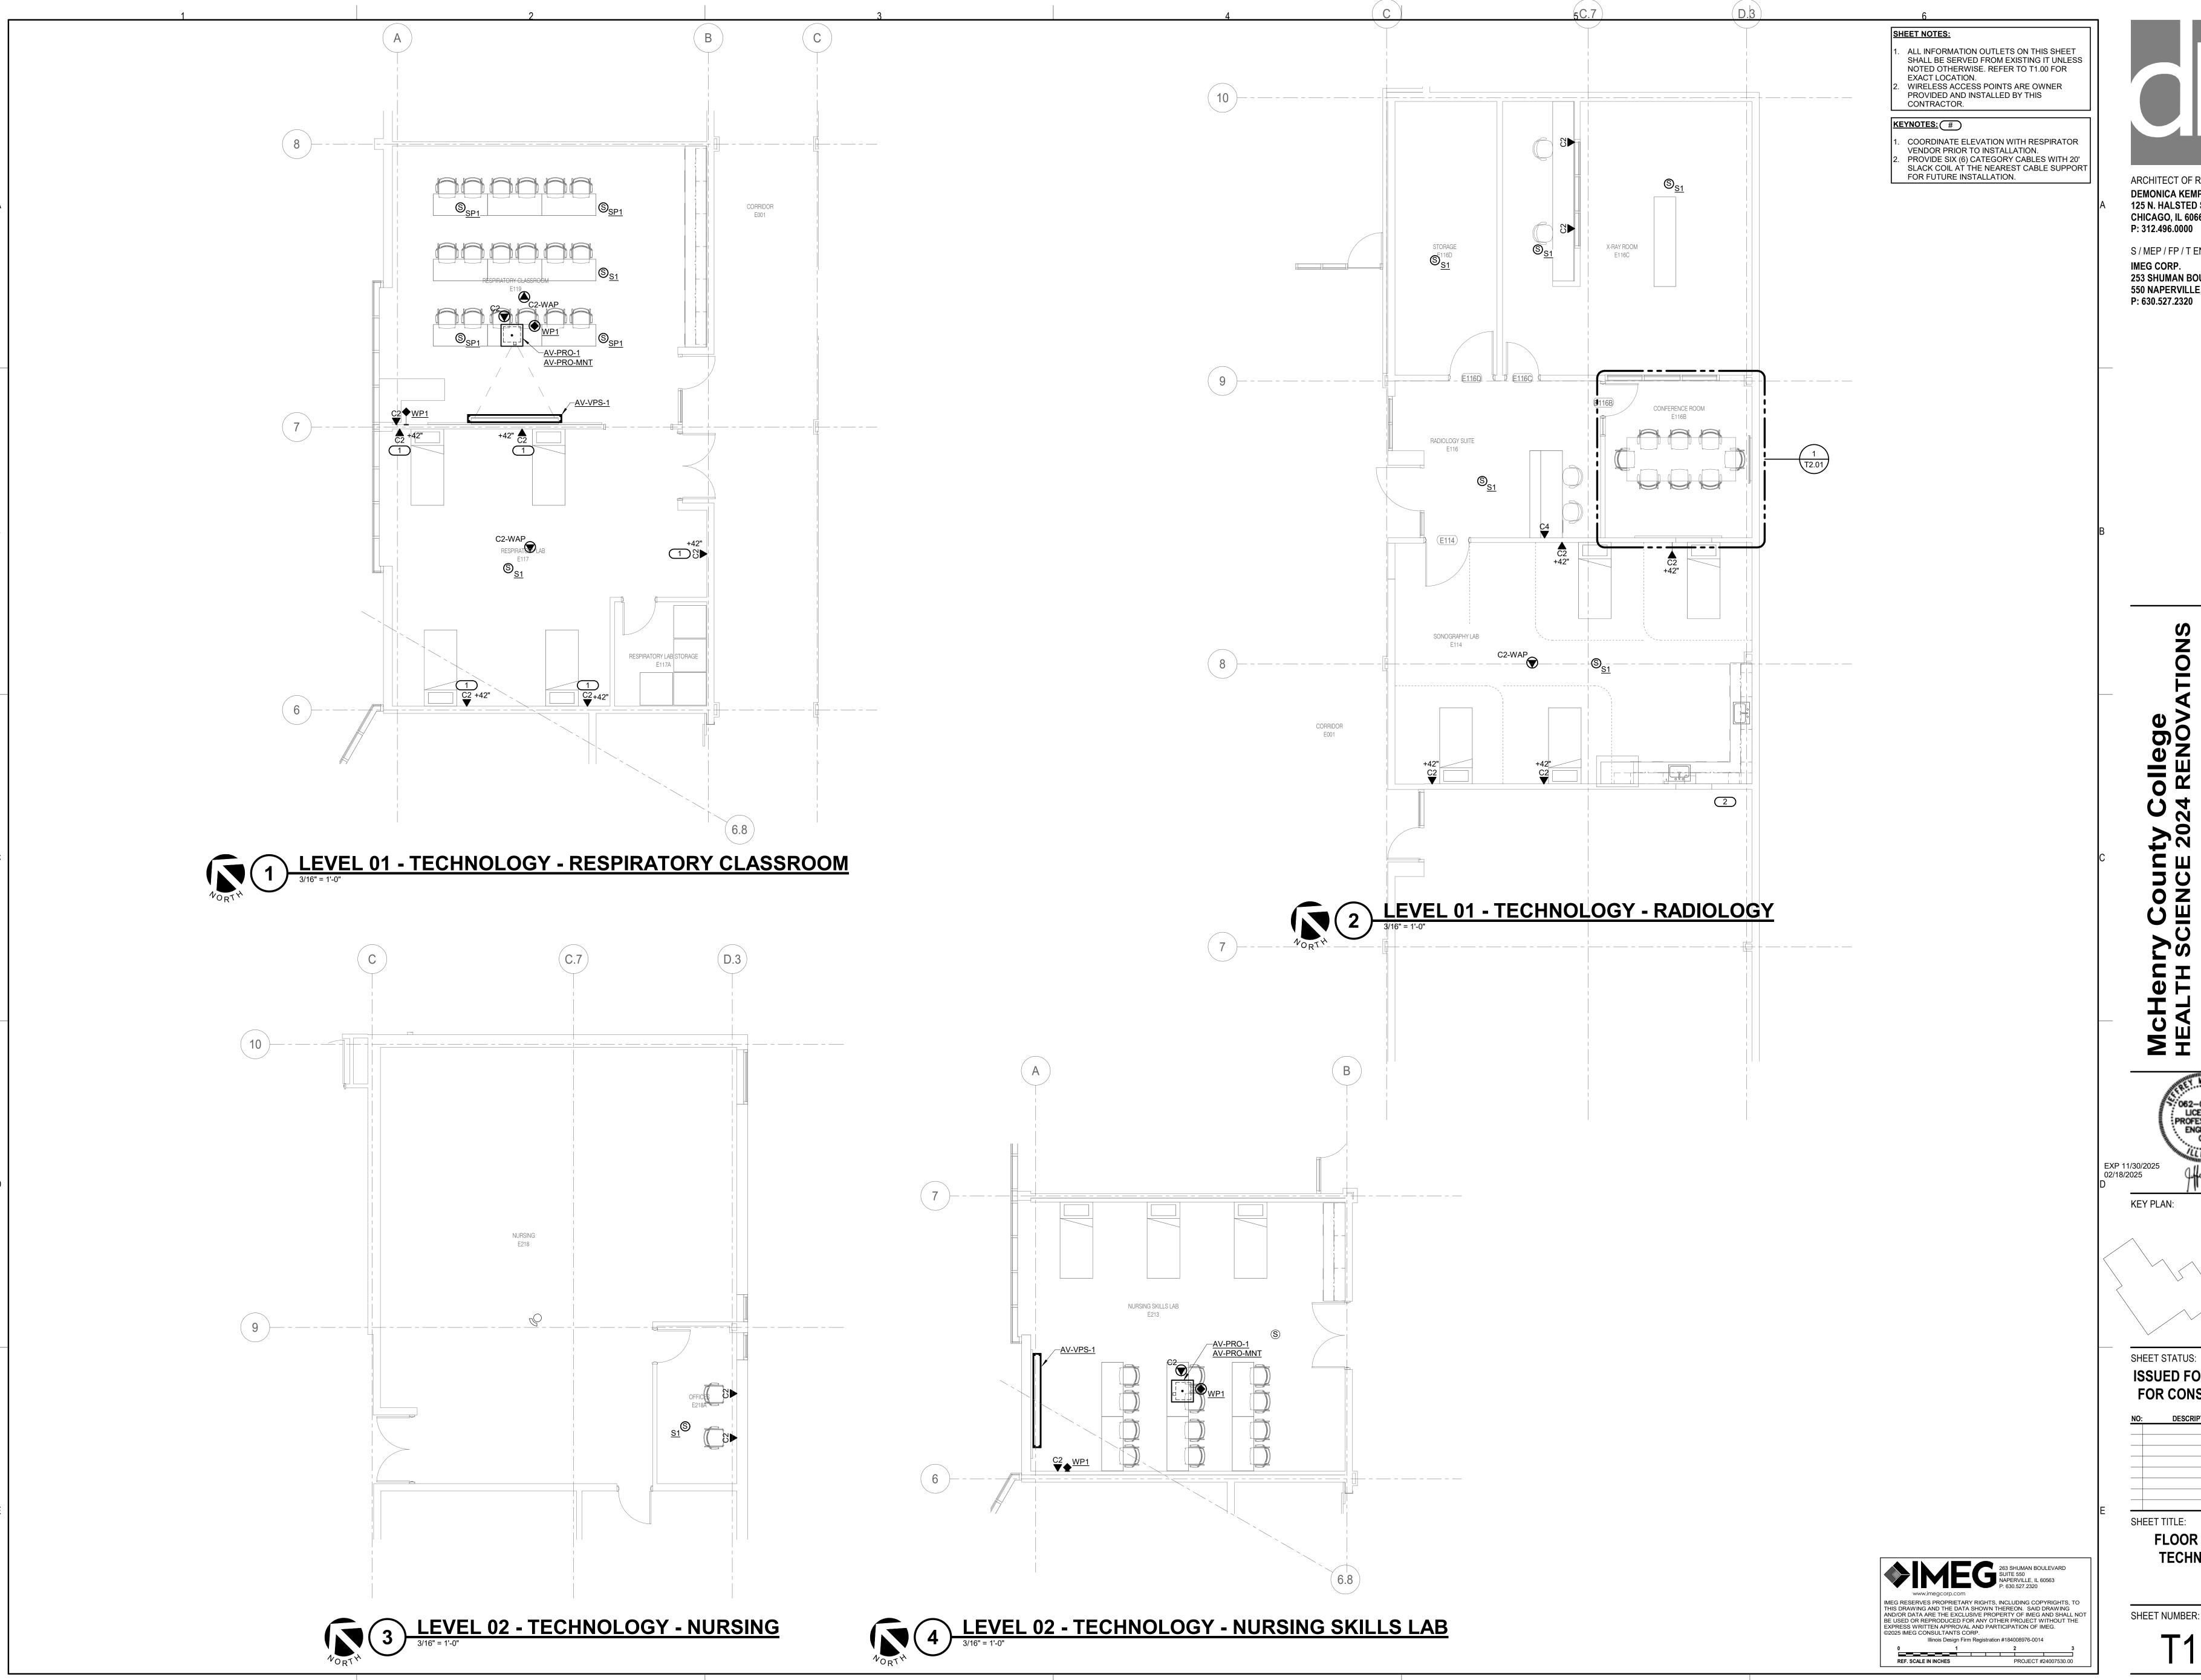
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SHEET TITLE:

OVERALL FLOOR PLANS -**TECHNOLOGY**

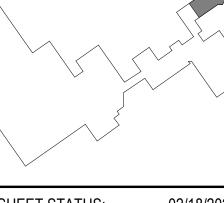
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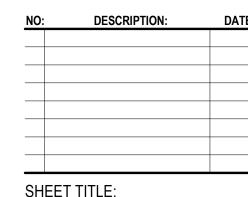




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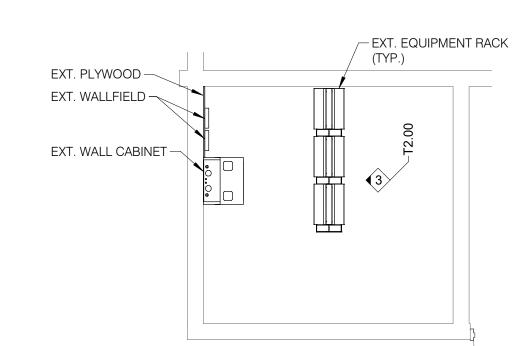
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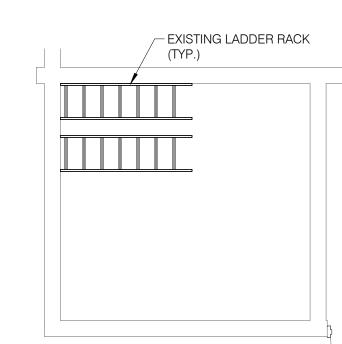
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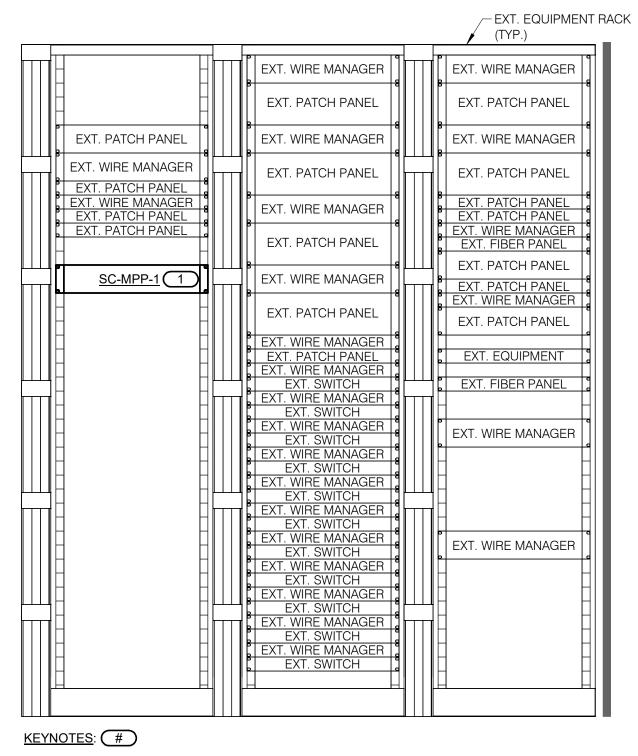
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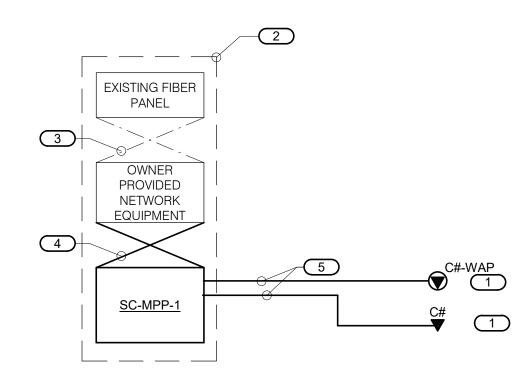


EQUIPMENT ROOM PATHWAY - EXISTING IT



1. COORDINATE FINAL LOCATION WITH OWNER PRIOR TO INSTALLATION.

BUILDING IT 1" = 1'-0"



NOTES:

- 1. THIS RISER IS DIAGRAMMATIC AND MAY NOT SHOW ACTUAL ROUTING OR QUANTITIES OF MATERIALS SHOWN. THIS RISER IS SHOWN FOR CLARIFICATION OF CONNECTION(S), LOCATIONS AND CABLE TYPE. ALL INFORMATION OUTLETS ARE TYPICAL OF THE OUTLETS IN THE AREA SHOWN. REFER TO FLOOR PLANS FOR MORE SPECIFIC ROUTING INFORMATION. REFER TO
- SPECIFICATIONS FOR ADDITIONAL REQUIREMENTS.

 2. REFER TO FLOOR PLANS FOR QUANTITY OF CABLES AND JACKS TO BE INSTALLED AT EACH INFORMATION OUTLET.

KEYNOTES:

- C# INDICATES VOICE/DATA FACEPLATE CONFIGURATION. REFER TO THE INFORMATION OUTLET SCHEDULE AND SPECIFICATION SECTION 27 15 00 FOR ADDITIONAL INFORMATION.

 2. PACK(S) OR CARINET(S) AS DEFINED ON THE TELECOM ROOM LAYOUT PEEER TO THE TELECOM.
- RACK(S) OR CABINET(S) AS DEFINED ON THE TELECOM ROOM LAYOUT. REFER TO THE TELECOM ROOM REFERENCES MATRIX ON THE COVERPAGE FOR LOCATION.
 EXISTING FIBER PATCH CORDS.
- RJ-45 TO RJ45 CATEGORY 6 UTP PATCH CORDS, REFER TO SPECIFIATIONS.
 4-PAIR, CATEGORY 6, UNSHIELDED TWISTED PAIR CABLE, REFER TO SPECIFICATIONS.

CONNECTIVITY RISER DIAGRAM - EXISTING IT
NO SCALE

ARCHITECT OF RECORD

DEMONICA KEMPER ARCHITECTS
125 N. HALSTED STREET, SUITE 301
CHICAGO, IL 60661
P: 312.496.0000

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IMEG CORP.
253 SHUMAN BOULEVARD, SUITE
550 NAPERVILLE, IL 60563
P: 630.527.2320

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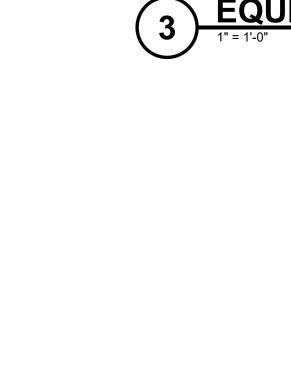
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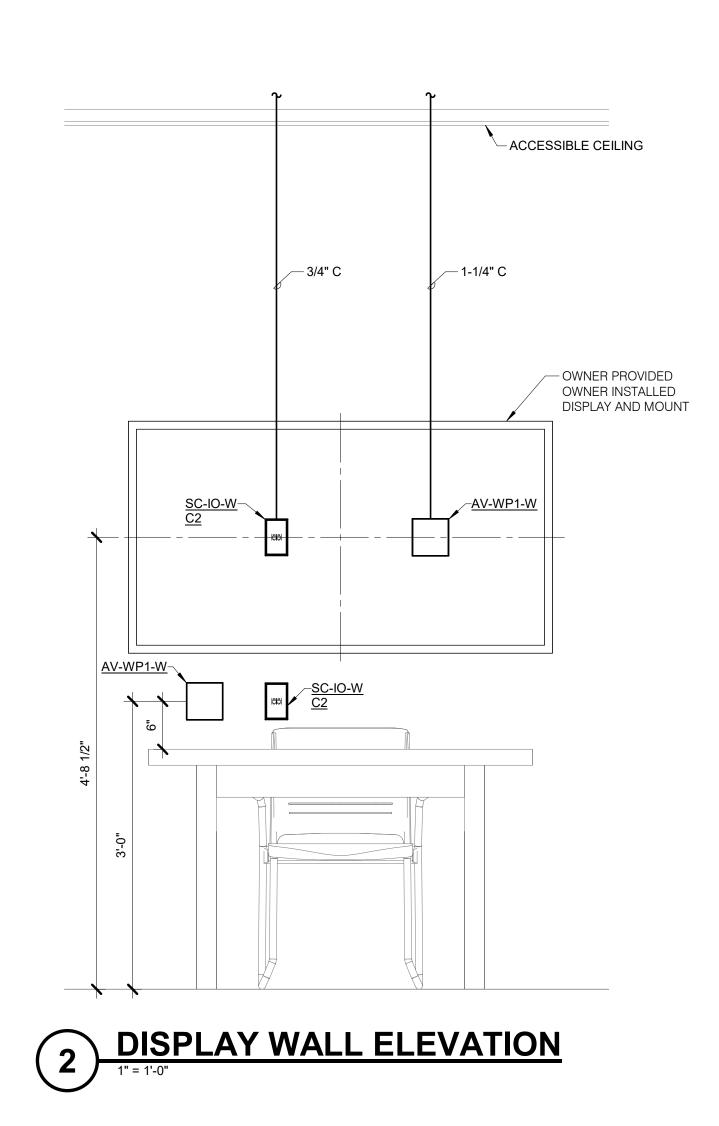
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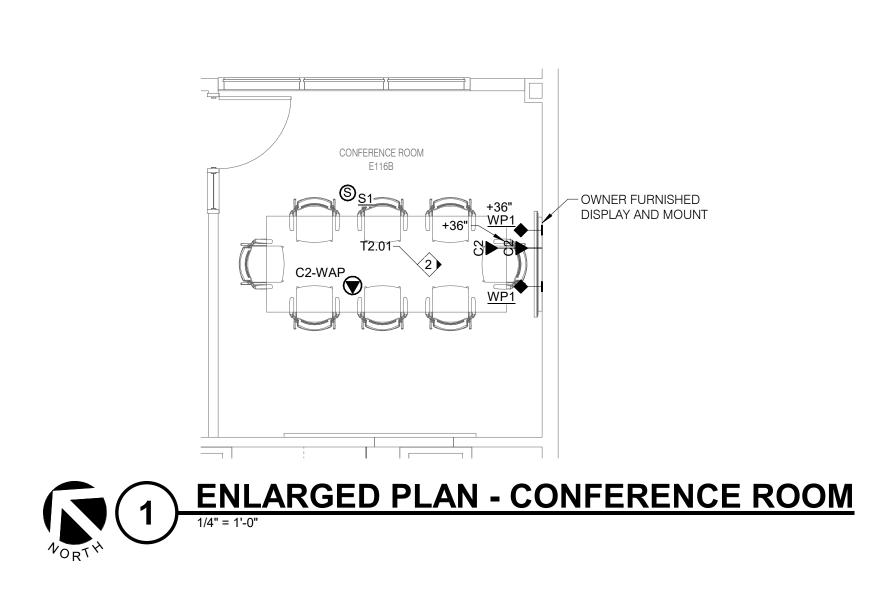
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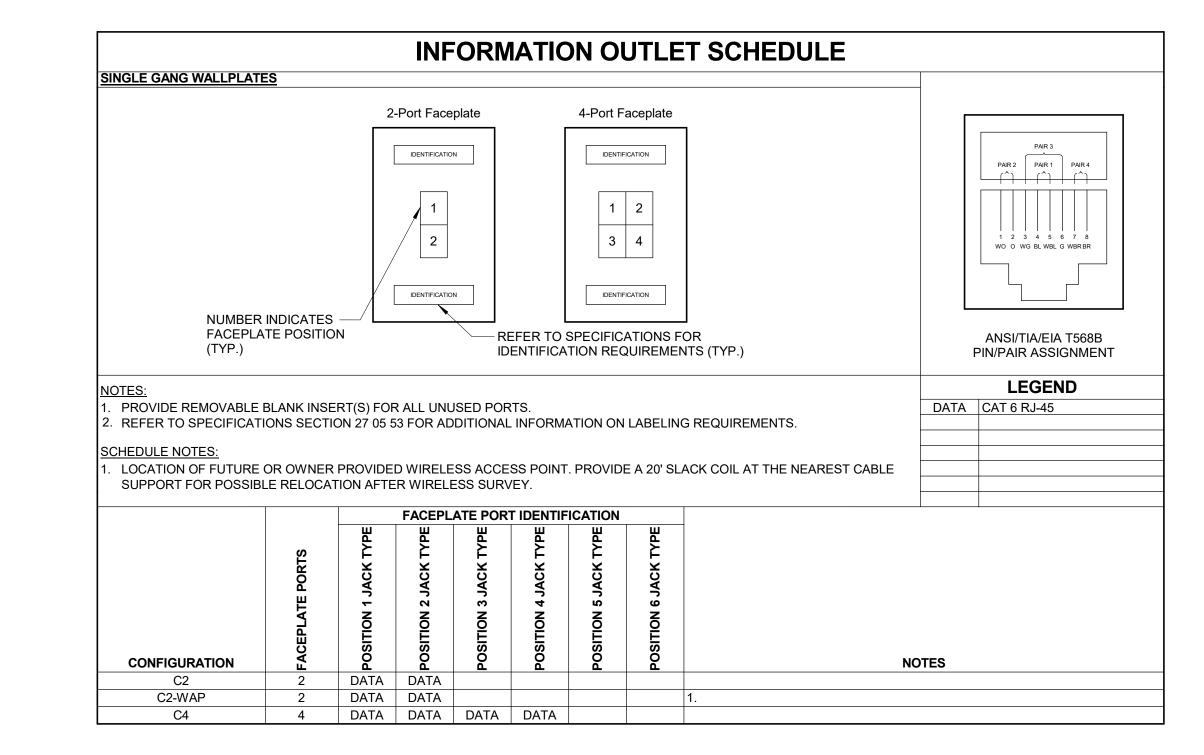
TECHNOLOGY EQUIPMENT SCHEDULE

THE EQUIPMENT LIST ABBREVIATIONS AND THE TECHNOLOGY EQUIPMENT SCHEDULE ARE FOR THE CONVENIENCE OF THE CONTRACTOR. EACH CONTRACTOR SHALL BE RESPONSIBLE FOR VERIFICATION OF QUANTITIES AND SHALL FURNISH ALL MATERIAL REQUIRED, WHETHER SPECIFIED OR NOT, TO PRODUCE A SATISFACTORY WORKING SYSTEM.

CATALOG NUMBERS ARE NOT TO BE CONSIDERED COMPLETE BUT ARE GIVEN ONLY TO AID THE CONTRACTOR IN THE SEARCH FOR MATERIAL. NO MATERIAL SHALL BE ORDERED BY MANUFACTURER AND CATALOG NUMBER ONLY. EACH CONTRACTOR SHALL FIRST READ THE COMPLETE DESCRIPTION OF THE MATERIAL ON THESE DRAWINGS AND SPECIFICATIONS. THE FIRST MANUFACTURER LISTED IS THE BASIS OF DESIGN. "STANDARD COLOR" INDICATES FACTORY FINISH AVAILABLE AT NO

ADDITIONAL CHARGE.

EQUIPMENT LIST ABBREVIATION	EQUIPMENT LIST DESCRIPTION	MANUFACTURER A MODEL
AV-PRO-1	VIDEO PROJECTOR, OWNER PROVIDED OWNER INSTALLED.	OWNER PROVIDED
AV-PRO-MNT	PROJECTOR MOUNT, OWNER PROVIDED OWNER INSTALLED.	OWNER PROVIDED
AV-SP1-C	AUDIO VISUAL SPEAKER. 110 CONICAL COVERAGE. 6.5" LOW FREQUENCY WITH SILK DOME TWEETER. RATED AT 75 WATTS, 8 OHMS, AND 60 WATT MULTI-TAP TRANSFORMER. WHITE FINISH PROVIDE WITH TILE BRIDGE OR DRYWALL TRIM RING.RESPONSE CURVE AT 500, 1000, 2000, 4000 AND 8000 Hz, AS WELL AS A FREQUENCY RESPONSE CURVE.	JBL CONTROL 26CT TANNOY
		COMMUNITY
AV-VPS-1	VIDEO PROJECTION SCREEN, OWNER PROVIDED OWNER INSTALLED.	OWNER PROVIDED
AV-WP1-C	AV PLATE, CEILING MOUNT, OWNER PROVIDED OWNER INSTALLED.	OWNER PROVIDED
	PROVIDE 4" SQUARE BACK BOX WITH SINGLE GANG PLASTER RING AND 1-1/4" EMT CONDUIT STUBBED TO ABOVE ACCESSIBLE CEILING.	
AV-WP1-W	AV PLATE, WALL MOUNT, OWNER PROVIDED OWNER INSTALLED.	OWNER PROVIDED
	PROVIDE 4" SQUARE BACK BOX WITH SINGLE GANG PLASTER RING AND 1-1/4" EMT CONDUIT TO ABOVE ACCESSIBLE CEILING.	
PA-S1-C	SPEAKER. 8" DUAL-CONE 4 WATT TRANSFORMER. 10 oz CERAMIC MAGNET. 25 AND 70.7 VOLTS. PROVIDE BACK BOX AND MOUNTING HARDWARE AS NECESSARY FOR INSTALLATION IN LAY-IN CEILING. REFER TO SPECIFICATION SECTION 27 51 13 FOR CONDUIT REQUIREMENTS AND ADDITIONAL INFORMATION.	BOGEN S10T725PG8WVR
	27 OF TOT OR GOINDON REQUIREMENTS /NB	ATLAS SOUND VALCOM
SC-IO-C	INFORMATION OUTLET, CEILING MOUNT, 2 PORT COVERPLATE AS INDICATED ON DRAWINGS.	FACEPLATE: HUBBELL
	"#" INDICATES INFORMATION OUTLET FACEPLATE CONFIGURATION AS INDICATED ON THE PLANS. REFER TO T5.00 FOR INFORMATION OUTLET SCHEDULE FOR PIN CONFIGURATION.	IFP12OW (2-PORT)
	INSTALL INFORMATION OUTLET IN A 4" SQUARE BACKBOX WITH A SINGLE GANG PLASTER RING. INSTALL A 1" EMT CONDUIT STUBBED TO ABOVE ACCESSIBLE CEILING. PROVIDE REMOVABLE BLANK INSERTS FOR UNUSED PORTS (HUBBELL SFB10A OR APPROVED EQUAL).	JACK: HUBBELL HXJ6 SERIES
		NO SUBSTITUTIONS
SC-IO-W	INFORMATION OUTLET, WALL MOUNT, 2,4 PORT COVERPLATE AS INDICATED ON DRAWINGS.	FACEPLATE:
	"#" INDICATES INFORMATION OUTLET FACEPLATE CONFIGURATION AS INDICATED ON THE PLANS. REFER TO T5.00 FOR INFORMATION OUTLET SCHEDULE FOR PIN CONFIGURATION.	HUBBELL IFP12OW (2-PORT) IFP14OW (4-PORT)
	INSTALL INFORMATION OUTLET IN A 4" SQUARE BACKBOX WITH A SINGLE GANG PLASTER RING. INSTALL A 1" EMT CONDUIT TO ABOVE ACCESSIBLE CEILING. PROVIDE REMOVABLE BLANK INSERTS FOR UNUSED PORTS (HUBBELL SFB10A OR APPROVED EQUAL).	JACK: HUBBELL HXJ6 SERIES
		NO SUBSTITUTIONS
SC-MPP-1	MODULAR PATCH PANEL, RACK MOUNT, 48 MODULAR RJ-45 TERMINATIONS, MOUNTS DIRECTLY TO EIA/TIA STANDARD 19" RELAY RACK, PORT IDENTIFICATION NUMBERS, COLOR CODING AND LABEL HOLDER KITS, U.L. LISTED. REQUIRES (2) 1.75" MOUNTING SPACES.	HUBBELL P6E48U
	(2) THE MODITING OF NOLE.	NO SUBSTITUTIONS
SC-WAP-C	INFORMATION OUTLET, 2-PORT SURFACE MOUNT BOX AS INDICATED ON DRAWINGS.	FACEPLATE: HUBBELL
	"#" INDICATES INFORMATION OUTLET FACEPLATE CONFIGURATION AS INDICATED ON THE PLANS. REFER TO T5.00 FOR INFORMATION OUTLET SCHEDULE FOR PIN CONFIGURATION.	ISB2BK (2-PORT)
	INSTALL A 3/4" EMT CONDUIT 6" BEYOND BOX AND TERMINATE WITH A NYLON BUSHING.	JACK: HUBBELL HXJ6 SERIES
		NO SUBSTITUTIONS





ARCHITECT OF RECORD

DEMONICA KEMPER ARCHITECTS

125 N. HALSTED STREET, SUITE 301

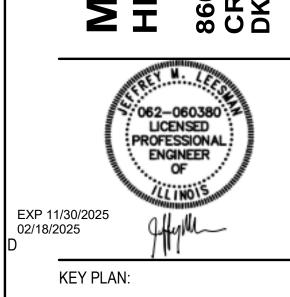
CHICAGO, IL 60661

P: 312.496.0000

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IMEG CORP.
253 SHUMAN BOULEVARD, SUITE
550 NAPERVILLE, IL 60563
P: 630.527.2320

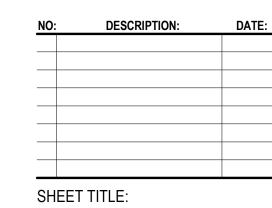
McHenry County College HEALTH SCIENCE 2024 RENOVATION



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