MCHENRY COUNTY COLLEGE

UNIVERSITY CENTER AT MCC

222 E CHURCH ST WOODSTOCK, ILLINOIS 60098

DKA PROJECT NO: 22-050





ARCHITECT:

DEMONICA KEMPER ARCHITECTS 125 N. HALSTED ST., SUITE 301 CHICAGO, IL 60661 T: 312.496.0000 F: 312.496.0001



MEP-FP-T-ENGINEERS

20/10 ENGINEERING GROUP, LLC 1216 TOWER ROAD SCHAUMBURG,IL 60173 P: 847.882.2010 F: 847.882.2201



CIVIL ENGINEERS

HRG GREEN 1391 CORPORATE DRIVE, SUITE 203 MChENRY, IL 60050 P:815.385.1778 F:815.385.1781 ISSUED FOR BIDS 9.19.23

ABBREVIATIONS

CPT

CT

CLR

CLO

COL

CONC

CONN

CONST

CONT

CONTR

CNSK

CRS

DEPT

DIM

DISP

DIV

DBL

DRW

DWG

DS

DWT

EIFS

ELVTR

ENCL

EP PT

EXSTG EXP

EXPD

FIN

FUTR

GALV

GEN

GTC

GD

GND

GL

FA

DS

CK

CARPET

CLEAR

CLOSET

COLUMN

CONCRETE

CONNECTION

CONTRACTOR

COUNTERSUNK

DEPARTMENT

DEAD LOAD

DIAMETER

DIMENSION

DISPENSER

DOOR OPENING

DRINKING FOUNTAIN

DETECTABLE WARNING TILE

EXTERIOR INSULATION FINISH SYSTEM

ELECTRICAL TRADES CONTRACTOR

ELECTRICAL WATER COOLER

ELECTRICAL PANEL BOARD

DRY STANDPIPE

DIVISION

DOOR

DOUBLE

DOWNSPOUT

DRAWER

DRAWING

ELECTRICAL

ELEVATION

ELEVATION

ELEVATOR

ENCLOSURE

EMERGENCY

EPOXY PAINT EPOXY FLOORING

EQUIPMENT

EXPANSION

EXPANSION JOINT

FACE OF CONCRETE FACE OF FINISH FACE OF STUD

FINISH OR FINISHED

FIRE EXTINGUISHER

FIRE HOSE CABINET

FLAT BAR STOCK

FIRE ALARM

FIREPROOF

FLOOR DRAIN

FLUORESCENT

FOOT OR FEET

FOUNDATION FRAME

FOOTING

FRAMING

FULL SIZE

FURRING

FUTURE

GALVANIZED

GENERAL

GROUND

GYPSUM BOARD

FABRIC WALLCOVERING

GENERAL CONTRACTOR

GLASS OR GLAZING

GENERAL TRADES CONTRACTOR

FLOOR

FIBERGLASS REINFORCED PANEL

FIRE EXTINGUISHER CABINET

EXISTING

EXPOSED

EXTERIOR

CORRIDOR

COURSE

CORK

CONSTRUCTION

CONSTRUCTION MANAGER

CONTINUOUS OR CONTINUE

DEMOLISH OR DEMOLITION

CERAMIC TILE

HDW HARDWARE **TELEPHONE** ACCESS PANEL ACOUST ACOUSTICAL HDWD HARDWOOD **TELEVISION** ACT ACOUSTICAL CEILING TILE HDR HEADER **TERRAZZO** HEATING ADJ ADJACENT TILE BASE A.F.F. ABOVE FINISH FLOOR **HVAC** HEATING, VENTILATING, AIR CONDITIONING THICK THK AGGR HT T.O.C. TOP OF CURB **AGGREGATE** HEIGHT AIR CONDITIONING **HOLLOW CORE** TOP TOP OF PAVEMENT ALTERNATE **HOLLOW METAL** TOW TOP OF WALL ALUM **ALUMINUM** HOLLOW METAL FRAME TONGUE AND GROOVE HORZ HORIZONTAL ANGLE TYPICAL APPROVED HOSE BIB **APPROXIMATE** HOUR UNF UNFINISHED ARCHITECTURAL OR ARCHITECT U.N.O. UNLESS NOTED OTHERWISE AD INCLUDE AREA DRAIN URINAL ASB **ASBESTOS** I.D. INSIDE DIAMETER ASPH INSUL ASPHALT INSULATION VINYL BASE INTR A/V **AUDIO VISUAL** INTERIOR **VERT** VERTICAL VESTIBULE INVERT BSMT BASEMENT VCT VINYL COMPOSITION TILE BRG **JANITOR** BEARING JAN VINYL WALLCOVERING BEAM JOINT BTW BETWEEN KIT **KITCHEN** WSCT WAINSCOT **BITUM BITUMINOUS** LAMINATE WATER CLOSET BLK BLOCK LAV LAVATORY WALK-OFF MAT WATER RESISTANT BLKG **BLOCKING** LH LEFT HAND BD LGTH WALL TILE OR WEIGHT BOARD LENGTH LT BRK **BRICK** LIGHT BUILDING LWC LIGHT WEIGHT CONCRETE WIDE FLANGE "W16x21" LTL LINTEL CAB CABINET LN LINOLEUM WITH CIP CAST IN PLACE W/O WITHOUT LIVE LOAD CAST IN PLACE CONCRETE WD WOOD **CURB INLET** MANHOLE **WOOD PANEL** CI CB CATCH BASIN MFR MANUFACTURER CLG MAS CEILING MASONRY **EXISTING** MO CTR CENTER MASONRY OPENING CJ **CONTROL JOINT** MTL METAL CENTER LINE MAX MAXIMUM CL

MECHANICAL

MEMBRANE

MARBLE TILE

MISCELLANEOUS

NOT IN CONTRACT NOT TO SCALE

MINIMUM

MOUNDED

MOUNTING

MULLION

NOMINAL

NORTH

NUMBER

OBSCURE

OPENING

OPPOSITE

OVERALL

PAINTED

PAIR

PANEL

ORIENTED STRAND BOARD

OUTSIDE DIAMETER

OVERFLOW DRAIN

PARTICLE BOARD

PLASTIC LAMINATE

PLUMBING TRADES CONTRACTOR

POUNDS PER SQUARE INCH

PRECAST CONCRETE

RAIN WATER LEADER

REFRIGERATOR

REGISTER

REINFORCED

REQUIRED

RESILIENT

RETURN AIR

RIGHT HAND

ROOF DRAIN

ROUGH OPENING

RUBBER BASE

SECTION

SCHEDULE

SHEATHING

SHEET VINYL

SEALED CONCRETE

SPECIFICATION

STAINLESS STEEL

SINGLE PLY MEMBRANE

STRUCTURE OR STRUCTURAL

SUSPENDED ACOUSTICAL TILE

SPRAY APPLIED FIRE RESISTIVE MATERIAL

SHEET

SHOWER

SIMILAR

SQUARE

STANDARD

SUSPENDED

SYMMETRICAL

STATION

STEEL STORAGE

SINK

RISER

RIGHT OF WAY

RETURN AIR GRILLE

PARTITION

PLASTIC

PLYWOOD

PRECAST

QUARRY TILE

RADIUS

OFFICE ON CENTER

MECHANICAL TRADES CONTRACTOR

MECH

MEMB

MTC

MT

MIN

MISC

MTD

MTG

MUL

NOM

N.T.S.

OFF

O.D.

OA

OFD

PTD

PBD

PTN

PLAS

P-LAM

PTC

PSI

PCC

RFRG

RGTR

REINF

RQD

RH

RD

R.O.

RB

SK

SPM

SQ

STA


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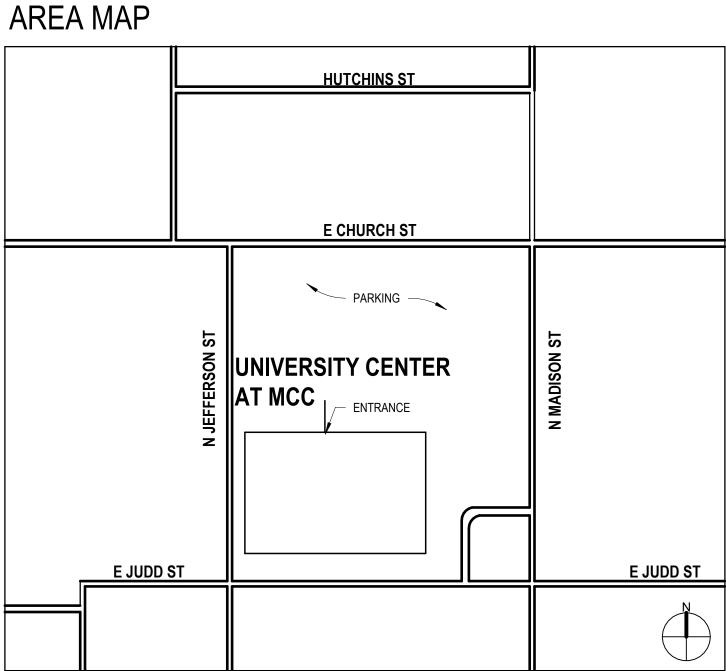
STRUCT SUSP

PLYWD

NO OR #

STATE LOCATION MAP



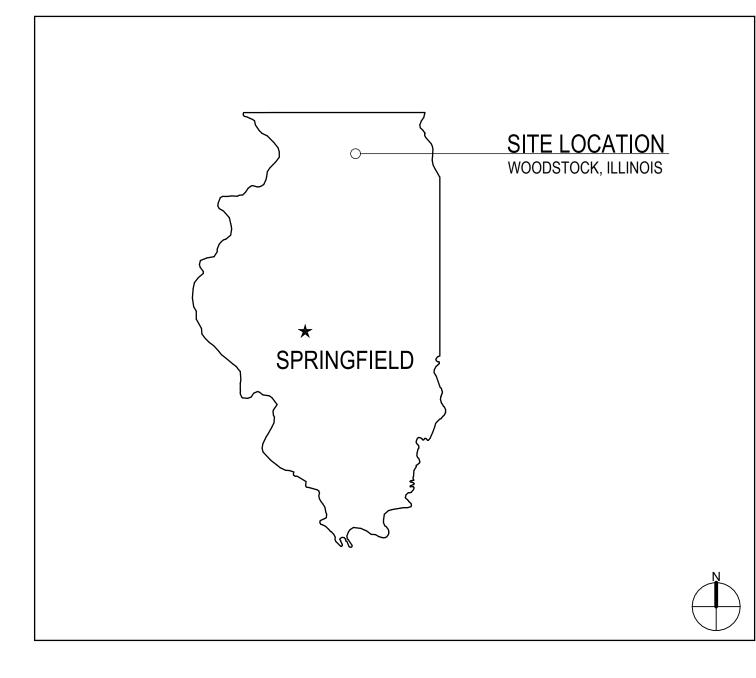

SHEET INDEX

MECHANICAL

ME1.00 MECHANICAL ELECTRICAL NOTES AND DETAILS

HVAC LEGEND NOTES, AND DETAILS

DHV1.00 HVAC DEMOLITION PLAN

HVAC ROOF PLAN

HV1.00 HVAC PLAN

HV5.00 HVAC SCHEDULES

GENERAL FIRE PROTECTION FPD1.00 FIRE PROTECTION DEMOLITION SHEET INDEX, ABBREVIATIONS, SYMBOLS & NOTES AC1.10 CODE PLAN FP1.00 FIRE PROTECTION PLAN FP5.00 FIRE PROTECTION GENERAL NOTES, SYMBOLS AND **ABBREVIATIONS** C1.00 SITE DEMOLITION PLAN PLUMBING C1.01 STANDARD CONSTRUCTION DETAILS PD1.00 UNDERFLOOR PLUMBING DEMOLITION PLAN STANDARD CONSTRUCTION DETAILS PD1.10 PLUMBING DEMOLITION PLAN UNDERFLOOR PLUMBING PLAN **ARCHITECTURAL** PLUMBING PLAN AD1.10 DEMOLITION PLAN PLUMBING RISER DIAGRAMS AD2.10 DEMOLITION RCP PLUMBING, GENERAL NOTES, SYMBOLS AND ABBREVIATIONS OVERAL FLOOR PLAN PLUMBING SCHEDULES DIMENSION PLAN PLUMBING SCHEDULES A2.11 REFLECTED CEILING PLAN ENLARGED REFLECTED CEILING PLAN ELECTRICAL **ROOF PLAN** ED1.10 ELECTRICAL DEMOLITION PLAN SECTION DETAILS ELECTRICAL PLAN PLAN DETAILS ELECTRICAL ROOF PLAN A7.11 **CEILING DETAILS** LIGHTING PLAN TOILET ROOMS-PLANS AND ELEVATIONS ENLARGED ELECTRICAL PLANS **INTERIOR ELEVATIONS** ELECTRICAL RISER DIAGRAM INTERIOR ELEVATIONS ELECTRICAL SYMMBOL LIST AND ABBREVIATIONS **INTERIOR ELEVATIONS ELECTRICAL NOTES** MILLWORK DETAILS ELECTRICAL SCHEDULES DOOR SCEHDULE, ELEVATIONS, AND DETAILS ELECTRICAL SCHEDULES A11.01 FINISH PLAN ELECTRICAL SCHEDULES A12.01 FURNITURE PLAN (FOR REFERENCE ONLY) ELECTRICAL DETAIL

ELECTRICAL DETAIL

ELECTRICAL DETAIL

ELECTRICAL DETAILS

ELECTRICAL DETAIL

ARCHITECT OF RECORD DEMONICA KEMPER ARCHITECTS 125 N. HALSTED STREET, SUITE 301 CHICAGO, IL 60661 P: 312.496.0000

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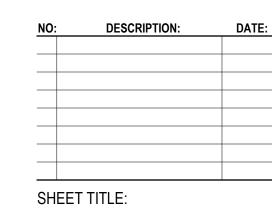
20/10 ENGINEERING GROUP, LLC **1216 TOWER ROAD** SCHAUMBURG,IL 60173 P: 847.882.2010 F: 847.882.2201

CIVIL ENGINEERS HRG GREEN

1391 CORPORATE DRIVE, SUITE 203 MChENRY ,IL 60050 P:815.385.1778 F:815.385.1781

KEY PLAN:

9.19.23 SHEET STATUS: **ISSUED FOR BIDS**




SHEET INDEX, ABBREVIATIONS, **SYMBOLS & NOTES**


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- PHONE/ DATA OUTLET — ELECTRICAL OUTLET ELECTRICAL OUTLET ALL OFFICES BEHIND FURNITURE TYP. ALL LOCATIONS

ROOM SIGNAGE ON LATCH SIDE - EXTINGUISHER OF DOOR (BY - LIGHT SWITCH/ THERMOSTAT/FIRE ALARM DEVICE - LIGHT SWITCH/ THERMOSTAT/FIRE ALARM DEVICE PHONE/ DATA OUTLET NOTE: IN THE EVENT OF A CONFLICT BETWEEN DIMENSIONS SHOWN ON THIS DRAWING AND ANY OTHER ARCHITECTURAL, ELECTRICAL, OR MECHANICAL SHEETS OR SPECIFICATIONS, NOTIFY ARCHITECT OF DISCREPANCY.



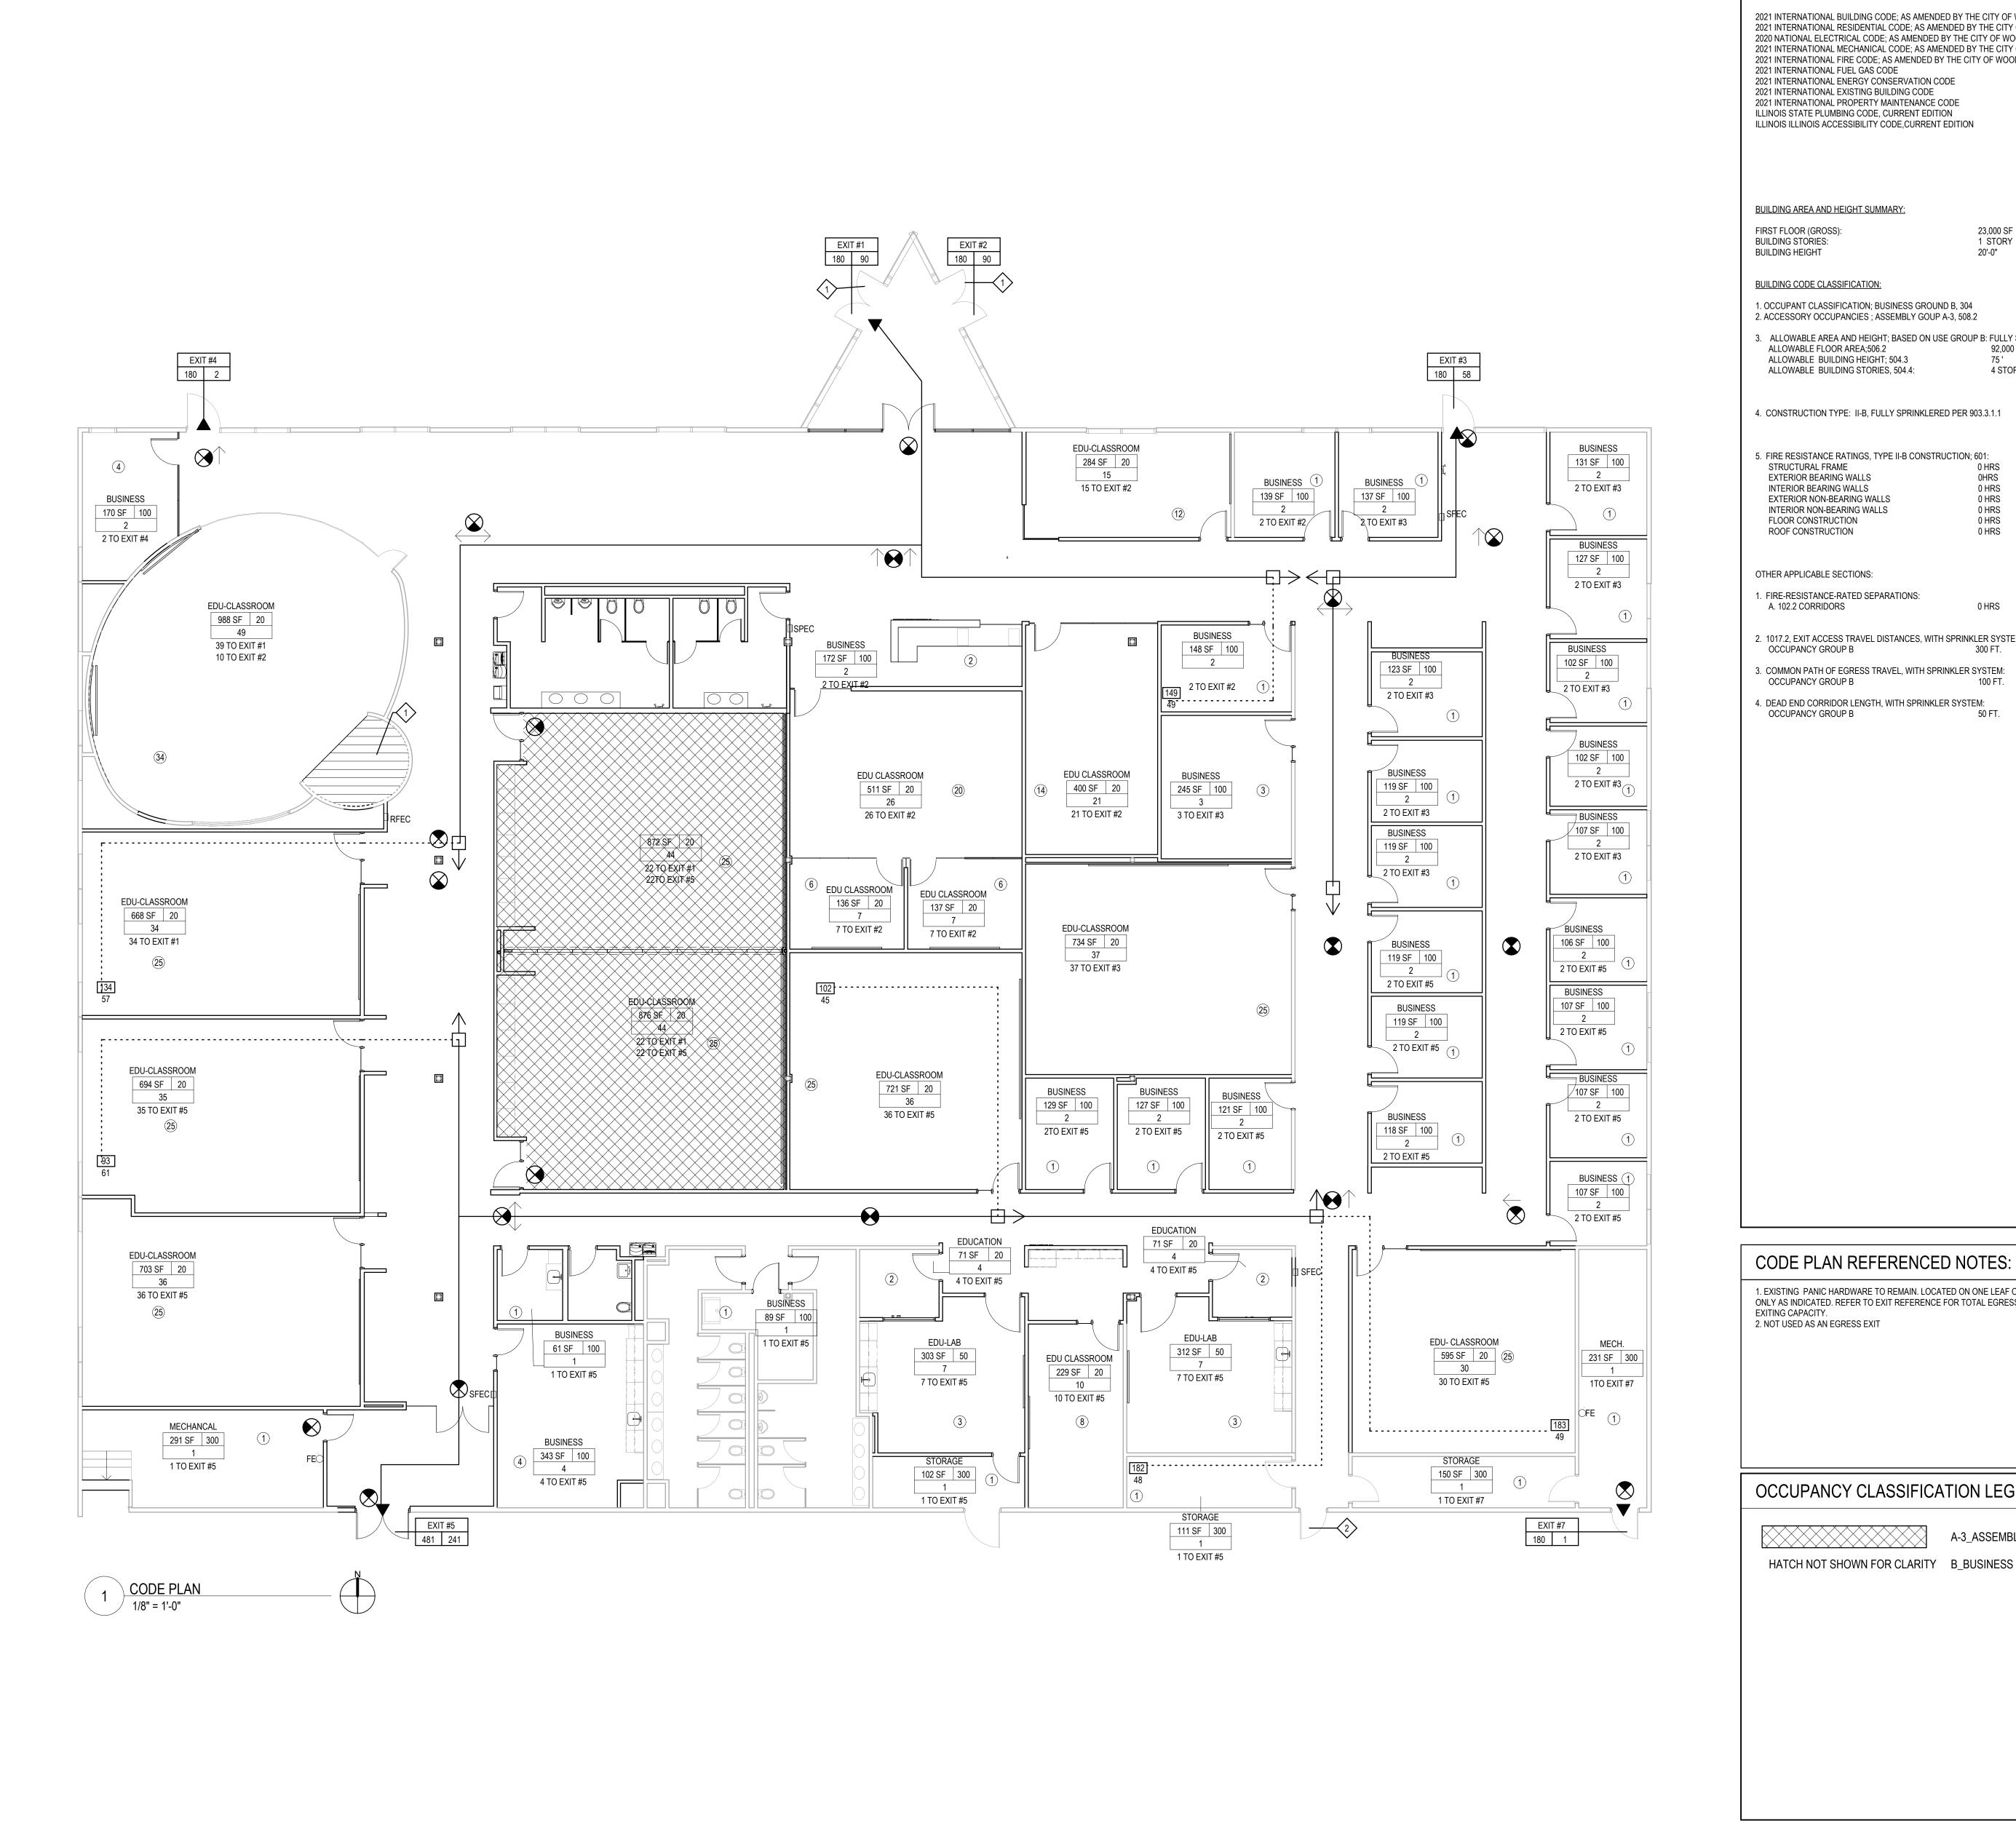

CODE PLAN REFERENCED NOTES:	X
EXISTING PANIC HARDWARE TO REMAIN. LOCATED ON ONE LEAF OF DOUBL ONLY AS INDICATED. REFER TO EXIT REFERENCE FOR TOTAL EGRESS OCCUPEXITING CAPACITY. NOT USED AS AN EGRESS EXIT	
OCCUPANCY CLASSIFICATION LEGEND	

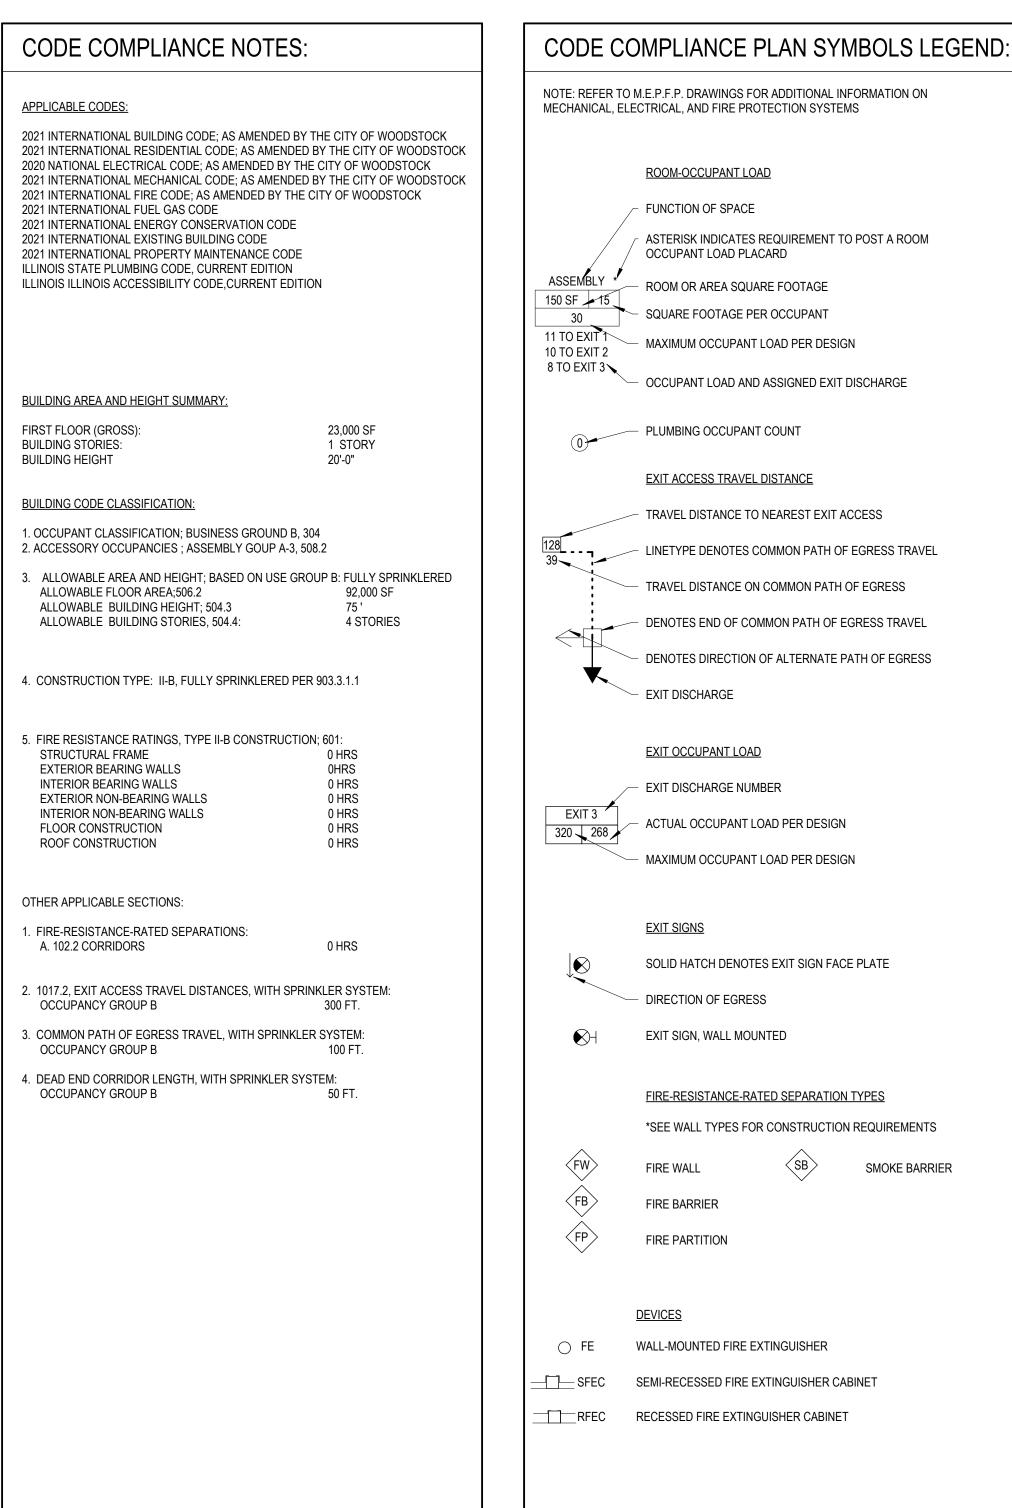OCCUPANCY CLASSIFICA	TION LEGEND:
HATCH NOT SHOWN FOR CLARITY	A-3_ASSEMBLY B_BUSINESS

					7 I									
1. NUMBER OF OCCUPANTS, ACTU	JAL:	34	9											
2. NUMBER OF OCCUPANTS, PER	SEX:	17	5											
3. BUILDING TYPE:		CC	OLLEGE											
		QUANTITY												
FIXTURE TYPE	REQL	JIRED	CURRENTLY	/ PROVIDED										
	WOMEN	MEN	WOMEN	MEN										
LAVATORIES	4	4	9	6										
WATER CLOSETS	9	5	9	7										
URINALS		4		4										
DRINKING FOUNTAINS		5		5										
SERVICE SINKS	1 PER I	FLOOR	1 PER	FLOOR										

PLUMBING FIXTURE COUNT:



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CIVIL ENGINEERS HRG GREEN 1391 CORPORATE DRIVE, SUITE 203 MChENRY ,IL 60050 P:815.385.1778 F:815.385.1781

COUNCENTER MCHENRY UNIVERSITY (


KEY PLAN:

SHEET STATUS: 9.19.23 **ISSUED FOR BIDS**

NO: DESCRIPTION: DATE: **CODE PLAN**

SHEET NUMBER:

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DENOTES REMOVE AND REPLACE HMA PAVEMENT

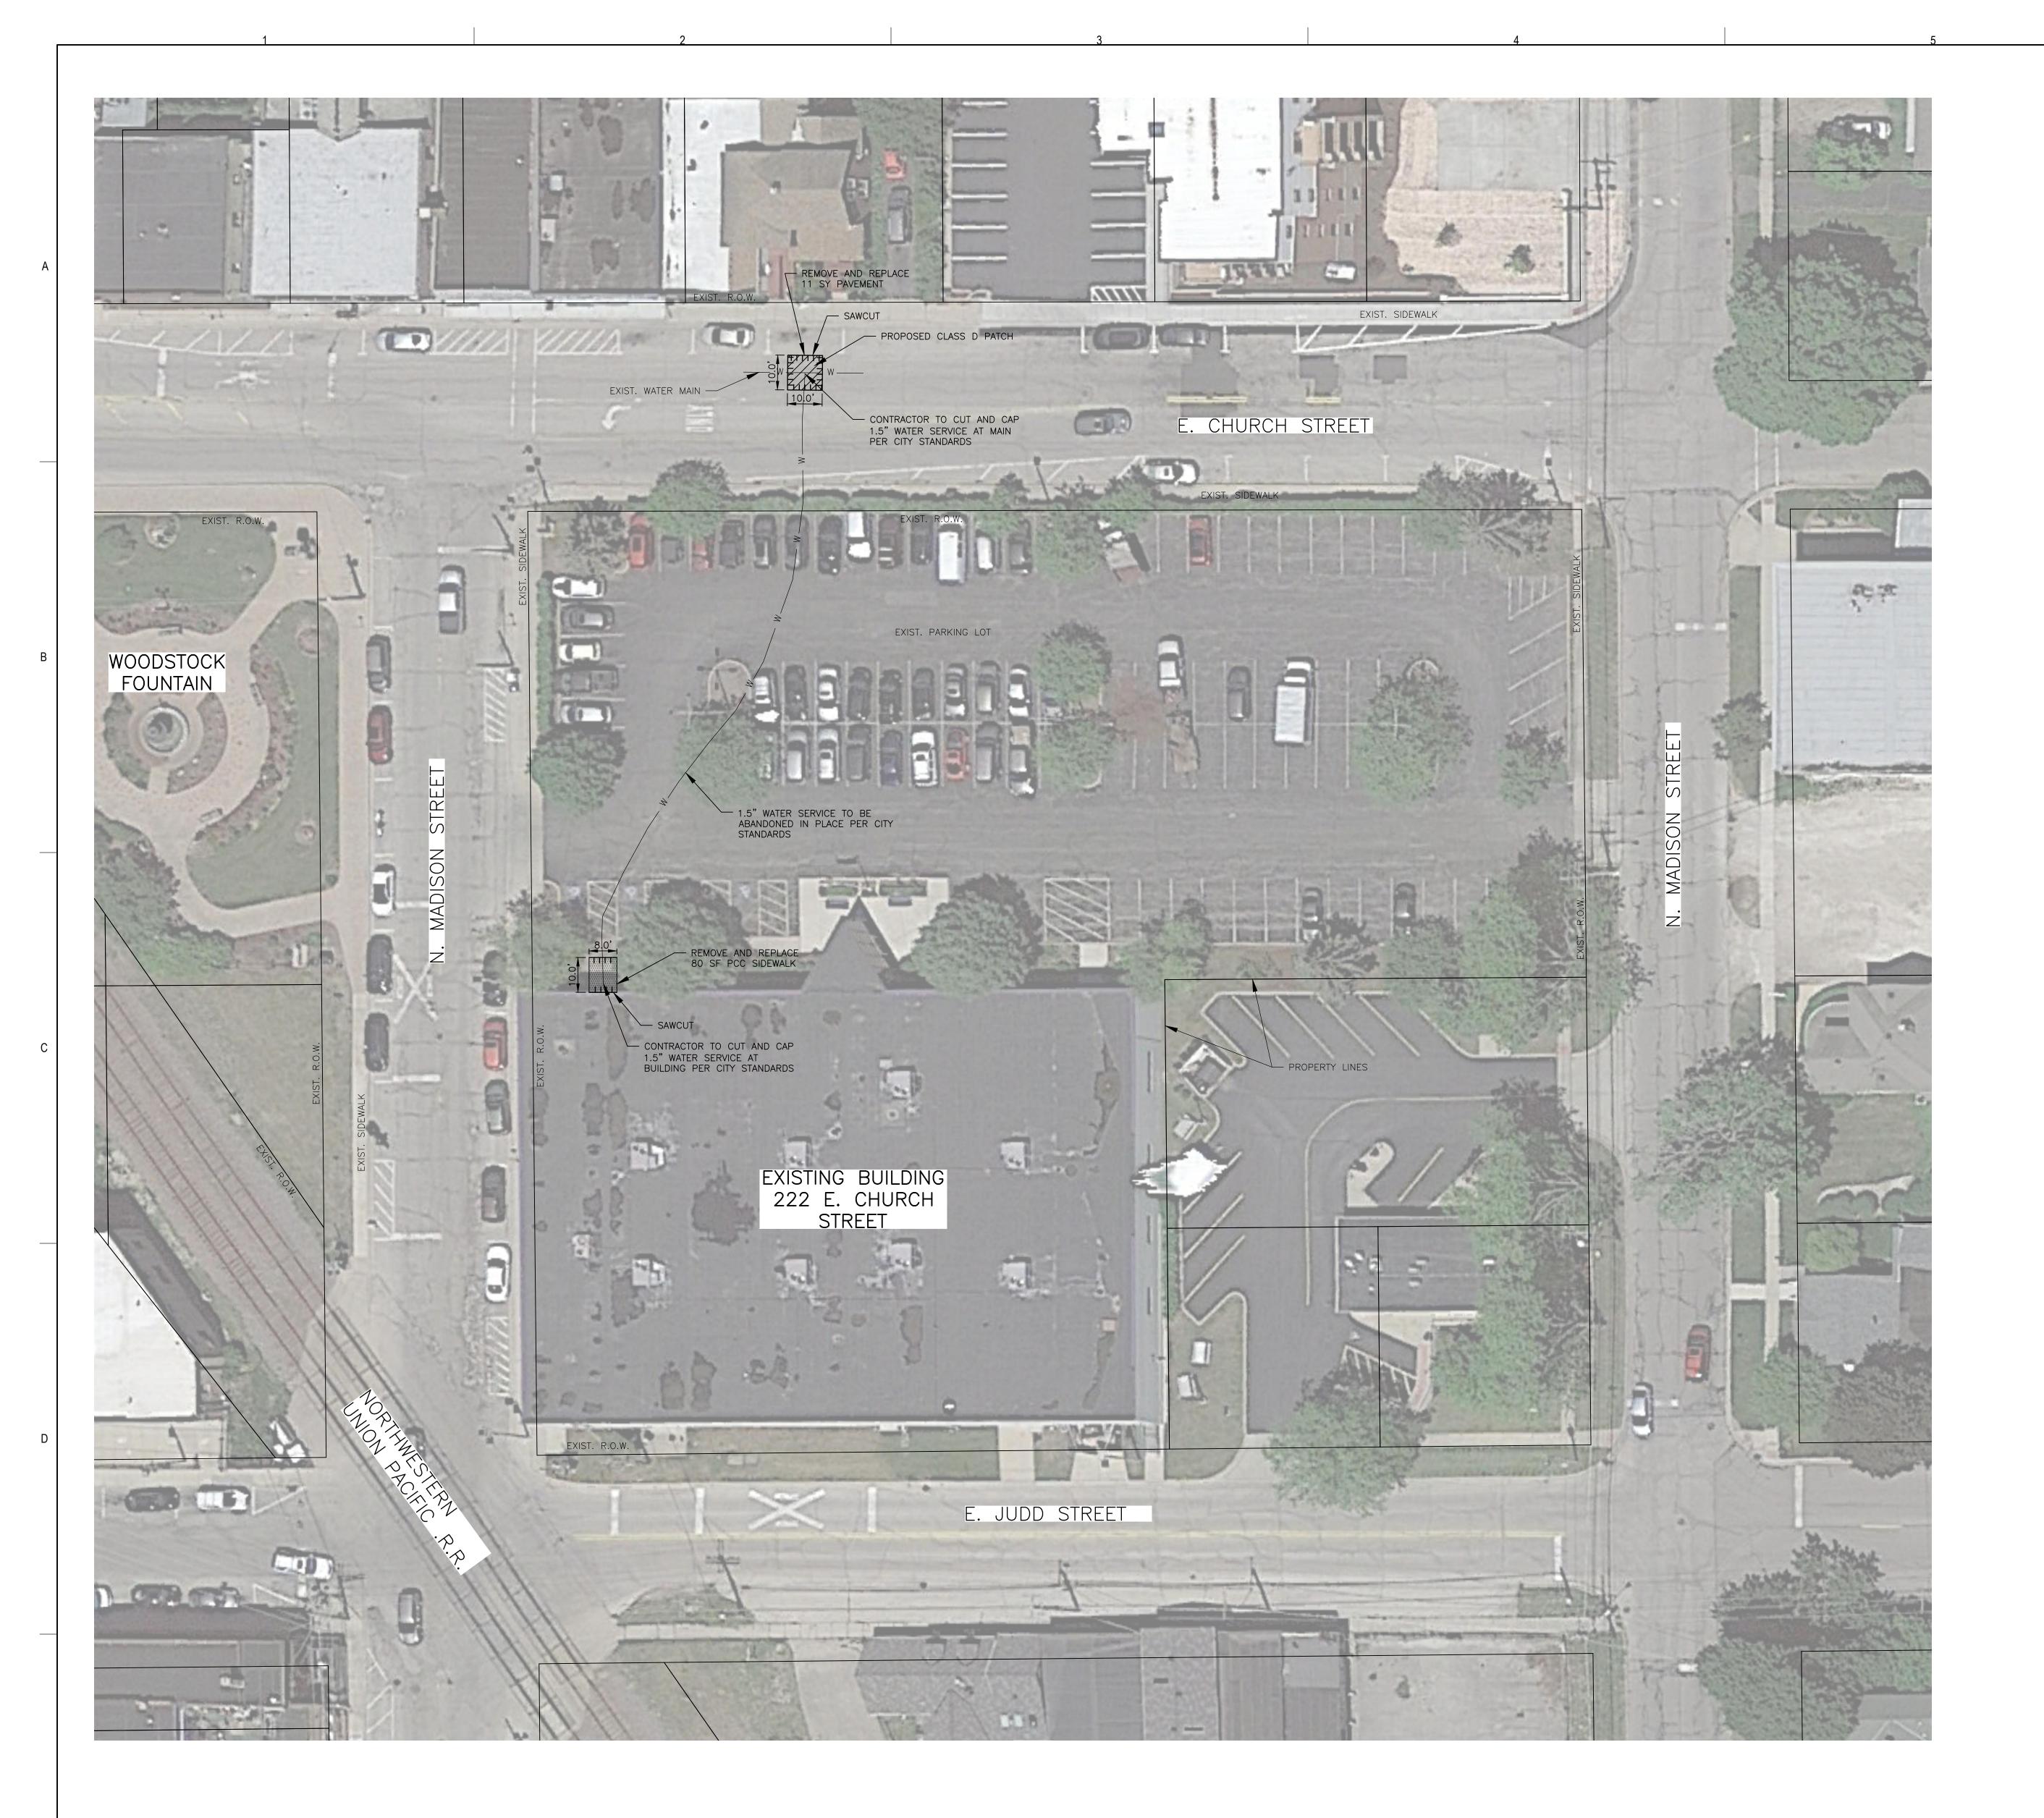DENOTES REMOVE AND REPLACE PCC SIDEWALK

______ DENOTES SAWCUT FULL DEPTH

EXECUTION OF THE WORK.

EXECUTION OF THE WORK.

TRAFFIC CONTROL NOTES:


- ALL APPLICABLE CITY PERMITS, INCLUDING BUT NOT LIMITED TO CLOSURE PERMITS, SHALL BE OBTAINED PRIOR TO ANY CONSTRUCTION WITHIN CITY ROW OR LANE CLOSURES.
- LATEST EDITION OF THE MANUAL ON UNIFORM TRAFFIC CONTROL


ALL TRAFFIC CONTROL SHALL BE IN ACCORDANCE WITH THE

- THE CONTRACTOR SHALL COORDINATE HIS TRAFFIC CONTROL WITH OTHER CONSTRUCTION PROJECTS IN THE AREA. SIDEWALK CLOSED SIGNS REQUIRED FOR ALL SIDEWALK
- THE CONTRACTOR IS CAUTIONED NEITHER TO OBSTRUCT NOR REMOVE ANY EXISTING PAVEMENT, NOR TO DISTURB THE EXISTING TRAFFIC PATTERNS MORE THAN IS NECESSARY FOR THE PROPER

PROJECT NOTES: • WATER SERVICE CUT AND CAP ACTIVITIES SHALL NOT COMMENCE UNTIL APPROVAL TO DO SO HAS BEEN RECEIVED BY GOVERNING

- ALL EXISTING UTILITIES TO BE FIELD VERIFIED PRIOR TO CONSTRUCTION.
- CONTRACTOR SHALL COORDINATE AND COMPLY WITH ALL UTILITY COMPANIES INVOLVED IN PROJECT AND PAY ALL REQUIRED FEES AND COSTS.
- ALL STRUCTURES & DEBRIS SHALL BE REMOVED PRIOR TO CONSTRUCTION & DISPOSED OF OFFSITE.
- ANY EXISTING FIELD DRAIN TILES ENCOUNTERED SHALL BE
- RECONNECTED. THE CONTRACTOR IS CAUTIONED NEITHER TO OBSTRUCT NOR REMOVE ANY EXISTING PAVEMENT, NOR TO DISTURB THE EXISTING TRAFFIC PATTERNS MORE THAN IS NECESSARY FOR THE PROPER
- ALL BITUMINOUS PAVEMENT REMOVAL AREAS SHALL BE SAWCUT.

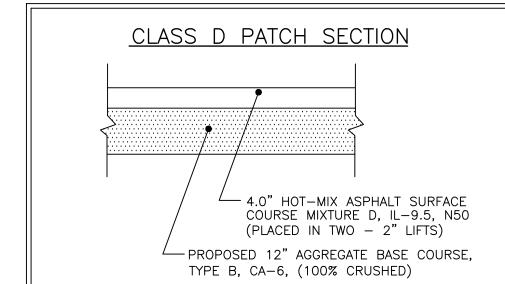

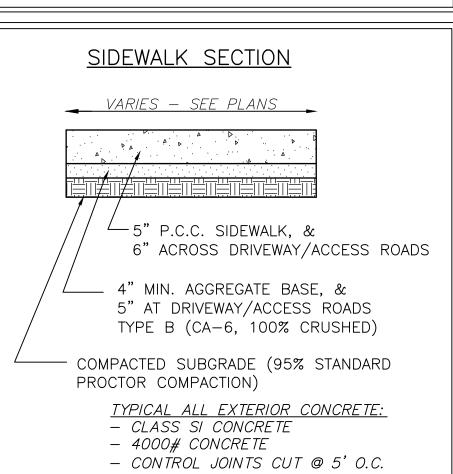

(OR AT SAME WIDTH OF SIDEWALK)

Know what's below.
Call before you dig.

PRELIMINARY
NOT FOR CONSTRUCTION



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P: 847.882.2010 F: 847.882.2201 CIVIL ENGINEERS **HRG GREEN** 1391 CORPORATE DRIVE, SUITE 203 MChENRY ,IL 60050 P:815.385.1778 F:815.385.1781

KEY PLAN:

9.19.23 SHEET STATUS: **ISSUED FOR BIDS**

NO: DESCRIPTION:

SHEET TITLE: SITE DEMOLITION


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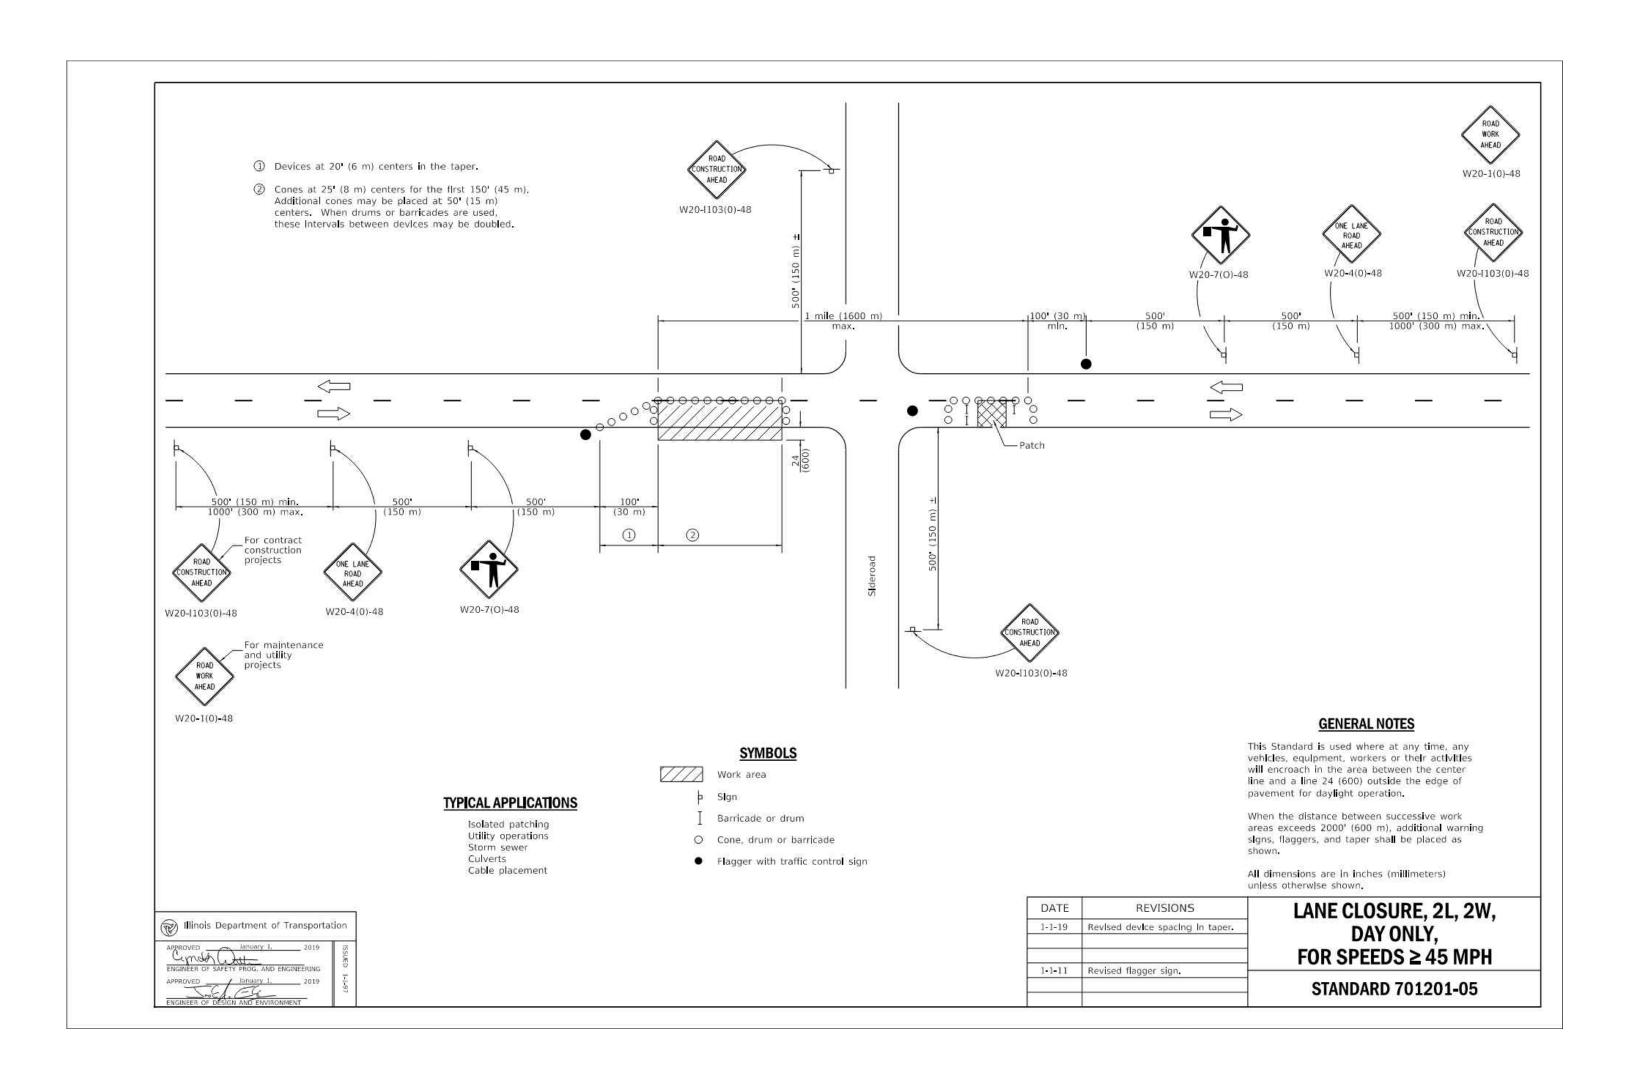
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20/10 ENGINEERING GROUP, LLC
1216 TOWER ROAD
SCHAUMBURG,IL 60173
P: 847.882.2010 F: 847.882.2201

CIVIL ENGINEERS

HRG GREEN
1391 CORPORATE DRIVE, SUITE
203 MChENRY, IL 60050
P:815.385.1778 F:815.385.1781

HENRY COUNTY COLLE
VERSITY CENTER AT MCC

KEY PLAN:

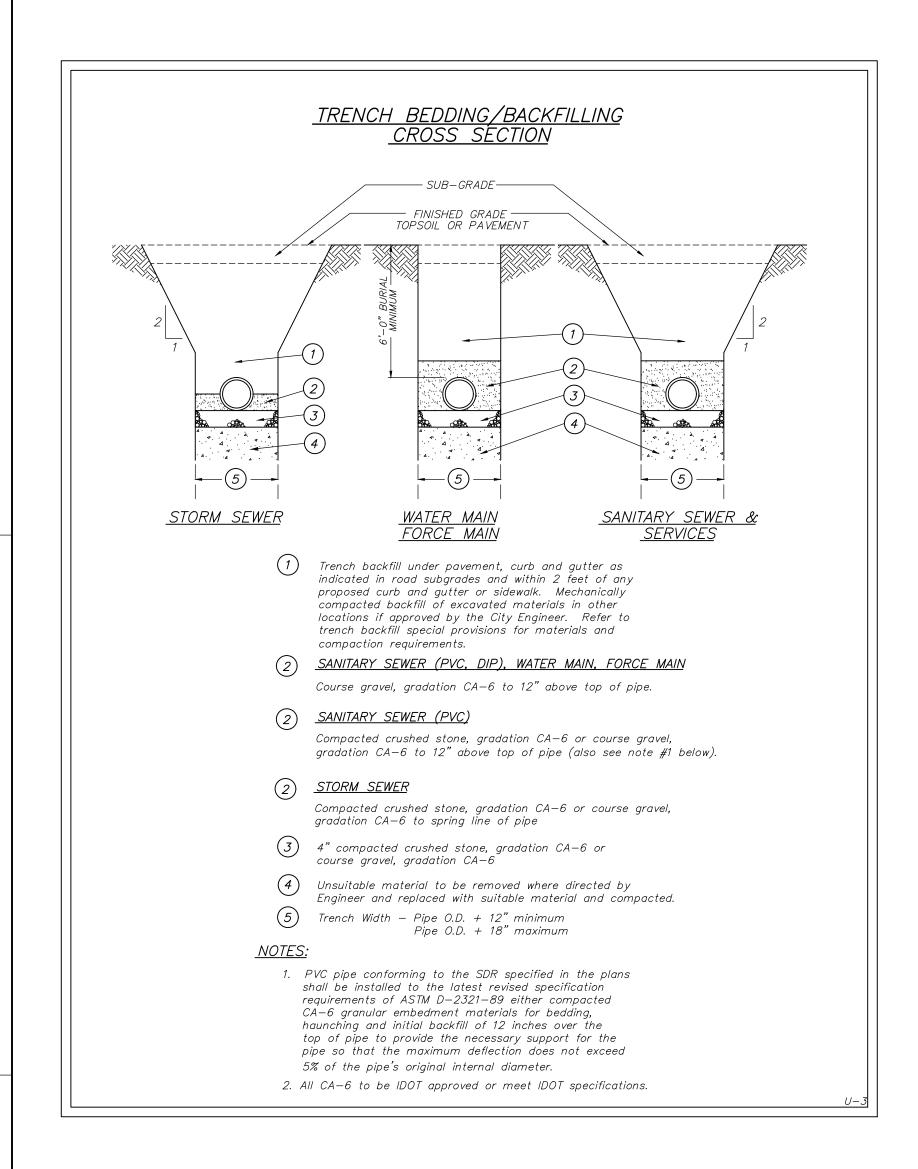SHEET STATUS: 9.19.23
ISSUED FOR BIDS

NO: DESCRIPTION: DATE


STANDARD CONSTRUCTION DETAILS


DETAIL


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COL

KEY PLAN:


SHEET STATUS: 9.19.23 **ISSUED FOR BIDS** DESCRIPTION:

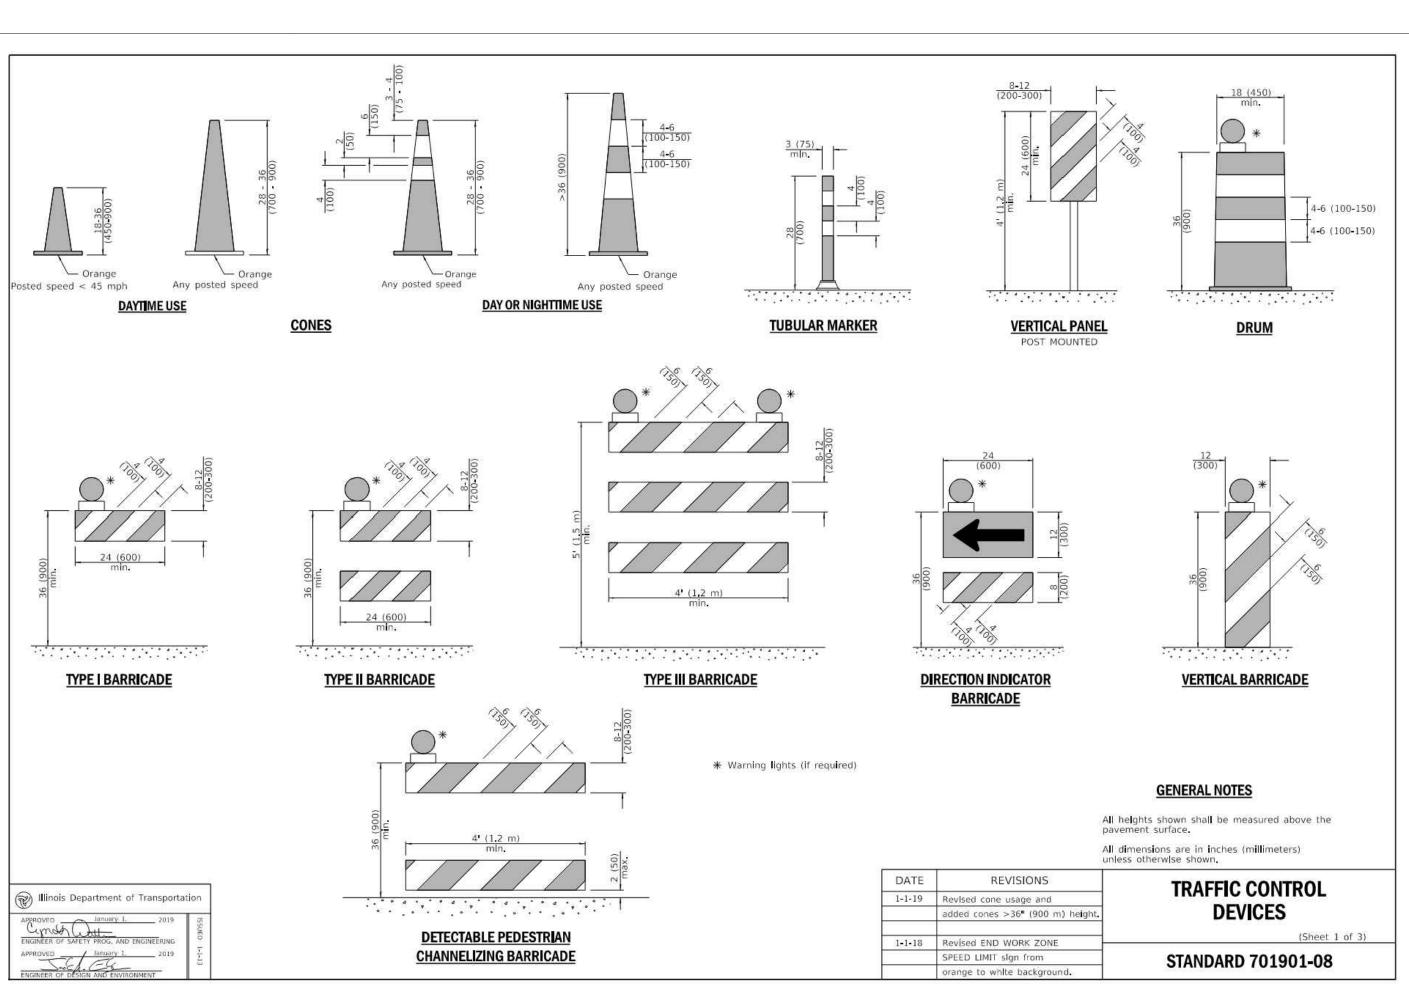SHEET TITLE:

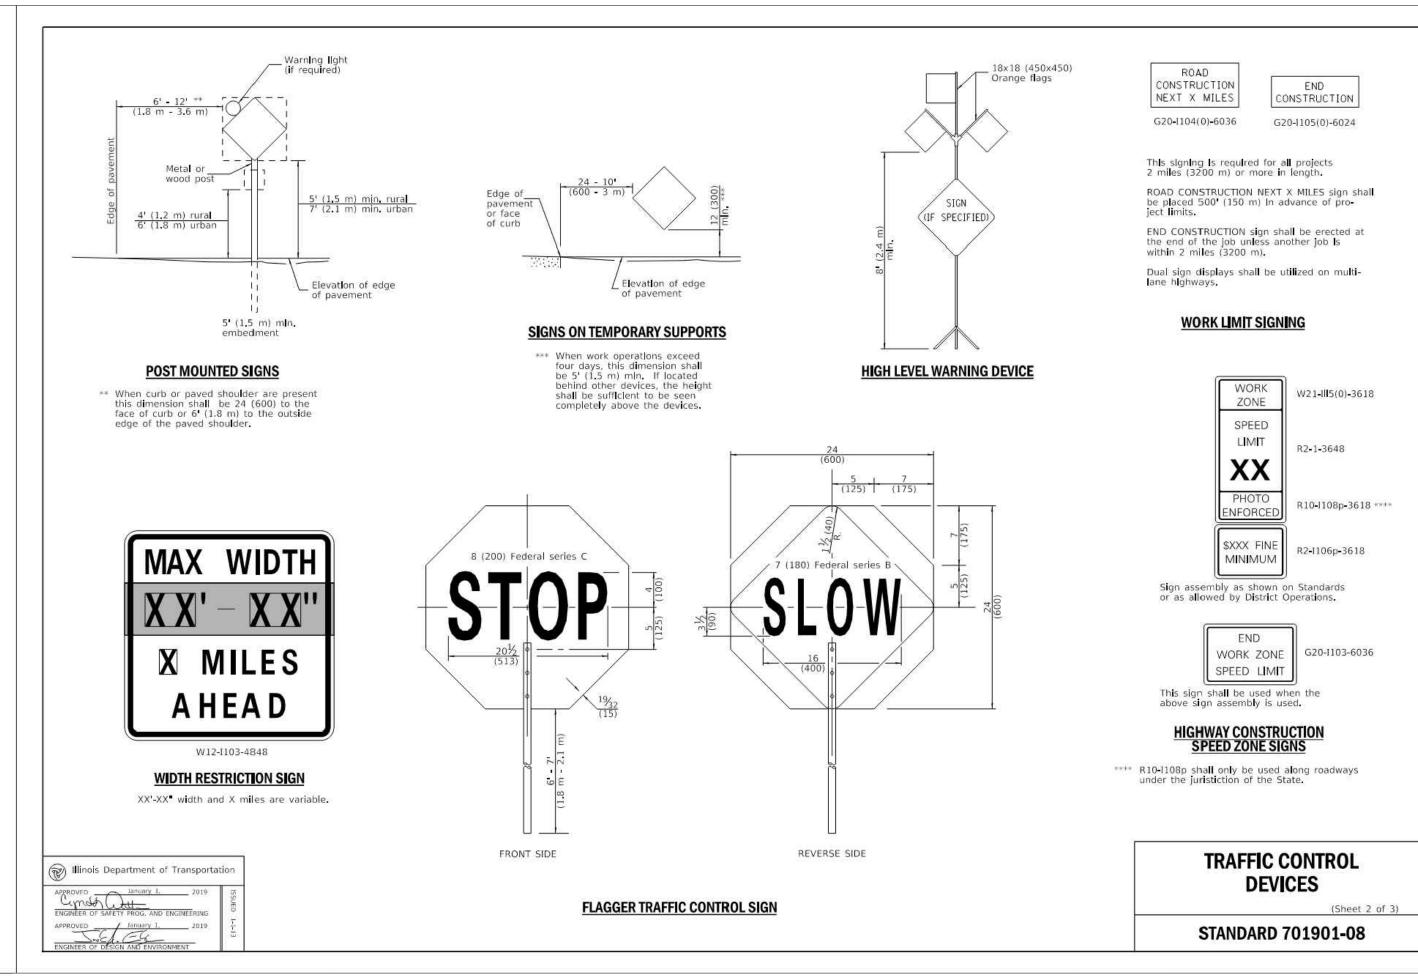STANDARD CONSTRUCTION **DETAILS**

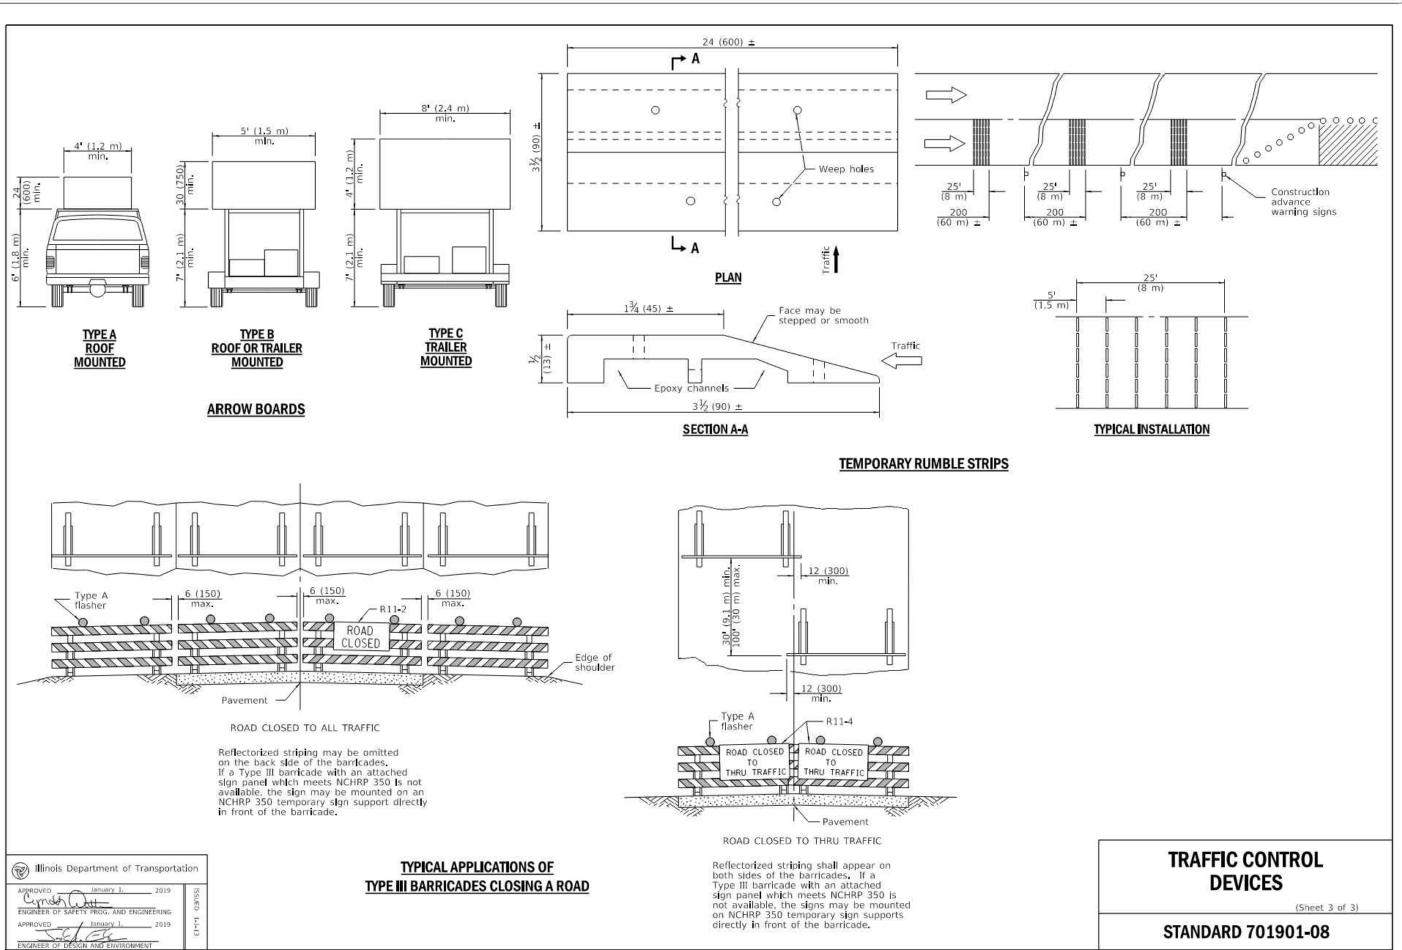
SHEET NUMBER:

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DEMO FLOOR PLAN SYMBOLS LEGEND:

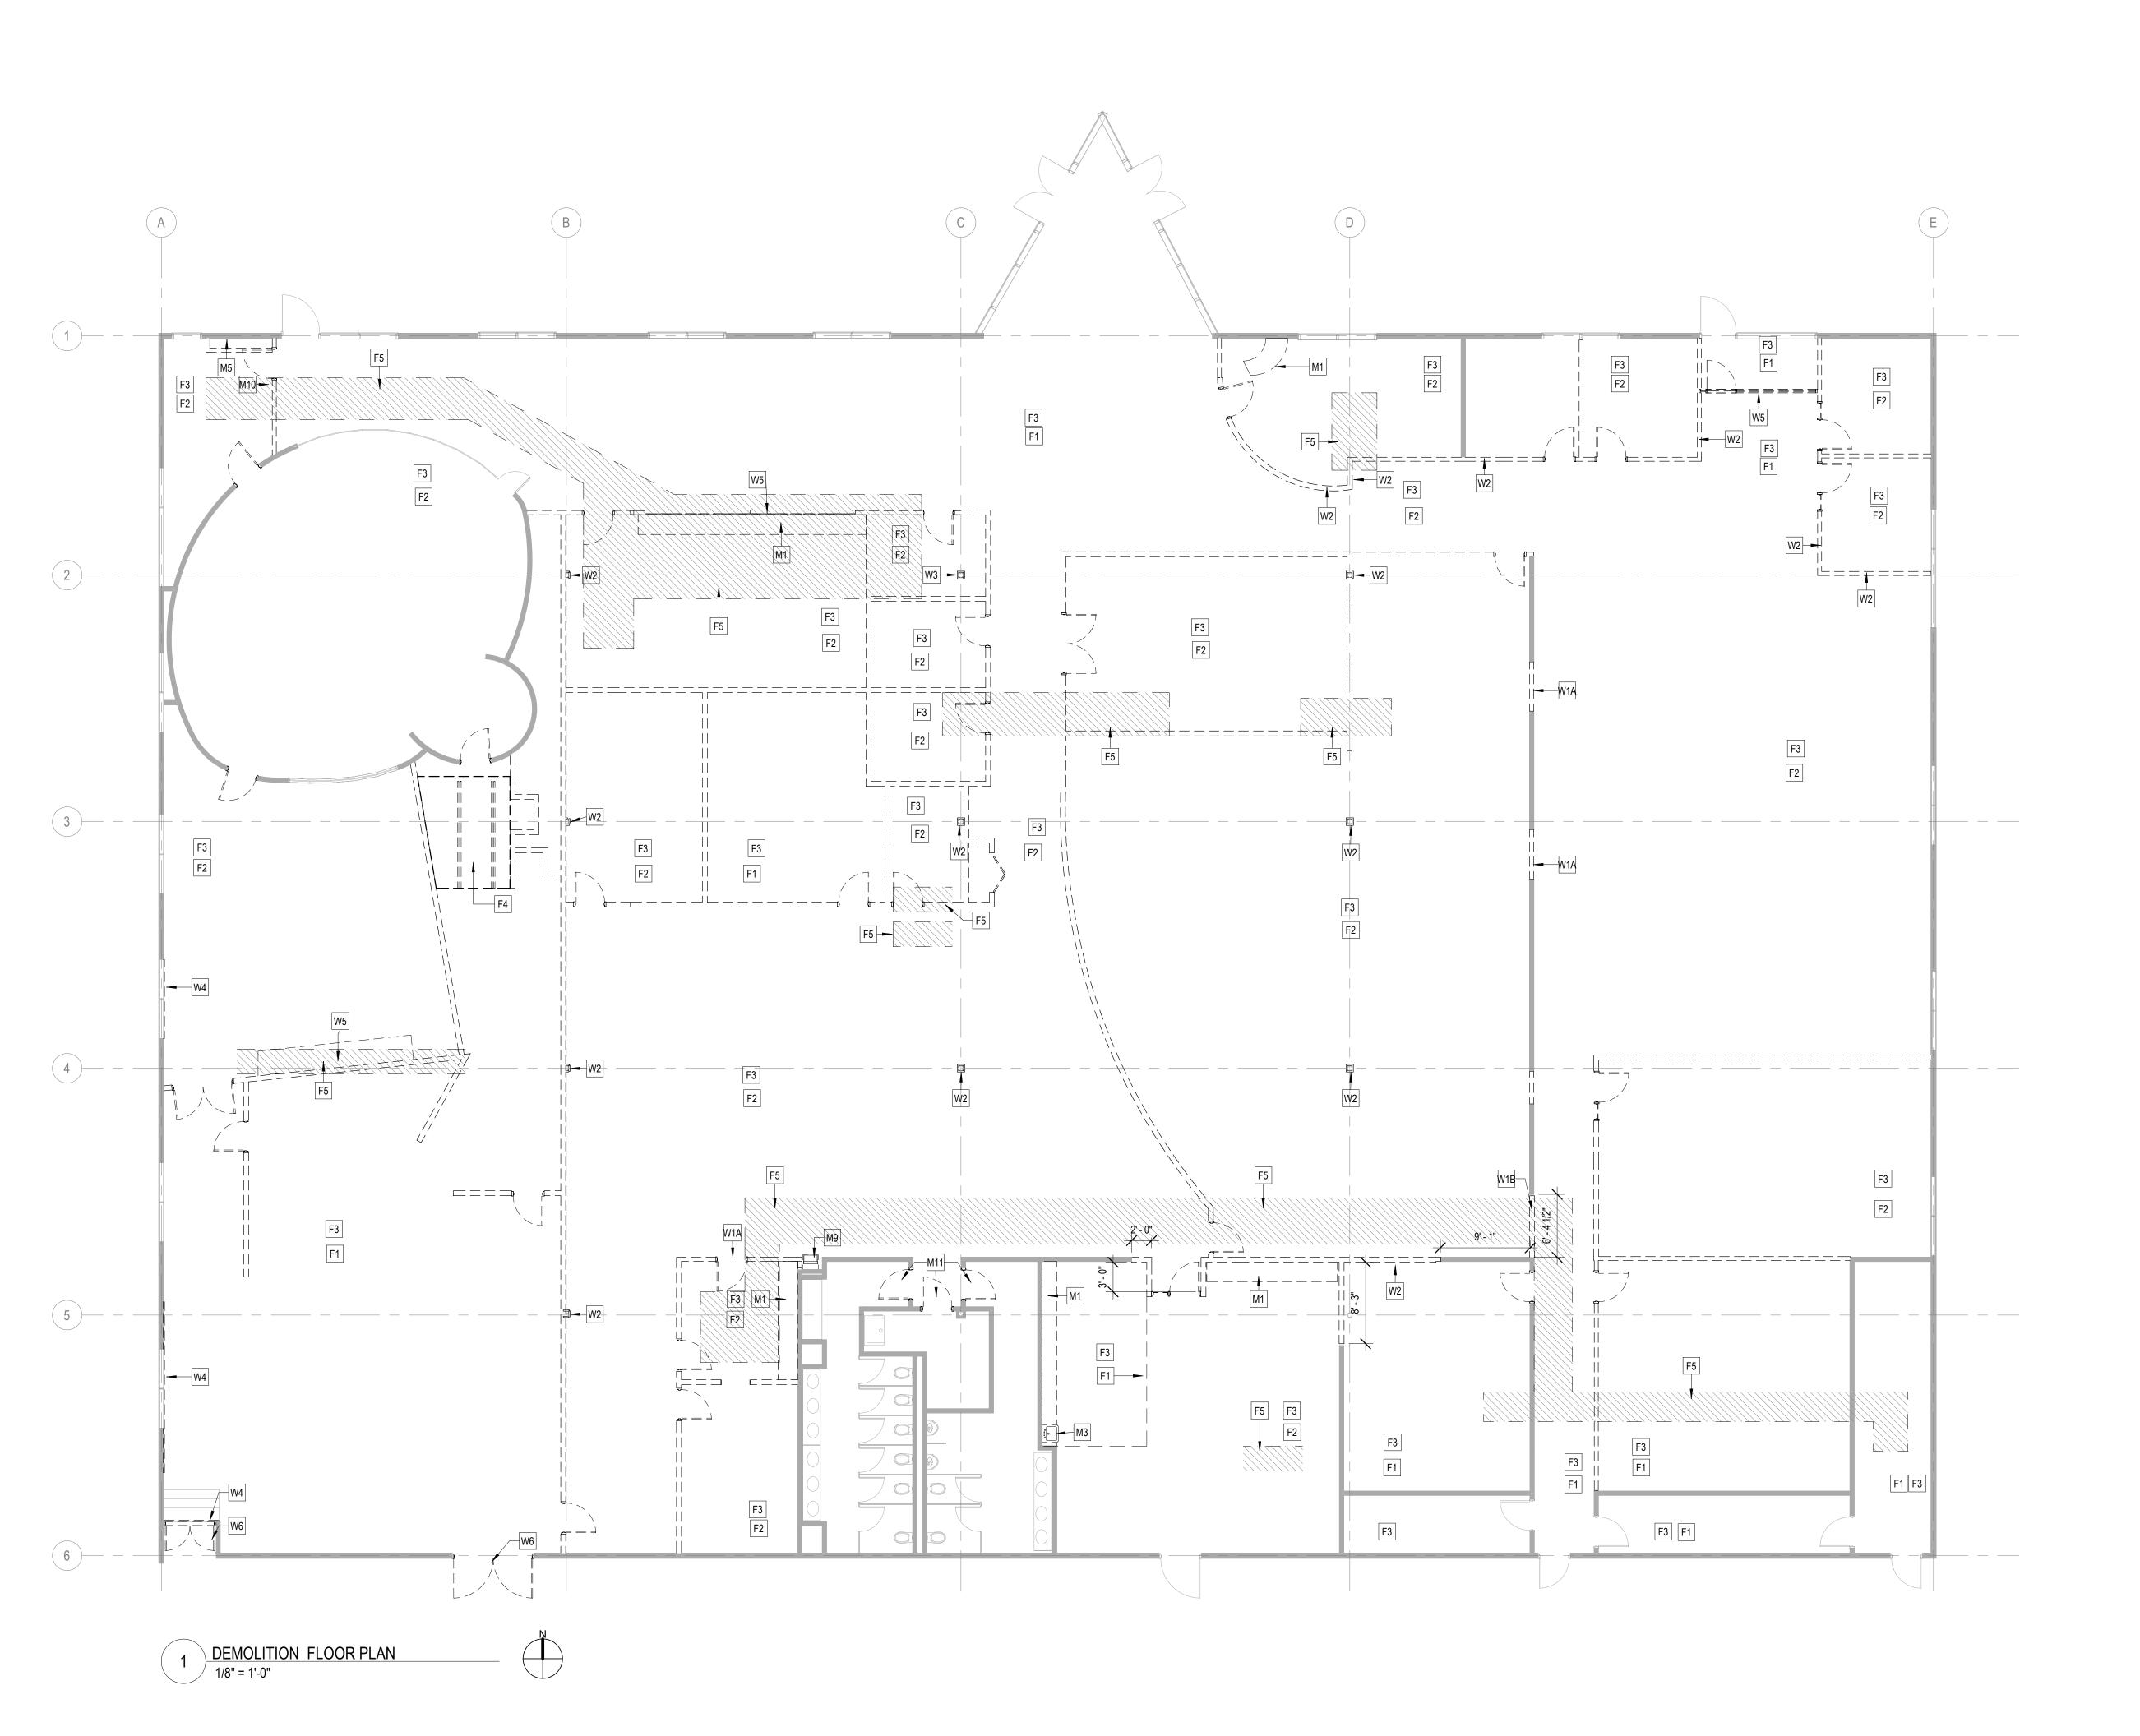NOTE: REFER TO M.E.P.F.P. DRAWINGS FOR ADDITIONAL INFORMATION ON MECHANICAL, ELECTRICAL, AND FIRE PROTECTION SYSTEMS



GYPSUM BOARD OR PLASTER PARTITION TO BE REMOVED

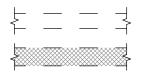CMU PARTITION TO BE REMOVED

FRAME AND DOOR TO BE REMOVED, SALVAGE HARDWARE TO OWNER

DEMO PLAN GENERAL NOTES:

. PRIOR TO AND DURING ANY DEMOLITION THE CONTRACTOR SHALL VERIFY AND MAINTAIN THE BUILDING'S STRUCTURAL INTEGRITY. . CONTRACTOR SHALL BE RESPONSIBLE FOR ALL DEMOLITION AS REQUIRED TO

INSTALL ALL NEW WORK. REPAIR, PATCH AND FINISH EXISTING FLOORS, WALLS AND CEILINGS DESIGNATED TO REMAIN TO MATCH EXISTING CONDITIONS. REMOVE ALL HANGERS, SUSPENSION SYSTEMS, SUPPORT FRAMING, EQUIPMENT PADS, ANCHORS, ATTACHMENT HARDWARE AND RELATED APPURTENANCES CONNECTED WITH THE WORK TO BE DEMOLISHED. IF COMPLETE REMOVAL IS NOT POSSIBLE, CUT DEVICES AS CLOSE AS POSSIBLE TO ADJOINING SURFACES OR ORIGIN OF SUPPORT.

. DURING THE BIDDING PERIOD, EACH BIDDING CONTRACTOR SHALL VISIT THE SITE AND THE FACILITY TO DETERMINE EXISTING CONDITIONS. CONTRACTOR'S FAILURE TO REASONABLY DETERMINE AND/OR ANTICIPATE THE EFFECT OF EXISTING CONDITIONS AND THE WORK INVOLVED THEREBY SHALL NOT BE JUSTIFICATION FOR ADDITIONAL COMPENSATION. NOTIFY ARCHITECT OF ANY DISCREPANCIES. 5. ALL MATERIALS, EQUIPMENT, FIXTURES, SYSTEMS, AND ACCESSORIES WHICH ARE TO REMAIN IN SERVICE SHALL BE CLEANED, REPAIRED, ADJUSTED AND PLACED INTO

WHEN TEMPORARY SHORING AND BRACING IS REQUIRED. CONTRACTOR SHALL RETAIN AND PAY FOR THE SERVICES OF A PROFESSIONAL ENGINEER-LICENSED TO PRACTICE IN THE STATE WHERE THE PROJECT IS LOCATED- TO DESIGN AND PREPARE DETAILED DRAWINGS. . CONTRACTOR SHALL COORDINATE SCHEDULE OF DEMOLITION WORK WITH THE OVERALL PHASING PLAN. ALL AREAS SURROUNDING EACH PHASE OF DEMOLITION/CONSTRUCTION WILL BE OCCUPIED BY THE OWNER DURING THE

PROPER OPERATIONS IN ALL MODES WITH THE ORIGINAL SYSTEM.

OWNER'S NORMAL BUSINESS HOURS. DEMOLITION WORK SHALL NOT ENCUMBER THE USE OF EXISTING ADJACENT SPACES. 8. EACH CONTRACTOR SHALL FOLLOW THE PROGRESS OF THE GENERAL DEMOLITION AND REMODELING WORK TO ASSURE THE ACCESSIBILITY AND SAFETY OF EQUIPMENT AND SYSTEMS IN SERVICE IN ORDER TO PROVIDE FOR THE TIMELY REMOVAL AND/OR RELOCATION OF EQUIPMENT, PIPING, ETC.

. REMOVE ALL ABANDONED CONDUIT BOXES, CONDUCTORS, TELEPHONE LINES, ELECTRIC PANELS, AND ANY OTHER MISCELLANEOUS EQUIPMENT NOT REQUIRED FOR THE NEW FACILITY. 10. REMOVE ALL RECESSED FLOOR BOXES, WALKER DUCTS, FLOOR SINKS, HUB DRAINS,

ELECTRICAL RECEPTACLES, ETC. AND FILL VOIDS AS REQUIRED. 11. REMOVE ALL DOOR STOPS AT ASSOCIATED DOORS TO BE DEMOLISHED. 12. NO TOXIC SUBSTANCES HAVE BEEN NOTED ON THE SITE. SHOULD THE CONTRACTOR ENCOUNTER ANY ASBESTOS, ASBESTOS PRODUCTS, PCBs OR OTHER

TOXIC SUBSTANCES, THE CONTRACTOR SHOULD REPORT THIS IMMEDIATELY TO THE OWNER IN WRITING PRIOR TO CONTINUING WORK IN THIS AREA. WORK SHALL NOT BE RESUMED EXCEPT BY WRITTEN AUTHORIZATION OR AGREEMENT. 13. ALL CONSTRUCTION DEBRIS AND EXCESS MATERIAL IS TO BE REMOVED BY THE CONTRACTOR AT THE END OF EACH WORK DAY. THE JOB SITE IS TO BE LEFT SUFFICIENTLY CLEAN AS TO WARRANT OWNER'S APPROVAL. 14. REMOVE ALL CEILING SYSTEMS IN THEIR ENTIRETY, INCLUDING TILE, GRID,

SUSPENSION WIRING, ANCHORS AND ALL ASSOCIATED APPURTENANCES. 5. CONTRACTOR SHALL SALVAGE ALL EXISTING CEILING TILES FOR POSSIBLE REUSE OR AS EXTRA STOCK FOR OWNER. SALVAGE ONLY UN-CUT TILES WITH NO VISIBLE DAMAGE. ONCE REMOVED, OWNER AND ARCHITECT WILL FIELD REVIEW AND APPROVE SALVAGED TILES PRIOR TO REUSE OR STORAGE.

DEMO PLAN REFERENCED NOTES:

FLOOR DEMOLITION KEYED NOTES

F1 REMOVE WALL BASE, RESILIENT TILE FLOORING, AND SUBSTRATE ADHESIVE COMPLETE. F2 REMOVE WALL BASE, CARPETING, AND SUBSTRATE ADHESIVE COMPLETE.

F3 REMOVE WALL BASE COMPLETE. F4 REMOVE METAL GRATE AND RAILINGS COMPLETE. PREP FLOOR SLAB DEPRESSION AND INFILL WITH CONCRETE TO E FLUSH WITH ADJACENT FLOOR SLABS

F5 HATCH INDICATES PROPOSED AREA OF SLAB REMOVAL AS REQ. FOR PLUMBING /ELECTRICAL WORK. BACKFILL AS REQUIRED AND INFILL PER DETAIL 8/A5.01

WALL DEMOLITION KEYED NOTES

W1 REMOVE GYP BD PARTITION AS REQUIRED FOR NEW OPENING.
W2 REMOVE GYP BD PARTITION TO EXTENTS SHOWN.

W3 REMOVE AND SALVAGE DOOR, FRAME, AND HARDWARE FOR RE-USE IN NEW WORK. W4 REMOVE FURRING AND INFILL FROM EXISTING WINDOW COMPLETE. REPAIR/TOUCH UP WINDOW AS REQ. FOR NEW WORK.

W5 REMOVE STOREFRONT SYSTEM AND MTL STUD PARTITION ABOVE COMPLETE.

W6 REMOVE EXTERIOR DOOR/FRAME COMPLETE PREP ROUGH OPENING FOR NEW WORK.

CEILING DEMOLITION KEYED NOTES

C2 REMOVE GYP. BD. CEILINGS AND BULKHEAD COMPLETE. C2A REMOVE GYP. BD. CEILING TO EXTENTS SHOWN.

C2B EXISTING GYP. BD. CEILING TO REMAIN REMOVE EXISTING RECESSED LIGHT FIXTURES COMPLETE AND PREP OPENING AS REQUIRED FOR NEW LIGHT FIXTURES. C3A REMOVE ACOUSTIC CEILING TILE SYSTEM TO EXTENTS SHOWN.

C3B EXISTING CEILING TILE SYSTEM TO REMAIN. C4 REMOVE PRIVACY CURTAINS AND ASSOCIATED TRACK.

C5 CURVED GYP BD. CLOUD CEILING- REMOVE EXISTING RECESSED LIGHT FIXTURES COMPLETE AND PREP OPENINGS AS REQ. FOR NEW LIGHT FIXTURES REMOVE. C6 CLOUD CEILING SYSTEM TO BE REMOVED COMPLETE

MISCELLANEOUS DEMOLITION KEYED NOTES

M1 REMOVE COUNTERTOP AND BASE CABINETS COMPLETE. M2 REMOVE UPPER CABINETS/GOGGLE COMPLETE.

M3 REMOVE SINK AND ASSOCIATED UTILITIES COMPLETE. M4 REMOVE DISPLAY BOARD COMPLETE.

M5 REMOVE FULL HEIGHT CABINETS COMPLETE. M6 REMOVE WALL MOUNTED SHELVES COMPLETE.

M7 REMOVE WATER SHUT OFF VALVE AND ASSOCIATED PIPING COMPLETE (REFER TO CIVIL AND PLUMBING) M8 (NOT USED)

M9 REMOVE DRINKING FOUNTAIN AND ASSOCIATED PLUMBING COMPLETE. FOR RE-LOCATION IN NEW WORK.

M10 REMOVE TECHNOLOGY RACK COMPLETE (REFER TO TECH) M11 REMOVE DOOR . FRAME EXISTING TO REMAIN.

*PROTECT ALL ITEMS NOTED BELOW THROUGH-OUT DEMOLITION AND NEW CONSTRUCTION. **REMOVE AND REINSTALL AS REQUIRED FOR NEW WORK.

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CIVIL ENGINEERS **HRG GREEN**

P: 847.882.2010 F: 847.882.2201

1391 CORPORATE DRIVE, SUITE 203 MChENRY ,IL 60050 P:815.385.1778 F:815.385.1781

9.19.23 SHEET STATUS: **ISSUED FOR BIDS**


KEY PLAN:

NO:	DESCRIPTION:	DATE:
СН	EET TITI E:	

DEMOLITION PLAN

SHEET NUMBER:

AD1.10

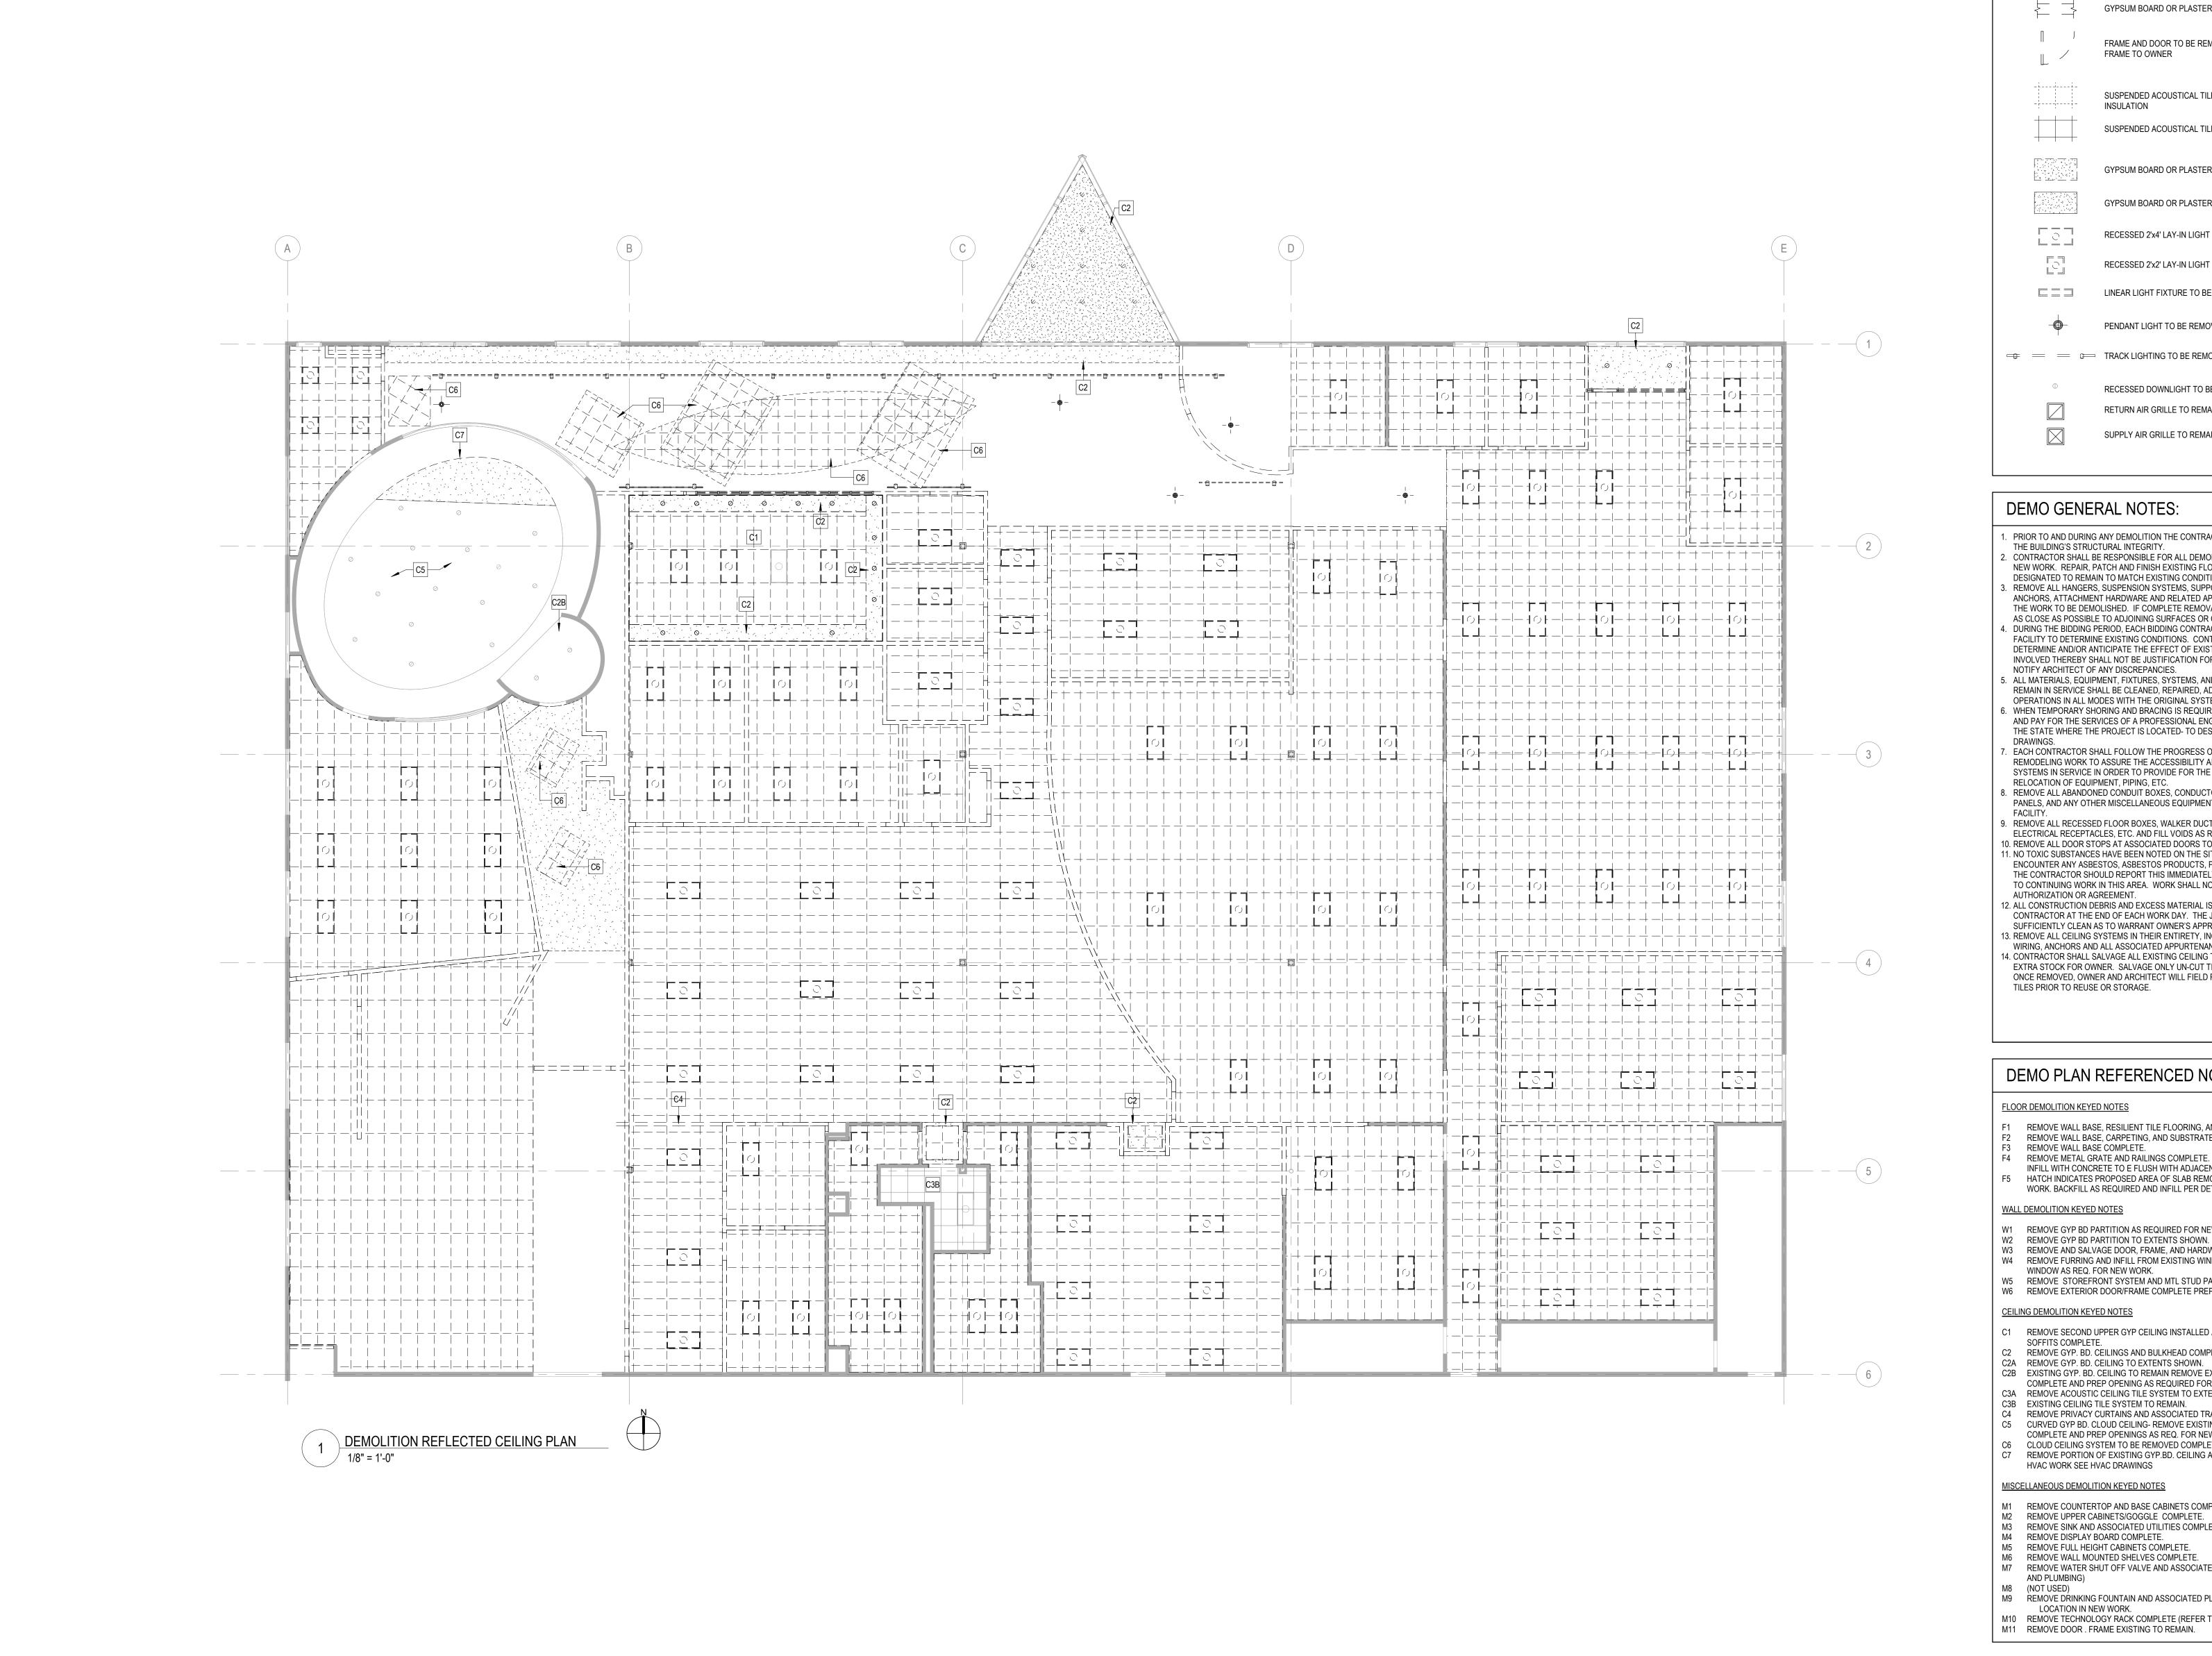

DEMO RCP SYMBOLS LEGEND: NOTE: REFER TO M.E.P.F.P. DRAWINGS FOR ADDITIONAL INFORMATION ON MECHANICAL, ELECTRICAL, AND FIRE PROTECTION SYSTEMS

ARCHITECT OF RECORD CHICAGO, IL 60661

P: 312.496.0000

SUSPENDED ACOUSTICAL TILE CEILING TO REMAIN

SUSPENDED ACOUSTICAL TILE CEILING TO BE REMOVED WITH BATT

GYPSUM BOARD OR PLASTER PARTITION TO BE REMOVED

FRAME AND DOOR TO BE REMOVED, SALVAGE DOOR

GYPSUM BOARD OR PLASTER CEILING TO BE REMOVED

GYPSUM BOARD OR PLASTER CEILING TO REMAIN

RECESSED 2'x4' LAY-IN LIGHT FIXTURE TO BE REMOVED RECESSED 2'x2' LAY-IN LIGHT FIXTURE TO BE REMOVED

LINEAR LIGHT FIXTURE TO BE REMOVED PENDANT LIGHT TO BE REMOVED

FRAME TO OWNER

TRACK LIGHTING TO BE REMOVED

RECESSED DOWNLIGHT TO BE REMOVED RETURN AIR GRILLE TO REMAIN

SUPPLY AIR GRILLE TO REMAIN

DEMO GENERAL NOTES:

PRIOR TO AND DURING ANY DEMOLITION THE CONTRACTOR SHALL VERIFY AND MAINTAIN THE BUILDING'S STRUCTURAL INTEGRITY. CONTRACTOR SHALL BE RESPONSIBLE FOR ALL DEMOLITION AS REQUIRED TO INSTALL ALL NEW WORK. REPAIR, PATCH AND FINISH EXISTING FLOORS, WALLS AND CEILINGS

- DESIGNATED TO REMAIN TO MATCH EXISTING CONDITIONS. REMOVE ALL HANGERS, SUSPENSION SYSTEMS, SUPPORT FRAMING, EQUIPMENT PADS, ANCHORS, ATTACHMENT HARDWARE AND RELATED APPURTENANCES CONNECTED WITH THE WORK TO BE DEMOLISHED. IF COMPLETE REMOVAL IS NOT POSSIBLE, CUT DEVICES AS CLOSE AS POSSIBLE TO ADJOINING SURFACES OR ORIGIN OF SUPPORT. . DURING THE BIDDING PERIOD, EACH BIDDING CONTRACTOR SHALL VISIT THE SITE AND THE
- FACII ITY TO DETERMINE EXISTING CONDITIONS.. CONTRACTOR'S FAII URE TO REASONABI. DETERMINE AND/OR ANTICIPATE THE EFFECT OF EXISTING CONDITIONS AND THE WORK INVOLVED THEREBY SHALL NOT BE JUSTIFICATION FOR ADDITIONAL COMPENSATION. NOTIFY ARCHITECT OF ANY DISCREPANCIES. REMAIN IN SERVICE SHALL BE CLEANED, REPAIRED, ADJUSTED AND PLACED INTO PROPER
- OPERATIONS IN ALL MODES WITH THE ORIGINAL SYSTEM. WHEN TEMPORARY SHORING AND BRACING IS REQUIRED, CONTRACTOR SHALL RETAIN AND PAY FOR THE SERVICES OF A PROFESSIONAL ENGINEER- LICENSED TO PRACTICE IN THE STATE WHERE THE PROJECT IS LOCATED- TO DESIGN AND PREPARE DETAILED
- EACH CONTRACTOR SHALL FOLLOW THE PROGRESS OF THE GENERAL DEMOLITION AND REMODELING WORK TO ASSURE THE ACCESSIBILITY AND SAFETY OF EQUIPMENT AND SYSTEMS IN SERVICE IN ORDER TO PROVIDE FOR THE TIMELY REMOVAL AND/OR RELOCATION OF EQUIPMENT, PIPING, ETC.
- REMOVE ALL ABANDONED CONDUIT BOXES, CONDUCTORS, TELEPHONE LINES, ELECTRIC PANELS, AND ANY OTHER MISCELLANEOUS EQUIPMENT NOT REQUIRED FOR THE NEW
- ELECTRICAL RECEPTACLES, ETC. AND FILL VOIDS AS REQUIRED. 1. NO TOXIC SUBSTANCES HAVE BEEN NOTED ON THE SITE. SHOULD THE CONTRACTOR ENCOUNTER ANY ASBESTOS, ASBESTOS PRODUCTS, PCBs OR OTHER TOXIC SUBSTANCES, THE CONTRACTOR SHOULD REPORT THIS IMMEDIATELY TO THE OWNER IN WRITING PRIOR TO CONTINUING WORK IN THIS AREA. WORK SHALL NOT BE RESUMED EXCEPT BY WRITTEN
- AUTHORIZATION OR AGREEMENT. 2. ALL CONSTRUCTION DEBRIS AND EXCESS MATERIAL IS TO BE REMOVED BY THE CONTRACTOR AT THE END OF EACH WORK DAY. THE JOB SITE IS TO BE LEFT
- 4. CONTRACTOR SHALL SALVAGE ALL EXISTING CEILING TILES FOR POSSIBLE REUSE OR AS EXTRA STOCK FOR OWNER. SALVAGE ONLY UN-CUT TILES WITH NO VISIBLE DAMAGE. ONCE REMOVED, OWNER AND ARCHITECT WILL FIELD REVIEW AND APPROVE SALVAGED TILES PRIOR TO REUSE OR STORAGE.

DEMO PLAN REFERENCED NOTES:

FLOOR DEMOLITION KEYED NOTES

- F1 REMOVE WALL BASE, RESILIENT TILE FLOORING, AND SUBSTRATE ADHESIVE COMPLETE. F2 REMOVE WALL BASE, CARPETING, AND SUBSTRATE ADHESIVE COMPLETE. F3 REMOVE WALL BASE COMPLETE.
- F4 REMOVE METAL GRATE AND RAILINGS COMPLETE. PREP FLOOR SLAB DEPRESSION AND INFILL WITH CONCRETE TO E FLUSH WITH ADJACENT FLOOR SLABS F5 HATCH INDICATES PROPOSED AREA OF SLAB REMOVAL AS REQ. FRO PLUMBING /CIVIL WORK. BACKFILL AS REQUIRED AND INFILL PER DETAIL 8/A7.01

WALL DEMOLITION KEYED NOTES

- W1 REMOVE GYP BD PARTITION AS REQUIRED FOR NEW OPENING. W2 REMOVE GYP BD PARTITION TO EXTENTS SHOWN.
- W3 REMOVE AND SALVAGE DOOR, FRAME, AND HARDWARE FOR RE-USE IN NEW WORK. W4 REMOVE FURRING AND INFILL FROM EXISTING WINDOW COMPLETE. REPAIR/TOUCH UP
- WINDOW AS REQ. FOR NEW WORK. W5 REMOVE STOREFRONT SYSTEM AND MTL STUD PARTITION ABOVE COMPLETE. W6 REMOVE EXTERIOR DOOR/FRAME COMPLETE PREP ROUGH OPENING FOR NEW WORK.
- CEILING DEMOLITION KEYED NOTES C1 REMOVE SECOND UPPER GYP CEILING INSTALLED ABOVE EXISTING SAT CEILING / GYP
- SOFFITS COMPLETE. C2 REMOVE GYP. BD. CEILINGS AND BULKHEAD COMPLETE. C2A REMOVE GYP. BD. CEILING TO EXTENTS SHOWN.
- C2B EXISTING GYP. BD. CEILING TO REMAIN REMOVE EXISTING RECESSED LIGHT FIXTURES COMPLETE AND PREP OPENING AS REQUIRED FOR NEW LIGHT FIXTURES.
- C3A REMOVE ACOUSTIC CEILING TILE SYSTEM TO EXTENTS SHOWN. C3B EXISTING CEILING TILE SYSTEM TO REMAIN. C4 REMOVE PRIVACY CURTAINS AND ASSOCIATED TRACK.
- C5 CURVED GYP BD. CLOUD CEILING- REMOVE EXISTING RECESSED LIGHT FIXTURES COMPLETE AND PREP OPENINGS AS REQ. FOR NEW LIGHT FIXTURES REMOVE. C6 CLOUD CEILING SYSTEM TO BE REMOVED COMPLETE C7 REMOVE PORTION OF EXISTING GYP.BD. CEILING AS REQUIRED TO ACCOMMODATE
- HVAC WORK SEE HVAC DRAWINGS MISCELLANEOUS DEMOLITION KEYED NOTES
- M1 REMOVE COUNTERTOP AND BASE CABINETS COMPLETE.
- M3 REMOVE SINK AND ASSOCIATED UTILITIES COMPLETE. M4 REMOVE DISPLAY BOARD COMPLETE.
- M5 REMOVE FULL HEIGHT CABINETS COMPLETE.
- M6 REMOVE WALL MOUNTED SHELVES COMPLETE. M7 REMOVE WATER SHUT OFF VALVE AND ASSOCIATED PIPING COMPLETE (REFER TO CIVIL AND PLUMBING)
- M8 (NOT USED) M9 REMOVE DRINKING FOUNTAIN AND ASSOCIATED PLUMBING COMPLETE. FOR RE-
- LOCATION IN NEW WORK. M10 REMOVE TECHNOLOGY RACK COMPLETE (REFER TO TECH) M11 REMOVE DOOR . FRAME EXISTING TO REMAIN.

*PROTECT ALL ITEMS NOTED BELOW THROUGH-OUT DEMOLITION AND NEW CONSTRUCTION. **REMOVE AND REINSTALL AS REQUIRED FOR NEW WORK.

DEMONICA KEMPER ARCHITECTS 125 N. HALSTED STREET, SUITE 301

MEP-FP-T-ENGINEERS 20/10 ENGINEERING GROUP, LLC 1216 TOWER ROAD SCHAUMBURG,IL 60173 P: 847.882.2010 F: 847.882.2201 CIVIL ENGINEERS **HRG GREEN**

1391 CORPORATE DRIVE, SUITE 203 MChENRY ,IL 60050 P:815.385.1778 F:815.385.1781

KEY PLAN:

9.19.23 SHEET STATUS:


ISSUED FOR BIDS

NO: DESCRIPTION: SHEET TITLE:

DEMOLITION RCP

SHEET NUMBER:

9/22/2023 2:16:25 PM

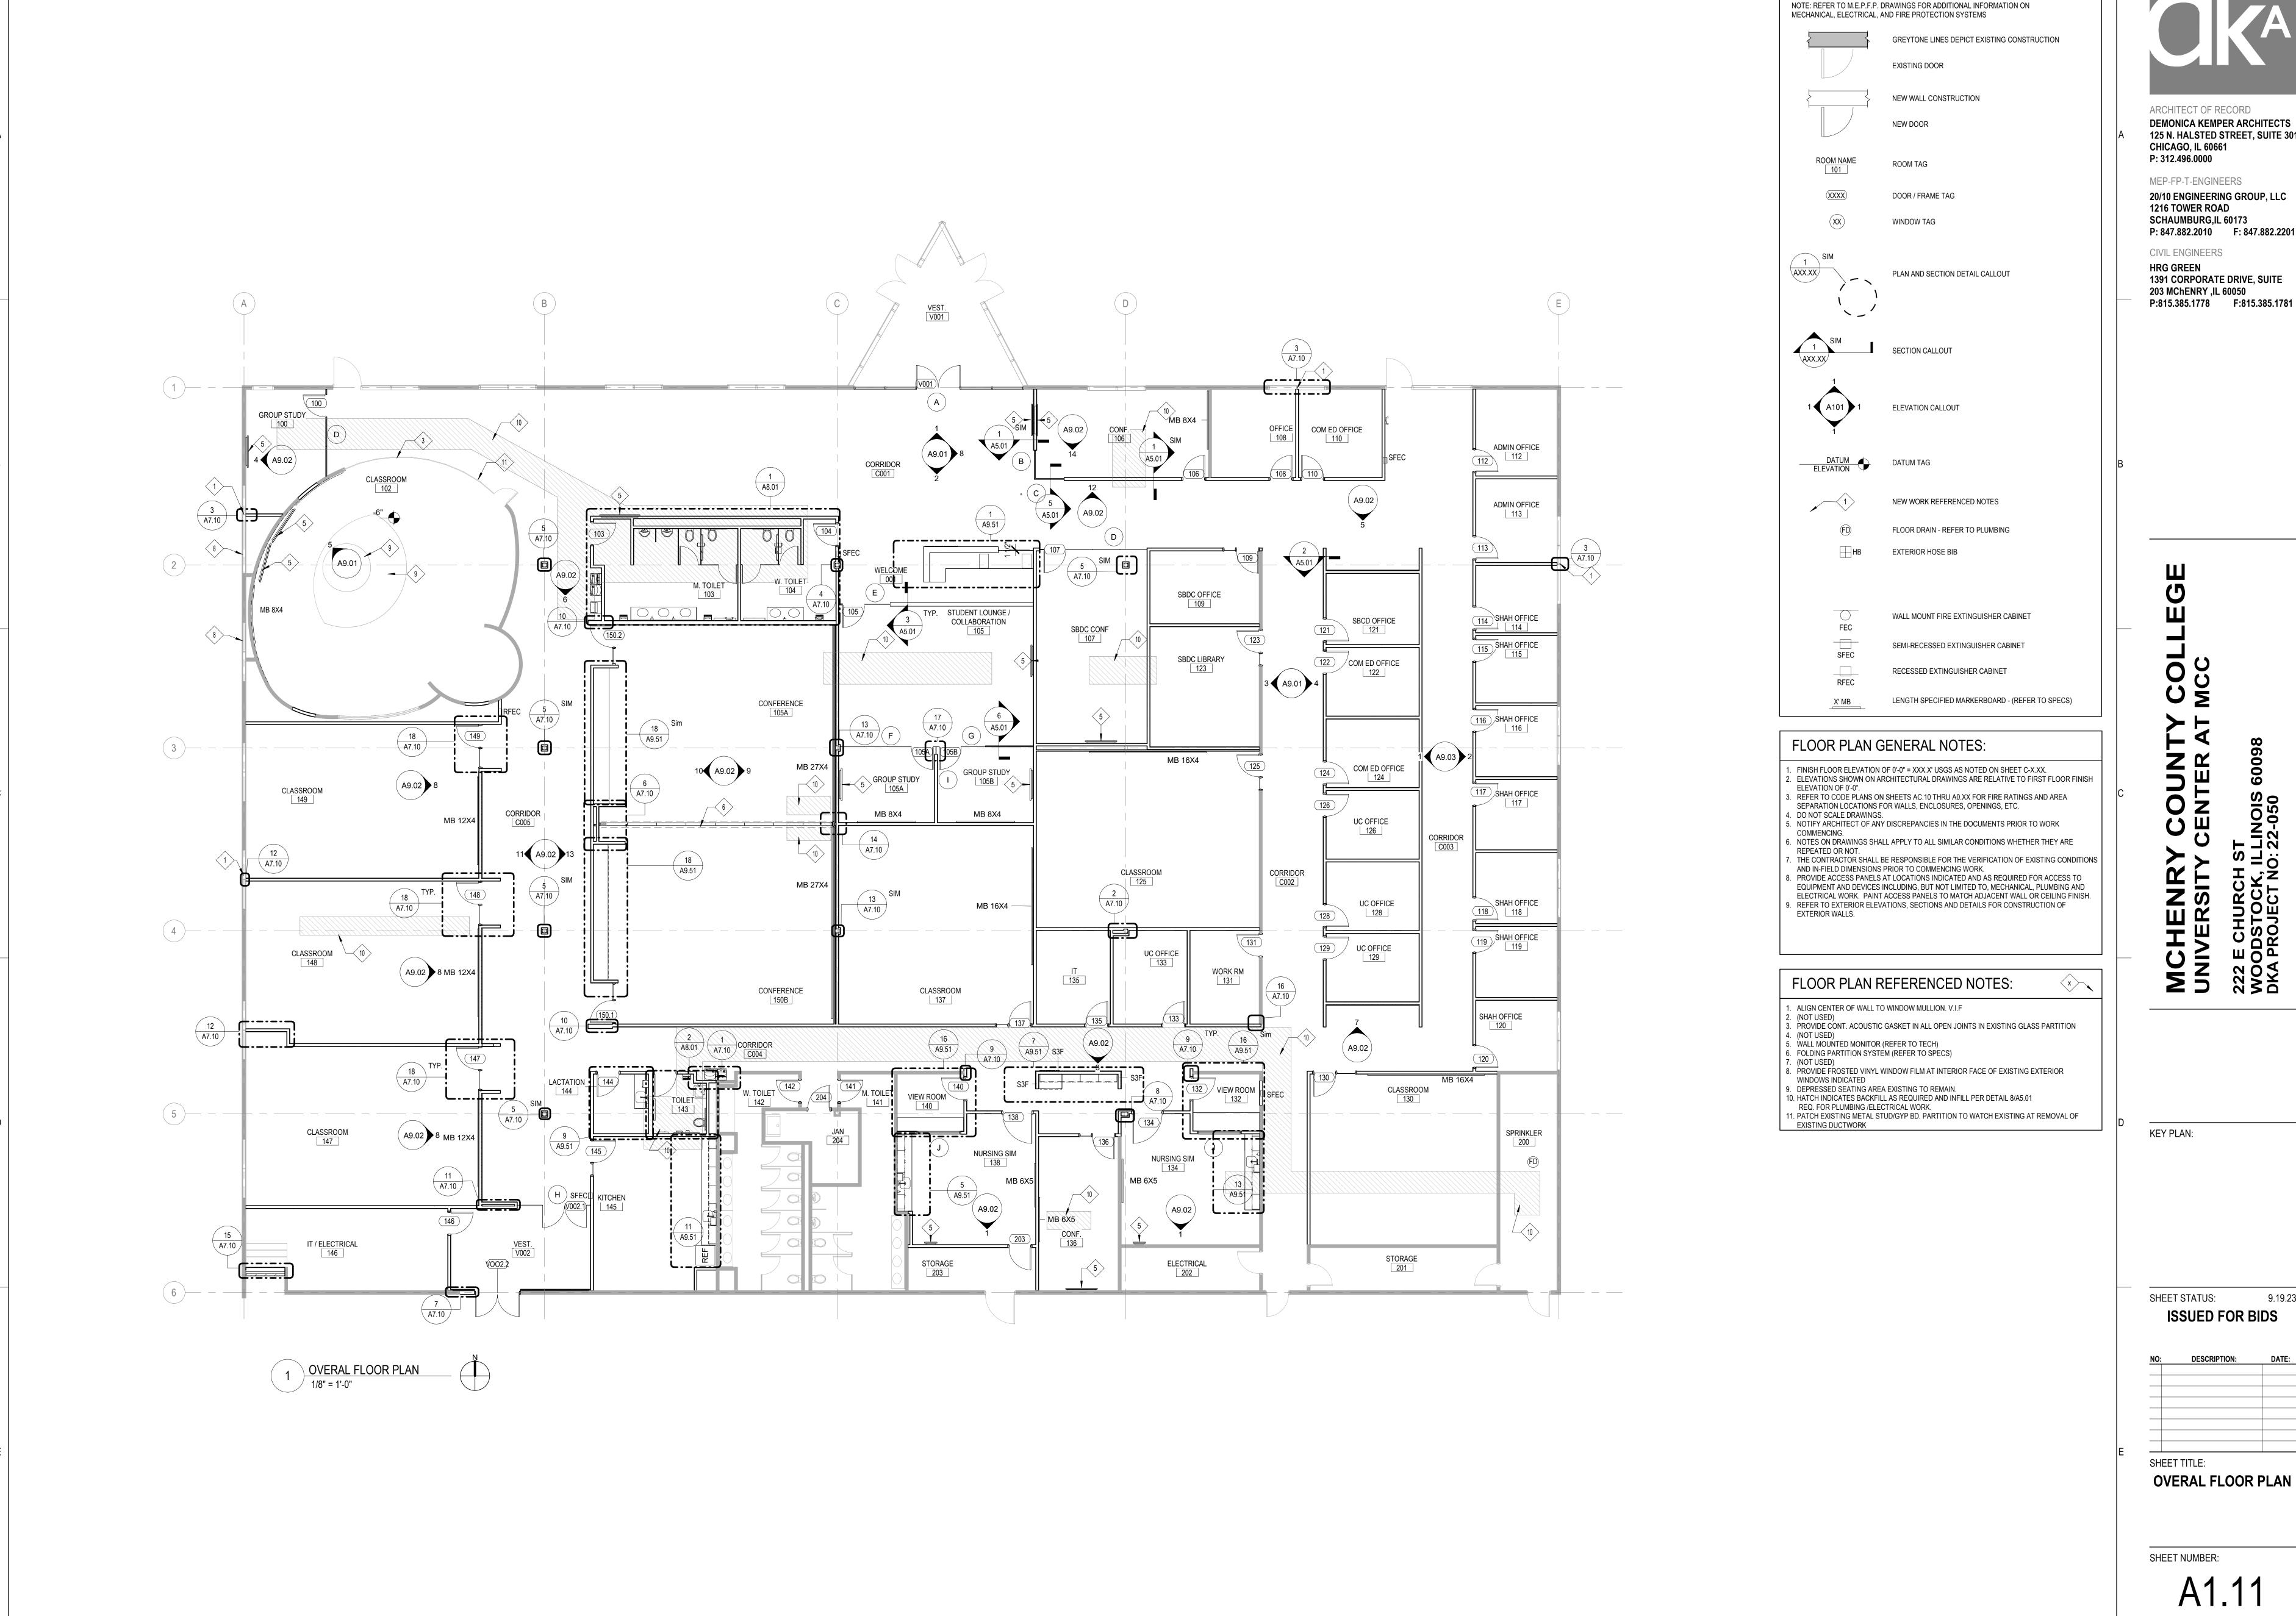



FLOOR PLAN & SECTION SYMBOLS LEGEND:

ARCHITECT OF RECORD DEMONICA KEMPER ARCHITECTS 125 N. HALSTED STREET, SUITE 301 **CHICAGO, IL 60661** P: 312.496.0000

MEP-FP-T-ENGINEERS 20/10 ENGINEERING GROUP, LLC

1216 TOWER ROAD SCHAUMBURG,IL 60173 P: 847.882.2010 F: 847.882.2201

CIVIL ENGINEERS **HRG GREEN**

1391 CORPORATE DRIVE, SUITE 203 MChENRY ,IL 60050

COUNCENTER


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NO: DESCRIPTION:

OVERAL FLOOR PLAN

SHEET NUMBER:

9/22/2023 2:16:33 PM



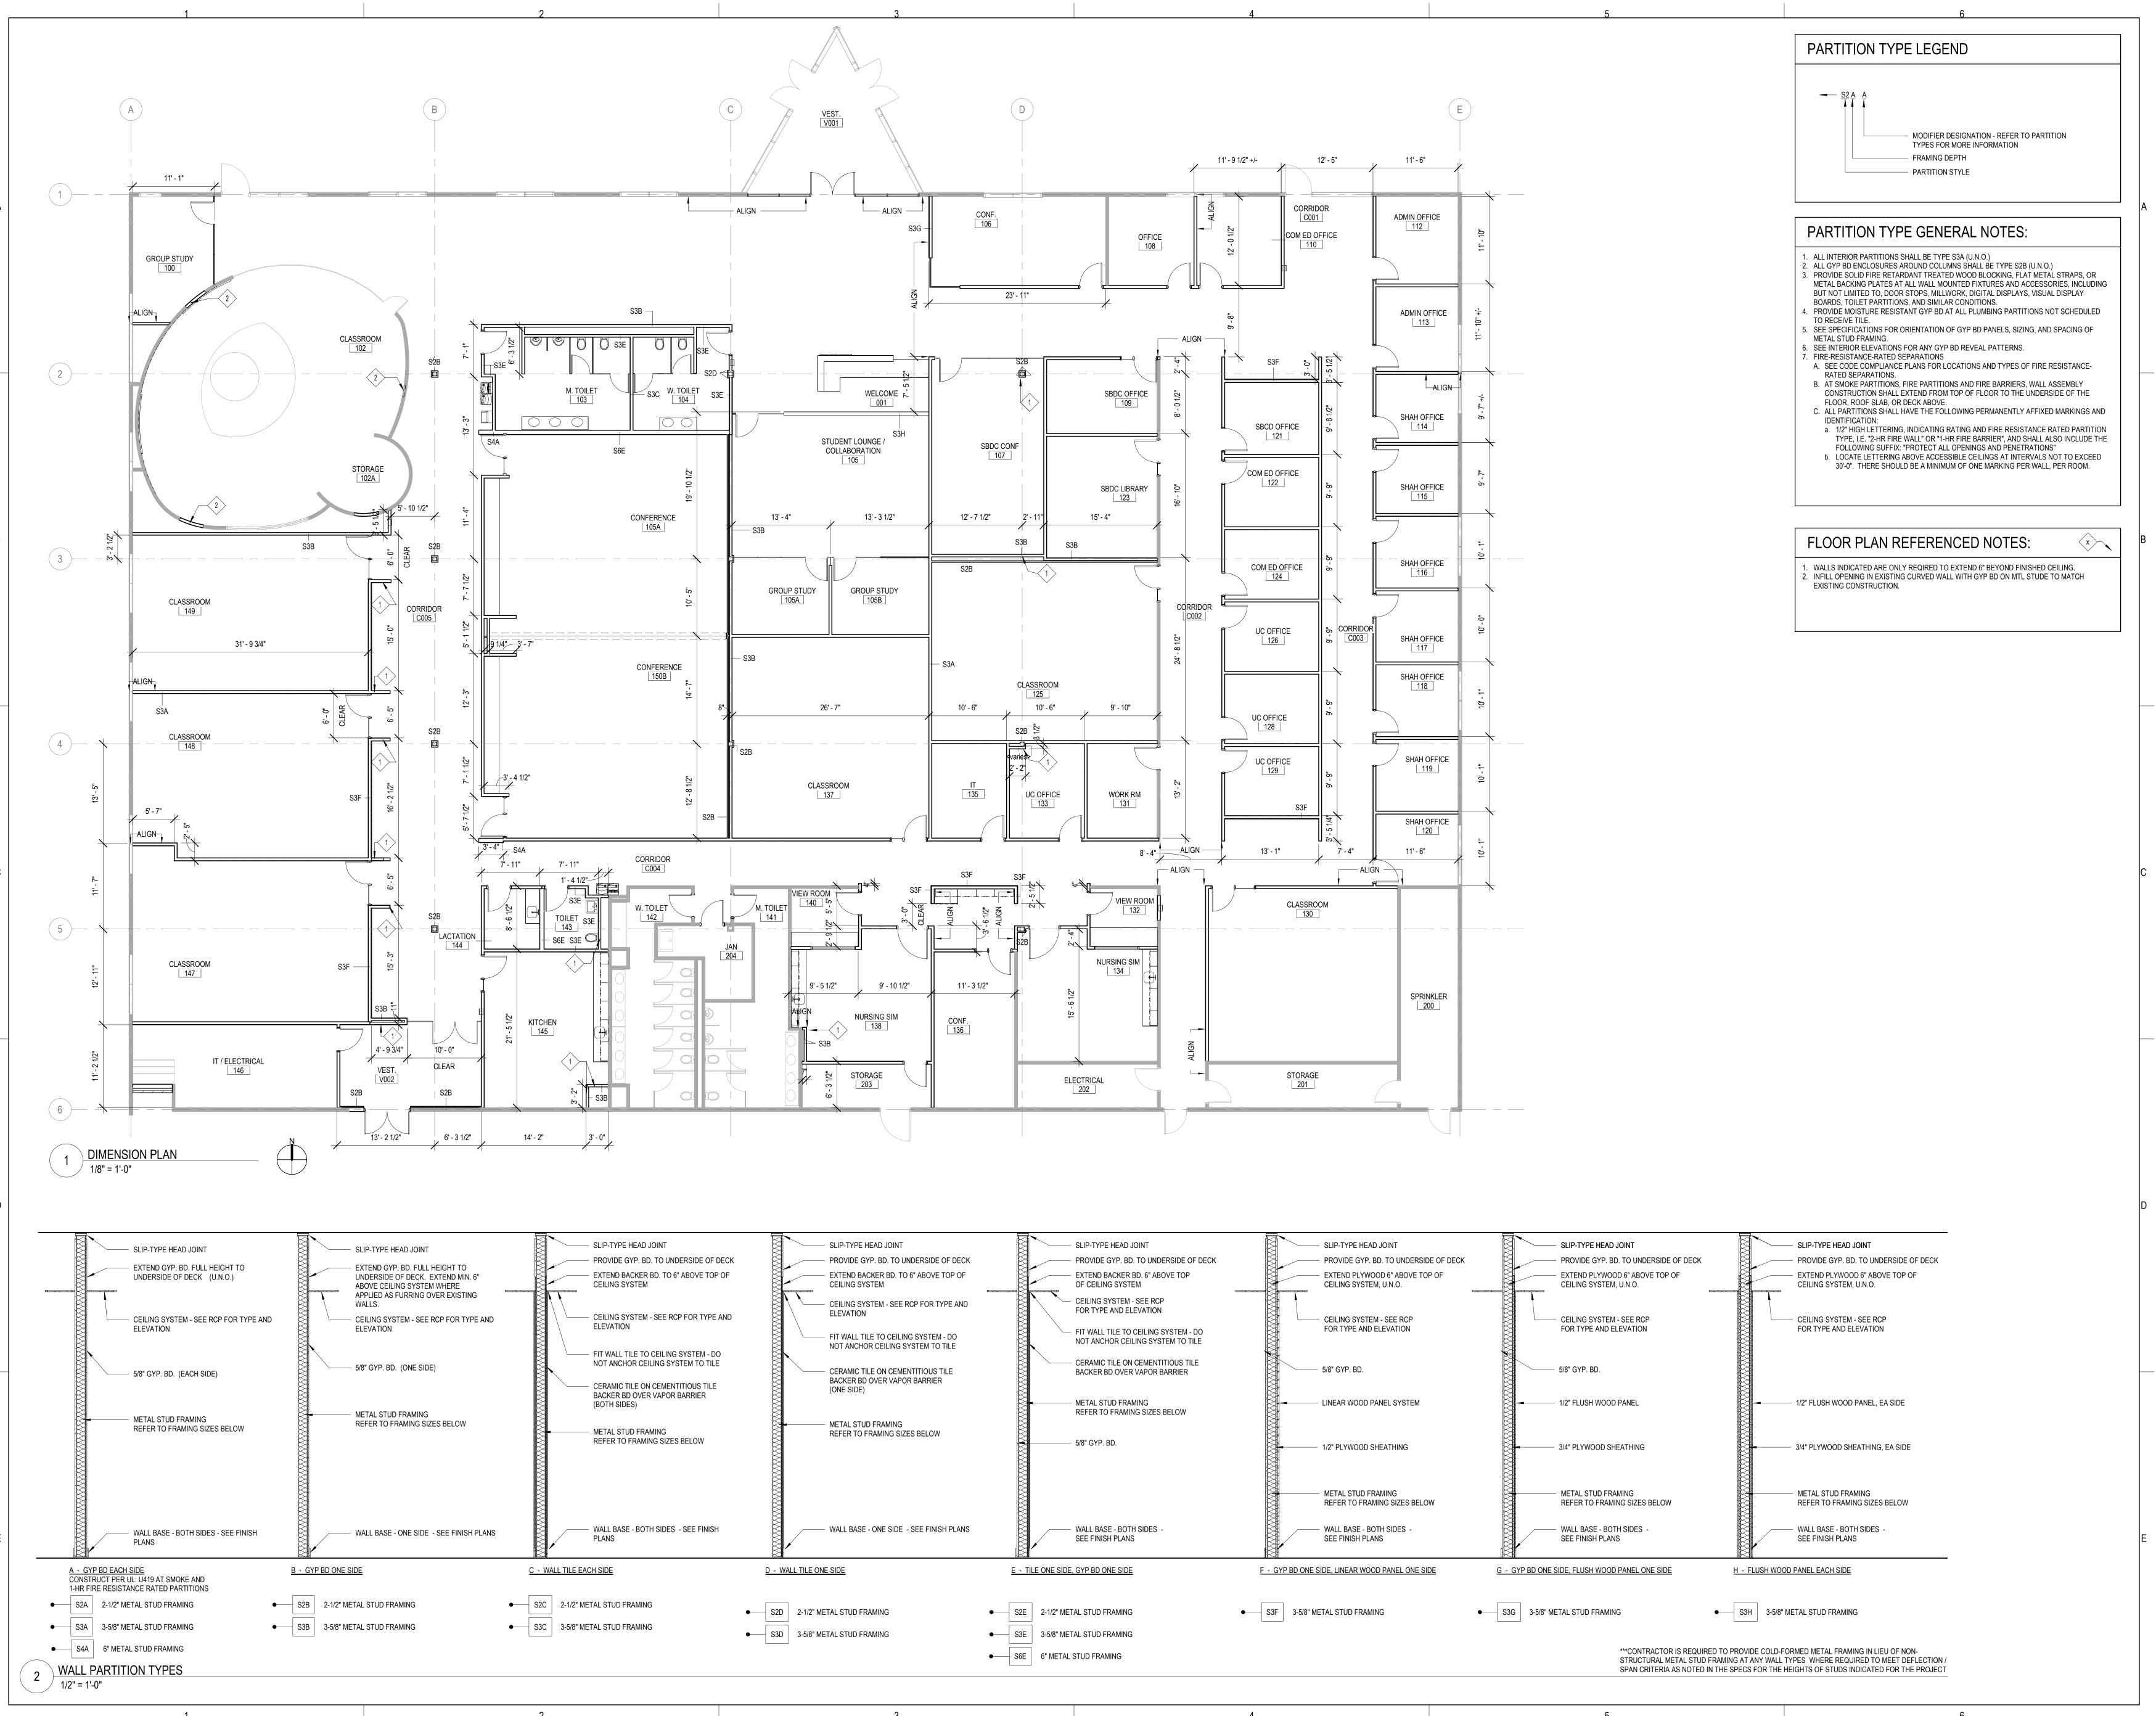

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CIVIL ENGINEERS

HRG GREEN
1391 CORPORATE DRIVE, SUITE
203 MChENRY ,IL 60050
P:815.385.1778 F:815.385.1781

NKY COUNTY COL SITY CENTER AT MCC

KEY PLAN:

SHEET STATUS: 9.19.23
ISSUED FOR BIDS

NO: DESCRIPTION: DATE:


SHEET TITLE:

DIMENSION PLAN

SHEET NUMBER:

A1.12

9/22/2023 2:16:29 PM

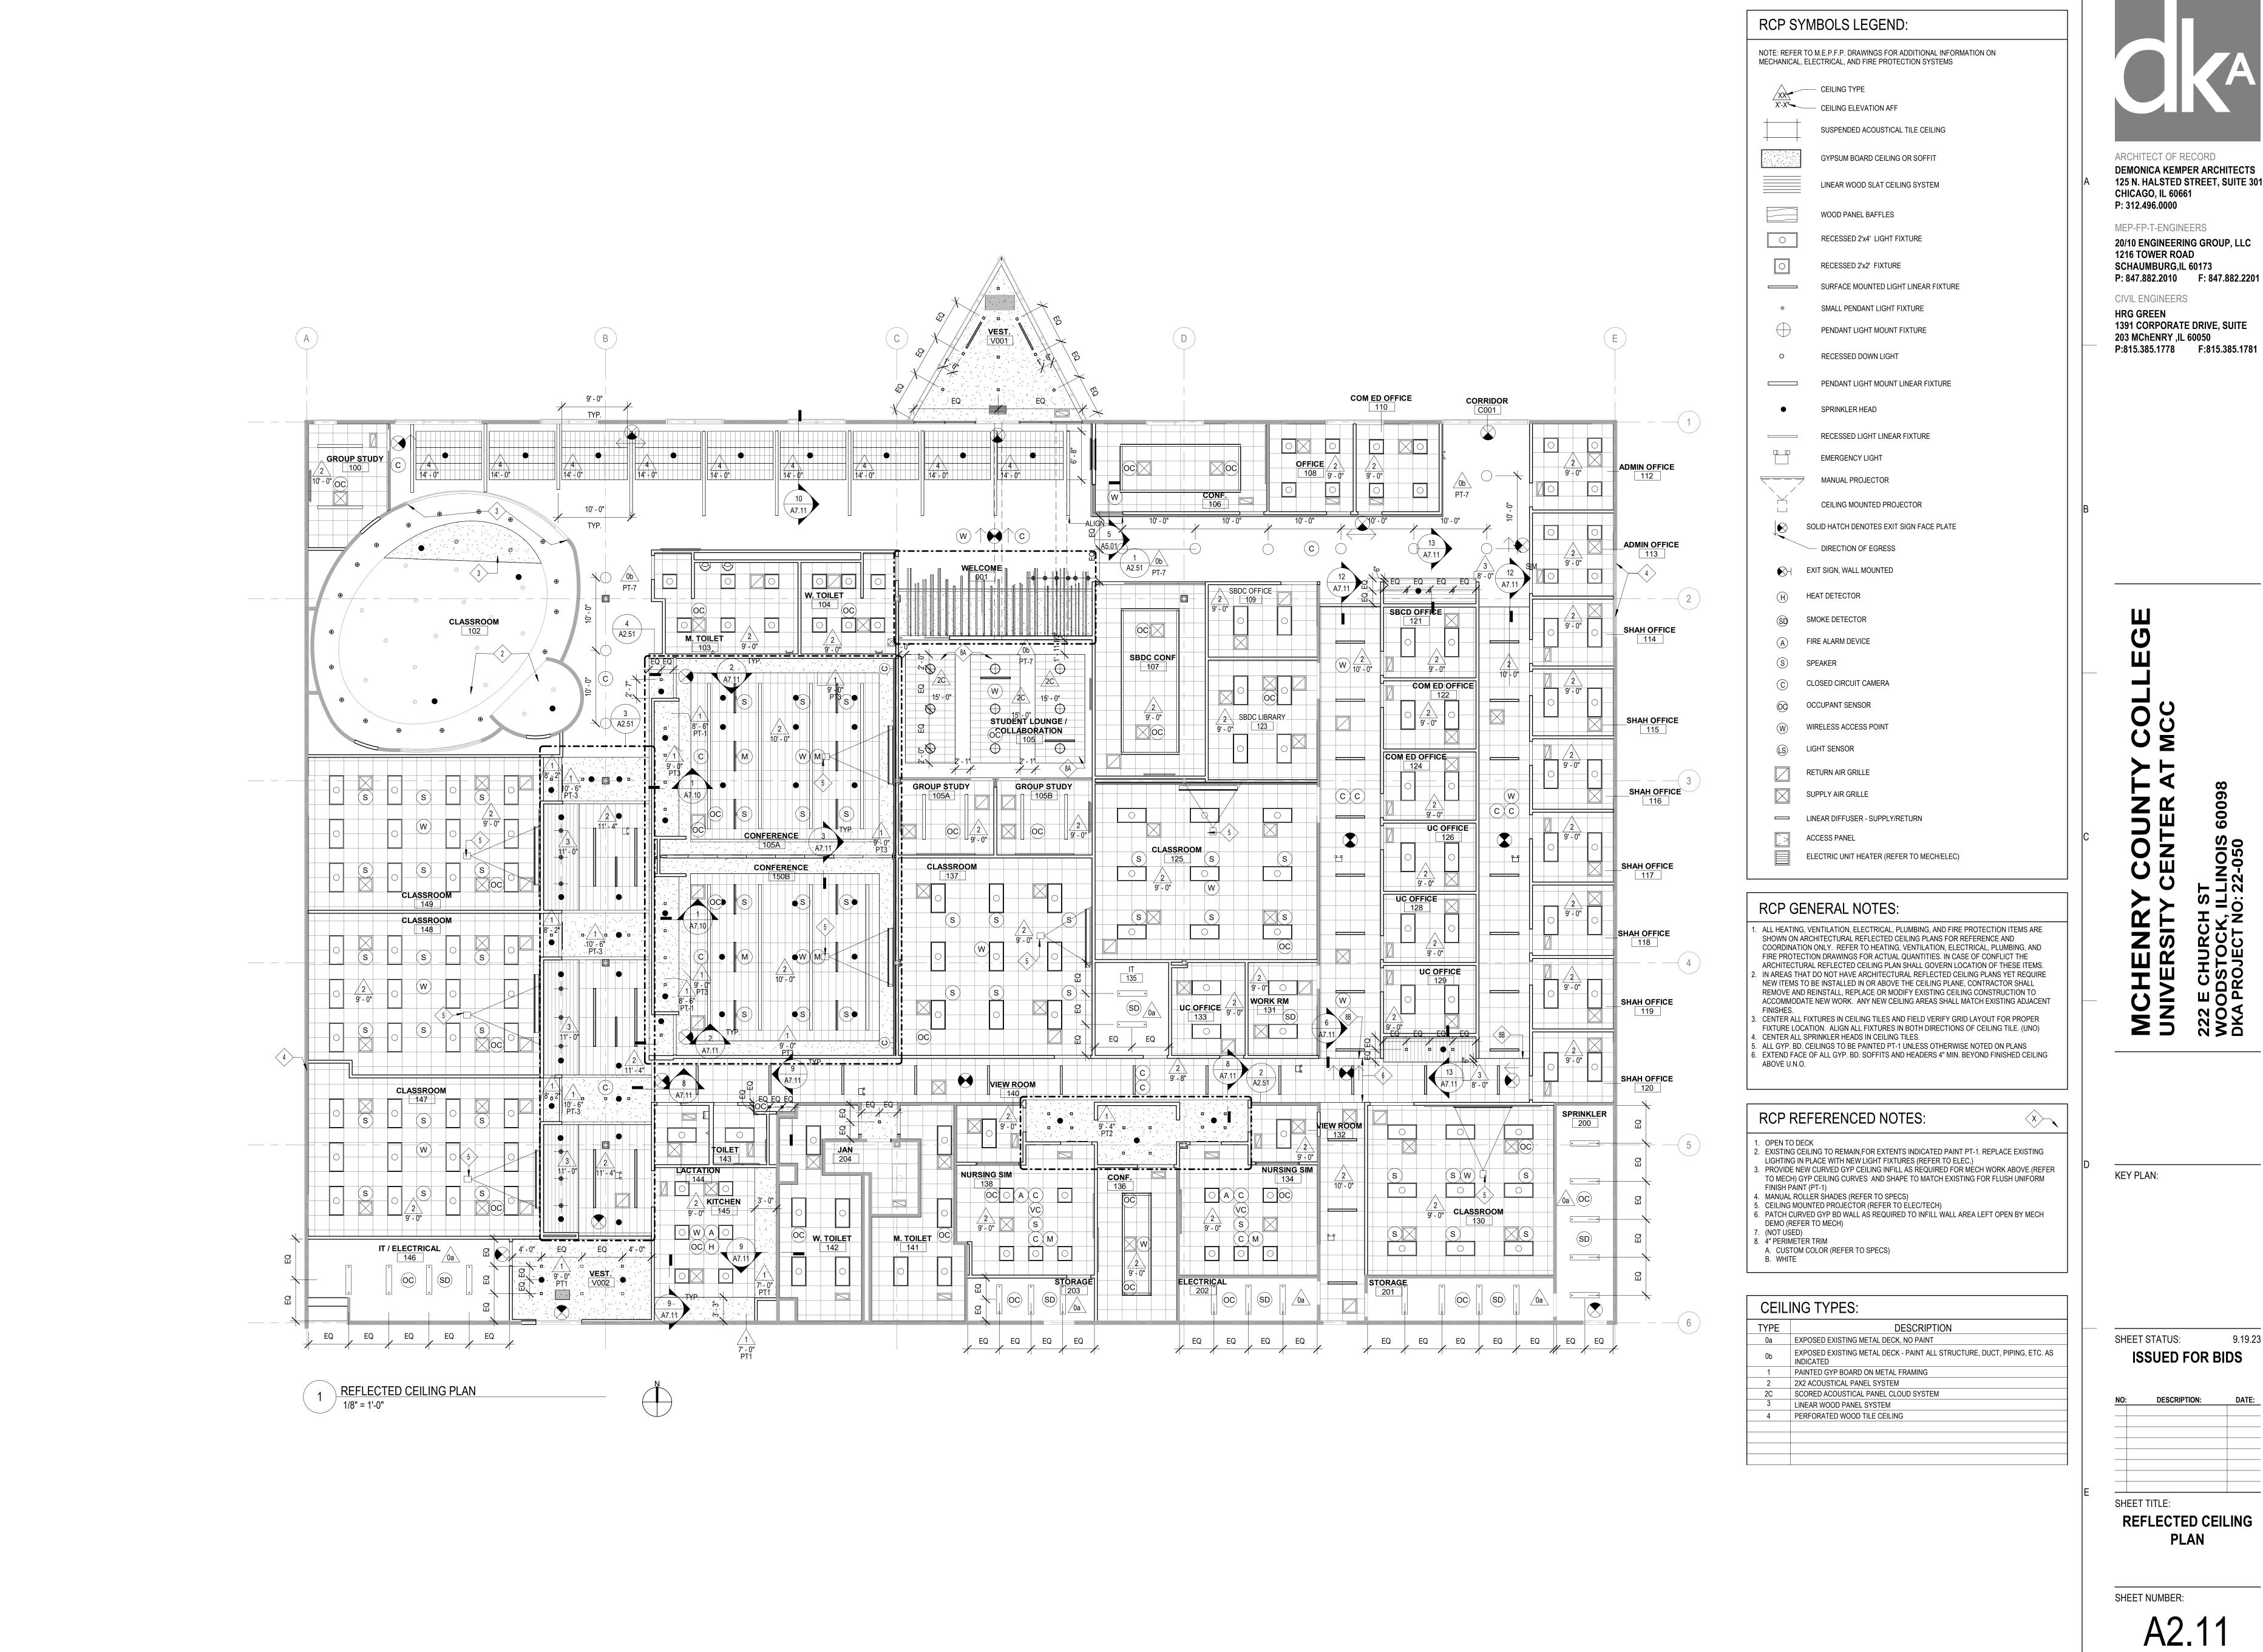

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CIVIL ENGINEERS **HRG GREEN**

203 MChENRY ,IL 60050

1391 CORPORATE DRIVE, SUITE P:815.385.1778 F:815.385.1781


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DESCRIPTION:

REFLECTED CEILING **PLAN**

SHEET NUMBER:

9/22/2023 2:16:41 PM

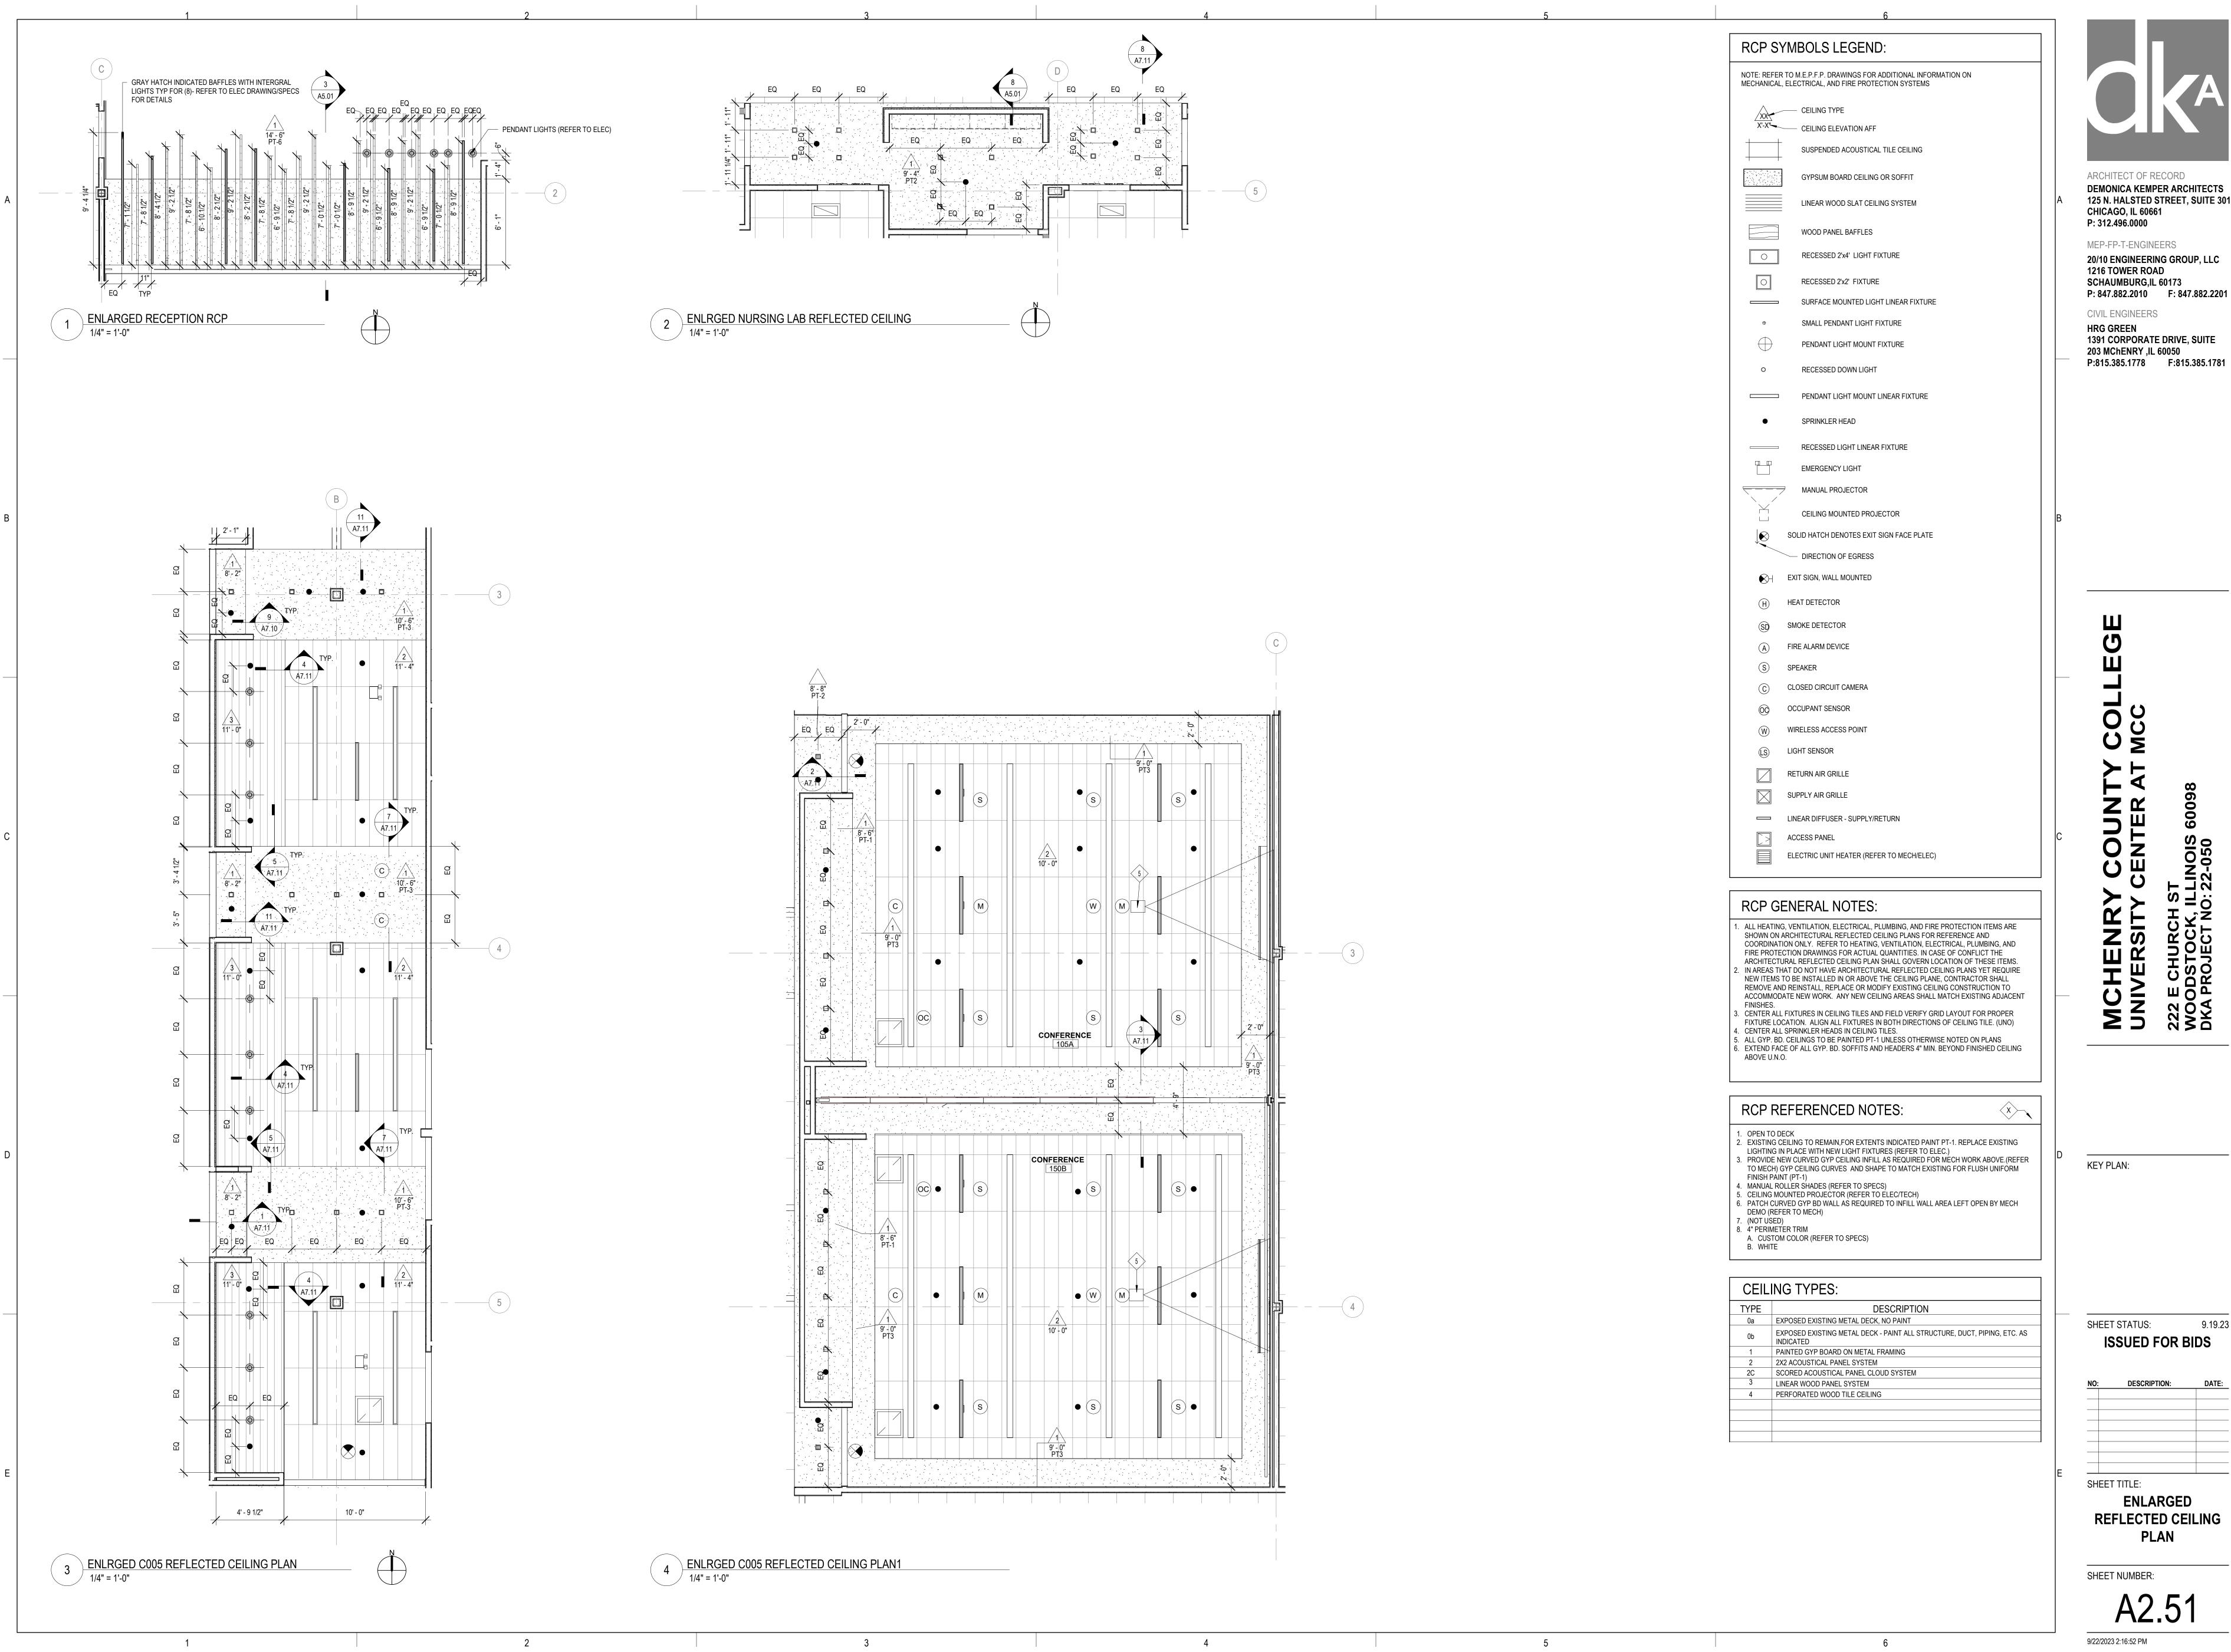

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CIVIL ENGINEERS

HRG GREEN

1391 CORPORATE DRIVE, SUITE 203 MChENRY ,IL 60050

9.19.23 SHEET STATUS:

ISSUED FOR BIDS


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REFLECTED CEILING PLAN

SHEET NUMBER:

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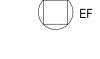


ROOF PLAN LEGEND:

NOTE: REFER TO M.E.P.F.P. DRAWINGS FOR ADDITIONAL INFORMATION ON MECHANICAL, ELECTRICAL, AND FIRE PROTECTION SYSTEMS

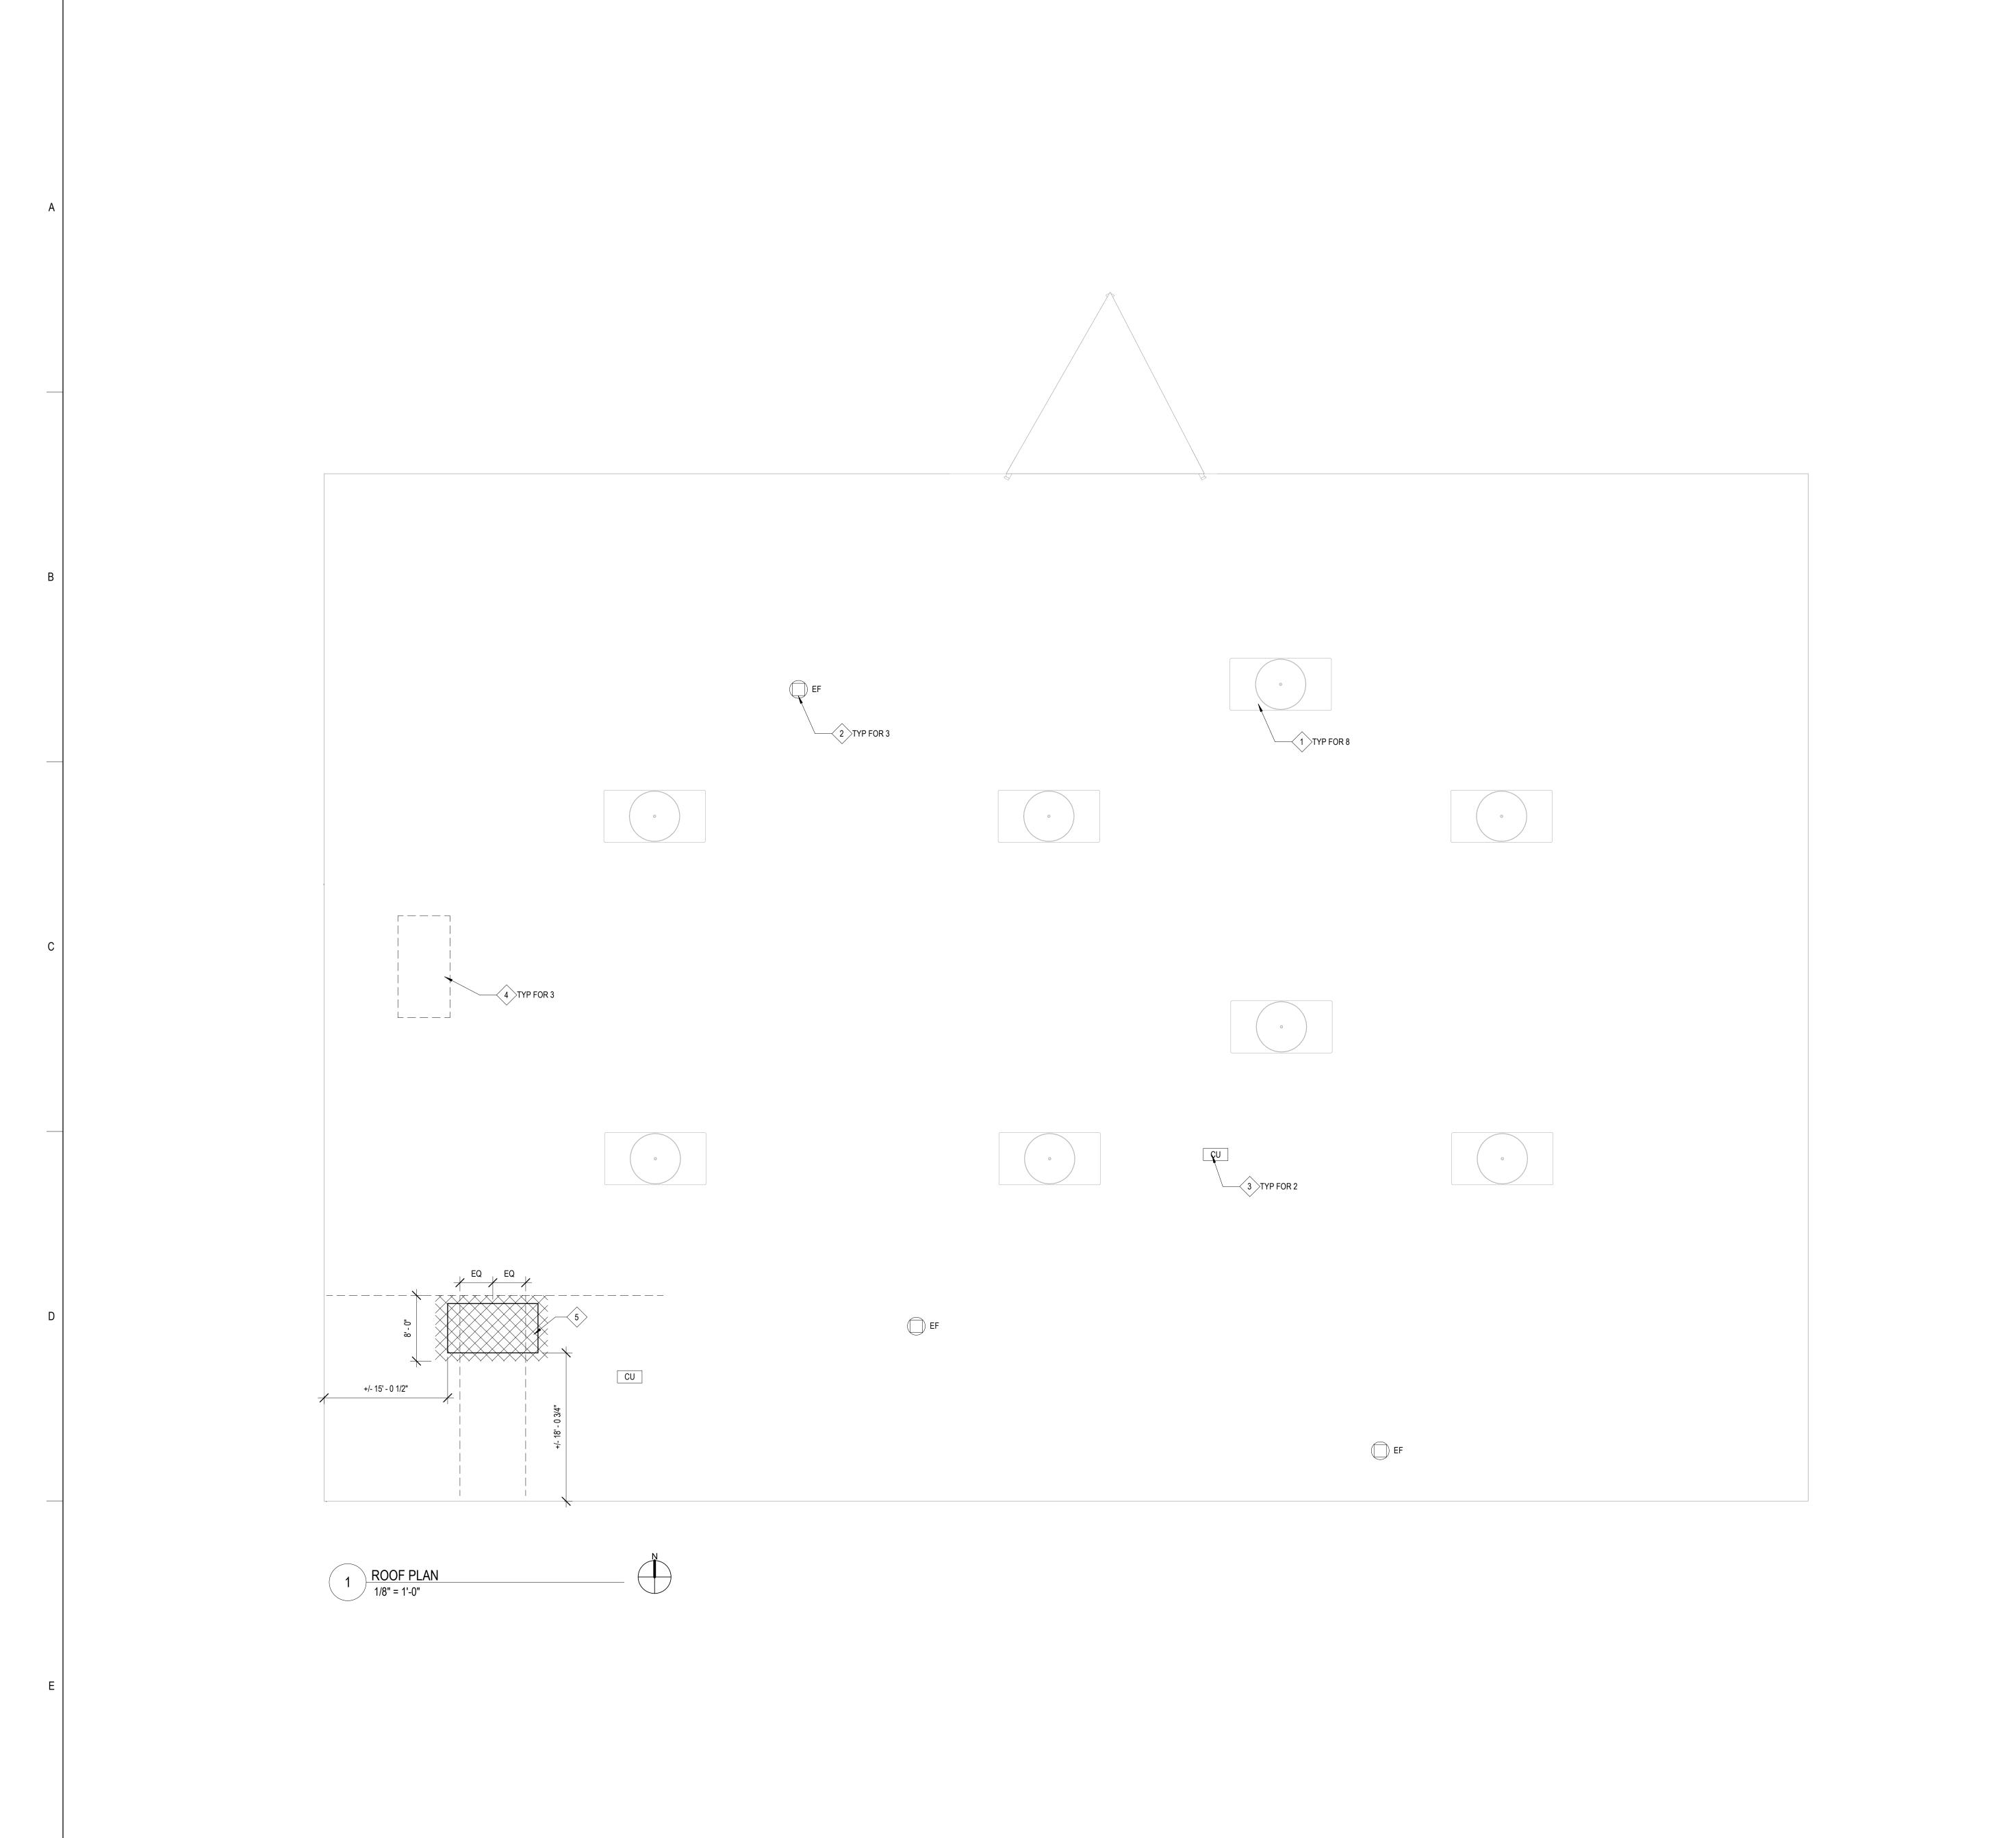

ROOF AREA NUMBER ROOF AREA TYPE



CONDENSER UNIT

EXHAUST FAN



PIPE PENETRATION

ROOF SYSTEM TYPES:

ROOF TYPE A: FLAT ROOF DECK - EXISTING TO REMAIN

1. VAPOR RETARDER - TAPE ALL JOINTS AND PERIMETER CONDITIONS. 2. ROOF INSULATION.

3. TOP LAYER OF TAPERED ROOF INSULATION. 4. MEMBRANE.

5. SHEET FLASHING. 6. PREFINISHED METAL COPINGS, END WALL FLASHING, COUNTERFLASHING, ETC.

*CONTRACTOR TO FIELD VERIFY EXISTING ROOF CONDITIONS AND PROVIDE ACCEPTABLE INFILLS / TIE-INS AT PENETRATIONS NOTED TO WORK WITH EXISTING ROOF WARRANTY.

**REFER TO MEP DRAWINGS FOR ADDITIONAL EQUIPMENT INFORMATION.

ROOF PLAN GENERAL NOTES:

- 1. EXISTING RTU TO REMAIN (REFER TO MECH) 2. NEW EXHAUST FAN (REFER TO MECH)
- 3. NEW CONDENSING UNIT (REFER TO MECH)
- 4. EXISTING RTU TO BE REMOVED PROVIDÉ INSULATED CAPS AT ALL CURBS / PENETRATIONS TO PROVIDE A COMPLETE SEALED AND INSULATED CONDITION AT EXISTING ROOF. 5. ROOF-MOUNTED STAND-BY GENERATOR - PROVIDE NON-PENETRATING ROOF-RAILS AS
- REQUIRED TO MOUNT THE GENERATOR INSTALL CENTERED ON THE BEAMS BELOW AND NO MORE THAN 1/3 THE OVERALL BEAM LENGTH FROM PRIMARY GIRDER AS INDICATED ON THE DRAWINGS (REFER TO ELEC).



ARCHITECT OF RECORD DEMONICA KEMPER ARCHITECTS 125 N. HALSTED STREET, SUITE 301 CHICAGO, IL 60661 P: 312.496.0000

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CIVIL ENGINEERS **HRG GREEN**

1391 CORPORATE DRIVE, SUITE 203 MChENRY ,IL 60050 P:815.385.1778 F:815.385.1781

KEY PLAN:


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ROOF PLAN

SHEET NUMBER:

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CIVIL ENGINEERS

1391 CORPORATE DRIVE, SUITE 203 MChENRY ,IL 60050


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SECTION DETAILS
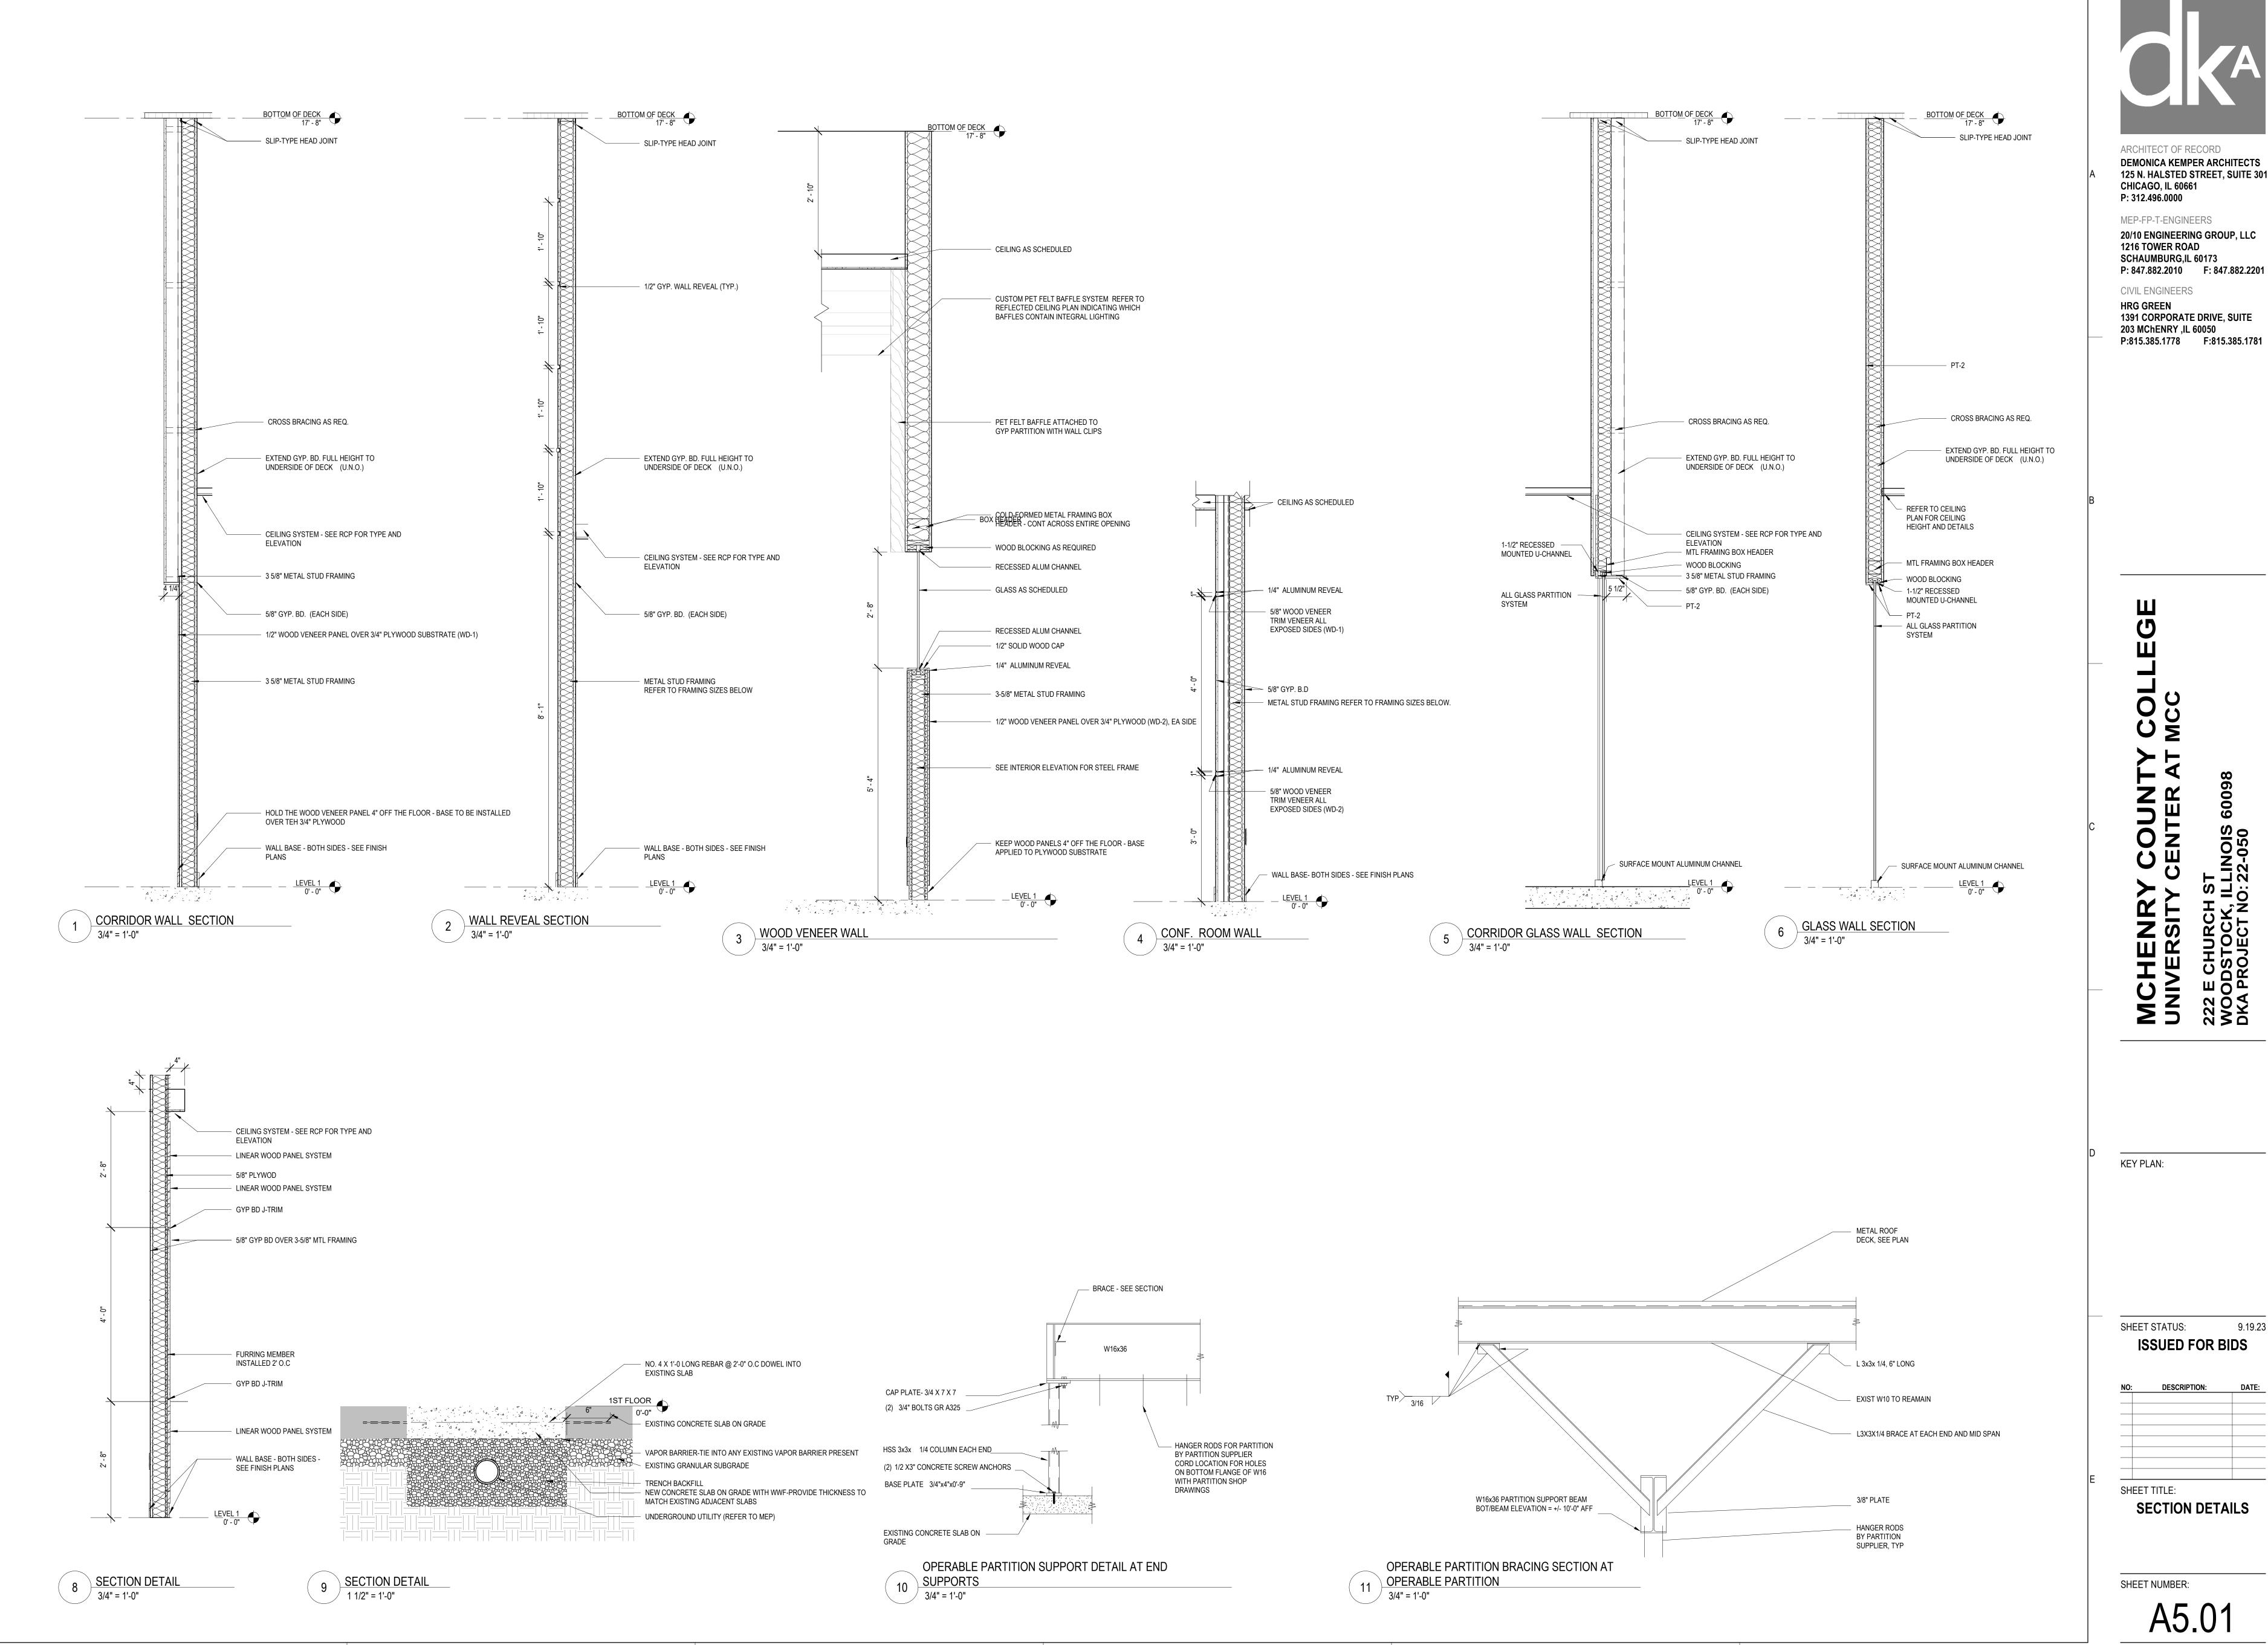
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9/22/2023 2:17:08 PM





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CIVIL ENGINEERS
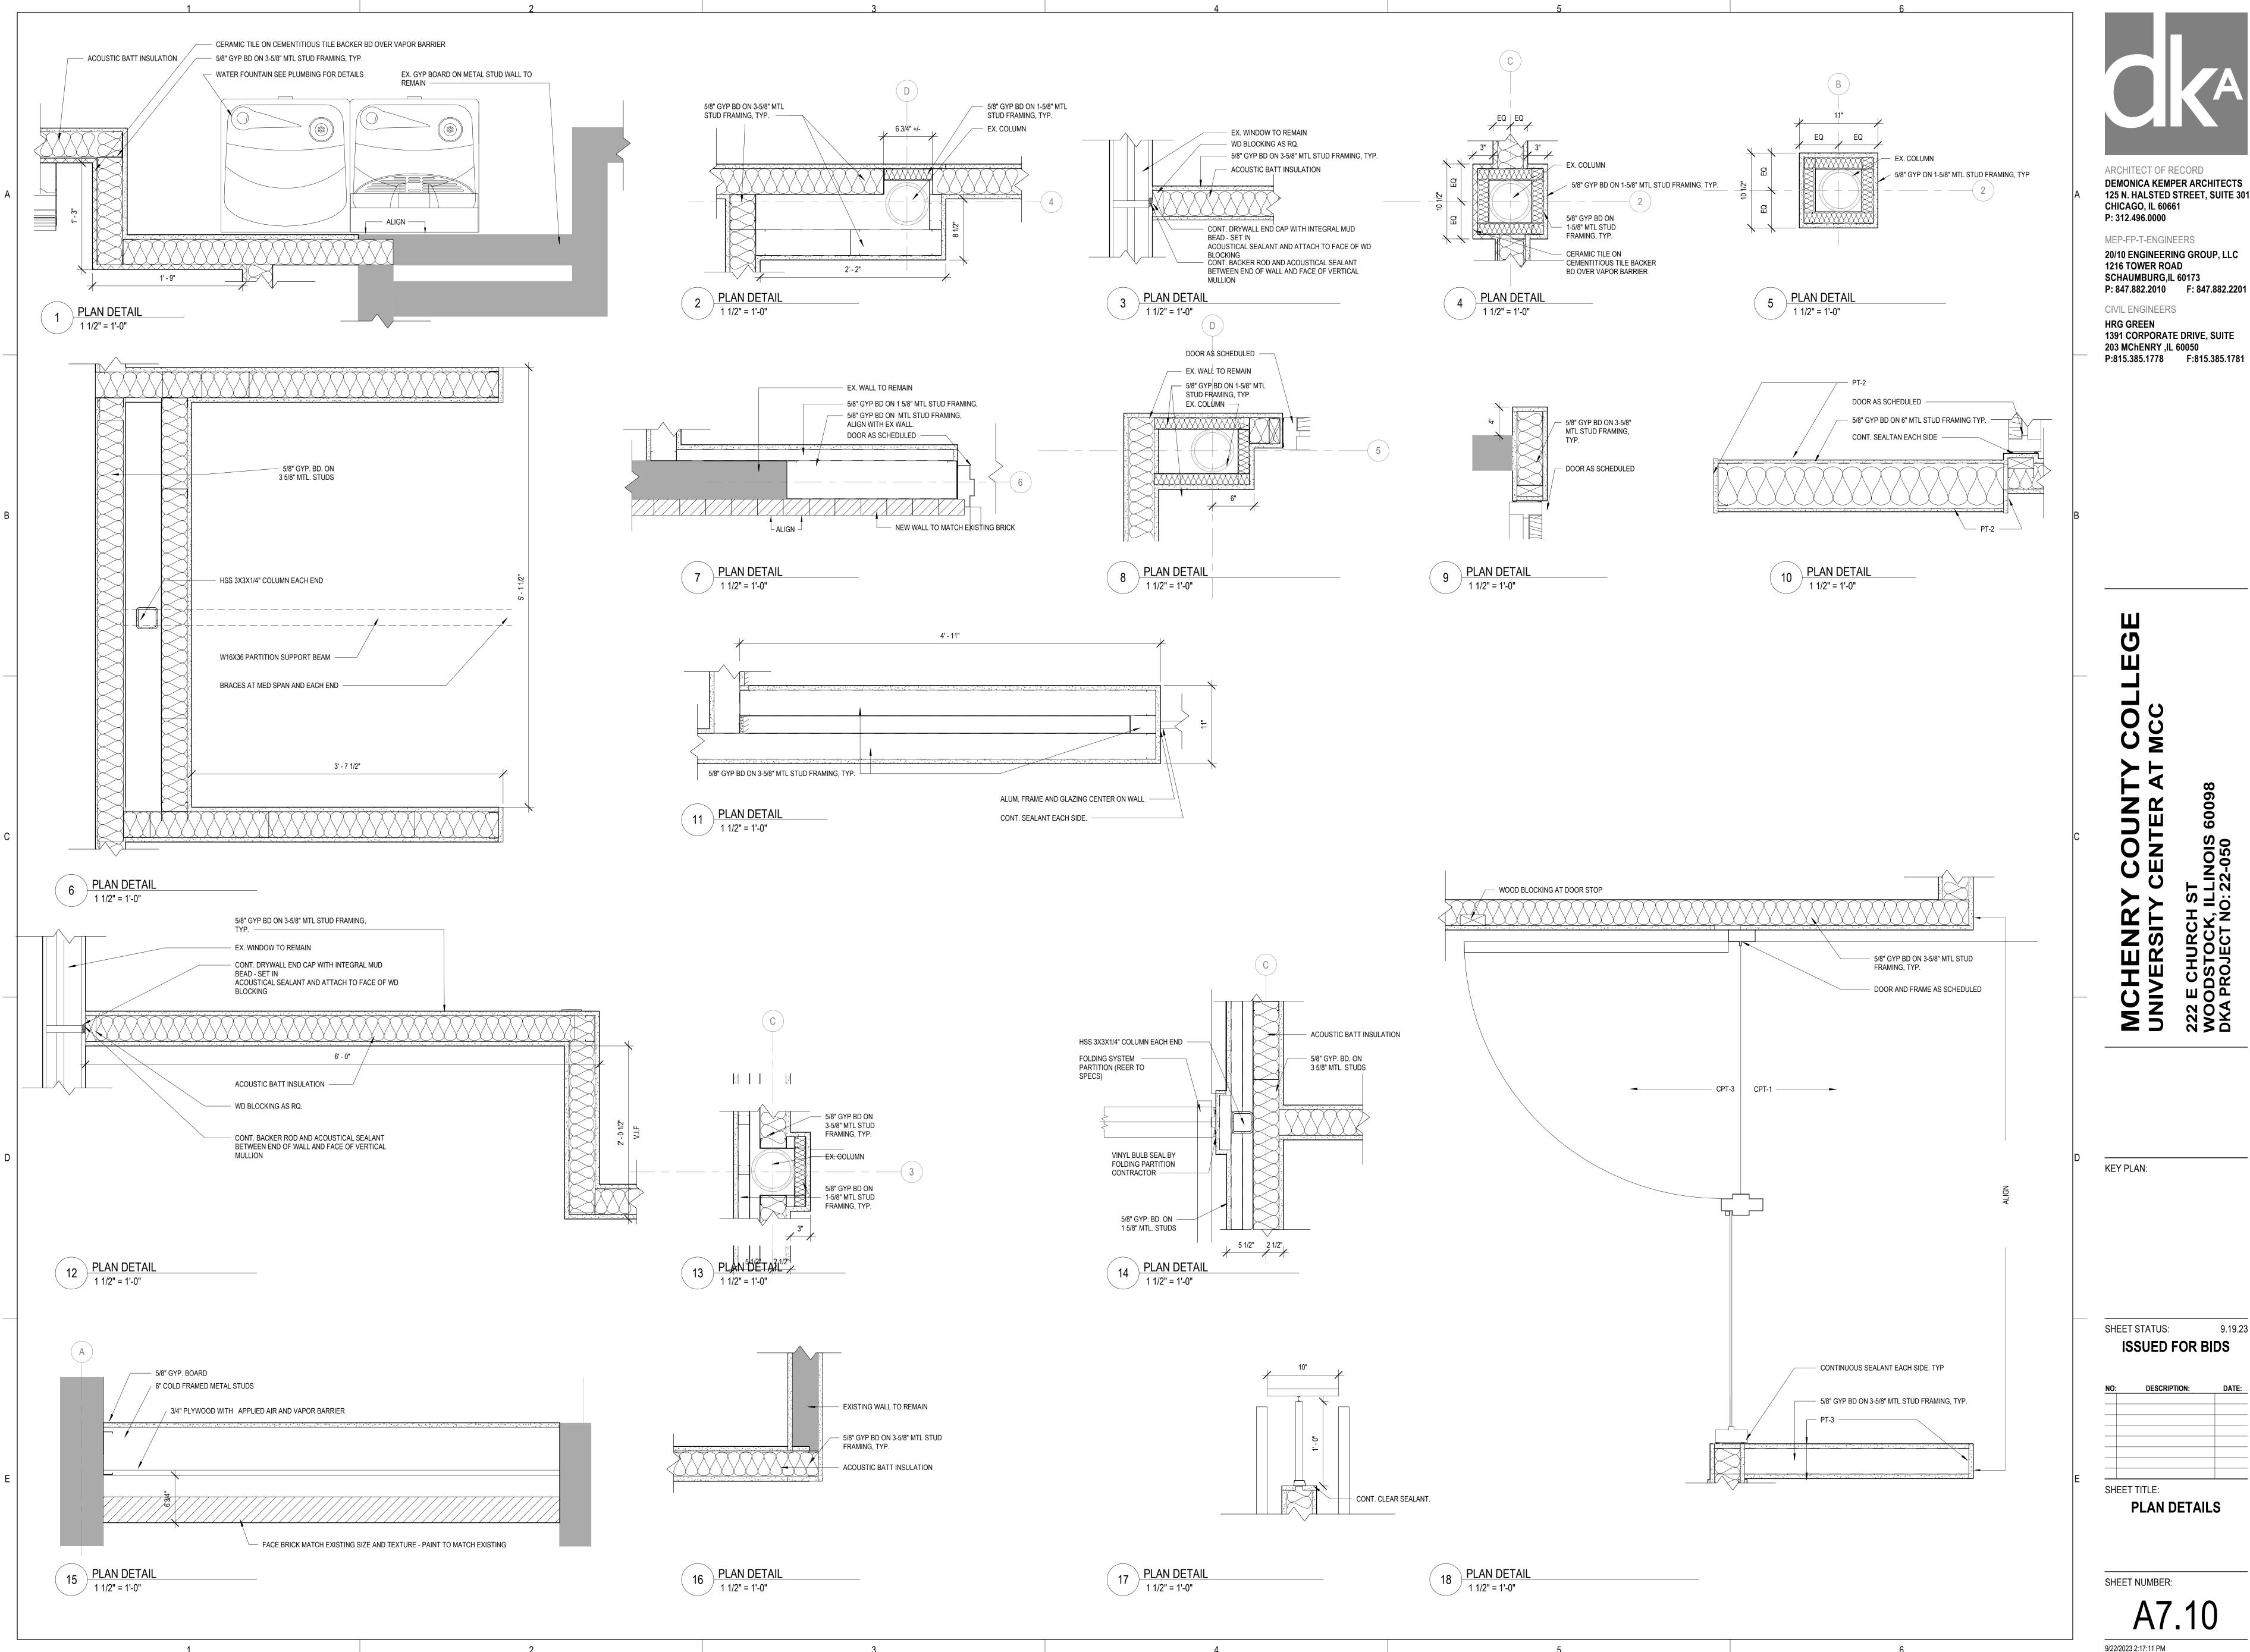
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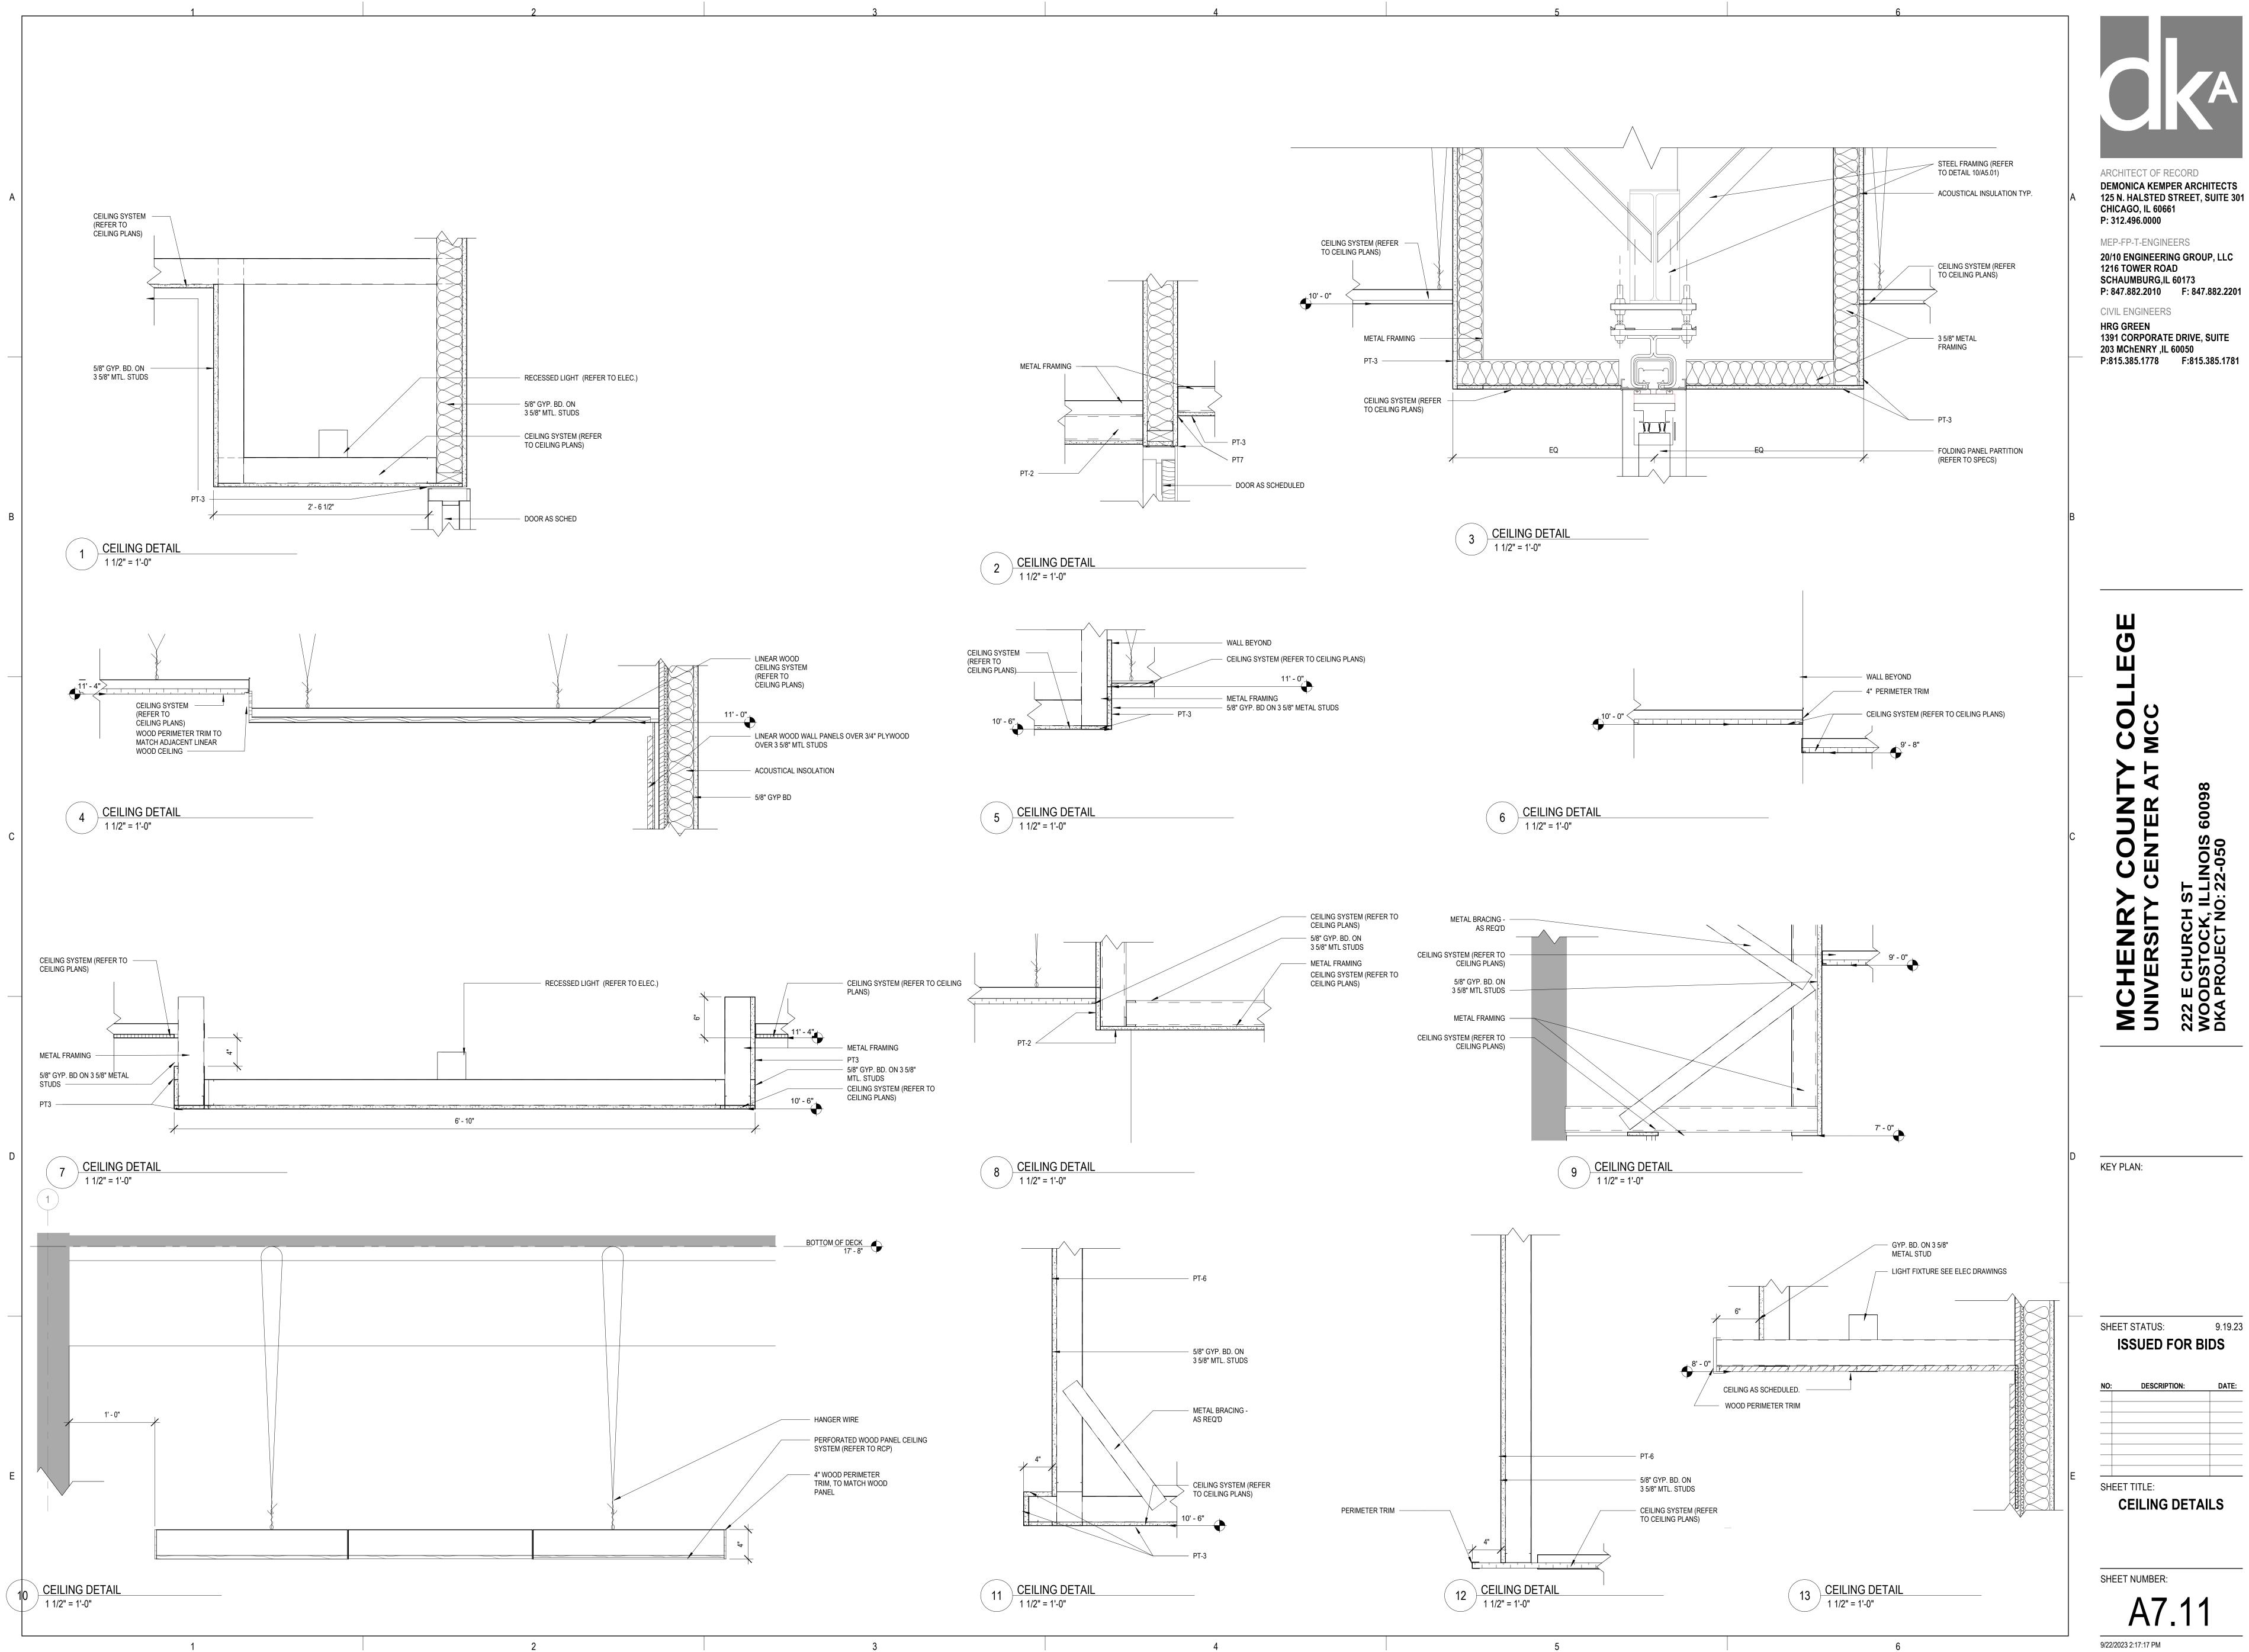
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NO: DESCRIPTION: DATE: SHEET TITLE:

PLAN DETAILS

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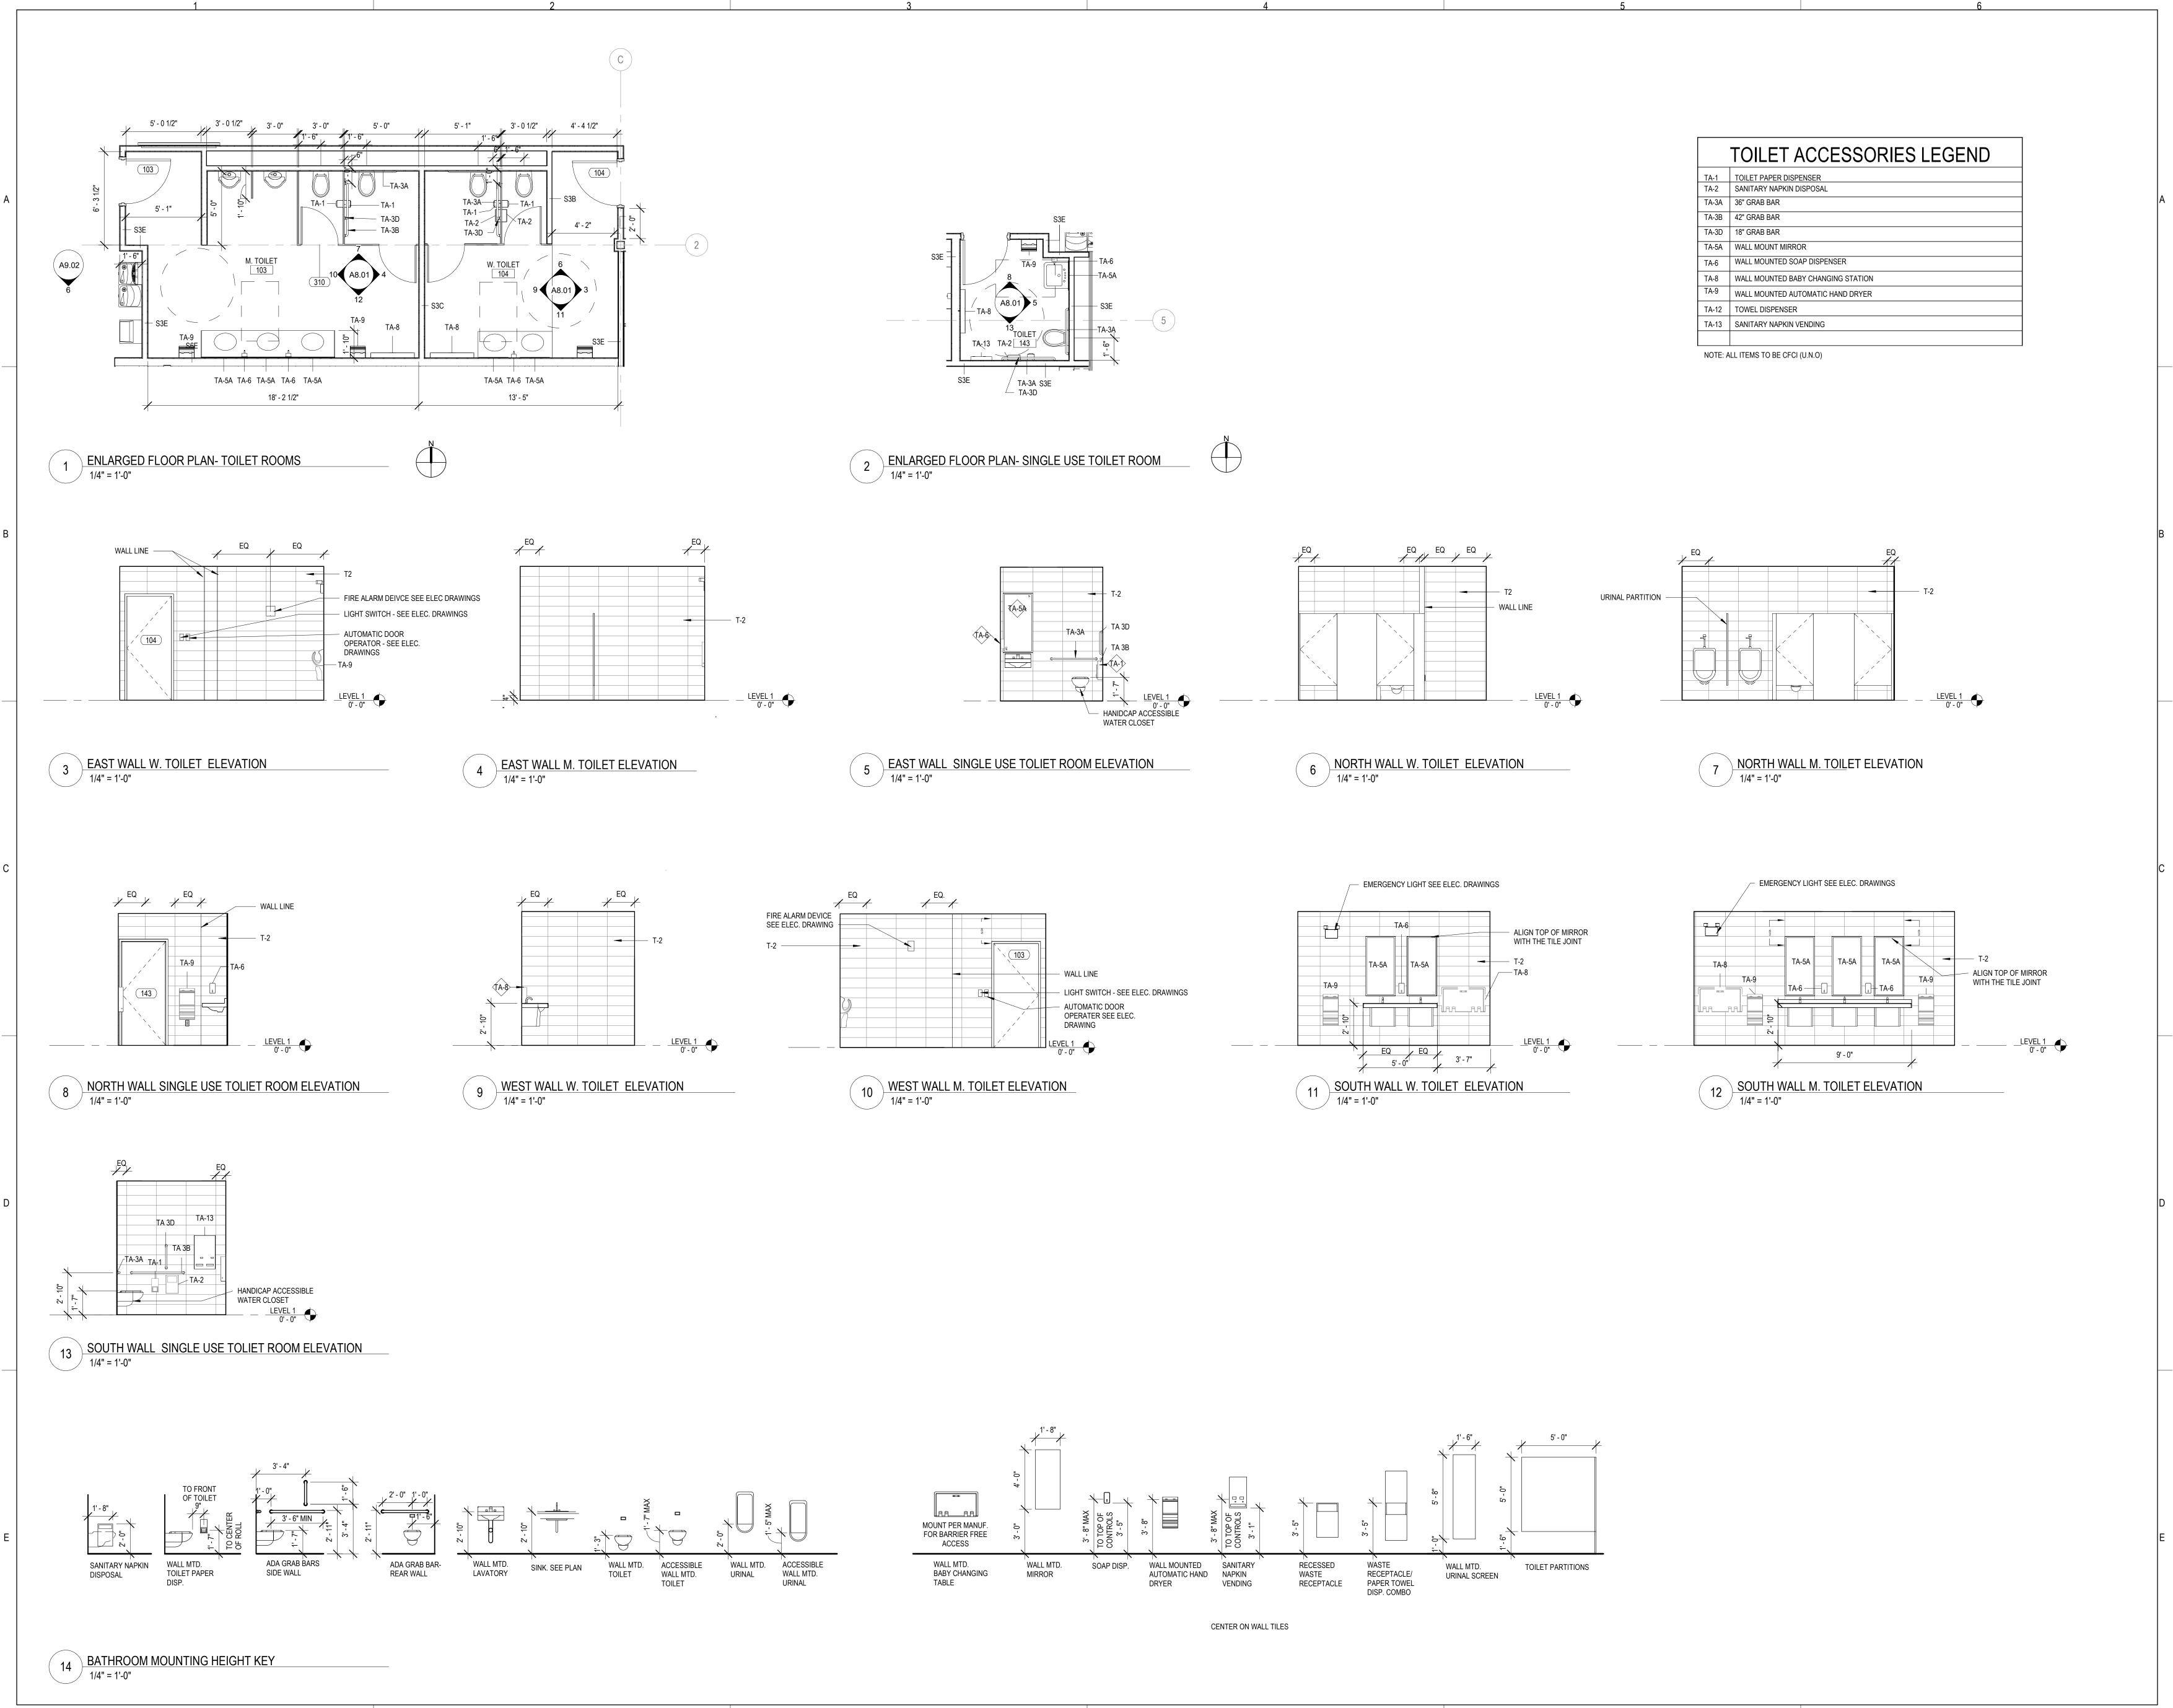
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9.19.23

NO: DESCRIPTION: DATE:



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P: 312.496.0000

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CIVIL ENGINEERS

HRG GREEN 1391 CORPORATE DRIVE, SUITE 203 MChENRY ,IL 60050 P:815.385.1778 F:815.385.1781

Y COUNTY COLLE
Y CENTER AT MCC

KEY PLAN:

SHEET STATUS: 9.19.23
ISSUED FOR BIDS

NO: DESCRIPTION: DATE:


TOILET OOMS-PLANS A

ROOMS-PLANS AND ELEVATIONS

SHEET NUMBER:

A8.0

9/22/2023 2:17:34 PM

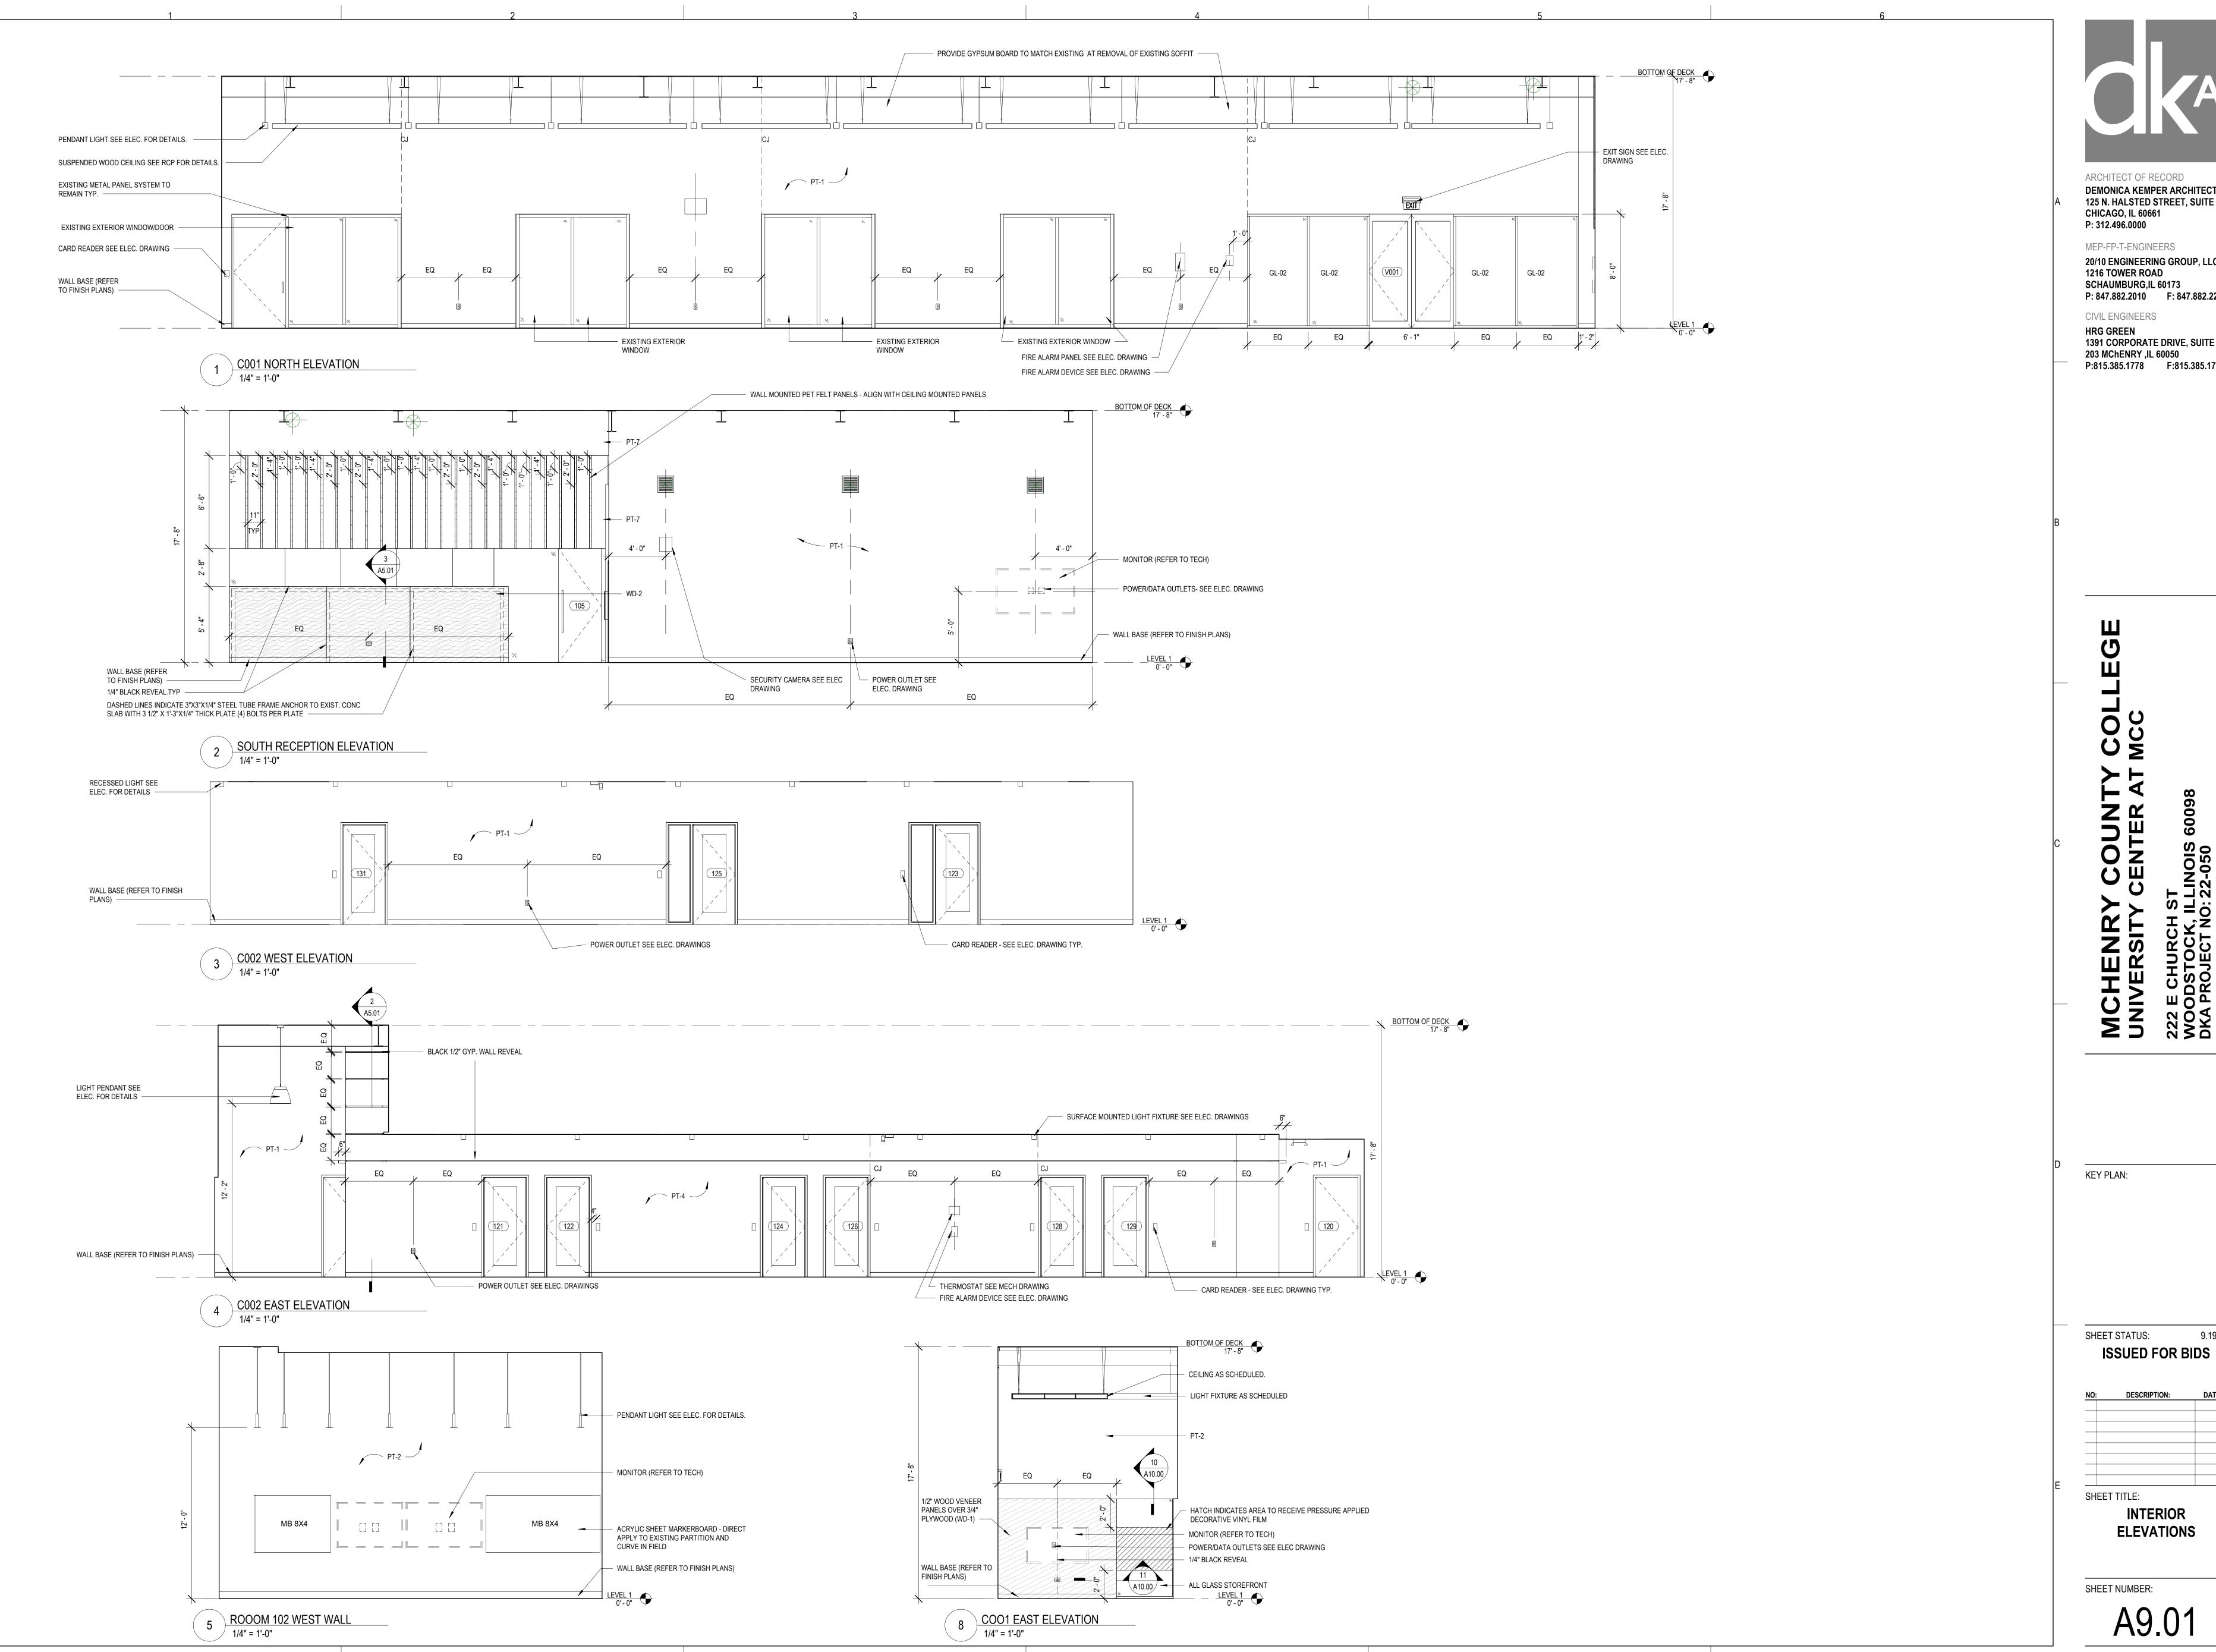

MEP-FP-T-ENGINEERS

20/10 ENGINEERING GROUP, LLC 1216 TOWER ROAD SCHAUMBURG,IL 60173

P: 847.882.2010 F: 847.882.2201 CIVIL ENGINEERS

HRG GREEN 1391 CORPORATE DRIVE, SUITE

203 MChENRY ,IL 60050 P:815.385.1778 F:815.385.1781

9.19.23 SHEET STATUS:


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SHEET TITLE: **INTERIOR**

ELEVATIONS


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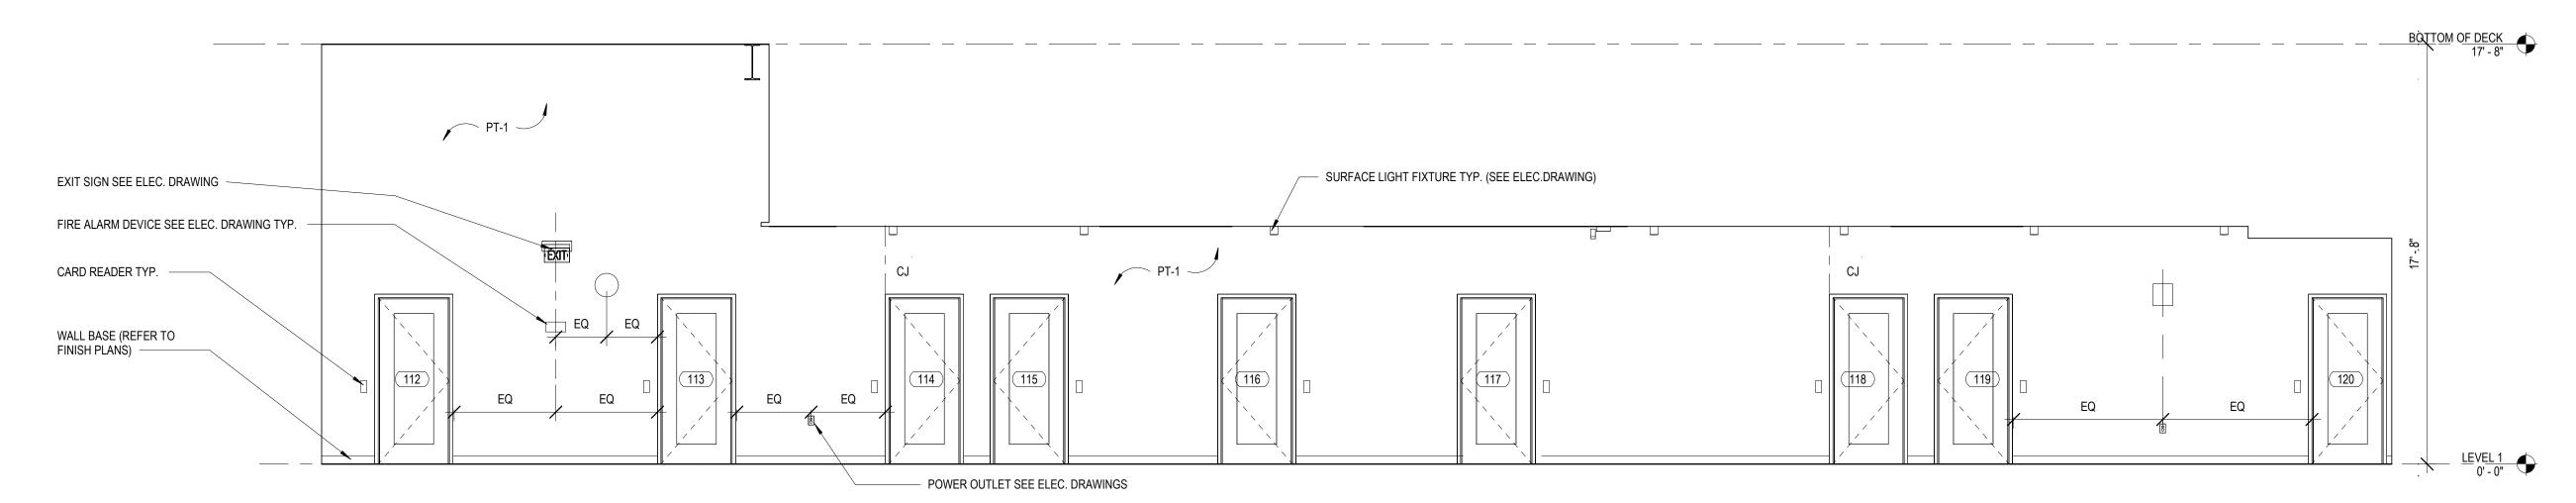
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9.19.23

NO: DESCRIPTION: DATE:



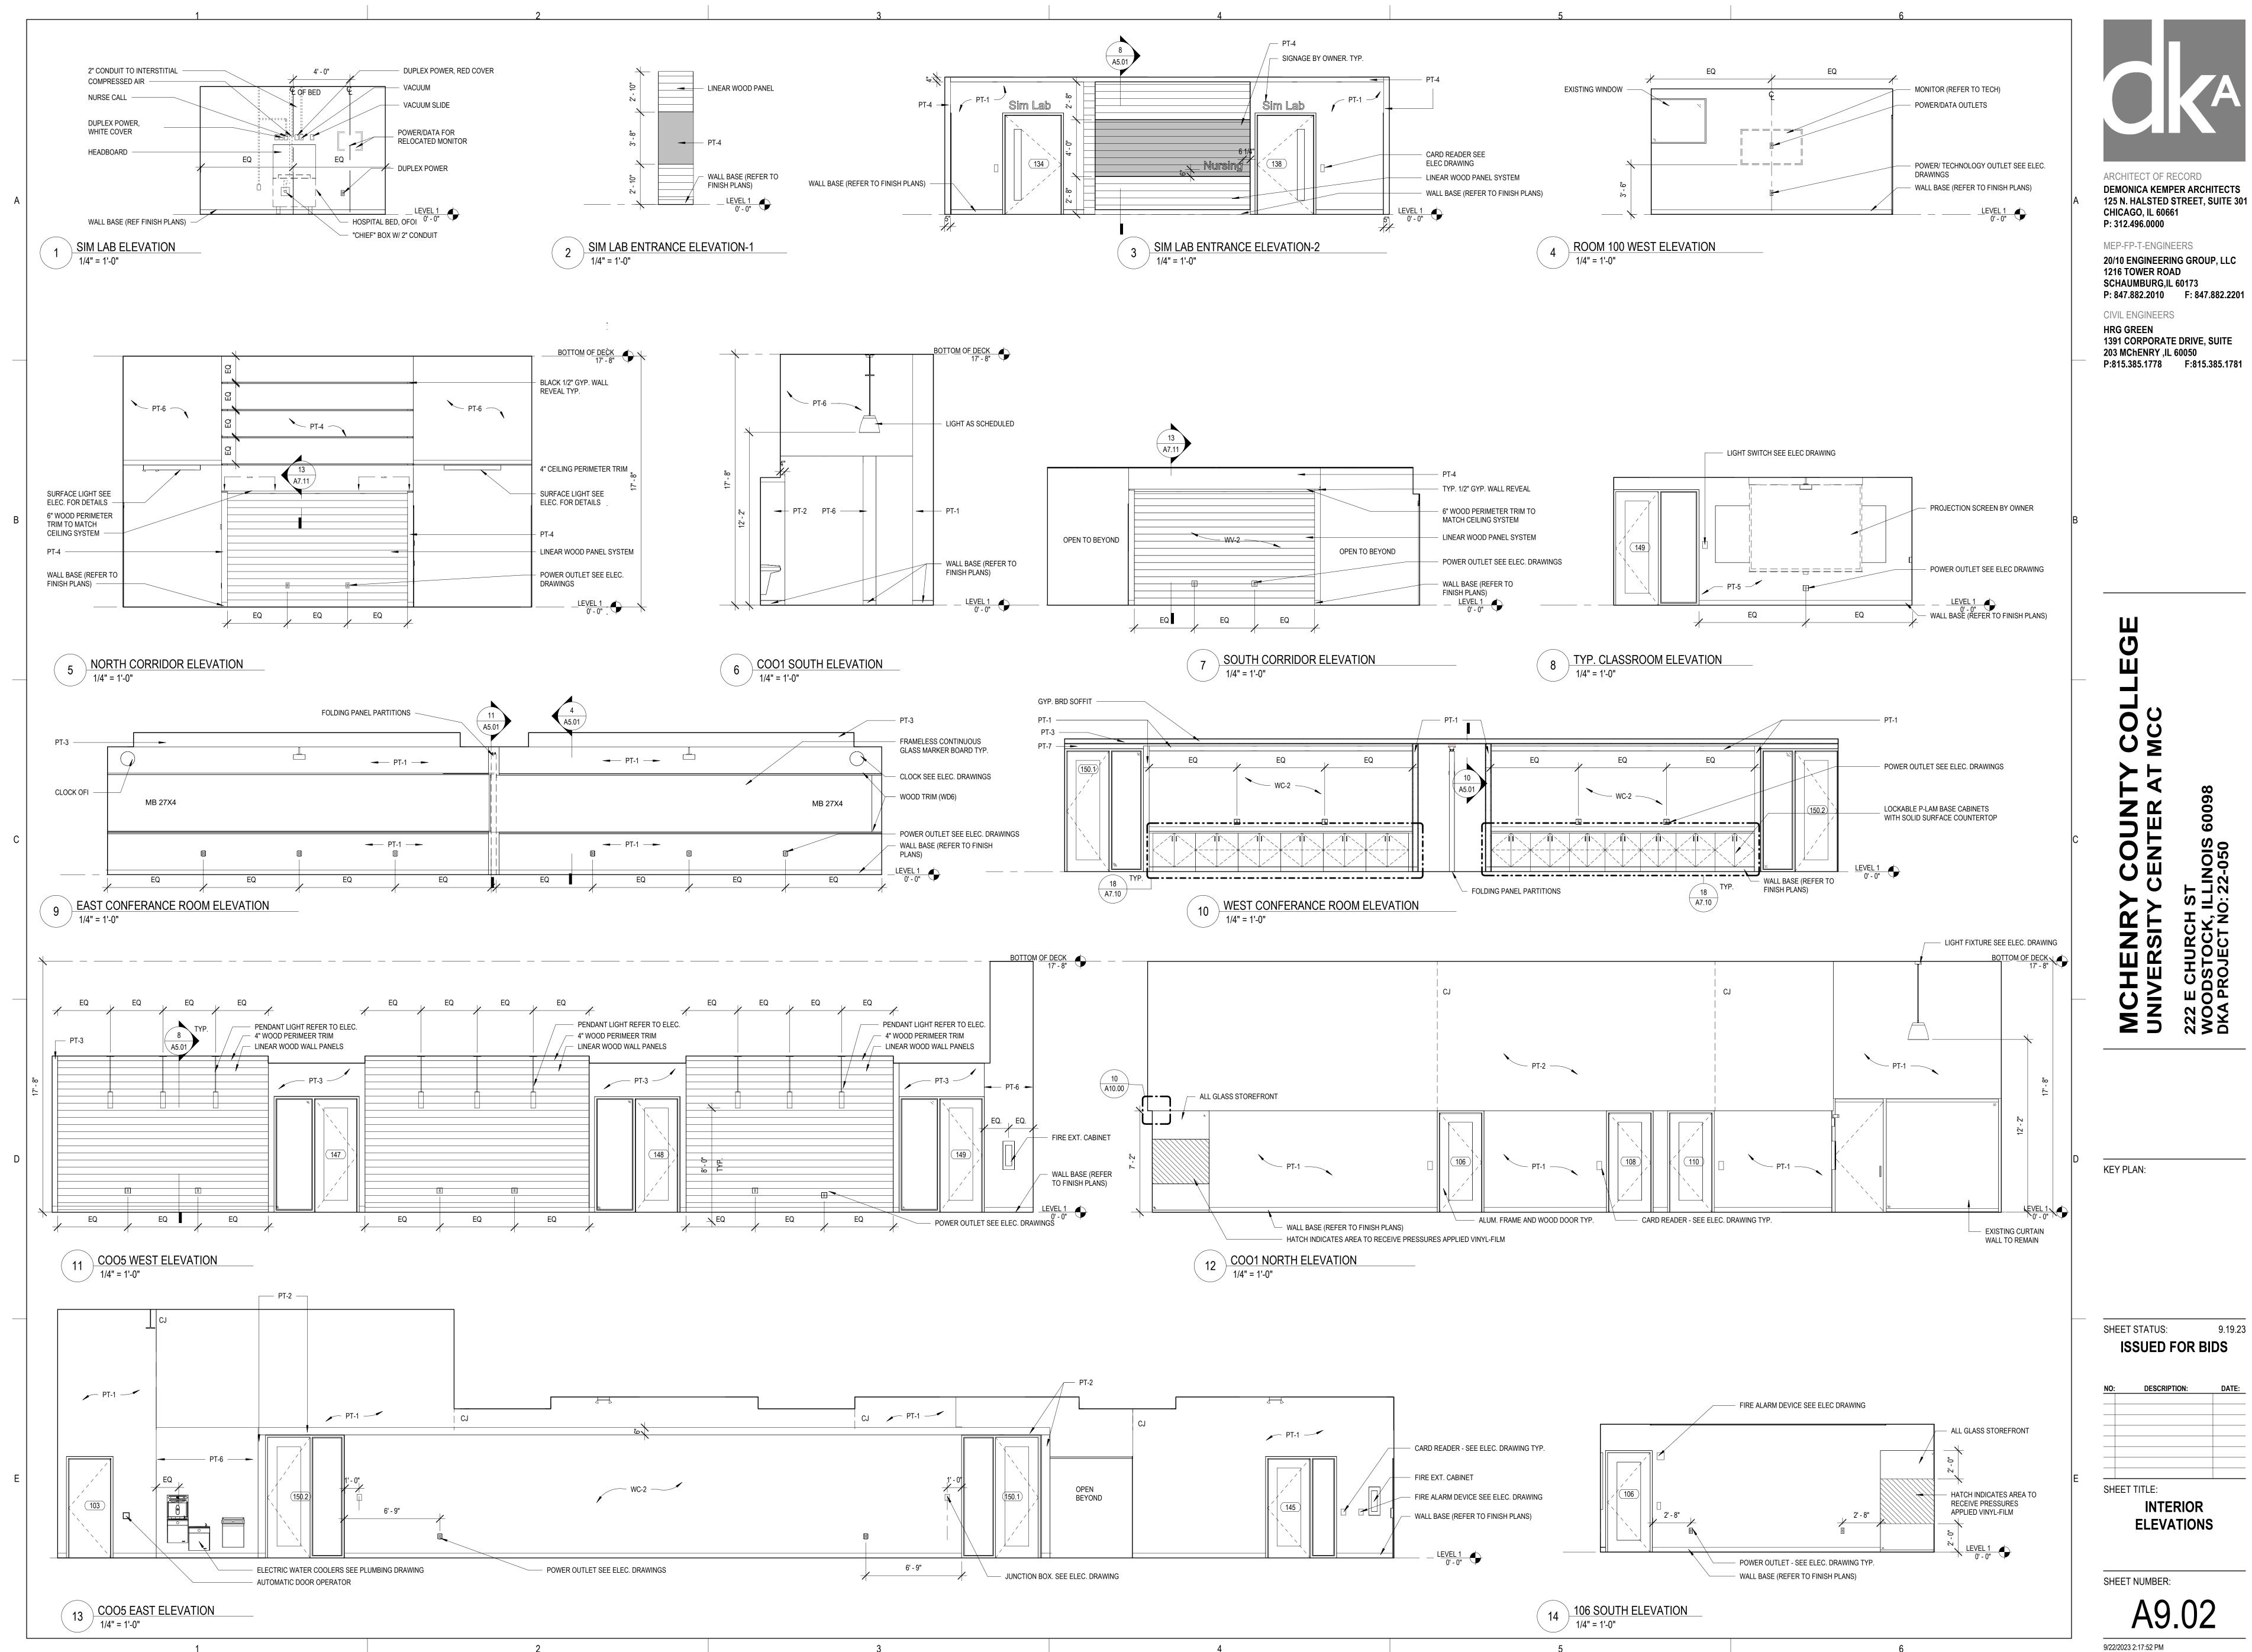

2 C003 EAST ELEVATION! 1/4" = 1'-0"

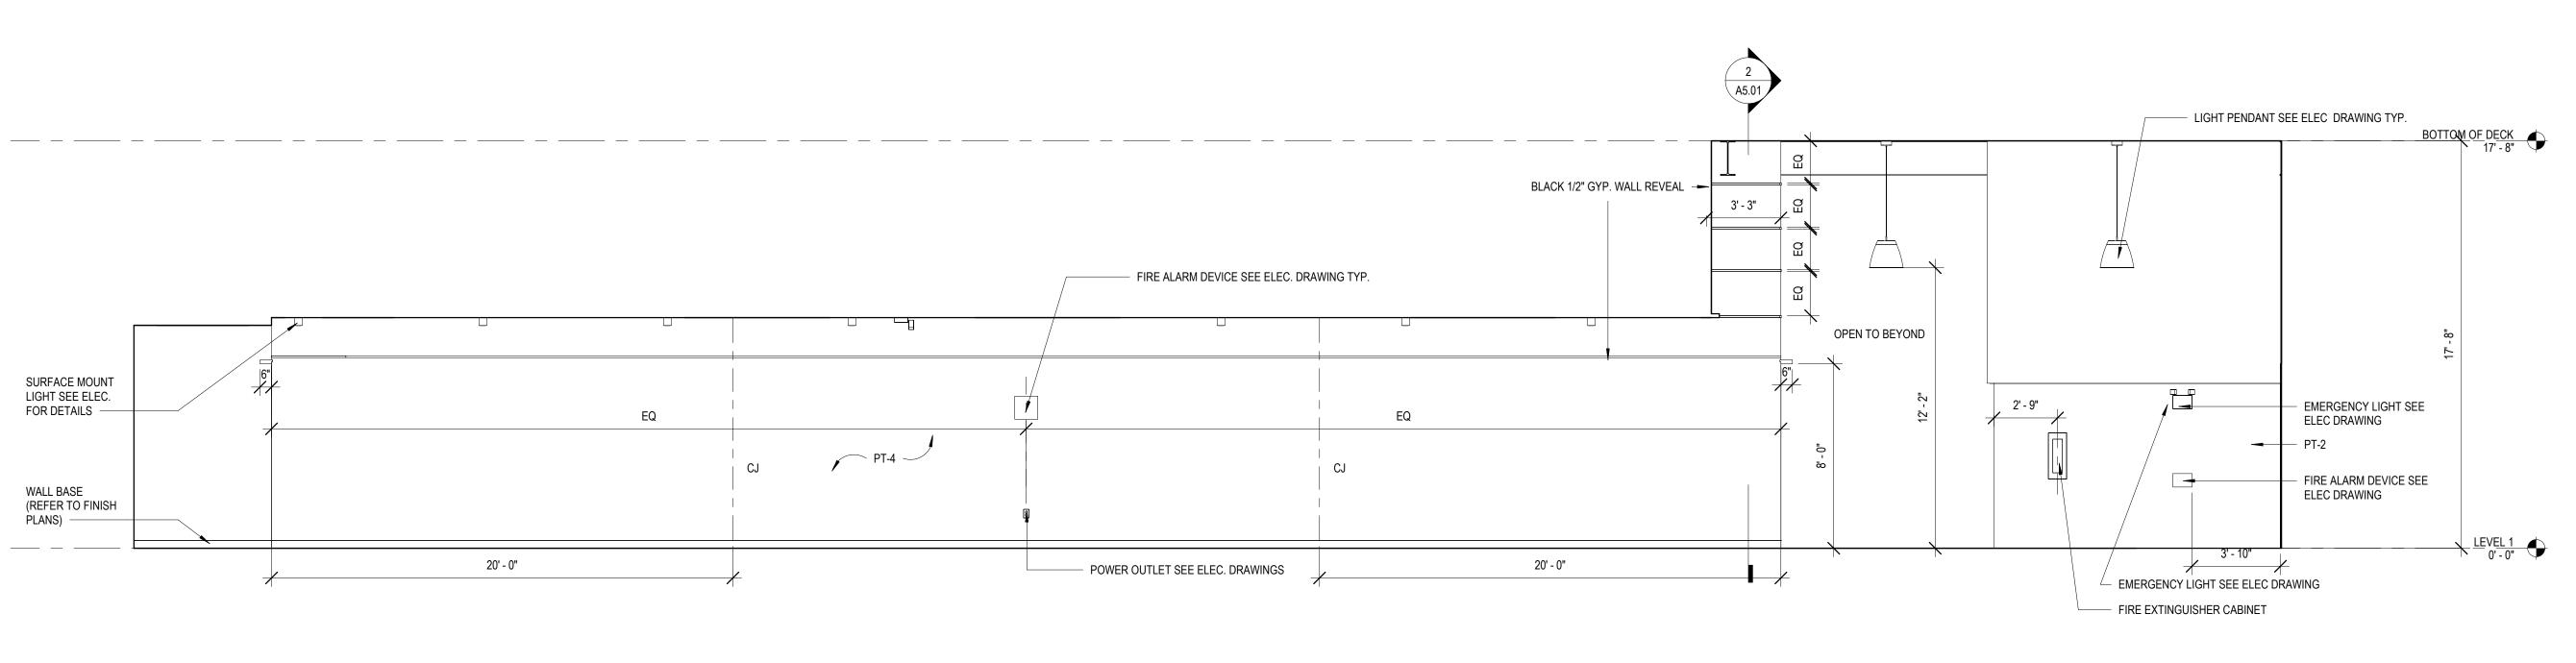ARCHITECT OF RECORD

DEMONICA KEMPER ARCHITECTS
125 N. HALSTED STREET, SUITE 301
CHICAGO, IL 60661
P: 312.496.0000

MEP-FP-T-ENGINEERS

20/10 ENGINEERING GROUP, LLC 1216 TOWER ROAD SCHAUMBURG,IL 60173 P: 847.882.2010 F: 847.882.2201

CIVIL ENGINEERS
HRG GREEN

HRG GREEN
1391 CORPORATE DRIVE, SUITE
203 MChENRY ,IL 60050
P:815.385.1778 F:815.385.1781

MCHENRY COUNTY COLLEGIONIVERSITY CENTER AT MCC

KEY PLAN:

SHEET STATUS: 9.19.23
ISSUED FOR BIDS


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INTERIOR ELEVATIONS

SHEET NUMBER:

A9 0

9/22/2023 2:18:17 PM



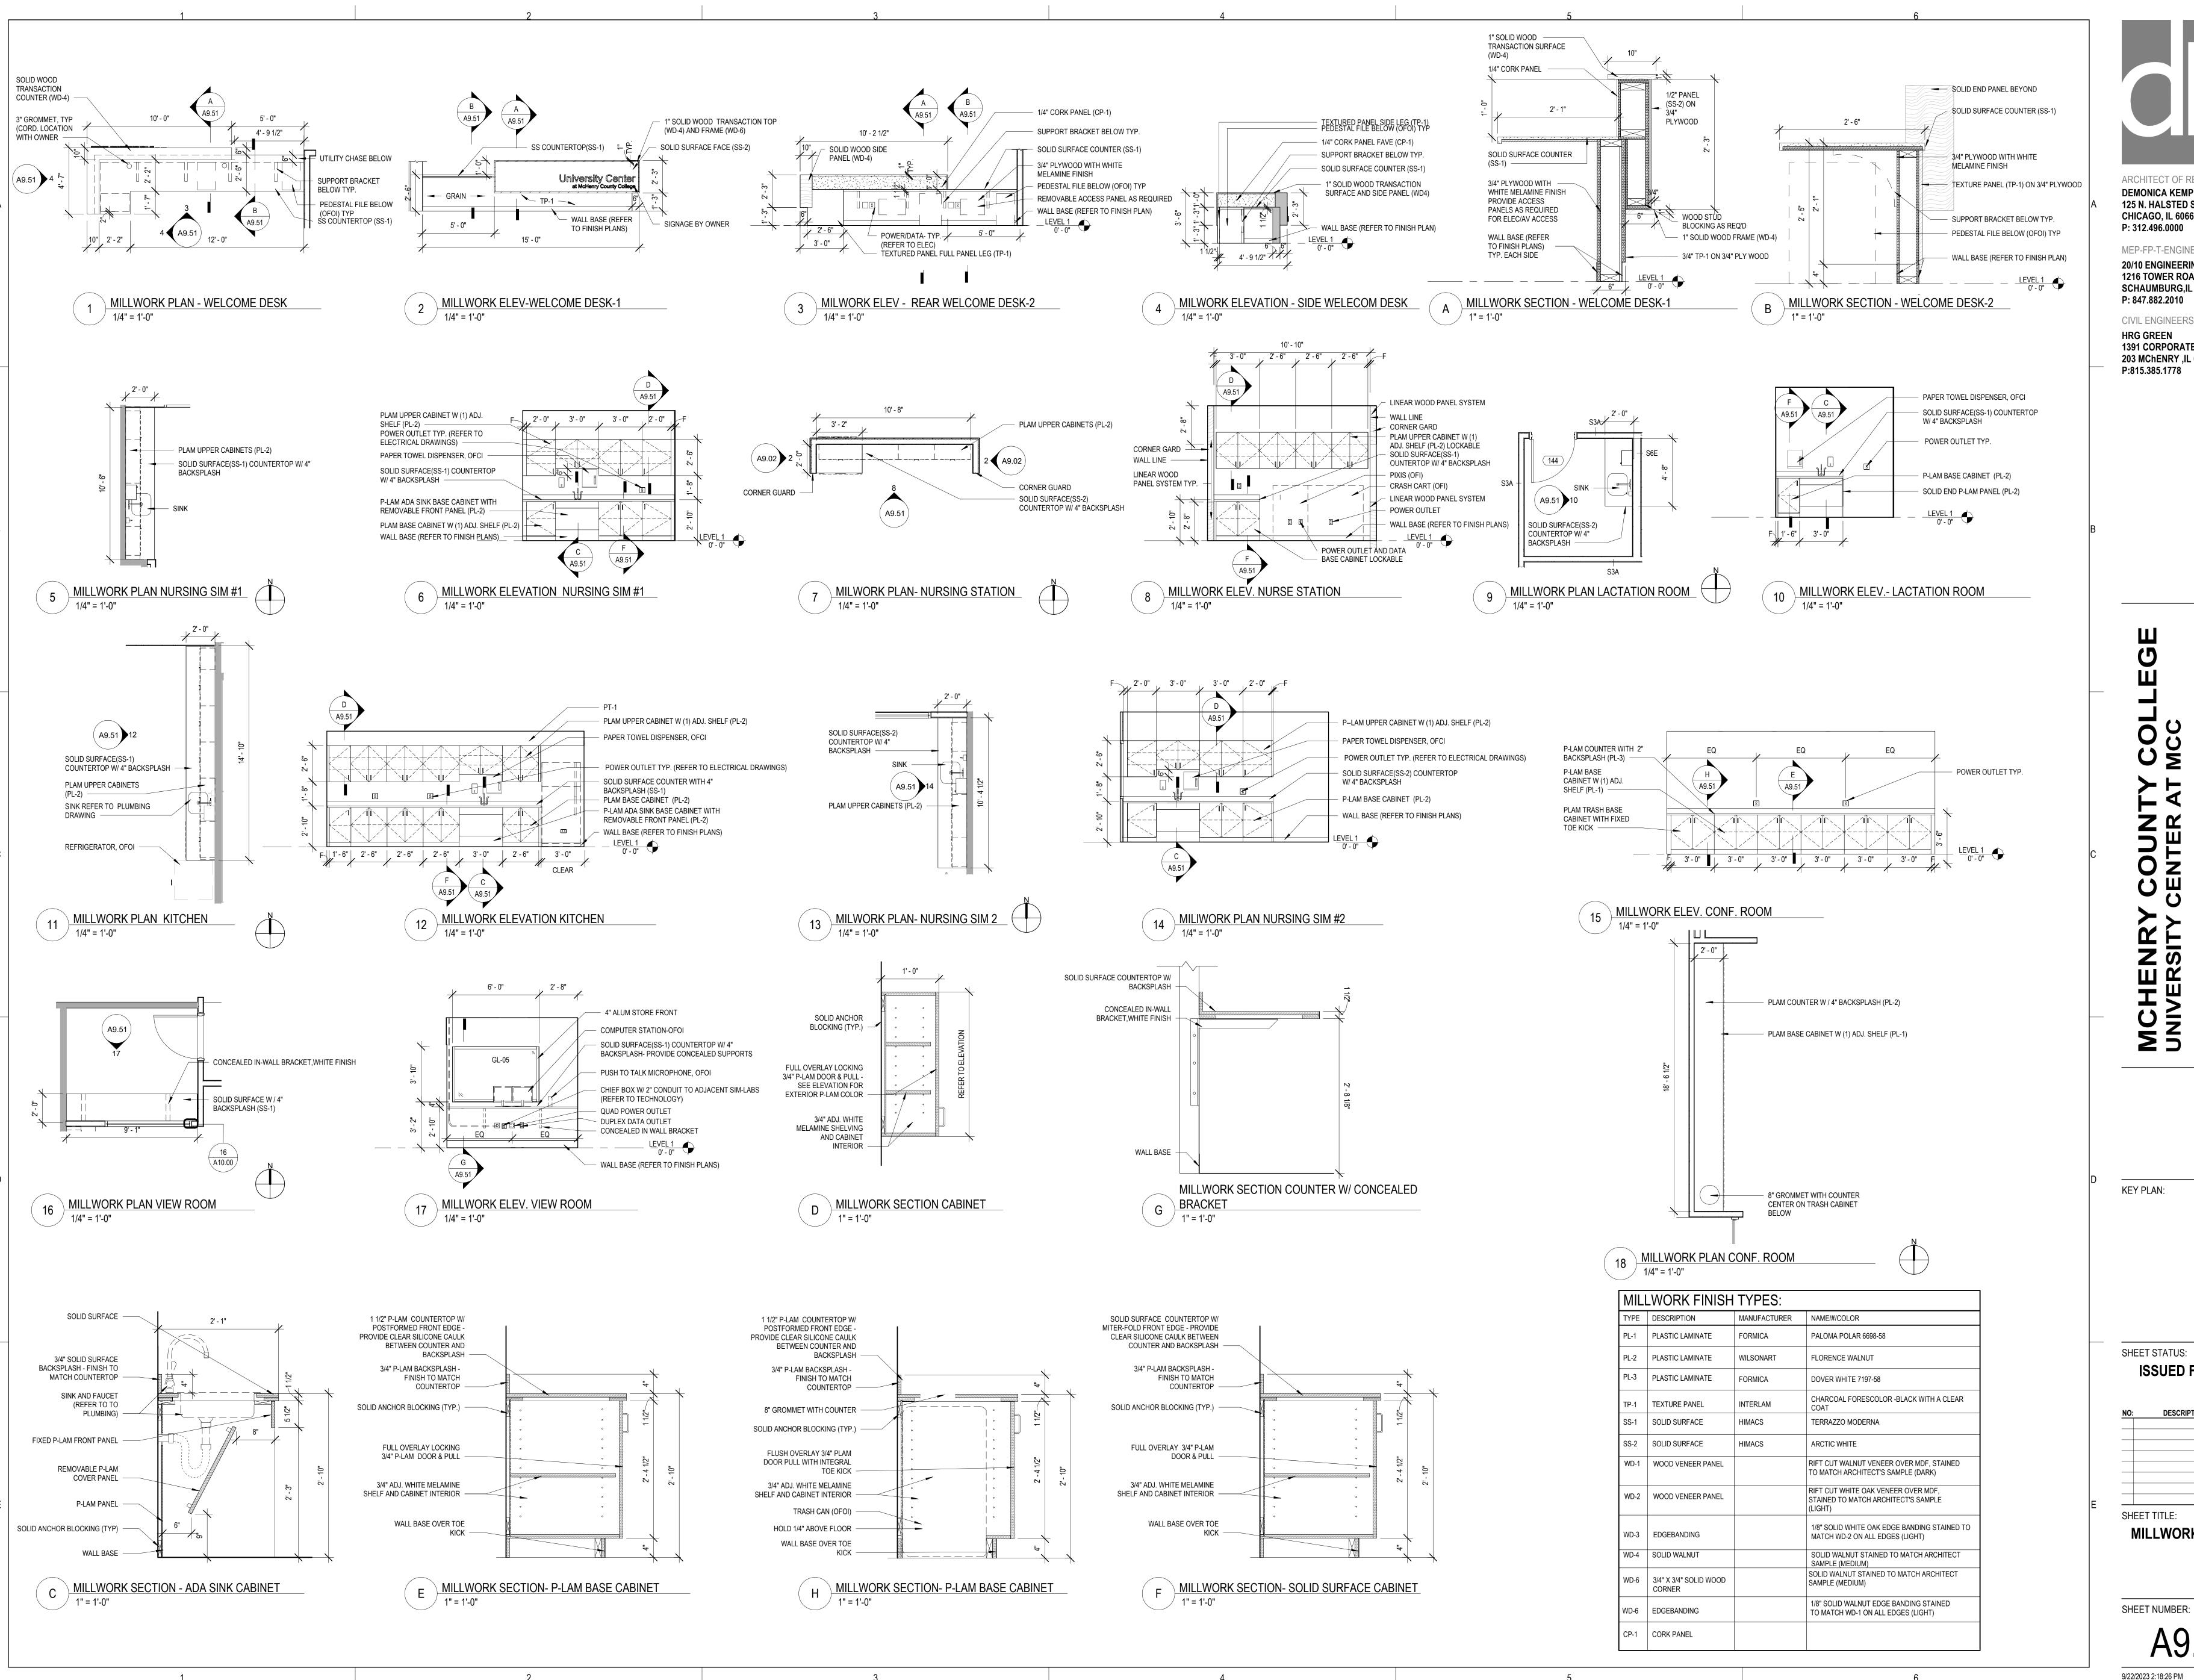

MEP-FP-T-ENGINEERS

20/10 ENGINEERING GROUP, LLC 1216 TOWER ROAD SCHAUMBURG,IL 60173

P: 847.882.2010 F: 847.882.2201 **CIVIL ENGINEERS**

HRG GREEN 1391 CORPORATE DRIVE, SUITE 203 MChENRY ,IL 60050 P:815.385.1778 F:815.385.1781


KEY PLAN:

9.19.23 SHEET STATUS: **ISSUED FOR BIDS**

DESCRIPTION: SHEET TITLE:

MILLWORK DETAILS

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MEP-FP-T-ENGINEERS

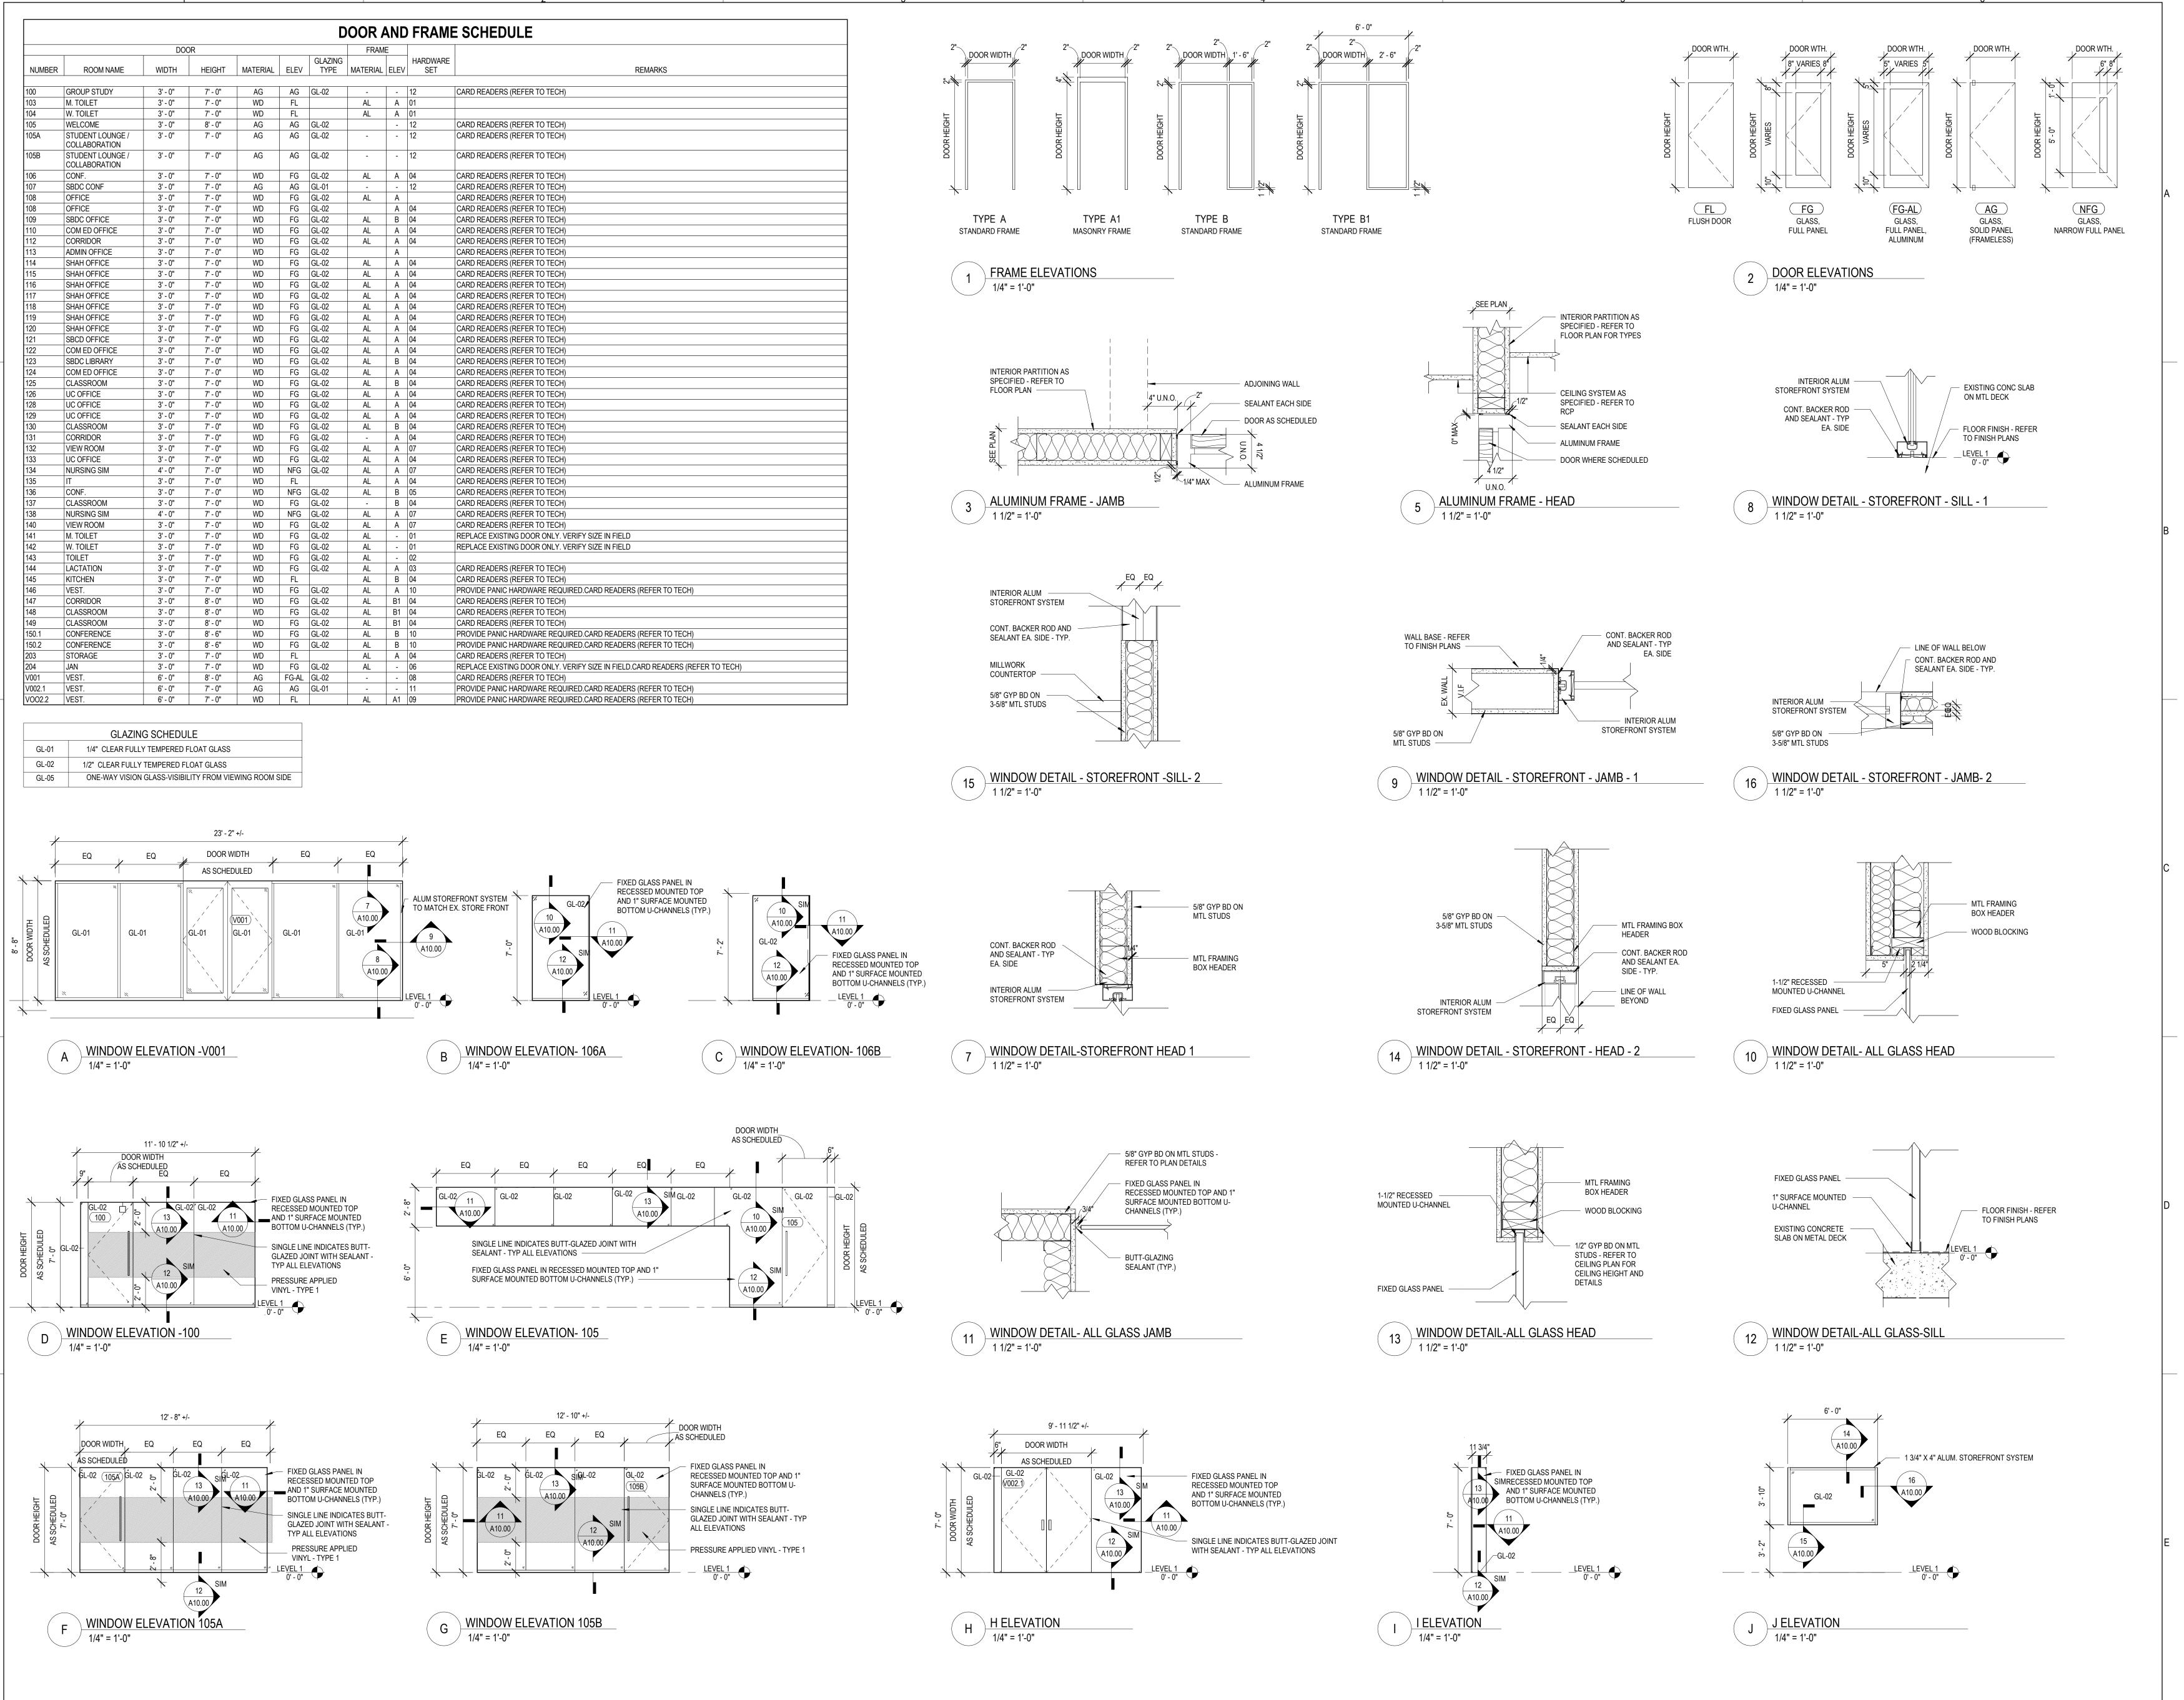P: 312.496.0000

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P: 847.882.2010 F: 847.882.2201

CIVIL ENGINEERS
HRG GREEN

HRG GREEN
1391 CORPORATE DRIVE, SUITE
203 MChENRY ,IL 60050
P:815.385.1778 F:815.385.1781

COUNTY COLL
CENTER AT MCC

KEY PLAN:

SHEET STATUS: 9.19.23

ISSUED FOR BIDS

NO: DESCRIPTION: DATE


DOOR SCEHDULE

ELEVATIONS, AND DETAILS

SHEET NUMBER:

9/22/2023 2:18:55 PM

A10.0

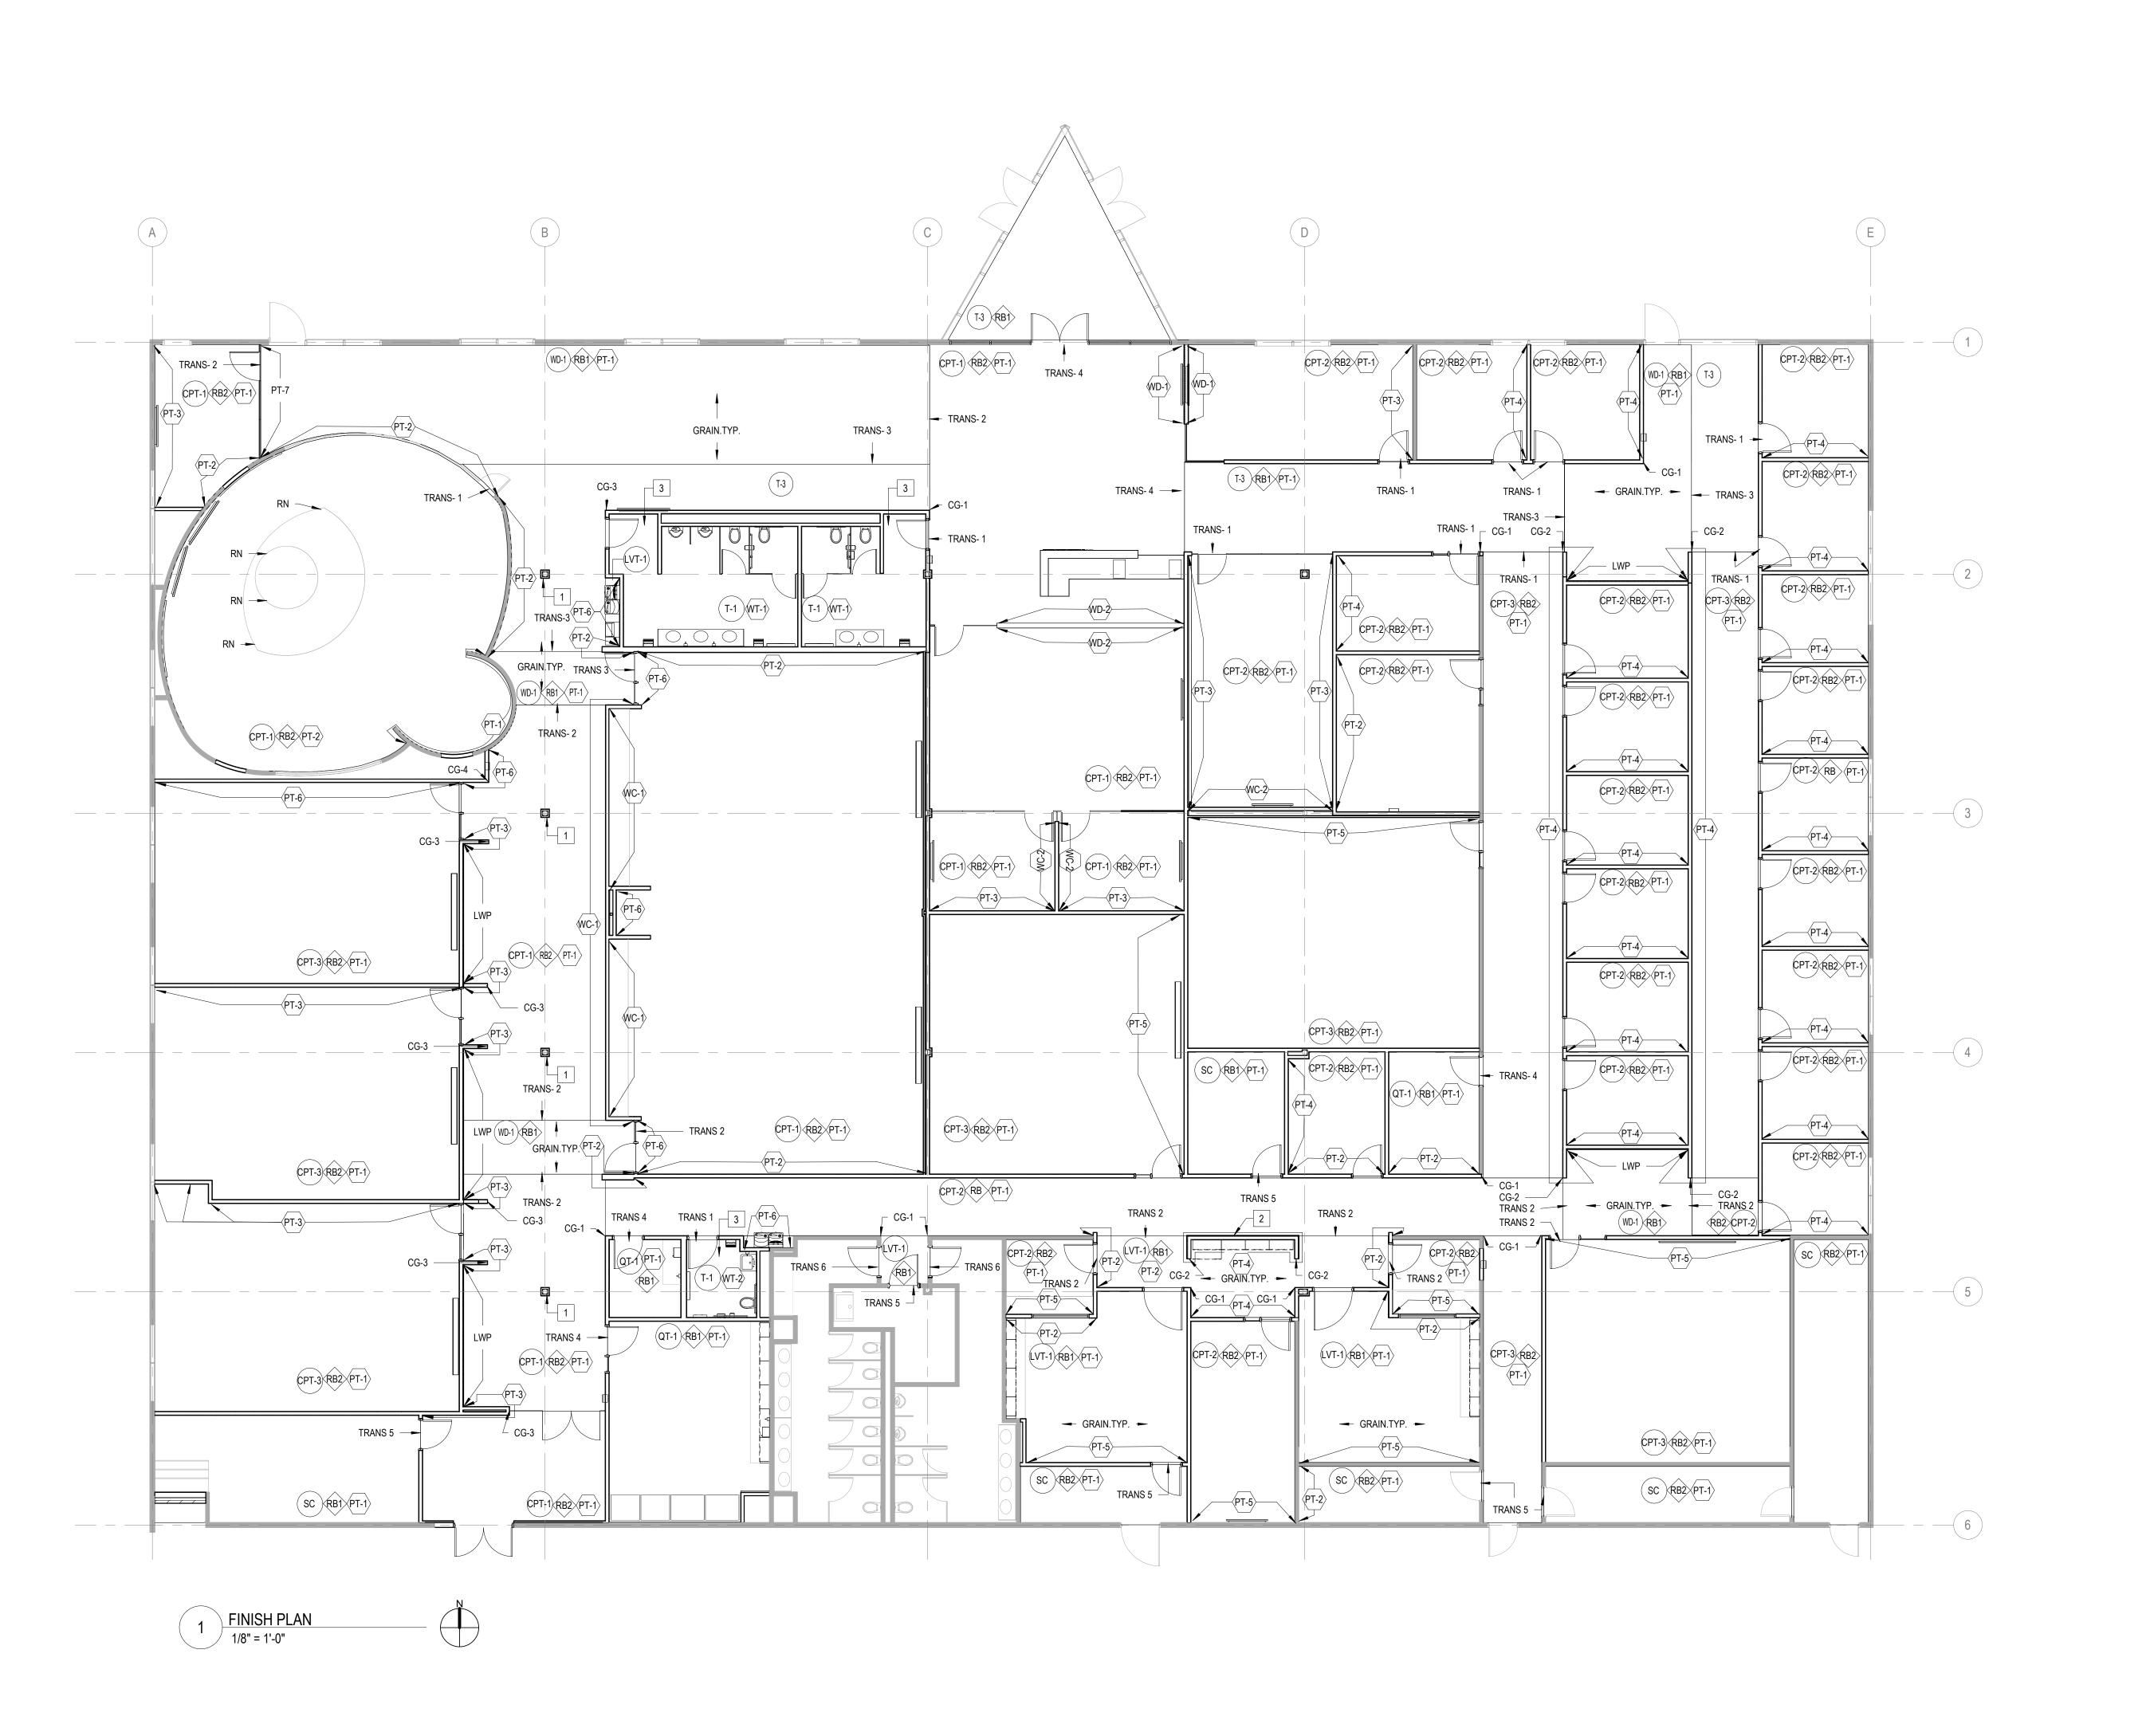

FINISH PLAN SYMBOLS LEGEND:

X WALL FINISH TYPE X WALL BASE TYPE X FLOOR FINISH TYPE

FINISH PLAN GENERAL NOTES:

- PAINT ALL EXPOSED CONDUIT, DUCTWORK, PIPING, ETC. IN ALL FINISHED SPACES. (PT-7) REFER TO INTERIOR FINISH PLANS AND REFLECTED CEILING PLANS FOR CLARIFICATIONS.
- PLANS FOR CLARIFICATIONS.

 2. PAINT ALL EXPOSED METAL ON EXTERIOR INCLUDING, BUT NOT LIMITED TO: CONDUIT, PIPING, FLASHING, MECHANICAL FLUES AND DUCTS, AND HOLLOW
- METAL FRAMES AND DOORS.

 B. PROVIDE CEMENTITIOUS SELF-LEVELING UNDERLAYMENT AT REMOVAL OF EXISTING FLOOR DRAINS AS REQUIRED TO PROVIDE A LEVEL SUBSTRATE FOR
- NEW FLOOR FINISH.

 4. ALL FINISHES ARE MONUMENTAL PER ROOM UNLESS NOTED OTHERWISE.
 HOLLOW METAL DOORS AND FRAMES TO BE PAINTED WV-2 UNLESS NOTED
 OTHERWISE EXISTING HM FRAMES/DOORS WITHIN SCOPE TO BE
 REPAINTED/TOUCHED AS NEEDED WITH PT-8 U.N.O.
- AT ALL LOCATIONS WHERE CASEWORK IS TO BE INSTALLED, THE SUBSEQUENT BASE TYPE SPECIFIED FOR EACH ROOM SHALL BE INSTALLED OVER CASEWORK TOE KICKS UNLESS NOTED OTHERWISE. REFER TO FLOOR PLANS FOR CASEWORK LOCATIONS.
- PAINT ALL GYP. BD. CEILINGS PT-1 UNLESS NOTED OTHERWISE.
 ALL CARPET TILE TO BE INSTALLED QUARTER TURNED UNLESS SPECIFIED OTHERWISE.

WA	ALL FINISH TY	PES:	X
TYPE	DESCRIPTION	MANUFACTURER	NAME/#/COLOR
PT-1	GENERAL PAINT	BENJAMIN MOORE	2176-70 CHALK WHITE
PT-2	ACCENT PAINT	BENJAMIN MOORE	NAVY BLUE
PT-3	ACCENT PAINT	BENJAMIN MOORE	SQUIRREL TAIL: 1476
PT-4	ACCENT PAINT	BENJAMIN MOORE	2108-60- ABALONE
PT-5	ACCENT PAINT	BENJAMIN MOORE	WATERFALL 2050-50
PT-6	ACCENT PAINT	BENJAMIN MOORE	1610- FRENCH BERET
PT-7	ACCENT PAINT	BENJAMIN MOORE	1631 MIDNIGHT OIL
PT-8	ACCENT PAINT	BENJAMIN MOORE	1599 MARINA GRAY
WC-1	VINYL WALLCOVERING	WOLF-GORDON	HOLBORN
WC-2	VINYL WALLCOVERING	MOMENTUM	OCEAN DRIVE CAVALIER
WT-1	PORCELAIN TILE	FLORIDA TILE	SOHO CANVAS WHITE
LWP	LINEAR WOOD PANEL		SEE SPEC
WD-1	WOOD VENEER PANEL		RIFT CUT WALNUT VENEER OVER MDF, STAINED TO MATCI ARCHITECT'S SAMPLE (DARK)
WD-2	WOOD VENEER PANEL		RIFT CUT WHITE OAK VENEER OVER MDF, STAINED TO MATCH ARCHITECT'S SAMPLE (LIGHT)

TYPE	DESCRIPTION	MANUFACTURER	NAME/#/COLO
RB1	4"H COVE RUBBER BASE	JOHNSONITE	63 BURNT UM
RB2	4"H STRAIGHT RUBBER BASE	JOHNSONITE	63 BURNT UN
RN	RUBBER NOSING RCN-XX-A	JOHNSONITE	63 BURNT UN

FL	OOR FINISH TYI	PES:	X
TYPE	DESCRIPTION	MANUFACTURER	NAME/#/COLOR
CPT-1	CARPET TILE	PATCRAFT	10467 SLOPE 00450 POINT INSTALL: MONOLITHIC
CPT-2	CARPET TILE	PATCRAFT	1046 RISE 00500 RATIO INSTALL: STAGGER
CPT-3	CARPET TILE	PATCRAFT	10465 RISE 00450 POINT INSTALL: STAGGER
T-1	PORCELAIN TILE	TBD	TBD
T-3	PORCELAIN TILE	CROSSVILLE	ALASKA
SC	SEALED CONCRETE	SEE SPEC	COLOR:CLEAR
LVT-1	LUXURY VINYL TILE	TBD	TBD
WD-1	WOOD FLOOR	TBD	TBD
QT-1	QUARTZ TILE	UPOFLOOR	MOSAIC CONGLOMERATE GREY

FLC	OR TRANSITION	TYPES:	TRANS-X —
TYPE	DESCRIPTION	MANUFACTURER	NAME/#/COLOR
TRANS-1	TILE TO CARPET OR ½" TO ¼"	JOHNSONITE	JOHNSONITE SUBFLOOR LEVELER TO BRING ADJACE SURFACES FLUSH AND PROVIDE SCHLUTER SCHEIN BETWEEN FLOOR TYPES.
TRANS-2	CARPET TO WOOD OR ¼" TO ½"	JOHNSONITE	JOHNSONITE SUBFLOOR LEVELER TO BRING ADJACE SURFACES FLUSH AND PRO SCHLUTER SCHEINE BETWE FLOOR TYPES.
TRANS-3	WOOD TO TILE OR ½" TO ½"	SCHLUTER	SCHLUTER SCHEINE
TRANS-4	CARPET TO QUARTZ TILE OR 1/4" TO 1/8"	TARKETT JOHNSONITE	SLIM LINE TRANSITION SLT-XX-A
TRANS-5	CARPET OR LVT TO SEALED CONCRETE OR 1/4" TO 0"	TARKETT JOHNSONITE	SLIM LINE TRANSITION SLT-XX-L
TRANS-6	LVT TO EXISTING TILE OR ½" TO ¼" REDUCER	TARKETT JOHNSONITE	TARKETT JOHNSONITE REDUCER CRS-XX-A

TYPE	MANUFACTURER	NAME/#/COLOR
CG-1	INPRO	3/4" X 3/4" ADHESIVE MOUNTED, 4'H, COLOR: DESIGNER WHITE 101
CG-2	INPRO	3/4" X 3/4" ADHESIVE MOUNTED, 4'H, COLOR: TAUPE 0113
CG-3	INPRO	3/4" X 3/4" ADHESIVE MOUNTED, 4'H, COLOR: MONSOON 0378
CG-4	INPRO	3/4" X 3/4" ADHESIVE MOUNTED, 4'H, COLOR: CASTLE 0256

FINISH PLAN REFERENCED NOTES: X

 PAINT COLUMN WITH PT-6 AND RB BASE.
 REFER TO INTERIOR ELEVATIONS FOR EXTENT OF LWP
 PROVIDE SCHLUTER DILEX-AHK AT ALL TILE FLOOR PERIMETER BETWEEN FLOOR AND WALL TILE AND VERTICAL INSIDE TILE CORNERS. PROVIDE SCHLUTER JOLLY AT ALL OUTSIDE TILE CORNERS

ARCHITECT OF RECORD

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MEP-FP-T-ENGINEERS

20/10 ENGINEERING GROUP, LLC 1216 TOWER ROAD SCHAUMBURG,IL 60173

P: 847.882.2010 F: 847.882.2201
CIVIL ENGINEERS


HRG GREEN
1391 CORPORATE DRIVE, SUITE
203 MChENRY ,IL 60050
P:815.385.1778 F:815.385.1781

WOOD VENEER PANEL

22 E CHURCH ST 700DSTOCK, ILLINOIS 60098 KA PROJECT NO: 22-050

KEY PLAN:


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FINISH PLAN
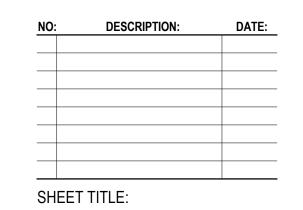
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MCHENRY COUNTY COLLE

KEY PLAN:

SHEET STATUS: 9.19.23

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NO: DESCRIPTION: DATE:

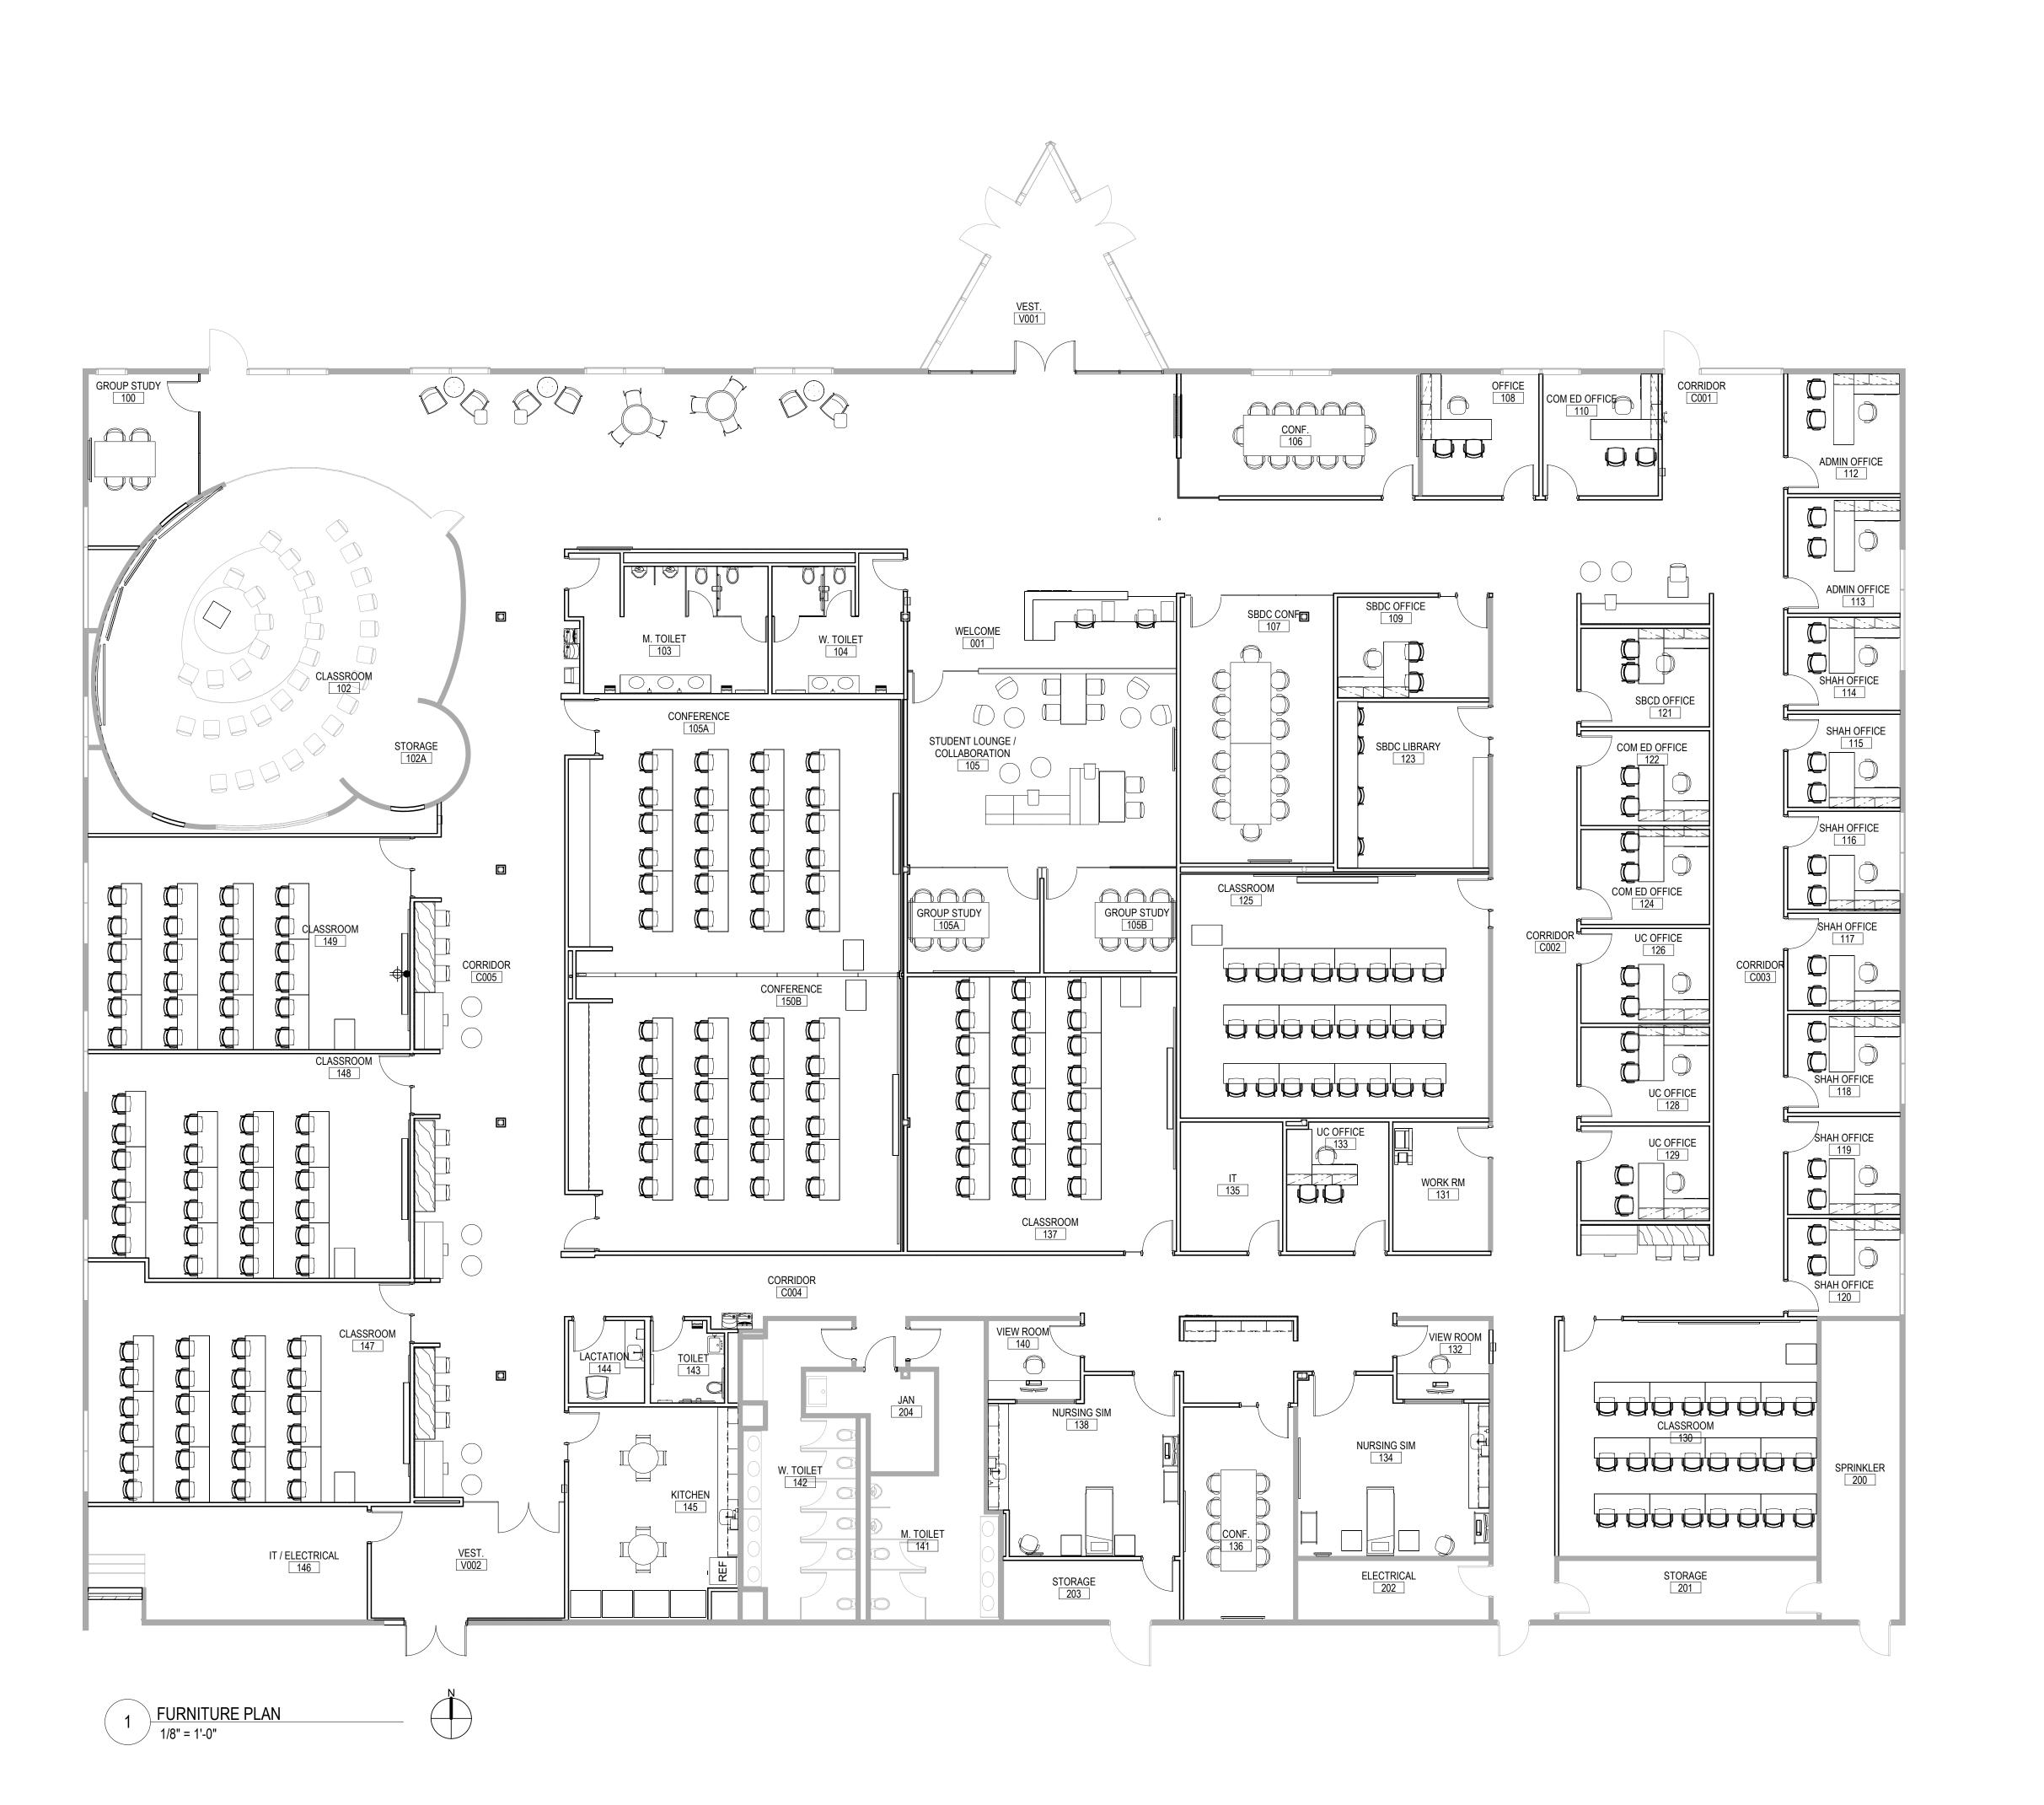SHEET TITLE:

FURNITURE PLAN (FOR REFERENCE ONLY)


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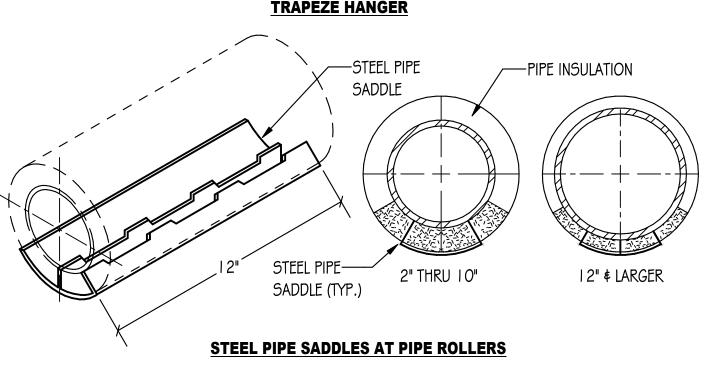
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A12.01

CLEV	IS HANGER	1
PIPE INSULATI	ON SHIELD	SCHEDULE
PIPE SIZE	LENGTH	GAUGE
UP TO 3/4"	8"	20 GA.
l" - 2"	12"	18 GA.
2 1/2" - 4"	12"	16 GA.
5" \$ 6"	18"	16 GA.
8" \$ UP	24"	14 GA.

NOTE: I. CONFER WITH ARCHITECT AND REFER TO STRUCTURAL DRAWINGS FOR ADDITIONAL INFORMATION ON ACCEPTABLE METHODS AND LOCATIONS FOR HANGER SUPPORTS



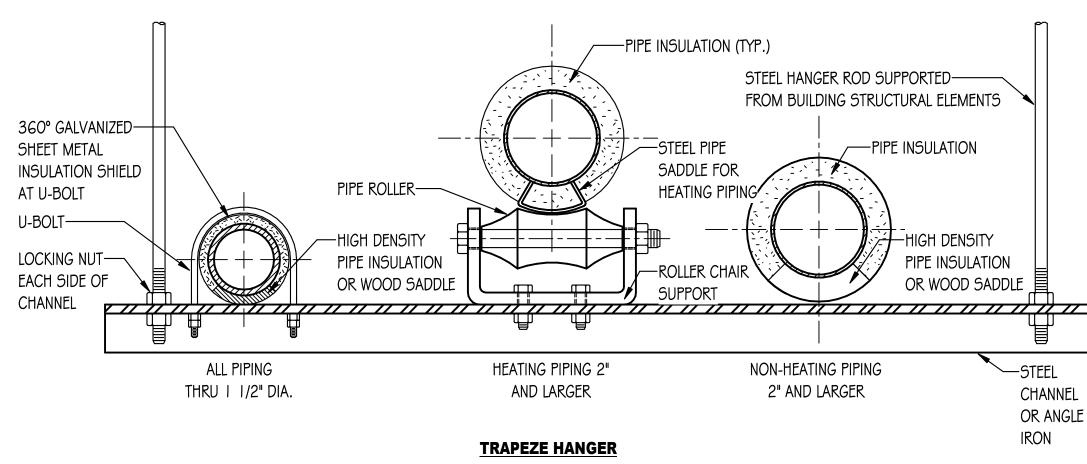

TYPICAL PIPE HANGER DETAILS

GENERAL REMODELING NOTES - ALL CONTRACTORS

LEGEND

SIZE OF

LETTERS

1/2"

3/4"

1 1/4"

2 1/2"

3 1/2"

COLOR

WHITE

WHITE

BLACK

BLACK

BLACK

BLACK

WHITE

WHITE

WHITE

WHITE

WHITE

WHITE

WHITE

GREEN

WHITE

IDENTIFICATION MARKERS OR STRIPS TO BE PLACED ON ALL EXPOSED COVERED AND

AT BOTH SIDES OF WALL/FLOOR PENETRATIONS. ARROWS OF SAME COLOR AS

MARKER INDICATING DIRECTION OF FLOW.

OUTSIDE DIAMETER

OF PIPE

OR COVERING

3/4" TO | 1/4"

1 1/2" TO 2"

2 1/2" TO 6"

8" TO 10"

OVER 10"

COMPRESSED AIR

REFRIGERANT SUCTION

REFRIGERANT LIQUID

NATURAL GAS VENT

DOMESTIC COLD WATER

DOMESTIC HOT WATER

DOMESTIC HOT WATER CIRC.

FIRE PROTECTION (SPRINKLER)

SANITARY DRAIN

PLUMBING VENT

STORM WATER

CITY WATER

OXYGEN

VACUUM

NO SCALE

CONDENSATE

NATURAL GAS

SERVICE

IDENTIFICATION MARKERS SHALL ALSO BE PLACED ON PIPES POINTING AWAY FROM

UNCOVERED PIPES AT 50'-0" INTERVALS, ADJACENT TO ALL VALVES OR BRANCHES, AND

SIZE OF LEGEND LETTERS

LENGTH OF

COLOR FIELD

32"

BACKGROUND OR LETTER

COLOR BAND

SAFETY BLUE

SAFETY GREEN

SAFETY ORANGE

SAFETY ORANGE

SAFETY YELLOW

SAFETY YELLOW

SAFETY GREEN

SAFETY WHITE

SAFETY GREEN

SAFETY RED

TYPICAL PIPE IDENTIFICATION MARKERS

- I. ALL WORK SHOWN ON DRAWINGS SHALL BE CONSIDERED NEW AND IN CONTRACT UNLESS SPECIFICALLY INDICATED OTHERWISE.
- DRAWINGS ARE GENERALLY DIAGRAMMATIC. ROUTING OF PIPING, DUCTWORK, CONDUITS, RACEWAYS, ETC., AS SHOWN ON DRAWINGS, DOES NOT INTEND TO SHOW EVERY RISE, DROP, OFFSET, FITTING NOR EVERY STRUCTURAL ELEMENT THAT MAY BE ENCOUNTERED DURING THE INSTALLATION OF THIS WORK. EACH CONTRACTOR SHALL MAKE ANY REQUIRED CHANGES FROM THE GENERAL ROUTING SHOWN ON THESE DRAWINGS, SUCH AS OFFSETS, BENDS OR CHANGES IN ELEVATION DUE TO COORDINATION WITH THE WORK OF OTHER TRADES AND BUILDING CONSTRUCTION. ALL CHANGES SHALL BE MADE WITHOUT ADDITIONAL COST TO THE OWNER OR DELAY IN COMPLETION DATE OF THE PROJECT.
- 3. IT IS INTENDED THAT EQUIPMENT SHALL BE LOCATED SYMMETRICALLY WITH THE ARCHITECTURAL ELEMENTS OF THE BUILDING, NOTWITHSTANDING THE FACT THAT LOCATIONS INDICATED BY THESE DRAWINGS MAY BE DISTORTED FOR CLEARNESS OF PRESENTATION.
- 4. CONTRACTOR SHALL CHECK DRAWINGS OF OTHER TRADES TO VERIFY THAT SPACES IN WHICH THEIR WORK WILL BE INSTALLED ARE CLEAR OF OBSTRUCTIONS. WORK SHALL BE INSTALLED TO MAINTAIN MAXIMUM HEADROOM AND SPACE CONDITIONS AT ALL POINTS IN THE BUILDING. WHERE HEADROOM OR SPACE CONDITIONS APPEAR INADEQUATE, CONTRACTOR SHALL NOTIFY OWNER/ARCHITECT/ENGINEER BEFORE PROCEEDING WITH THE INSTALLATION OF THEIR WORK.
- CONTRACTOR SHALL FURNISH OTHER TRADES ADVANCE INFORMATION AND/OR SHOP DRAWINGS ON LOCATIONS AND SIZES OF PIPING, DUCTWORK, CONDUIT, RACEWAYS, EQUIPMENT, FRAMES, BOXES, SLEEVES AND OPENINGS, ETC. NEEDED FOR THEIR WORK TO PERMIT OTHER TRADES AFFECTED TO INSTALL THEIR WORK PROPERLY AND WITHOUT DELAY.
- WHERE THERE IS EVIDENCE THAT WORK OF ONE TRADE WILL INTERFERE WITH WORK OF OTHER TRADES, ALL TRADES SHALL MEET ON JOB SITE TO WORK OUT SPACE CONDITIONS AND MAKE SATISFACTORY ADJUSTMENTS TO INSTALLATION OF THE NEW WORK. CONTRACTORS SHALL VERIFY EXACT LOCATIONS OF ALL DEVICES AND EQUIPMENT WITH FIELD CONDITIONS, SHOP DRAWINGS, AND WORK OF OTHER TRADES PRIOR TO ROUGH-IN. EACH CONTRACTOR SHALL BE RESPONSIBLE, AT THEIR OWN EXPENSE, FOR THE REMOVAL AND REINSTALLATION OF ANY PART OF THEIR WORK IF SAME WAS INSTALLED WITHOUT CONSULTING WITH OTHER TRADES BEFORE INSTALLING THEIR
- 7. CONTRACTOR SHALL PROVIDE SLEEVES IN BEAMS, FLOORS, COLUMNS AND WALLS AS SHOWN ON THE DRAWINGS, AS REQUIRED BY JOB SITE CONDITIONS, AND/OR AS SPECIFIED, WHEN INSTALLING THEIR WORK. ALL BEAMS AND COLUMNS WHICH ARE REQUIRED TO BE SLEEVED SHALL BE CUT AND REINFORCED AS REQUIRED BY FIELD CONDITIONS AND LOCATIONS AND SIZES SHALL BE CHECKED AND APPROVED BY ARCHITECT BEFORE CONTRACTOR CUTS ANY STRUCTURAL BUILDING MEMBER.
- B. THE SEQUENCE FOR THE INSTALLATION OF ALL WORK SHALL BE COORDINATED BETWEEN ALL CONTRACTORS ON THE PROJECT AND IN STRICT ACCORDANCE WITH ARCHITECT/ENGINEER AND OWNERS STIPULATION AS DIRECTED.
- CONTRACTOR SHALL REFER TO THE ARCHITECTURAL AND STRUCTURAL CONTRACT DRAWINGS (BEFORE SUBMITTING THEIR BIDS) TO FAMILIARIZE THEMSELVES WITH THE EXTENT OF THE GENERAL CONTRACTOR'S WORK, CEILING HEIGHTS AND CLEARANCE FOR INSTALLING THEIR WORK.
- 10. CONTRACTOR SHALL BE RESPONSIBLE AND PAY FOR ALL CORING, CUTTING, PATCHING, REPAIRING. REFINISHING AND REMOVAL/REPLACEMENT OF NEW OR EXISTING BUILDING CONSTRUCTION REQUIRED TO ACCOMMODATE THE INSTALLATION OR REMOVAL OF THEIR WORK. ALL PATCHING, REPAIRING AND REFINISHING WORK SHALL BE PERFORMED BY THOSE REGULARLY INVOLVED IN THAT TRADE AND SHALL MATCH THE ADJACENT CONSTRUCTION AS CLOSELY AS POSSIBLE. CARE SHALL BE TAKEN SO AS NOT TO DAMAGE ANY EXISTING BUILDING CONSTRUCTION OR ITEMS THAT ARE TO REMAIN. ANY EXISTING FINISHES THAT ARE DAMAGED DURING THE INSTALLATION OF NEW WORK OR REMOVAL OF EXISTING WORK SHALL BE REPAIRED, REPLACED AND PAID FOR BY THE INSTALLING CONTRACTOR, TO THE SATISFACTION OF THE ARCHITECT AND OWNER. REFER TO ARCHITECTURAL DRAWINGS FOR EXISTING BUILDING CONSTRUCTION THAT IS TO REMAIN AND, THEREFORE, SUBJECT TO PATCHING, REPAIRING, REFINISHING, AND REMOVAL/REPLACEMENT. (NOTE: CONTRACTOR SHALL VERIFY EXISTING BUILDING'S ROOF WARRANTY AND EMPLOY OTHER SUBCONTRACTOR(S) AS REQUIRED BY ROOF MANUFACTURER'S REPRESENTATIVE SO AS NOT TO VOID OWNER'S ROOF WARRANTY.)
- II. SOME OF THE EXISTING ITEMS AND EQUIPMENT SCHEDULED TO BE REMOVED SHALL BE TURNED OVER TO THE OWNER. ANY ITEMS THAT THE OWNER WANTS TO RETAIN SHALL BE REMOVED CAREFULLY SO AS NOT TO DAMAGE THEM. ALL OTHER ITEMS TO BE REMOVED SHALL BECOME THE PROPERTY OF THE CONTRACTOR AND REMOVED FROM THE SITE.
- 12. CONTRACTOR SHALL BE RESPONSIBLE FOR THEIR OWN CLEAN-UP DURING CONSTRUCTION. IF CONTRACTOR FAILS TO PROVIDE SUCH CLEAN-UP, THE ARCHITECT/ENGINEER WILL DIRECT ANOTHER CONTRACTOR TO PERFORM THE CLEAN-UP AND THE NEGLIGENT CONTRACTOR SHALL PAY THE ASSOCIATED BACK-CHARGES AS DEEMED APPROPRIATE BY THE ARCHITECT/ENGINEER.
- 13. CONTRACTOR SHALL INSTALL ALL AUXILIARY SUPPORTING STEEL AS REQUIRED FOR THE SUPPORTING OF THEIR PIPING, DUCTWORK, CONDUIT, TANKS, EQUIPMENT, ETC. ALL SUPPORTING STEEL FOR ITEMS ABOVE A SUSPENDED CEILING SHALL BE FROM BUILDING STRUCTURAL MEMBERS
- 14. IT IS MANDATORY THAT THE COMPLETE EXISTING BUILDING REMAIN IN CONTINUOUS AND NON-INTERRUPTED OPERATION DURING REMODELING/ALTERING OF SAID EXISTING BUILDING. THE SPECIFIC AREA(S) BEING REMODELED/ALTERED AT ANY SCHEDULED TIME ARE OBVIOUSLY EXCLUSIVE OF THIS STATEMENT. SERVICES TO EXISTING BUILDING SHALL BE KEPT IN CONTINUOUS OPERATION INCLUDING POWER, SIGNAL SYSTEMS, LIGHTING, TELEPHONE, HEATING, COOLING, VENTILATING, TEMPERATURE CONTROL, SEWERS AND HOT AND COLD WATER. ANY ABSOLUTELY NECESSARY INTERRUPTION OF THESE SERVICES TO ACCOMPLISH CONTRACT WORK SHALL BE ARRANGED WITH THE OWNER A MINIMUM OF TEN (10) WORKING DAYS IN ADVANCE. SUCH INTERRUPTIONS SHALL BE KEPT TO AN ABSOLUTE MINIMUM AS FAR AS TIME INTERVAL IS INVOLVED AND TEMPORARY SERVICES SHALL BE FURNISHED AND INSTALLED UNDER THIS CONTRACT WHERE NECESSARY TO ACCOMPLISH THIS PURPOSE. TEMPORARIES SHALL BE REMOVED BY THE CONTRACTOR ONLY AFTER NEW PERMANENT SERVICES ARE INSTALLED AND FULLY OPERATIONAL.

PACK VOID BETWEEN PIPE OR INSULATION— -Provide a minimum of 1/2" AND WALL WITH FIBERGLASS BATT, THEN CLEARANCE BETWEEN WALL SEAL WITH A SILICONE COMPOUND OR OTHER APPROVED SEALANTS. IF WALL AND PIPE OR INSULATION IS FIRE RATED, FILL VOID BETWEEN PIPE -PIPE INSULATION. -SEE DRAWINGS FOR PIPE SPECIFICATIONS FOR . – – – – + – – SIZE AND MATERIAL PIPE SIZE AND MATERIAL ╼┵╶╶╟┤╴╴╴╴╴┼╎╴╴┶ CHROME PLATED OR STAINLESS STEEL-ESCUTCHEON PLATES BOTH SIDES OF WALL SECURED WITH WALL CLIPS OR MOUNTING -FACE OF WALL.

- NOTES: 1. I.D. OF WALL OPENING TO BE A MIN. OF 1/2" LARGER THAN O.D.
- OF PIPE OR INSULATION PASSING THROUGH WALL 2. CONTRACTOR SHALL BE RESPONSIBLE FOR THE COORDINATION OF THEIR WALL OPENINGS WITH OTHER TRADES AND/OR CONTRACTORS.
- PIPE PENETRATIONS OF SMOKE OR FIRE WALLS SHALL BE IN COMPLIANCE WITH NFPA-90A.

PIPE PENETRATION OF INTERIOR WALL DETAIL NO SCALE

I. CONTRACTOR SHALL ISOLATE ALL PIPES WHICH VIBRATE FROM CONSTRUCTION IN ORDER

- TO AVOID TRANSMISSION TO STRUCTURE. 2. CONTRACTOR SHALL BE RESPONSIBLE FOR THE COORDINATION OF THEIR WALL OPENINGS WITH OTHER TRADES AND/OR CONTRACTORS.
- PIPE PENETRATION OF EXTERIOR WALL ABOVE GRADE NO SCALE

- 15. UNLESS INDICATED OTHERWISE. THE ARCHITECT/ENGINEER MAKES NO REPRESENTATION AS TO WHETHER OR NOT ANY HAZARDOUS OR CONTAMINATED MATERIALS (INCLUDING BUT NOT LIMITED TO ASBESTOS, PCB'S, CONTAMINATED SOILS, ETC.) ARE PRESENT WITHIN THE EXISTING BUILDING OR ON THE SITE. WORK SHOWN ON THE DRAWINGS AND/OR INDICATED IN THE SPECIFICATIONS SHALL NOT BE CONSTRUED TO CALL FOR CONTACT WITH ANY OF THESE MATERIALS. IF THESE MATERIALS ARE ENCOUNTERED OR SUSPECTED, THE CONTRACTOR SHALL NOT DISTURB THEM AND SHALL CONTACT THE ARCHITECT/ENGINEER IMMEDIATELY.
- 16. WHERE WORK CALLED FOR ON THE DRAWINGS OR IN THE SPECIFICATIONS INVOLVES THE REMOVAL OR RELOCATION OF PIPING OR EQUIPMENT CONTAINING REFRIGERANT, ALL REFRIGERANT SHALL BE RECOVERED BY APPROVED METHODS PER EPA REGULATIONS.
- 17. CONTRACTOR SHALL STORE ALL MATERIALS AND EQUIPMENT SHIPPED TO THE SITE IN A PROTECTED AREA. IF MATERIAL IS STORED OUTSIDE OF THE BUILDING, IT MUST BE STORED OFF THE GROUND A MINIMUM OF SIX INCHES (6") SET ON 6 X 6 PLANKS AND/OR WOOD PALLETS. ALL MATERIAL AND EQUIPMENT MUST BE COMPLETELY COVERED WITH WATERPROOF TARPS OR VISQUIN. ALL PIPING AND DUCTWORK WILL HAVE THE ENDS CLOSED TO KEEP OUT DIRT AND OTHER DEBRIS. NO EQUIPMENT WILL BE ALLOWED TO BE STORED OUTSIDE THE BUILDING ON THE SITE UNLESS IT IS SUPPORTED OFF THE GROUND AND COMPLETELY PROTECTED WITH WEATHERPROOF COVERS.
- 18. THE DRAWINGS, SCHEDULES AND SPECIFICATIONS HAVE BEEN PREPARED USING ONE MANUFACTURER FOR EACH PIECE OF EQUIPMENT AS THE BASIS FOR DIMENSIONAL DESIGN. IF THE CONTRACTOR PURCHASES EQUIPMENT FROM A SPECIFIED ACCEPTABLE MANUFACTURER, BUT NOT THE SCHEDULED MANUFACTURER USED FOR THE BASE DESIGN, THE CONTRACTOR SHALL BE RESPONSIBLE FOR CHECKING ALL THE DIMENSIONS OF THE EQUIPMENT TO VERIFY THAT IT WILL FIT IN THE SPACE SHOWN ON THE DRAWINGS. MINOR DEVIATIONS IN DIMENSIONS WILL BE PERMITTED, PROVIDED THE RATINGS MEET THOSE SHOWN ON THE DRAWINGS AND EQUIPMENT WILL PHYSICALLY FIT INTO THE SPACE ALLOCATED WITH SUITABLE ACCESS AROUND EQUIPMENT FOR OPERATION AND MAINTENANCE OF THE EQUIPMENT. WHEN EQUIPMENT SUBMITTED FOR REVIEW DOES NOT MEET THE PHYSICAL SIZE OR ARRANGEMENT OF THAT SCHEDULED AND SPECIFIED, CONTRACTOR SHALL PAY FOR ALL ALTERATIONS REQUIRED TO ACCOMMODATE SUCH EQUIPMENT AT NO ADDITIONAL COST TO THE OWNER. CONTRACTOR WILL ALSO PAY ALL COSTS FOR ADDITIONAL WORK REQUIRED BY OTHER CONTRACTORS, OWNER, ARCHITECT OR ENGINEER TO MAKE CHANGES WHICH WOULD ALLOW THE EQUIPMENT TO FIT IN THE SPACE AND FUNCTION AS INTENDED.
- 19. CONTRACTOR AND/OR MANUFACTURER SHALL VERIFY THAT THE CHARACTERISTICS OF THE EQUIPMENT SUBMITTED FOR REVIEW MEETS THE CAPACITY AND DUTY SPECIFIED. WHEN EQUIPMENT SUBMITTED FOR REVIEW REQUIRES MODIFICATIONS TO THE WORK OF OTHER CONTRACTORS, SUBMITTING CONTRACTOR SHALL PAY FOR ALL COSTS FOR ADDITIONAL WORK REQUIRED BY OTHER CONTRACTORS, OWNER, ARCHITECT OR ENGINEER TO MAKE CHANGES WHICH WOULD ALLOW THE EQUIPMENT FUNCTION SAFELY AND PROPERLY.
- 20. CONTRACTOR SHALL FIELD VERIFY THE SIZE OF EXISTING OPENINGS, WINDOWS, DOORS, CORRIDORS, ROOMS, ETC. FOR ACCESS OF THE NEW EQUIPMENT INTO OR REMOVAL OF EXISTING EQUIPMENT FROM THE BUILDING. IF OPENINGS ARE TOO SMALL FOR ACCESS THEN CONTRACTOR SHALL, AT THEIR OWN EXPENSE, PROVIDE NEW OR ENLARGED OPENINGS AND RESTORE SAME TO ORIGINAL SIZE AND CONDITION. CONTRACTOR MAY ELECT TO ORDER THE EQUIPMENT DISASSEMBLED AND/OR WITH SPLIT HOUSING FOR ENTRANCE INTO THE EXISTING SPACE OR BUILDING. CONTRACTOR SHALL REASSEMBLE EQUIPMENT AFTER IT IS IN THE SPACE AT THEIR OWN EXPENSE.
- 21. CONTRACTOR SHALL BE RESPONSIBLE FOR OBTAINING ALL NECESSARY PERMITS AND THEIR ASSOCIATED
- 22. CONTRACTOR SHALL SUBMIT DIGITAL COPIES OF SHOP DRAWINGS OF ALL EQUIPMENT, DIFFUSERS, REGISTERS, LIGHTING FIXTURES, PANELBOARDS, ELECTRICAL DEVICES, AND PLUMBING FIXTURES TO ENGINEER FOR APPROVAL PRIOR TO ORDERING ANY ITEMS OR FABRICATING ANY DUCTWORK.
- 23. CONTRACTOR SHALL PROVIDE OWNER TRAINING ON ALL EQUIPMENT AND BUILDING SYSTEMS PROVIDED/ALTERED BY THEIR WORK. TRAINING SHALL BE ACCOMPLISHED DURING TIME DEDICATED FOR THAT PURPOSE, NOT IN CONJUNCTION WITH SERVICE WORK.
- 24. AT COMPLETION OF PROJECT, CONTRACTOR SHALL SUBMIT ONE PHYSICAL AND DIGITAL COPIES OF OPERATION AND MAINTENANCE MANUALS FOR ALL WORK PROVIDED BY THEM ON PROJECT. MANUALS SHALL BE CLEARLY ORGANIZED AND CONTAIN COPIES OF APPROVED EQUIPMENT, SHOP DRAWINGS, EQUIPMENT PARTS LISTS, SERVICE CONTACTS, CONTRACTOR AND MANUFACTURER WARRANTEES, AND "AS BUILT" FLOOR
- 25. CONTRACTOR SHALL PROVIDE WARRANTY FOR ALL MATERIAL AND GUARANTEE ALL WORKMANSHIP PROVIDED BY THEM FOR I (ONE) YEAR FROM SUBSTANTIAL COMPLETION OF WORK INVOLVED.
- 26. CONTRACTOR SHALL MAINTAIN A CURRENT CITY OF WOODSTOCK LICENSE THROUGHOUT ALL PHASES OF CONSTRUCTION. IT SHALL BE THE CONTRACTORS RESPONSIBILITY TO COORDINATE ALL INSPECTIONS WITH THE CITY OFFICIALS.

INTERIOR SIDE OF WALL-

PLATE IN EXPOSED AREA.

WITH WALL CLIPS OR

MOUNTING SPRINGS

PIPE INSULATION—

(WHERE SPECIFIED)

SEE DRAWINGS/—

PLATE SHALL BE SECURED

CHROME PLATED, BRASS, OR—

STAINLESS STEEL ESCUTCHEON

PROVIDE 1/2" MIN. CLEARANCE-

BETWEEN WALL & PIPE OR

INSULATION

ARCHITECT OF RECORD **DEMONICA KEMPER ARCHITECTS** 125 N. HALSTED STREET, SUITE 301 **CHICAGO, IL 60661** P: 312.496.0000

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SCHAUMBURG,IL 60173 P: 847.882.2010 F: 847.882.2201 CIVIL ENGINEERS HRG GREEN

1391 CORPORATE DRIVE, SUITE 203 MCHENRY ,IL 60050 P:815.385.1778 F:815.385.1781

5世

KEY PLAN:

-SEAL WITH SILICONE OR OTHER

APPROVED SEALANTS

-EXTERIOR SIDE OF WALL.

-MASTIC WATERTIGHT JOINT

360° AROUND PIPE PLATE

-STAINLESS STEEL, CHROME

PLATED, OR VRASS COLLAR

-Pack void between wall

-STAINLESS STEEL, CHROME

SEALED WATER TIGHT

\$ SLEEVE WITH OAKUM

OR FIBERGLASS ROPE

PLATED, OR BRASS

ESCUTCHEON PLATE

-STAINLESS STEEL OR

BRASS BOLTS INTO WALL

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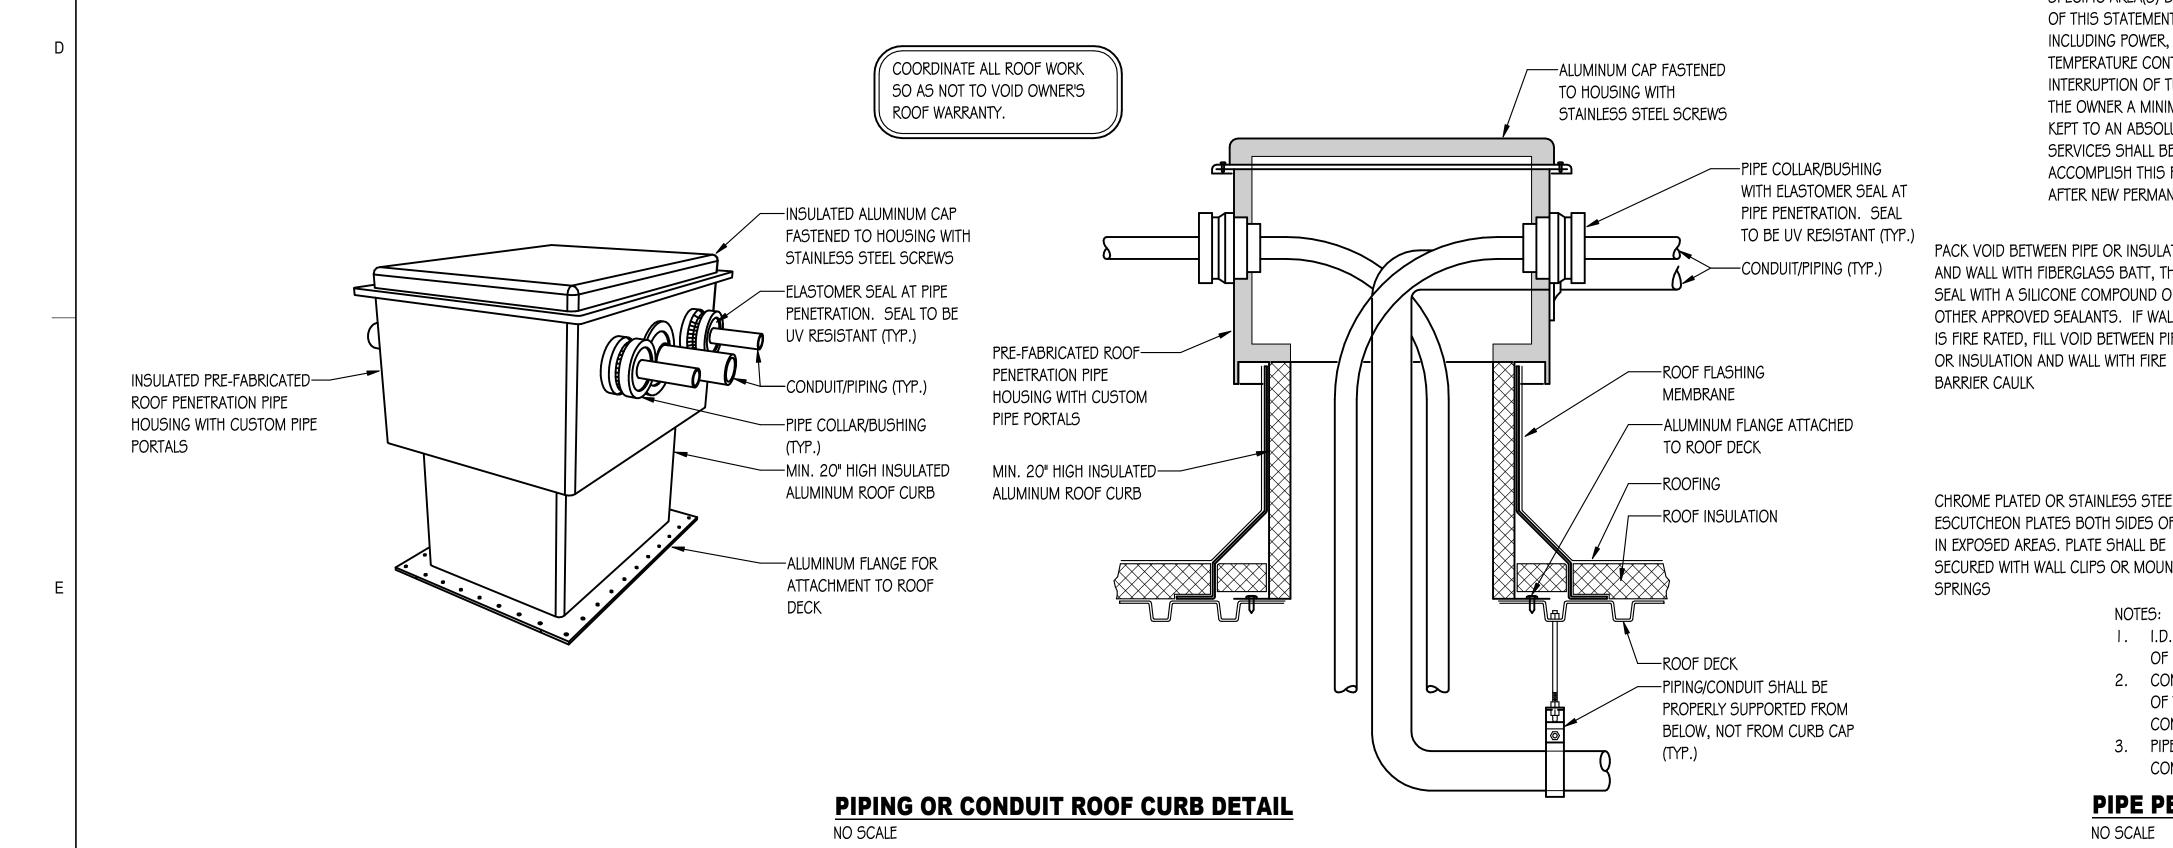
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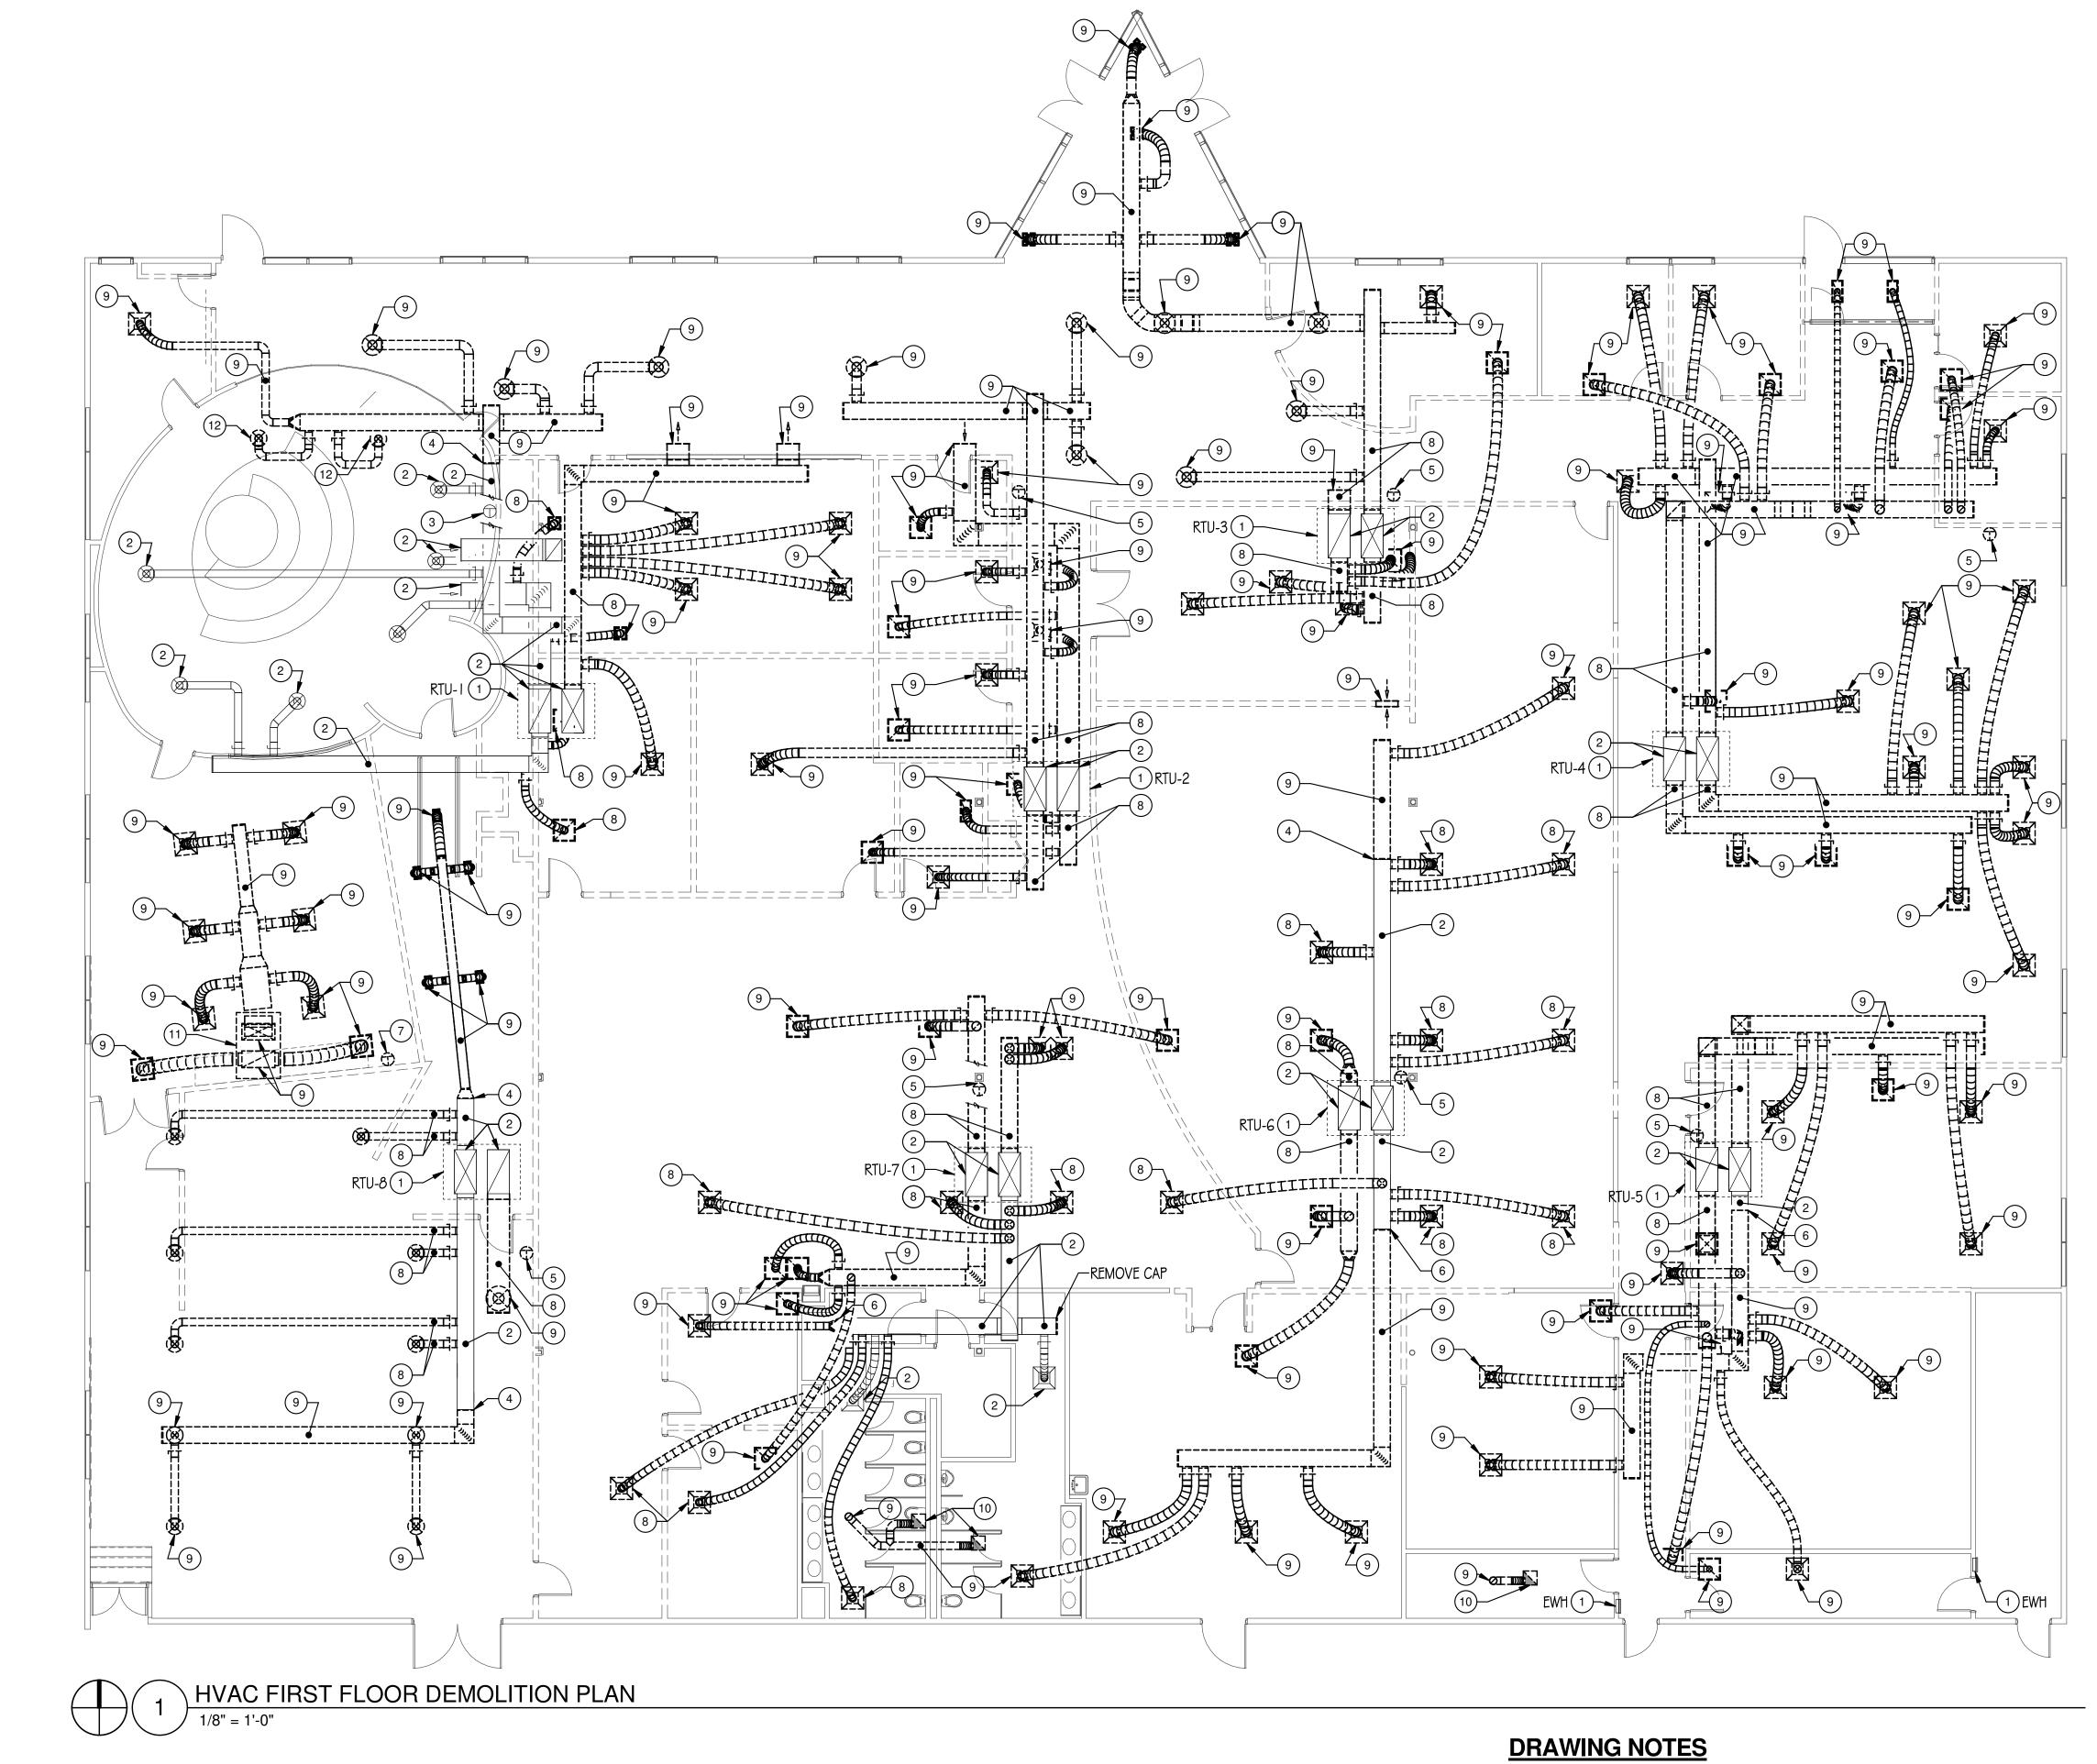
AND DETAILS

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- I EXISTING HVAC EQUIPMENT TO REMAIN.
- 2 EXISTING DUCTWORK, DIFFUSERS, REGISTERS, AND GRILLES TO REMAIN.

SHEET METAL CAP AND SEAL WEATHER TIGHT.

- 3 EXISTING THERMOSTAT TO REMAIN.
- 4 CAP EXISTING DUCT AT LOCATION SHOWN AND REMOVE ALL DUCTWORK, REGISTERS, DIFFUSERS, HANGERS, INSULATION, ETC. SHOWN DASHED BEYOND THIS POINT.
- 5 CAREFULLY REMOVE EXISTING TEMPERATURE SENSOR TO LOCATION INDICATED ON NEW WORK PLAN. EXTEND TRIM/EXISTING WIRING AS REQUIRED.
- 6 NEW CONNECTION TO BE MADE AT THIS LOCATION. REMOVE ALL DUCTWORK, DIFFUSERS,
- REGISTERS, HANGERS, INSULATION, ETC. SHOWN DASHED BEYOND THIS POINT.

 7 REMOVE EXISTING THERMOSTAT INCLUDING ALL ASSOCIATED CONDUIT, WIRING, ETC.
- 7 REMOVE EXISTING THERMOSTAT INCLUDING ALL ASSOCIATED CONDUIT, WIRING, ETC.
 LOCATED ABOVE ANY ACCESSIBLE CEILING BETWEEN THERMOSTAT AND THE UNIT IT
 CONTROLS. PROVIDE BLANK COVER PLATE OVER ALL ABANDONED JUNCTION BOXES IN
 WALLS THAT ARE TO REMAIN.
- 8 REMOVE ALL DUCTWORK, DIFFUSERS, REGISTERS, HANGERS, INSULATION, ETC. SHOWN DASHED AND CAP AT MAIN.
- 9 REMOVE ALL DUCTWORK, DIFFUSERS, REGISTERS, HANGERS, INSULATION, ETC. SHOWN DASHED.
- 10 REMOVE EXISTING EXHAUST FAN AND ALL ASSOCIATED DUCTWORK, GRILLES, REGISTERS,
- DAMPERS, INSULATION, CONTROLS, ETC.

 I REMOVE EXISTING ROOFTOP UNIT AND ALL ASSOCIATED DUCTWORK, DAMPERS, PIPING, VALVING, CONTROLS, HANGERS, SUPPORTS, INSULATION, ETC. PROVIDE INSULATED
- I 2 CAREFULLY REMOVE EXISTING ROUND DIFFUSER TO LOCATION INDICATED ON NEW WORK PLAN. MODIFY DUCTWORK AS REQUIRED.

ARCHITECT OF RECORD

DEMONICA KEMPER ARCHITECTS

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CIVIL ENGINEERS

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MCHENRY COUNTY COLI

KEY PLAN:

SHEET STATUS: 9.19.23
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NO: DESCRIPTION: DATE:

SHEET TITLE:


HVAC FIRST FLOOR

DEMOLITION PLAN

SHEET NUMBER:

DHV1.00

9/19/2023 10:15:24 AM

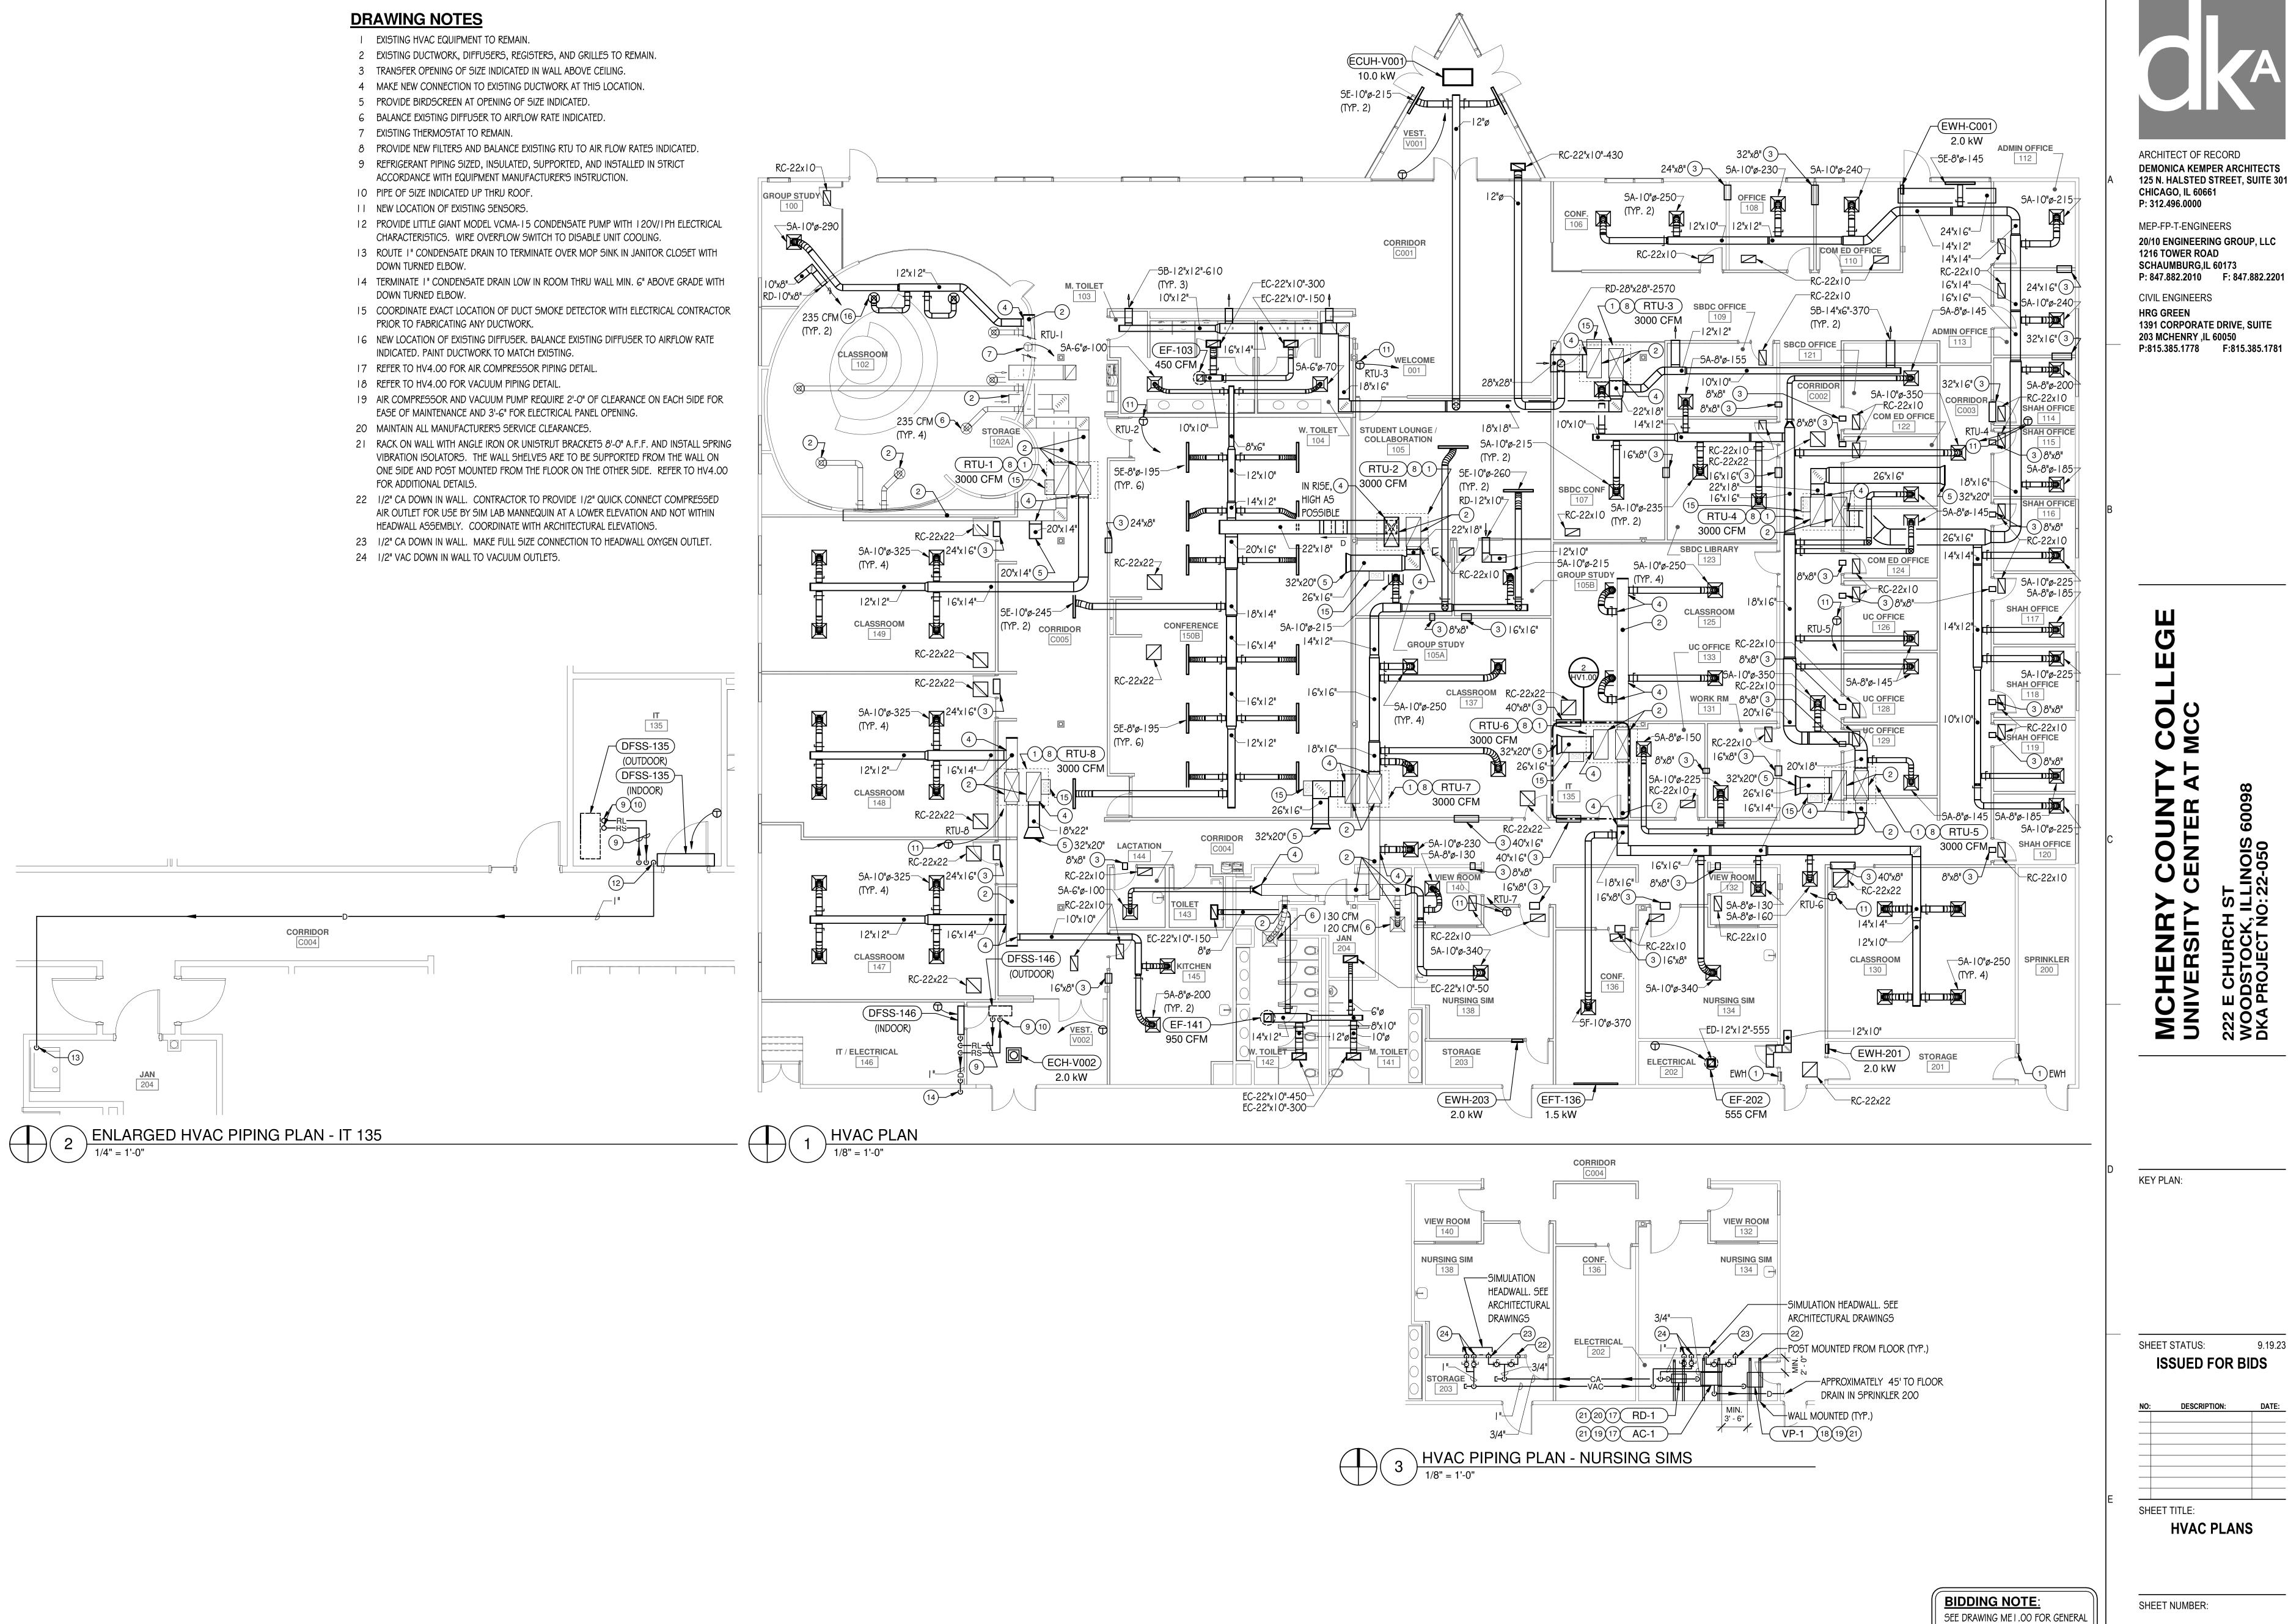

MEP-FP-T-ENGINEERS 20/10 ENGINEERING GROUP, LLC 1216 TOWER ROAD SCHAUMBURG,IL 60173

CIVIL ENGINEERS HRG GREEN 1391 CORPORATE DRIVE, SUITE 203 MCHENRY ,IL 60050

CENTER

SHEET STATUS: 9.19.23 **ISSUED FOR BIDS**


DESCRIPTION: SHEET TITLE:

HVAC PLANS

SHEET NUMBER: HV1.00

9/19/2023 10:15:25 AM

NOTES AND ADDITIONAL DETAILS APPLICABLE TO THIS TRADE'S WORK.

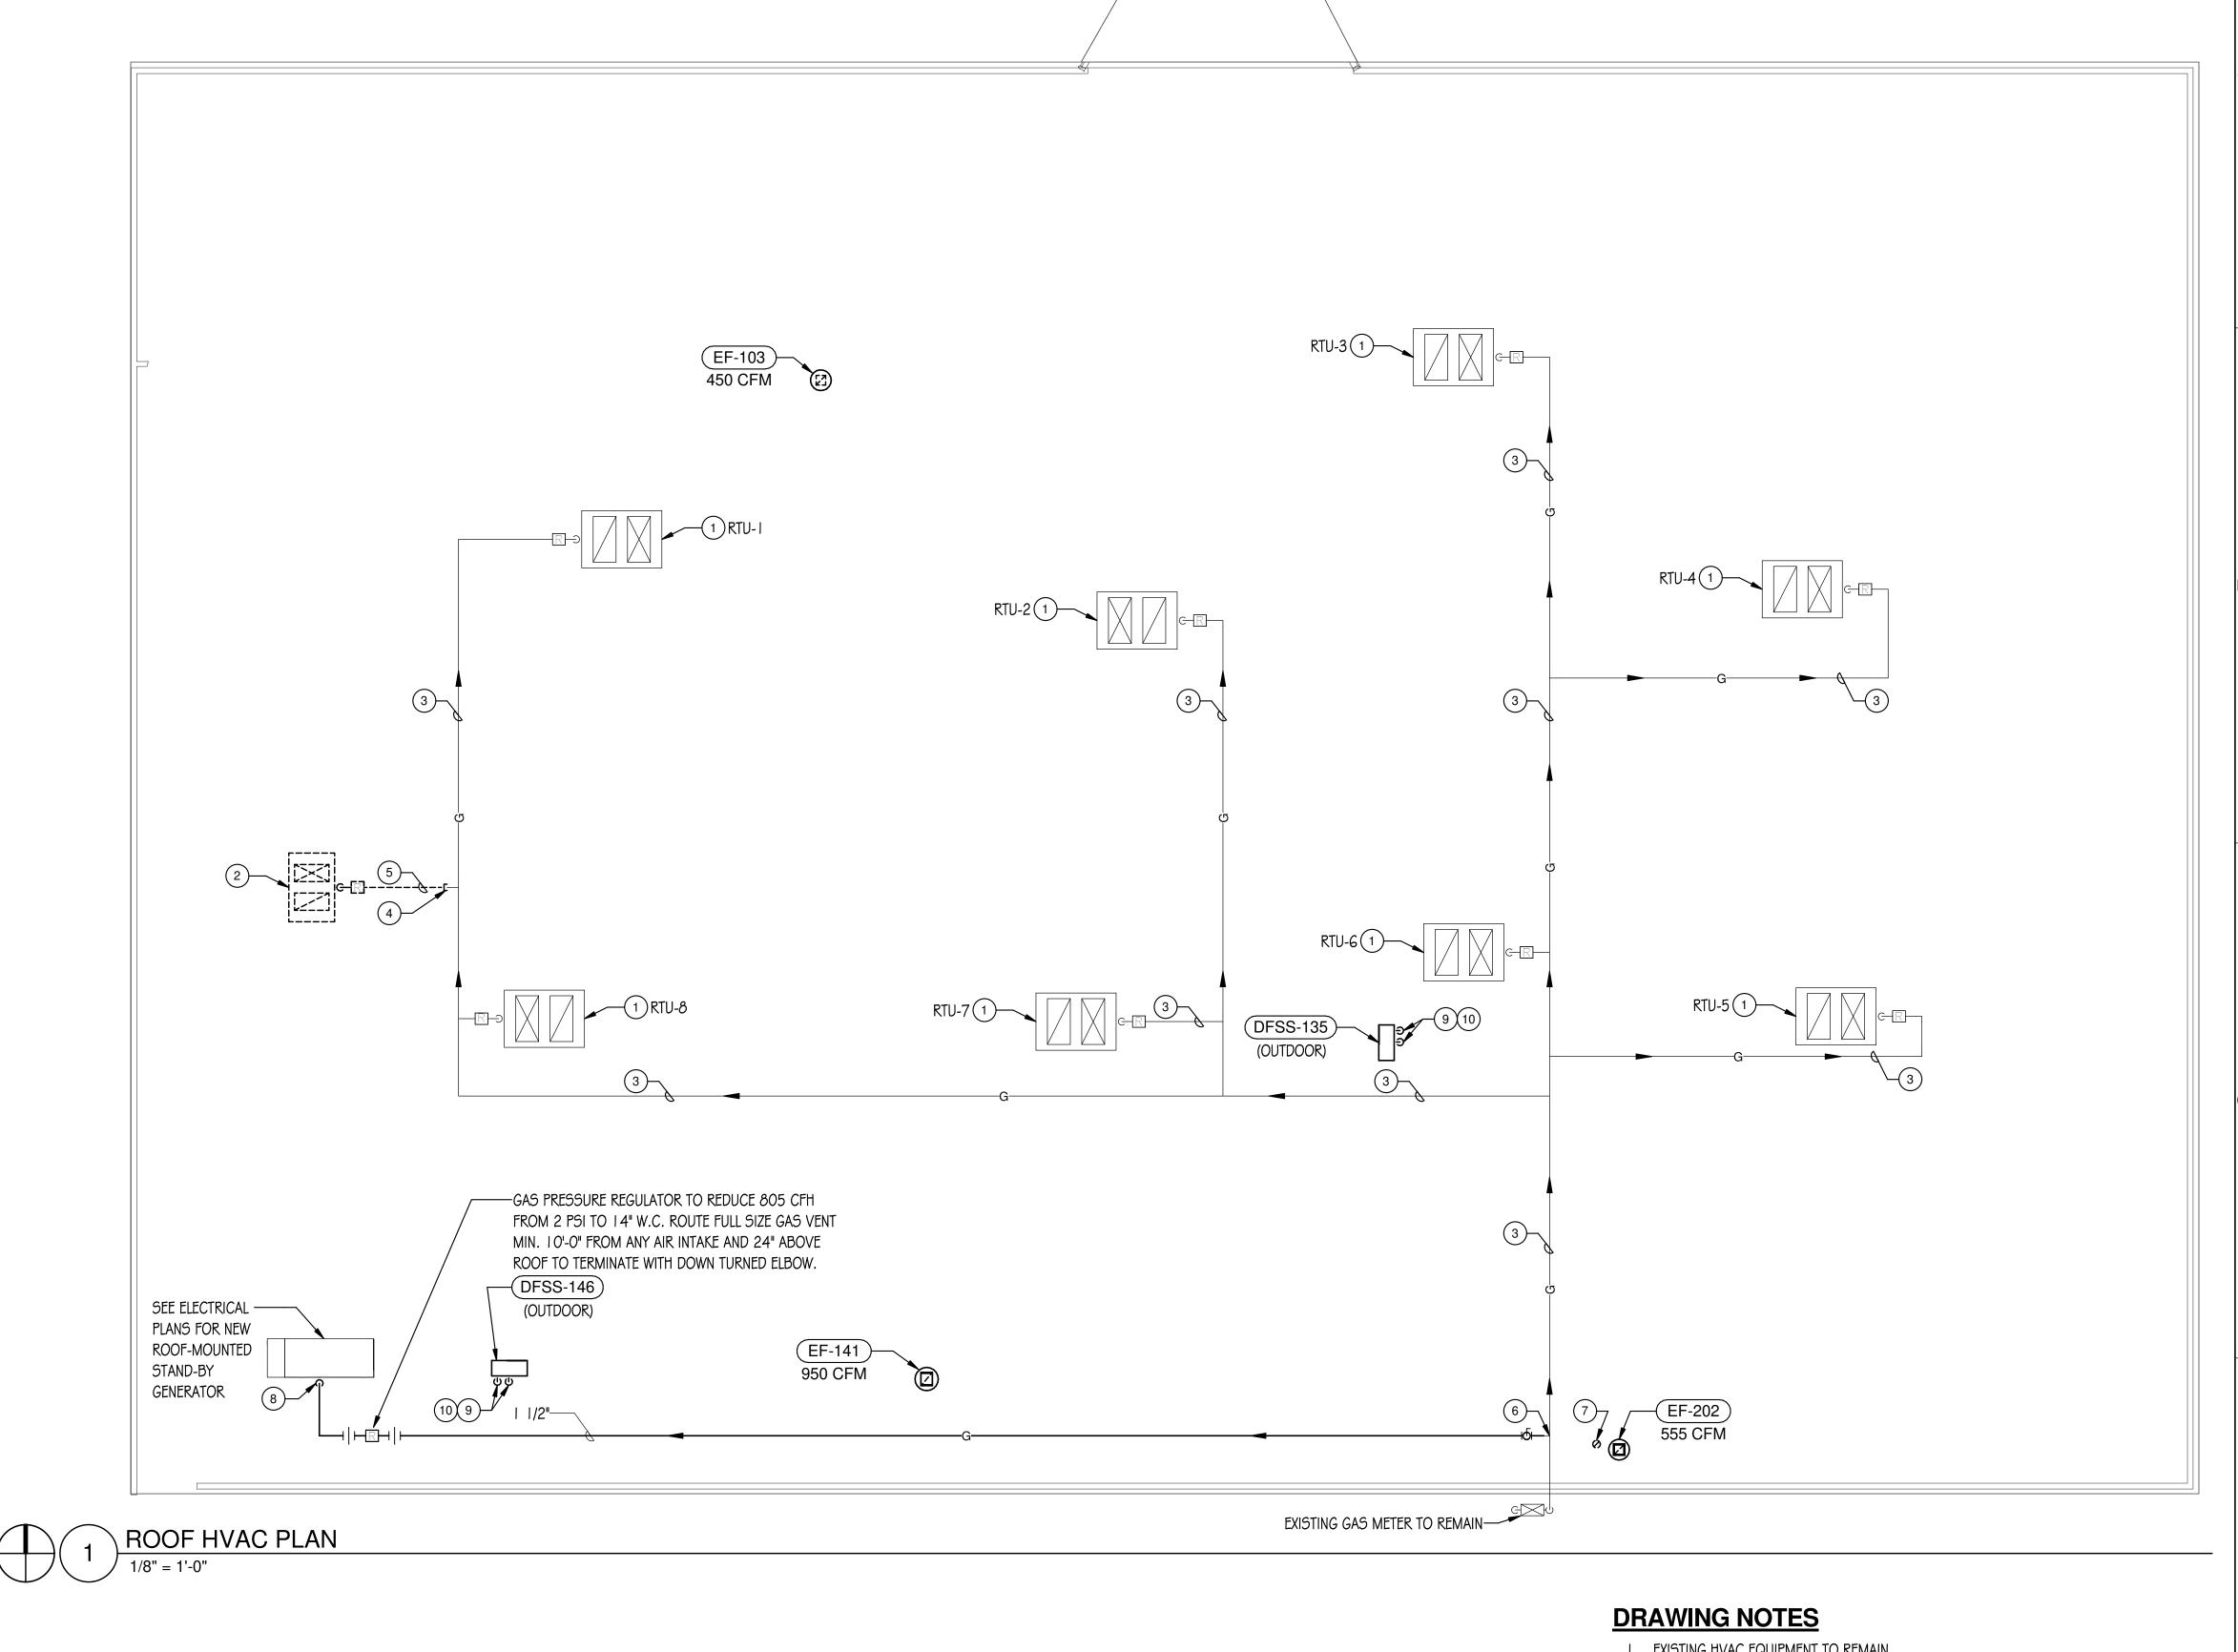

- I EXISTING HVAC EQUIPMENT TO REMAIN.
- 2 REMOVE EXISTING ROOFTOP UNIT AND ALL ASSOCIATED DUCTWORK, DAMPERS, PIPING, VALVING, CONTROLS, HANGERS, SUPPORTS, INSULATION, ETC. PROVIDE INSULATED
- SHEET METAL CAP AND SEAL WEATHER TIGHT. 3 EXISTING PIPING AND VALVING TO REMAIN.
- 4 CAP EXISTING PIPE AT LOCATION SHOWN AND REMOVE ALL PIPING, VALVING, HANGERS,
- INSULATION, ETC. SHOWN DASHED BEYOND THIS POINT.
- 5 REMOVE ALL PIPING, VALVING, HANGERS, INSULATION, ETC. SHOWN DASHED.
- 6 MAKE NEW CONNECTION TO EXISTING PIPING AT THIS LOCATION.
- 7 REMOVE ALL DUCTWORK, DIFFUSERS, REGISTERS, HANGERS, INSULATION, ETC. SHOWN
- 8 MAKE FINAL FULL SIZE CONNECTION TO UNIT WITH MIN. 6" DIRT LEG.
- 9 PIPE OF SIZE INDICATED DOWN THRU ROOF.
- 10 REFRIGERANT PIPING SIZED, INSULATED, SUPPORTED, AND INSTALLED IN STRICT ACCORDANCE WITH EQUIPMENT MANUFACTURER'S INSTRUCTION.

MEP-FP-T-ENGINEERS 20/10 ENGINEERING GROUP, LLC **1216 TOWER ROAD**

SCHAUMBURG,IL 60173 P: 847.882.2010 F: 847.882.2201 CIVIL ENGINEERS

HRG GREEN 1391 CORPORATE DRIVE, SUITE 203 MCHENRY ,IL 60050 P:815.385.1778 F:815.385.1781

CENTER AT

KEY PLAN:


SHEET STATUS: 9.19.23 **ISSUED FOR BIDS**

NO: DESCRIPTION: DATE:

SHEET TITLE: **HVAC ROOF PLAN**

SHEET NUMBER:

9/19/2023 10:15:26 AM

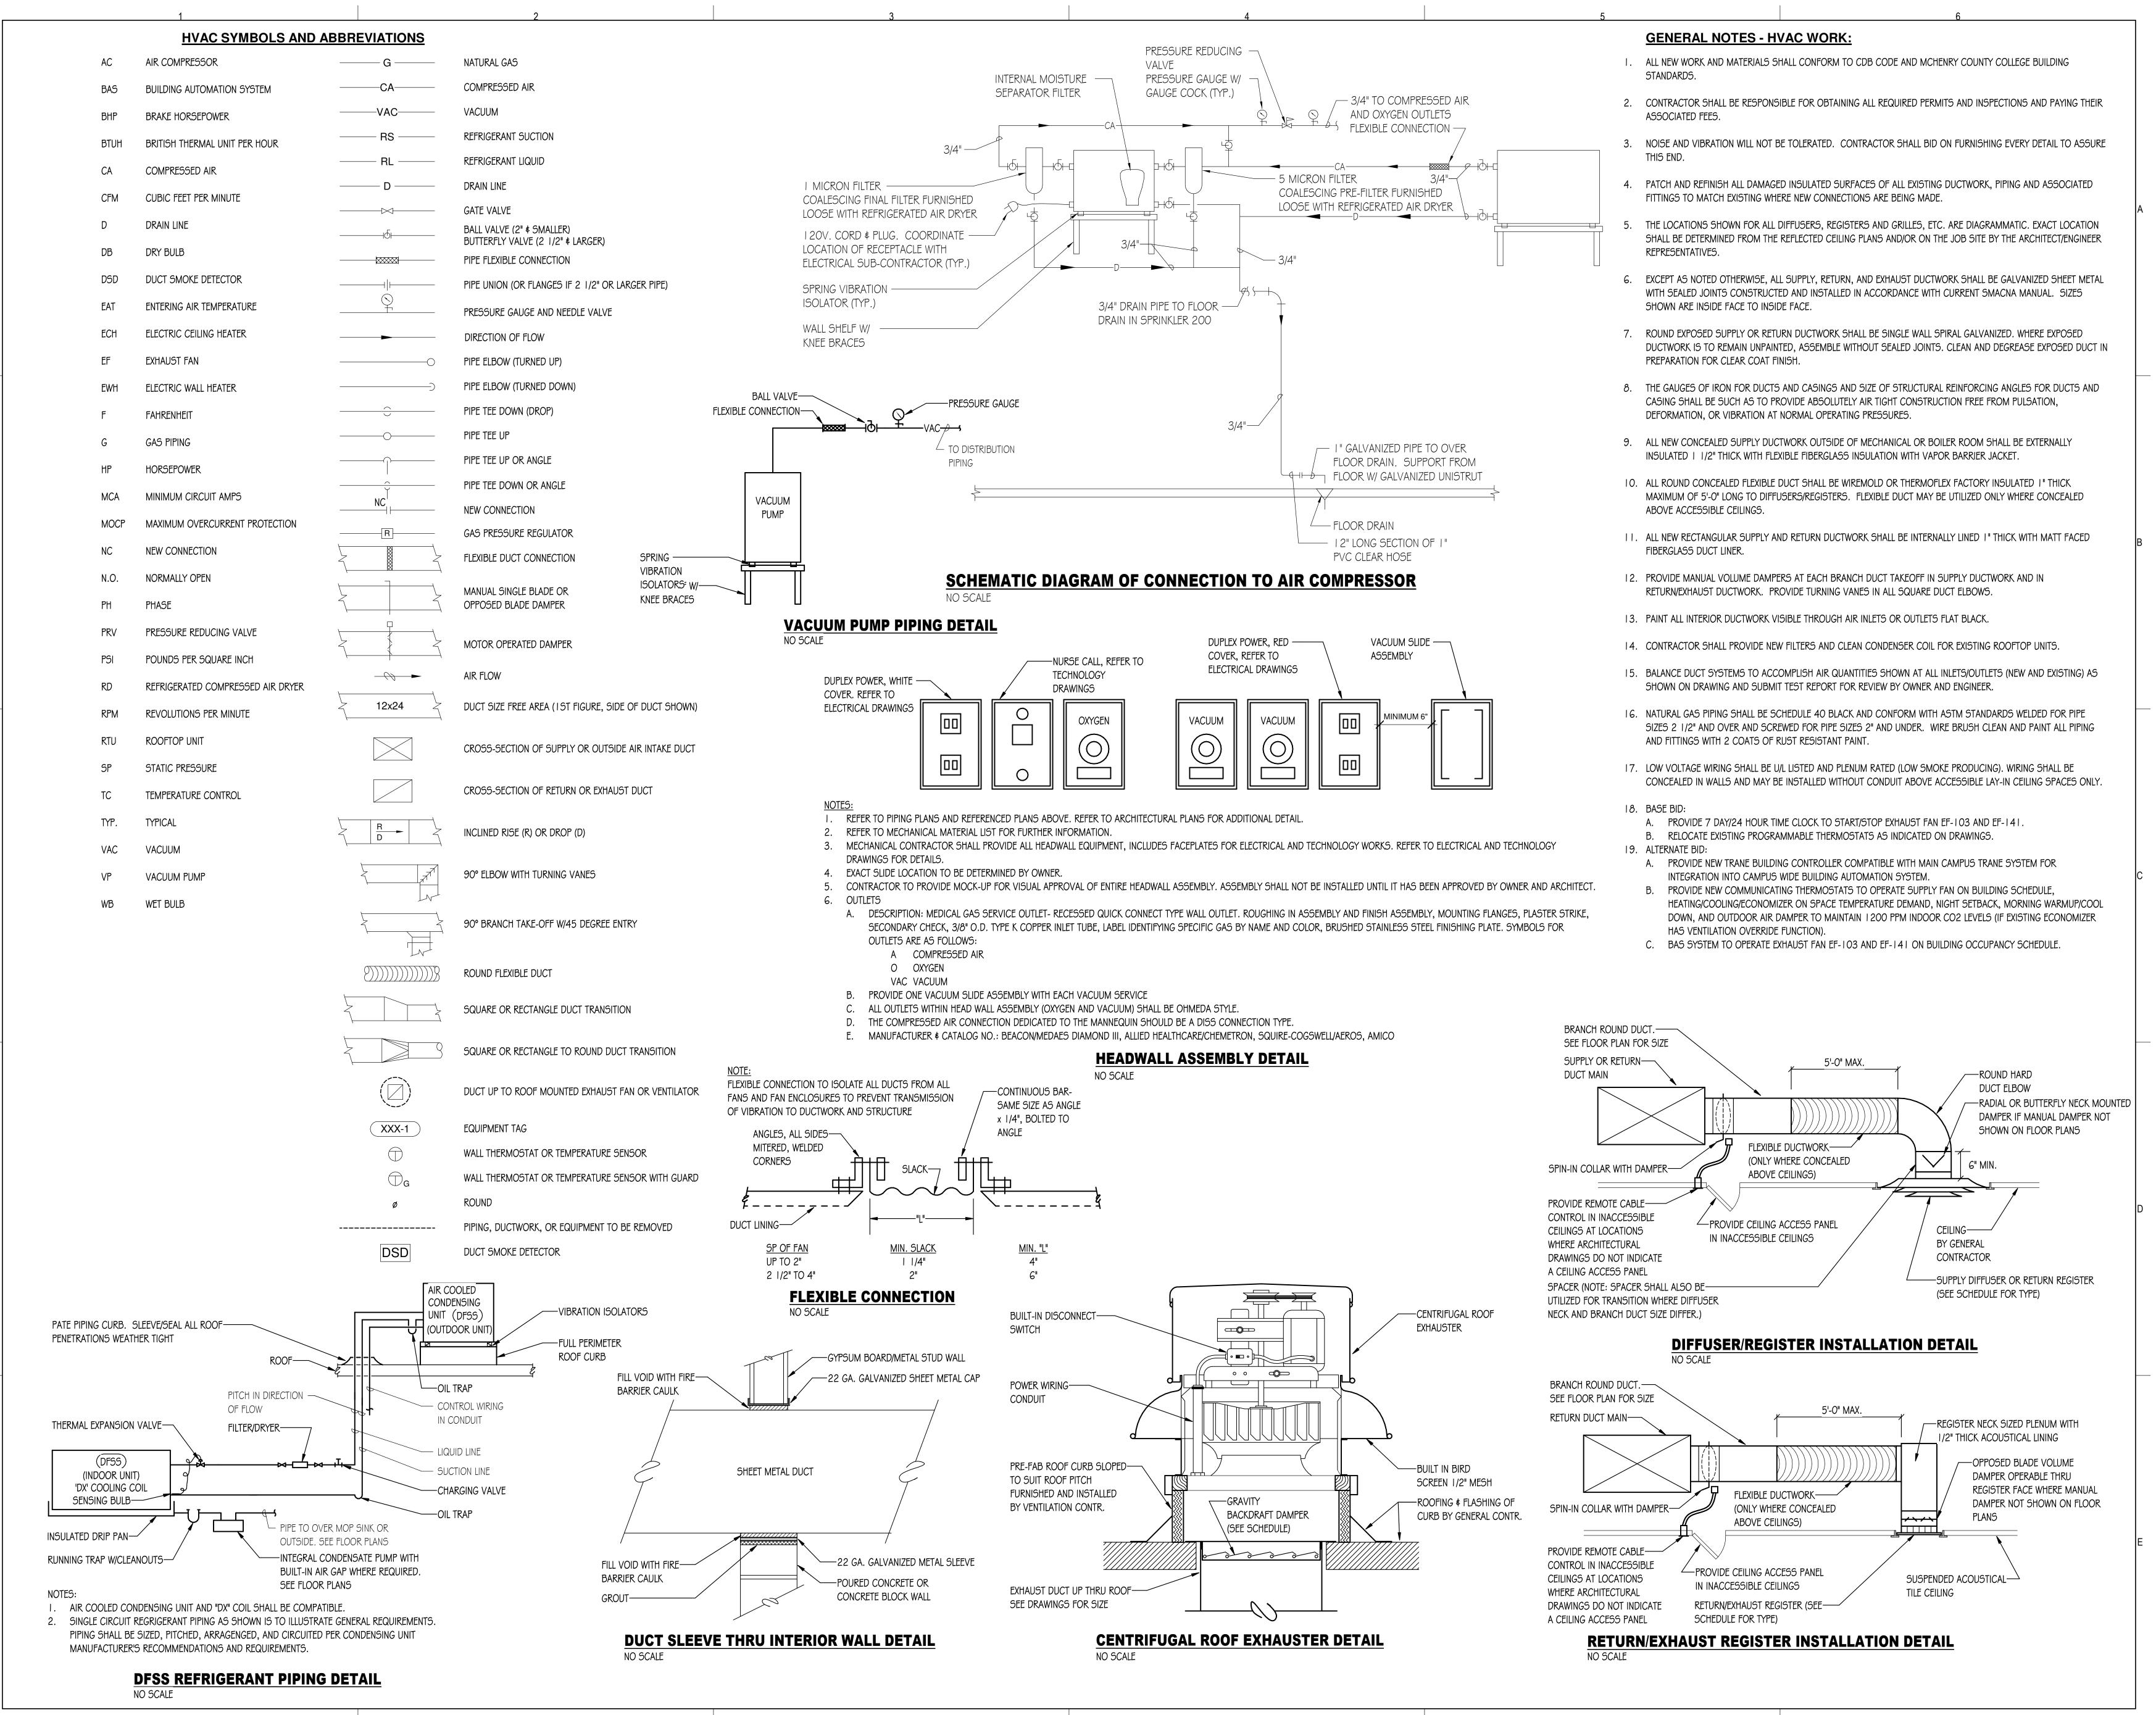

MEP-FP-T-ENGINEERS

20/10 ENGINEERING GROUP, LLC

1216 TOWER ROAD

SCHAUMBURG,IL 60173

P: 847.882.2010 F: 847.882.2201

CIVIL ENGINEERS

HRG GREEN
1391 CORPORATE DRIVE, SUITE
203 MCHENRY, IL 60050
P:815.385.1778 F:815.385.1781

Y CENTER AT MCC

KEY PLAN:

SHEET STATUS: 9.19.23

ISSUED FOR BIDS

NO: DESCRIPTION: DATE:

SHEET TITLE:

HVAC LEGEND,

NOTES, AND DETAILS

SHEET NUMBER: HV4.00

9/19/2023 10:15:26 AM

											DUCT	FREE	SPLIT	SYS	STEN	SC	HED	ULE											
FOLUD	۸۵۵۸		COOLING	HEATING						- IN	NDOOR L	JNIT									OL	JTDOOR			ELE	ECTRIC	AL D	√TA	
EQUIP TAG	AREA SERVED	MANUF.	CAPACITY (BTUH)	CAPACITY (BTUH)	MODEL	TYPE	DIME	NSIONS	S (IN.) H	CFM	MIN. ODA	EAT (°F DB)	EAT (°F WB)	HP	MO ⁻		VOLT	FILTER	MODEL	LOCATION	SIZE		MPRESSOR REFRIG. TYPE	FAT (°F)	MCA	МОСР	РН	VOLT	NOTE
DFSS-135	IT 135	CARRIER	24,000	24,000	DHMAHBQ24	HIGHWALL	47	10	13	870	0	80.0	67.0		0.63	1		CLEANABLE	38MARBQ24	ON	2	45.0	R-410A	95.0	25.0		1	208	1,2,3
DF55-146	IT/ELECTRICAL I 46	CARRIER	36,000	36,000	DHMAHBQ36	HIGHWALL	47	10	13	870	0	80.0	67.0	0.13	0.63	I	208	CLEANABLE	38MARBQ36	ON ROOF	3	45.0	R-410A	95.0	28.0	35	ı	208	1,2,3

		2. INDOOR UNIT POWERED FROM OUTDOOR UNIT.												LOW AMBIENT			•		R FOR OPERATIO	ON TO -20 DEG.	F.					
					2021 IN	NTERNATION <i>A</i>	AL MECHANICAL	CODE VEN	NTILATIOI	N SCHF	DULF															XHAL
						112111111111111111111111111111111111111		LOODL IL	**************************************	1100112		^AL V/FNTILATION	N (SECTION 403)						-	1	_			1		
			ROOM DATA		TILATION (SECTION		_						ZONE OUTSIDE AIR			l A	ACTUAL ROC	DM VENTILATION	EQUIP	LOCATION		SEDVED	MANUF	MODEL	TYPE	DF
				4	402)	ESTIMATE	D MAXIMUM OCCUPAN	T LOAD			ILAUIT	SEE NOTI		•			SUPPLY CFM		TAG	LOCATION	ANEA	SERVED	IVIAINOF	INIODEL		ا ا
ROOM	ROOM NAME	OCCUPANCY CLAGGIFICATION						ENTUDE					BREATHING		REQ'D	REQ'D		NOTES							CENTRIELICA	
NUMBER	ROOIVI IVAIVIL	OCCUPANCY CLASSIFICATION	AREA LOUINE	MINIMUM	ACTUAL	DEEALUT	7015	FIXTURE	CFM/	CFM/	EXHAUST	EXHAUST	ZONE	ZONE AIR	TOTAL	TOTAL	~ -		EF-103	ROOF	TOILET	103, 104	GREENHECK	. G-090-D	CENTRIFUGAL	
			(FT2) VOLUME	OPERABLE	OPERABLE	DEFAULT	ZONE	QUANTITY	PERSON	SQ.FT.	AIRFLOW RATE	AIRFLOW	OUTDOOR	DISTRIBUTION		E.A. CFM TOTAL	1 1				TOUET				DOWNBLAST	
			(AZ) (FT3)	AREA (FT2)		OCCUPANCY	POPULATION (RP)	REQUIREING	(RP)	(RA)	CFM/SQ.FT.	RATE PER	AIRFLOW RATE		CFM		O.A.	O.A.	EF-141	ROOF		141, 142,	GREENHECK	. G-099-A	CENTRIFUGAL	
								EXHAUST				FIXTURE	(VBZ)		(Voz)						JAI	N 204			DOWNBLAST	
100	GROUP STUDY	OFFICE SPACES	170 1530	6.8			4	-	5	0.06	-	-	30.2	1.0	30.2	- 290	33%	96 0 1	EF-202	ROOF	FLECTE	RICAL 202	GREENHECK	. G-095-D	CENTRIFUGAL	
102	CLASSROOM M. TOILET	CLASSROOMS (AGES 9 PLUS) TOILET ROOMS - PUBLIC	989 8901 245 2205	39.6		35	34	- Л	10	0.12	-	- 50	458.7	1.0	458.7	- 1410	33%	465 0 1	-	1.001		(10) (2 202			DOWNBLAST	
103	W. TOILET	TOILET ROOMS - PUBLIC	170 1530	6.8		-	-	2	-	-	-	<u> </u>	-	1.0	-	100 70	25%	18 150 1	NOTES:							
105	STUDENT LOUNGE/COLLABORATION	OFFICE SPACES	511 4599	20.4		3	12	-	5	0.06	-	-	90.7	1.0	90.7	- 520	34%	177 0 1	→ I	ACCEPTABLE M	ANUFACTI	JRERS: APPRO	OVED EQUAL	. 2. (GRAVITY BACKD	RAFT DA
105A	GROUP STUDY GROUP STUDY	OFFICE SPACES	137 1233	5.5			6	-	5	0.06	-	-	38.2	1.0	38.2	- 215	34%	73 0								
105B		OFFICE SPACES	137 1233	5.5			6	-	5	0.06	-	-	38.2	1.0	38.2	- 215	34%	73 0 1								
106	CONF. SBDC CONF	CONFERENCE ROOMS CONFERENCE ROOMS	284 2556 406 3654	11.4		14	10	-	5	0.06	-	-	67.0 94.4	1.0	67.0 94.4	- 500 - 430	25% 25%	125 0 1	-						Al ^r	R CO
108	OFFICE	OFFICE SPACES	139 1251	5.6			3	<u>-</u>	5	0.06	-	<u>-</u>	23.3	1.0	23.3	- 230	25%	58 0 1	-	1		<u> </u>	Ini			_
109	SBDC OFFICE	OFFICE SPACES OFFICE SPACES	148 1332	5.9		İ	3	-	5	0.06	-	-	23.9	1.0	23.9	- 155	25%	39 0 1					וטן	ISPLACEMEI CFM	CAP.	REC
110	COM ED OFFICE	OFFICE SPACES	137 1233	5.5			3	-	5	0.06	-	-	23.2	1.0	23.2	- 240	25%	60 0 1	EQUIP TAG	LOCATION	MANU	= MODEL	TYPE -		── SCFM AT	Г САР
112	ADMIN OFFICE	OFFICE SPACES	130 1170	5.2			3	-	5	0.06	-	-	22.8	1.0	22.8	- 215	25%	54 0 1	l lag					EACH TOTA	AL 100 PSIG	G (G
	ADMIN OFFICE SHAH OFFICE	OFFICE SPACES OFFICE SPACES	128 1152	5.1			3	-	5	0.06	-	-	22.7	1.0	22.7	- 240	25% 25%	60 0 1						OIVIP		
114	SHAH OFFICE	OFFICE SPACES	102 918 103 927	4.1			3	-	5	0.06	-	-	21.1	1.0	21.1	- 185	25%	46 0 1	AC-I	ELECTRICAL	POWFRE	X SES0308	SCROLL	1 8.8	8.8	
116	SHAH OFFICE	OFFICE SPACES	108 972	4.3			3	-	5	0.06	-	-	21.5	1.0	21.5	- 225	25%	56 0 1		202	1 OVVEIVE	X 3230300	JOROLL	1 0.0		
117	SHAH OFFICE	OFFICE SPACES	106 954 106 954	4.2			3	-	5	0.06	-	-	21.4	1.0	21.4	- 185	25%	46 0 1	NOTES:							
118	SHAH OFFICE	OFFICE SPACES	106 954	4.2			3	-	5	0.06	-	-	21.4	1.0	21.4	- 225	25%	56 0 1		THER ACCEPTAE	BLE MANUI	FACTURERS: A	APPROVED EC	QUAL.	6.	REFRIGE
119	SHAH OFFICE SHAH OFFICE	OFFICE SPACES OFFICE SPACES	10/ 963	4.3			3	-	5	0.06	-	-	21.4	1.0	21.4	- 185 - 225	25%	<u>46 </u>	- 2. UN	NIT SHALL HAVE	A SINGLE	POINT POWER	R CONNECTIO	ON.		AIR DRYI
121	SBDC OFFICE	UFFICE SPACES	118 1062	4.7			3	-	5	0.06	-	-	22.1	1.0	22.1	- 145	25%	36 0	-					LET PRESSURE.		DRYER IS
122	COM ED OFFICE	UFFICE SPACES LIBRARIES	120 1080	4.8		2	3	-	<u>5</u>	0.06	-	-	22.2 49.4	1.0	22.2 49.4	- 145 - 470	25%	36 0 1		NIT TO BE PROV						TIMER D
124	COM ED OFFICE	OFFICE SPACES	120 1080	4.8			3	-	5	0.06	-	-	22.2	1.0	22.2	- 145	25%	36 0	- I					HEDULE SOUND		WHEN C
125	CLASSROOM LIC OFFICE	CLASSROOMS (AGES 9 PLUS)	734 6606	29.4		26	25	-	10	0.12	-	-	338.1	1.0	338.1	- 1000	34%	340 0 1		VEL. SCHEDULE						REQUIRE
128	UC OFFICE	OFFICE SPACES OFFICE SPACES	120 1080	4.8			3	-	5	0.06	-	-	22.2	1.0	22.2	- 145 - 145	25%	36 0 1	- L							
129	UC OFFICE CLASSROOM	OFFICE SPACES OFFICE SPACES	121 1089	4.8			3	-	5	0.06	-	-	22.3	1.0	22.3	- 145	25%	36 0 1								
130	WORK RM	CLASSROOMS (AGES 9 PLUS) COPY PRINTING ROOMS	<u>393 3333 1089 </u>	25.0 4.8		0	25	-	5	0.12	0.5	-	3 <u>21.4</u> 17.3	1.0	17.3	60.5 225	25%	56 0 1	_							VAC
132	VIEW ROOM	COPY, PRINTING ROOMS OFFICE SPACES OFFICE SPACES	71 639	2.8		Ö	2	-	5	0.06	-	-	14.3	1.0	14.3	- 130	34%	44 0 1	<u> </u>				1	<u> </u>		
133	UC OFFICE NURSING SIM	CLASSROOMS (AGES 9 PLUS)	12/ 1143	<u>5.1</u> 125			5	-	10	0.06	-	-	22.6 87.4	1.0	87.4	- 150 - 340	34%	38 U I								И САР. 9" Нд
135	T_	l NONE '	129 1161	5.2				-					-	1.0	-	- 0	25%	0 0		QUIP LOCAT	TION M	ANUF MOI	DEL TYPE	E ORIENTA		
136	CONF. CLASSROOM	CONFERENCE ROOMS CLASSROOMS (AGES 9 PLUS)	<u>229 2061</u> 721 6489	9.2			10	-	5	0.06	-	-	63.7 336.5	1.0	63.7 330.5	- 370	34%	126 0 1	- '	AG					EACH PUMP	TOTA
138	NURSING SIM	CLASSROOMS (AGES 9 PLUS)	303 2727	12.1			5	-	10	0.12	-	-	86.4	1.0	86.4	- 340	34%	116 0 1	j						- FOIVIE	
140	VIEW ROOM	OFFICE SPACES	71 639	2.8		0	2	- /	5	0.06	-	- F0	14.3	1.0	14.3	- 130	34%	44 0	l v	P-I ELECTR		WEREX IVSO	ROTAR		JAL I	6.3
141	W. TOILET	TOILET ROOMS - PUBLIC	285 2565	10.4		-	-	<u>4</u> 6	-	-	-	<u> </u>	-	1.0	-	300 130	34%	41 300 1	i Li	202	2 1 0	***************************************	VANE			
143	TOILET	TOILET ROOMS - PUBLIC OFFICE SPACES	59 531	2.4		-	-		-	-	-	50	-	1.0	- 7	50 0	25%	0 150 1] NO	OTES:						
144	LACTATION KITCHEN	OFFICE SPACES DAY ROOM	62 558 343 3087	13.7		10	8	-	5	0.06	-	-	13.7	1.0	13./ 60.6	- 100	26%	34 U I	<u> </u>		EPTABLE N	//ANUFACTURE	RS: APPROV	/ED EQUAL.		
146	IT/ELECTRICAL	NONE	292 2628	11.7				-					-	1.0	-	- 0	25%	0 0	2.	UNIT SHALL						
147	CLASSROOM CLASSROOM	CLASSROOMS (AGES 9 PLUS)	703 6327	<u>28.1</u>		25 24	<u>25</u>	-	10	0.12	-	-	334.4 333.4	1.0	334.4 333.4	- 1300	26%	338 0	- L							
149	CLASSROOM CLASSROOM	CLASSROOMS (AGES 9 PLUS)	669 6021	26.8		23	25	-	10	0.12	-	-	330.3	1.0	330.3	- 1300	33%	429 0 1								
150A	CONFERENCE CONFERENCE	CONFERENCE ROOMS CONFERENCE ROOMS	875 7875	35.0		44	25	-	5	0.06	-	-	177.5	1.0	177.5	- 1170	25%	293 0							F	LEC
200	1 SPRINKTER	NONE	231 2079	9.2			25	-	5				- 1//.5	1.0	-	- 11/0	25%	0 0 1	-			OFNE	2.4.1			
202	ELECTRICAL	NONE	111 999	4.4				-					-	1.0	-	- <u>Ö</u>	25%	0 0 1	1			GENEF	KAL			
C001	JAN CORRIDOR	NUNE CORRIDORS	09 801 2464 3 22178 6	3.6 1 98.6				<u> </u>		0.06			147.9	1.0	- 47.9	- <u>U</u> - 2570	<u>25% </u> 25%	643 0 1	-	EQUIP	TAG	LOCATION	MANU	IF. MODEL	L TYPE/	, LE
<u> </u>	CORRIDOR	CORRIDORS CORRIDORS CORRIDORS CORRIDORS CORRIDORS	545.8 4912.2	21.8		-	-	-	-	0.06	-	-	32.7	1.0	32.7	- 350	25%	88 0							WATERIA	
C003 C004	CORRIDOR	COKKIDORS CORRIDORS	628./9 5659.11 1004.4 9039.15	25.2 40.2		-	-	-	-	0.06	-	-	37.7	1.0	3/.7 60 3	- 350	25% 34%	00 1 1 1 1 1 1 1 1 1	-	EFT-1	36	136 CONF.	MARKE	3700 L	ALUMINUM	1
C004 C005	CORRIDOR	CORRIDORS	1317.9 11860.65	5 52.7			-	<u>-</u>	-	0.06		<u>-</u>	79.1	1.0	79.1	- 490	25%	123 0]					SERIES	BASEBOAR	<u>) </u>
V001	VESTIBULE VESTIBULE	NONE NONE	<u>284</u> <u>2556</u>	11.4				-					-	1.0	-	- 430	25%	108 0 1	-	NOTES:						
V002 V003	VESTIBULE	NONE	219 1971	8.8				-					-	1.0	-	- 143	25%	0 0 1	1	I. OTH	IER ACCEP	TABLE MANUF	ACTURERS: 1	APPROVED EQL	JAL.	

NOTES:

I. COORDINATED WITH TABLE 403.3.
2. CODE MET BY NATURAL VENTILATION.

	EXHAUST FAN SCHEDULE																
EQUIP	IIP SP							SP MAX.			МО		CONTROL				
TAG	LOCATION	AREA SERVED	MANUF	MODEL	TYPE	DRIVE	CFM	(IN.)	SONES	FAN RPM	ВНР	HP	RPM	PH	VOLT	TYPE	NOTES
EF-103	ROOF	TOILET 103, 104	GREENHECK	G-090-D	CENTRIFUGAL DOWNBLAST	DIRECT	450	0.50	7.4	1550	0.08	0.07	1750	I	120	BAS	1,2,3
EF-141	ROOF	TOILET 141, 142, JAN 204	GREENHECK	G-099-A	CENTRIFUGAL DOWNBLAST	DIRECT	950	0.50	12.7	1725	0.24	0.25	1750	ı	120	BAS	1,2,3
EF-202	ROOF	ELECTRICAL 202	GREENHECK	G-095-D	CENTRIFUGAL DOWNBLAST	DIRECT	555	0.50	9.5	1550	0.12	0.13	1750	ı	120	T-STAT	1,2,3
NOTES:		_															

OTHER ACCEPTABLE MANUFACTURERS: APPROVED EQUAL. 2. GRAVITY BACKDRAFT DAMPER, DISCONNECT SWITCH, BIRDSCREEN, AND UL705 RATING. 3. 24" ROOF CURB WITH SEAL.

	AIR COMPRESSOR SCHEDULE															
EQUIP	LOCATION		MODEL			CEMENT FM		RECEIVER		SOUND		ELECTRICAL				NOTEO
TAG	LOCATION	MANUF	MODEL	TYPE	EACH	TOTAL	100 PSIG	CAPACITY (GAL.)	OUTPUT	LEVEL (dbA)	FURNISHED	AND INSTALLED BY	HP	ДЦ	VOLT	NOTES
					PUMP	IOIAL	1001010	(3,712.)		(0.07 1)	DISCONNECT	CONTROLLER/STARTER	1 11	1 11	VOLI	
AC-1	ELECTRICAL 202	POWEREX	SES0308	SCROLL	ı	8.8	8.8	13	7635	49	ELECTRICAL CONTRACTOR	MANUFACTURER	3	3	208	1,2,3,4,5,6
NOTES:											CONTRACTOR					

6. REFRIGERATED AIR DRYER TO BE PROVIDED BY COMPRESSOR MANUFACTURER. REFRIGERATED COMPRESSED AIR DRYER RATED FOR 10 SCFM, NON-CYCLING, DIRECT EXPANSION, R-134A REFRIGERANT, CFC FREE. THE DRYER IS SELFREGULATING FOR LARGE LOAD SWINGS AND HAS AN INTEGRAL MOISTURE SEPARATOR WITH AUTO TIMER DRAIN, ISOLATION VALVE/ STRAINER, DEWPOINT VERIFICATION, AND ON/OFF SWITCH THAT ILLUMINATES WHEN COMPRESSOR IS IN OPERATION. UNIT TO BE PROVIDED WITH MANUFACTURER WALL MOUNT. ELECTRICAL REQUIREMENTS - 120 VAC, HARD-WIRED. ACCEPTABLE MANUFACTURERS: SPX (HPR5-10) OR APPROVED EQUAL.

4. UNIT TO BE PROVIDED WITH SET-POINT CONTROL OPTION.

	VACUUM PUMP SCHEDULE															
EQUIP	LOCATION		MODEL	TVDE	ODIENITATIONI	SCFM AT 1	1 CAP. 9" Hg	RECEIVER	BTUH	SOUND		ELECTRICAL				NOTE
TAG	LOCATION	MANUF	MODEL	IYPE	ORIENTATION	EACH	TOTAL	CAPACITY (GAL.)	OUTPUT	LEVEL (dbA)	FURNISHED	AND INSTALLED BY	ΠР	ДЦ	VOLT	NOTES
						PUMP	IOTAL	(G/ (L.)		(4671)	DISCONNECT	CONTROLLER/STARTER		ГΠ	VOLT	
VP-I	ELECTRICAL 202	POWEREX	IV50151	ROTARY VANE	HORIZONTAL	I	6.3	30	3200	59	ELECTRICAL CONTRACTOR	MANUFACTURER	1.5	3	208	1,2,3,4
NOTES:	NOTES: I. OTHER ACCEPTABLE MANUFACTURERS: APPROVED EQUAL. 3. UNIT TO BE PROGRAMMED AND SET TO 19" HG OUTLET PRESSURE.															

ELECTRIC FINNED TUBE SCHEDULE														
	GENERA	\L				ENCLOS	SURE			ELEM	1ENT			
EQUIP TAG	LOCATION	MANUF.	MODEL	TYPE/ MATERIAL	LENGTH	HEIGHT	WIDTH	MOUNTING HEIGHT (MIN. AFF)	WATTS	CAPACITY (BTUH)	AMP	PH	VOLT	NOTES
EFT-136	136 CONF.	MARKEL	3700 SERIES	ALUMINUM BASEBOARD	72"	9"	3"	6"	1,500	5,118	12.5	ı	120	1,2,3,4

FIELD MEASURE ALL LENGHTS PRIOR TO FABRICATION. COLOR FINISH TO BE SELECTED BY ARCHITECT.

PROVIDE 6" CONTROL SECTION, END TRIMS, AND END CLOSURES.

. TAMPER-PROOF BUILD-IN DISCONNECT SWITCH AND INTEGRAT THERMOSTAT.

DIFFUSER, REGISTER, AND GRILLE SCHEDULE										
TAG	MANUFACTURER	MODEL	TYPE	NOMINAL FACE SIZE	MATERIAL	MAX. N.C.	NOTES			
Α	TITUS	OMNI	SQUARE PANEL FACE	24"x24"	STEEL	30	1,2			
В	TITUS	300R	DOUBLE DEFLECTION SUPPLY REGISTER	VARIES	STEEL	30	1,2,3			
С	TITUS	50F	EGG CRATE	VARIES	ALUMINUM	30	1,4			
D	TITUS	350R	35 DEG. DEFLECTION GRILLE	VARIES	STEEL	30	1,2,3			
E	TITUS	TBDI-80	LINEAR INSULATED BOOT	48 IN LONG	STEEL	30	1,5			
F	ACUTHERM	TF/HC	HEATING/COOLING THERMAFUSER	24"x24"	STEEL	30	I			
NOTES:			FLOOR PLAN TA	C LECEND.						

<u>FLOOR PLAN TAG LEGEND:</u>

OTHER ACCEPTABLE MANUFACTURERS: APPROVED EQUAL.

REQUIRED.

FINISH AS SELECTED BY ARCHITECT. 'S'=SUPPLY---OPPOSED BLADE DAMPER. 'R'=RETURN/RELIEF 1/2"x1/2"x1" OR 1/2"x1/2"x1/2" W/ 45 DEG. 'E'=EXHAUST DEFLECTION GRID. EQUIPMENT TAG-

5. (2) I "SLOTS, PROVIDE CENTER NOTCH WHERE

----NECK SIZE (IN.)

	ELECTRIC CABINET UNIT HEATER SCHEDULE																
						CABINET		CAE	INE	T DIMEN	ISIONS	FILTER	ELECTI	RICAL	DATA	4	
EQUIP TAG	LOCATION	MANUF.	MODEL	TYPE	CFM	ARRANGEMENT	L	W	Н	PROJ.	MOUNTING HEIGHT	TYPE	HEATER kW	AMP	PH	VOLT	NOTES
ECUH-VOO I	VESTIBULE VOO I	MARKEL	6300 "T" SERIES	FULLY RECESSED CEILING	500	BOTTOM FRONT IN, TOP FRONT OUT	46"	9"	25"	0"	CEILING	1/2 IN PERM.	10	33	3	208	1,2,3
NOTES:	<u>OTES:</u> . OTHER ACCEPTABLE MANUFACTURERS: APPROVED FQUAL. 3. DISCONNECT SWITCH, 24V RELAY AND TRANSFOMER, FAN DELAY SWITCH.																

MOUNTING KIT TO MATCH MOUNTING REQUIREMENTS

OTHER ACCEPTABLE MANUFACTURERS: APPROVED EQUAL. 3. DISCONNECT SWITCH, 24V RELAY AND TRANSPOMER, FAN DELAY SWITCH.

ELECTRIC CEILING HEATER SCHEDULE											
	GE	NERAL			FAN [DATA	ELECT	RICAL	DATA	1	NOTE
EQUIP TAG	LOCATION	MANUF.	MODEL	TYPE	TYPE	CFM	HEATER kW	AMP	PH	VOLT	NOTE
ECH-VOO2	VESTIBULE VOO2	MARKEL	3480 SERIES	RECESSED MOUNTED	PROP.	600	2.0	9.6	l	208	1,2,3
NOTES:											

OTHER ACCEPTABLE MANUFACTURERS: APPROVED EQUAL. MOUNTING KIT TO MATCH MOUNTING REQUIREMENTS.

DISCONNECT SWITCH, 24V RELAY AND TRANSFOMER, FAN DELAY SWITCH.

ELECTRIC WALL HEATER SCHEDULE												
		GEI	NERAL			FAN DATA		ELECT	RICAL	DATA	١	NOTES
I	EQUIP TAG	LOCATION	MANUF.	MODEL	TYPE	TYPE	CFM	HEATER kW	AMP	PH	VOLT	NOTES
	EWH-201	STORAGE 201	MARKEL	3420 SERIES	RECESSED WALL	PROP.	245	2.0	9.6	ı	208	1,2,3
	EWH-203	STORAGE 203	MARKEL	3420 SERIES	RECESSED WALL	PROP.	245	2.0	9.6	ı	208	1,2,3
	EWH-COO I	CORRIDOR 001	MARKEL	3420 SERIES	RECESSED WALL	PROP.	245	2.0	9.6	ı	208	1,2,3

OTHER ACCEPTABLE MANUFACTURERS: APPROVED EQUAL.

DISCONNECT SWITCH, FAN RELAY SWITCH, AND TAMPER-PROOF BUILT-IN THERMOSTAT.

MOUNTING KIT TO MATCH MOUNTING REQUIREMENTS.

ARCHITECT OF RECORD DEMONICA KEMPER ARCHITECTS 125 N. HALSTED STREET, SUITE 301 **CHICAGO, IL 60661** P: 312.496.0000

MEP-FP-T-ENGINEERS 20/10 ENGINEERING GROUP, LLC 1216 TOWER ROAD SCHAUMBURG,IL 60173

P: 847.882.2010 F: 847.882.2201 CIVIL ENGINEERS **HRG GREEN** 1391 CORPORATE DRIVE, SUITE 203 MCHENRY ,IL 60050

P:815.385.1778 F:815.385.1781

KEY PLAN:


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SHEET TITLE: **HVAC SCHEDULES**

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1 FIRE PROECTION DEMOLITION PLAN

1/8" = 1'-0"



ARCHITECT OF RECORD

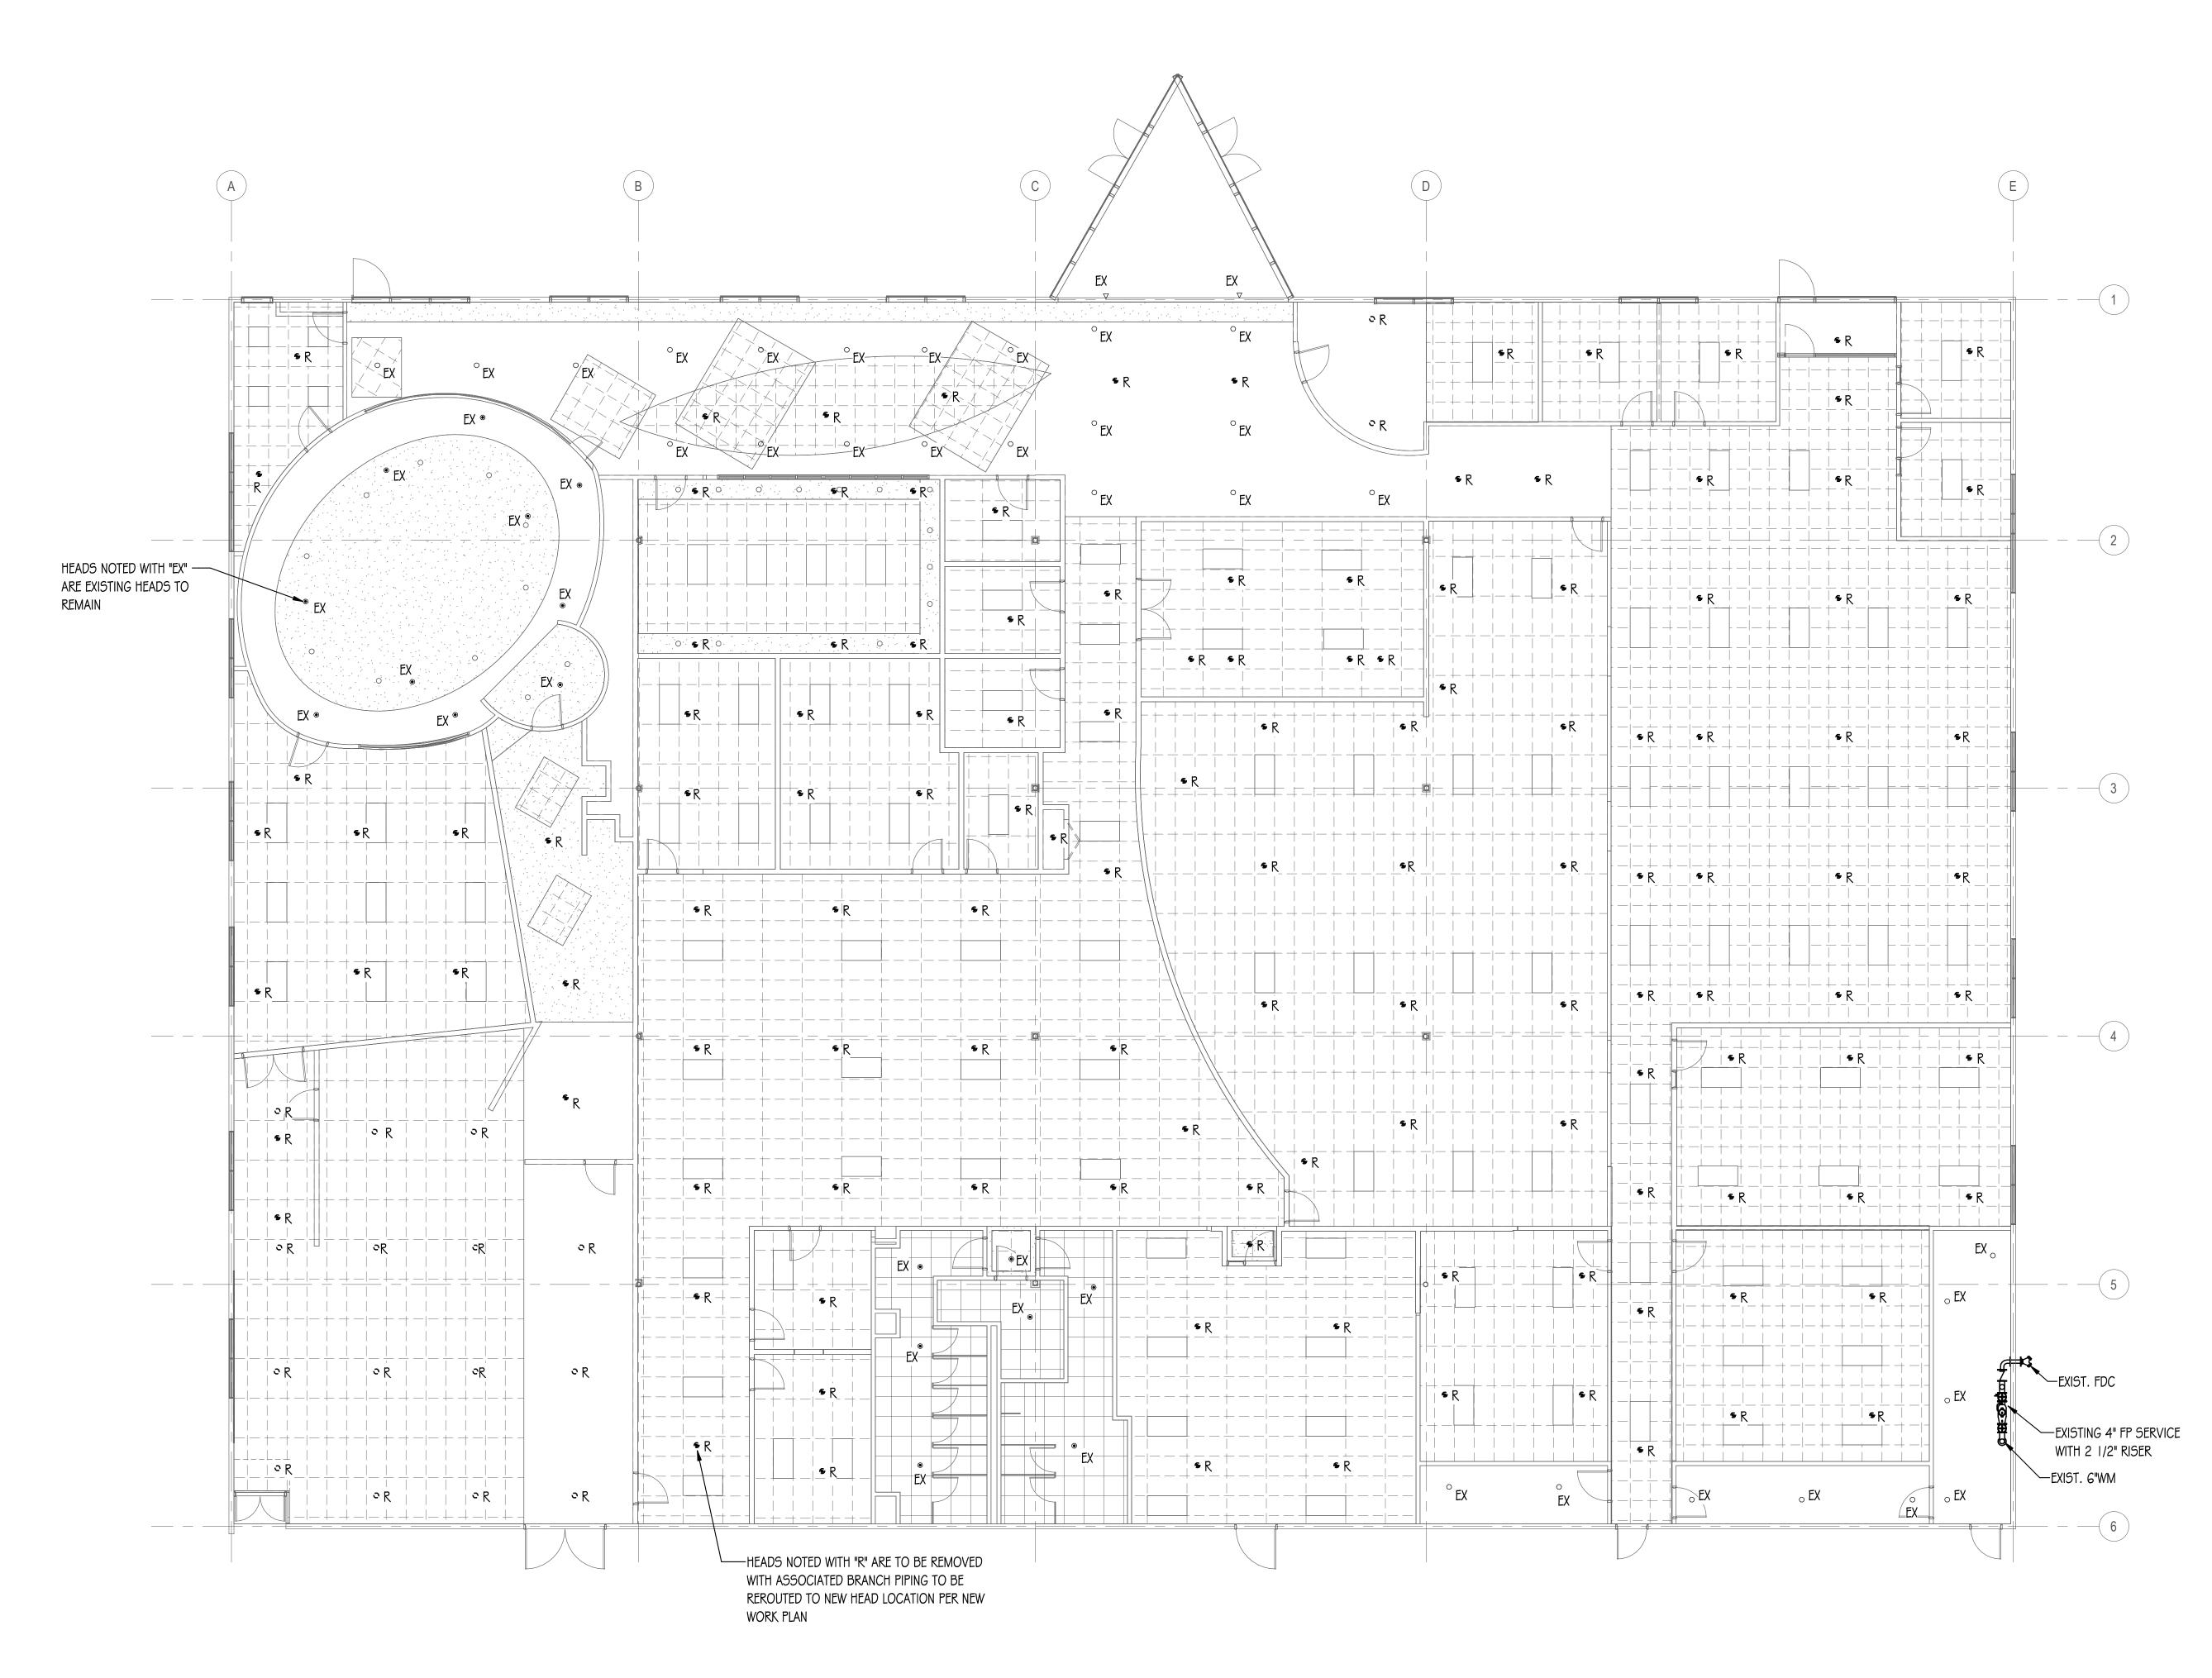DEMONICA KEMPER ARCHITECTS

125 N. HALSTED STREET, SUITE 301

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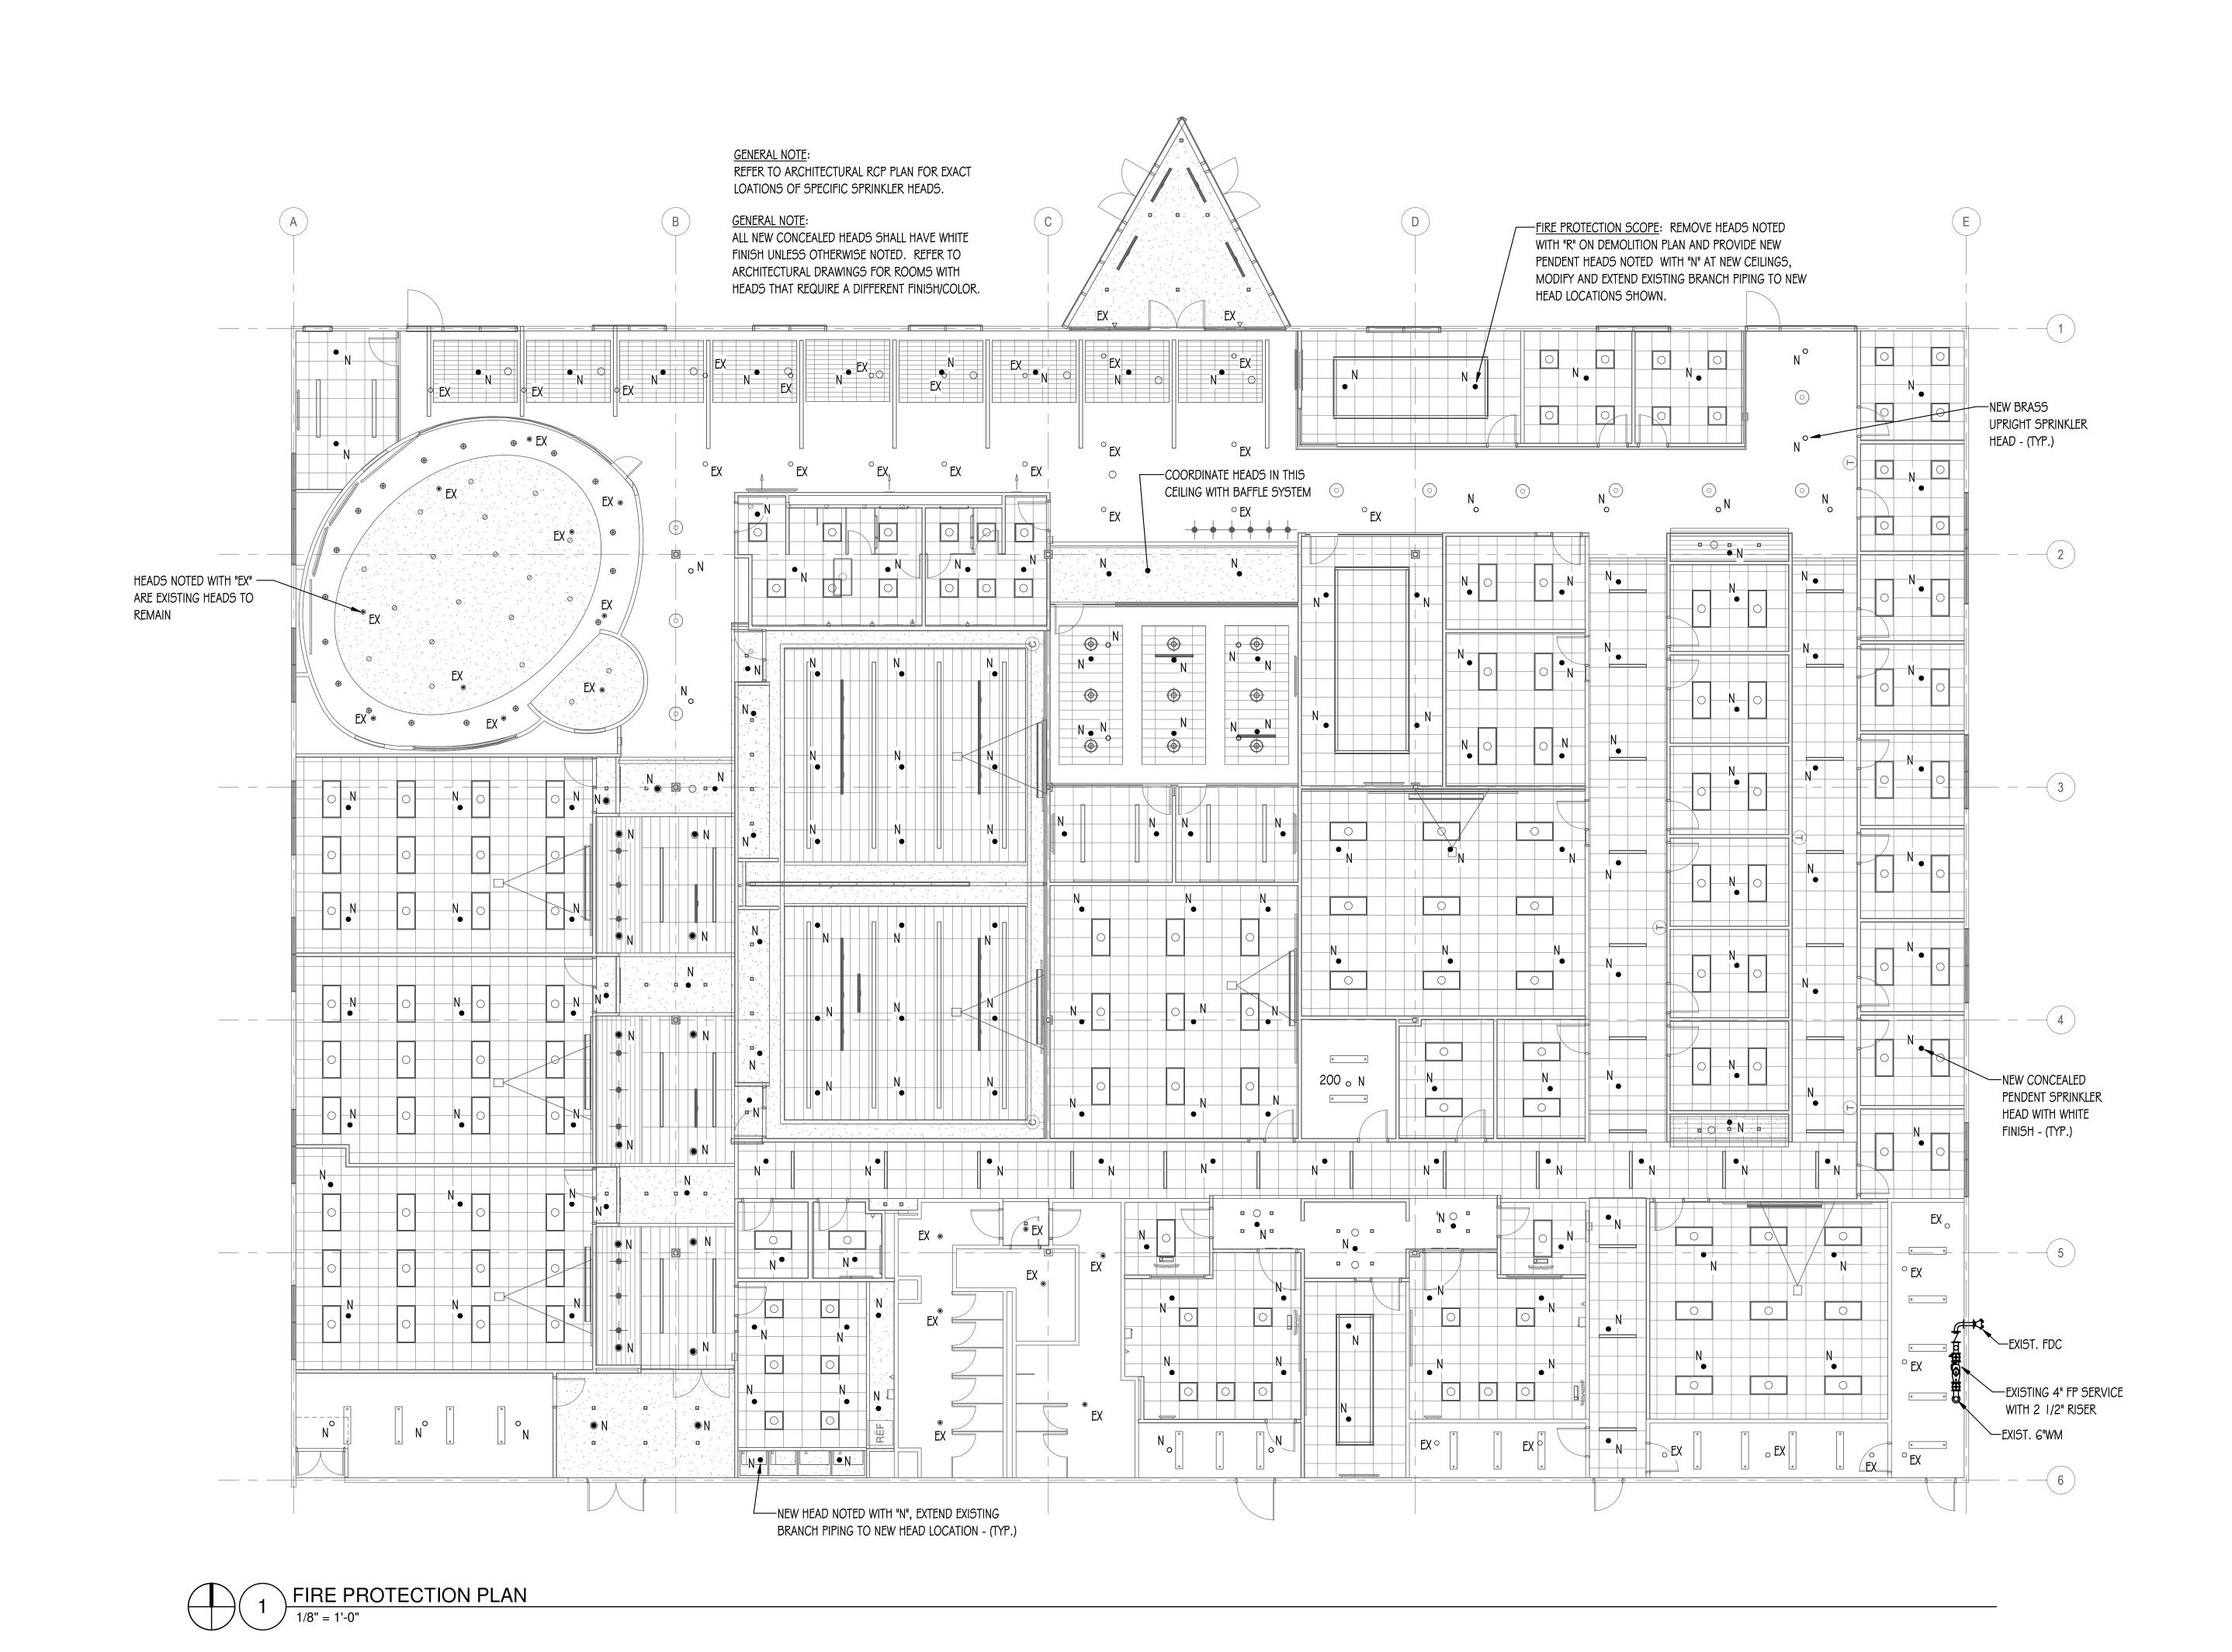
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FIRE PROTECTION
DEMOLITION PLAN

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KEY PLAN:

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FIRE PROTECTION
PLAN

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GENERAL NOTES - FIRE PROTECTION:

- **GENERAL**
- 1.1 SYSTEM TO PROVIDE COVERAGE FOR BUILDING AREAS NOTED. SYSTEMS SHALL CONFORM TO THE DESIGN CRITERIA REQUIRED BY NFPA-13 AND THE LOCAL AUTHORITY HAVING JURISDICTION. WORKING PLANS AND CALCULATIONS SHALL BE SUBMITTED TO LOCAL APPROVAL AGENCIES AND TO OWNERS FIRE PROTECTION CONSULTANT FOR APPROVAL.
- 1.2 ALL WORK SHALL BE INSTALLED AND ALL MATERIALS SHALL BE IN STRICT ACCORDANCE WITH ALL APPLICABLE RULES AND REGULATIONS OF NFPA-13, 20 EDITION AND ALL LOCAL AMENDMENTS.
- 1.3 CONTRACTOR SHALL BE RESPONSIBLE FOR OBTAINING ALL NECESSARY PERMITS AND THEIR
- 1.4 IT SHALL BE THE CONTRACTOR'S RESPONSIBILITY TO COORDINATE ALL INSPECTIONS WITH THE LOCAL AUTHORITY HAVING JURISDICTION.
- 1.5 DRAWINGS ARE GENERALLY DIAGRAMMATIC. ROUTING OF PIPING, ETC., AS SHOWN ON DRAWINGS DOES NOT INTEND TO SHOW EVERY RISE, DROP, OFFSET, FITTING NOR EVERY STRUCTURAL ELEMENT THAT MAY BE ENCOUNTERED DURING THE INSTALLATION OF THIS WORK. CONTRACTOR SHALL MAKE ANY REQUIRED CHANGES FROM THE GENERAL ROUTING SHOWN ON THESE DRAWINGS, SUCH AS OFFSETS, BENDS OR CHANGES IN ELEVATION DUE TO COORDINATION WITH THE WORK OF OTHER TRADES AND BUILDING CONSTRUCTION. ALL CHANGES SHALL BE MADE WITHOUT ADDITIONAL COST TO THE OWNER OR DELAY IN COMPLETION DATE OF THE PROJECT.
- 1.6 ALL EXISTING PIPING INFORMATION SHOWN ON THIS DRAWING HAS BEEN OBTAINED FROM OWNER'S EXISTING CONSTRUCTION DOCUMENTS AND LIMITED FIELD SURVEY. EXACT LOCATION OF EXISTING SPRINKLER SYSTEM COMPONENTS SHALL BE FIELD VERIFIED BEFORE STARTING INSTALLATION.
- 1.7 THE CONTRACTOR SHALL BE RESPONSIBLE DURING THE INSTALLATION AND TESTING PERIODS OF THE FIRE SPRINKLER SYSTEM WORK, FOR ANY MATERIAL DAMAGE TO THE WORK OF THE OWNER OR OTHERS, AND TO THE PROPERTY AND MATERIALS OF THE OWNER OR OTHERS, INCLUDING CEILING SPRINKLER TILES, AND INCLUDING DAMAGE CAUSED BY GREASE, OIL, OR LEAKS IN SPRINKLER EQUIPMENT, FITTINGS, OR BY DISCONNECTED PIPES.
- 1.8 THE CONTRACTOR SHALL REVIEW THE DRAWINGS OF ALL OTHER TRADES INCLUDING BUT NOT LIMITED TO ARCHITECTURAL, STRUCTURAL, HVAC, PLUMBING AND ELECTRICAL AS TO REVIEW FOR ADDITIONAL AREAS AND ASPECTS OF THE REQUIRED SPRINKLER DESIGN NOT SHOWN. CONTRACTOR SHALL VERIFY THE SPRINKLER REQUIREMENTS OF ALL SKYLIGHTS, CEILING POCKETS, FLOATING CEILINGS, CEILING ELEVATIONS, CEILING TYPES AND CONSTRUCTION, ATTIC SPACES, OVERBUILD ATTIC SPACES, STAIRCASE AND STAIRCASE LANDINGS, ELECTRICAL ROOMS, LIGHT FIXTURES, DUCTWORK, FURNITURE, AND OTHER OBSTRUCTIONS BY ARCHITECTURAL AND STRUCTURAL COMPONENTS. CONTRACTOR SHALL PROVIDE ALL REQUIRED SPRINKLER COVERAGE TO ADDRESS SUCH BUILDING CHARACTERISTICS.

HAZARD CLASSIFICATIONS AND HYDRAULIC CALCULATIONS

- 2.1 CONTRACTOR SHALL VERIFY EXISTING AVAILABLE FLOW DATA WITH MUNICIPALITY AND FIELD CONDITIONS. CONTRACTOR TO CONTACT ARCHITECT/ENGINEER AND LOCAL MUNICIPALITY 48 HOURS PRIOR TO FLOW TEST.
- 2.2 FINAL HYDRAULIC CALCULATIONS ARE THE SOLE RESPONSIBILITY OF THE CONTRACTOR, ANY PIPE SIZING SHOWN ON THE DRAWINGS REFLECT SCHEMATIC DESIGN AND ARE SHOWN FOR SUPPOSITIONAL PURPOSES IN THE FIRE PROTECTION SYSTEM(S) LAYOUT.
- 2.3 CONTRACTOR SHALL REVIEW ALL FLOOR PLANS AND DETERMINE EACH ROOM SPECIFIC HAZARD PER THE REQUIREMENTS OF NFPA-13. SPRINKLER DESIGN SHALL ADHERE TO THE STANDARDS SET
- 2.4 LIGHT HAZARD AREAS SHALL BE DESIGNED TO 0.10 GPM PER SQUARE FOOT, 225 SQ.FT PER HEAD WITH A REMOTE AREA OF 1500 SQUARE FEET. AN AREA OF LESS THAN 1,500 SQUARE FEET MAY BE PERMITTED WHEN THE USE OF QUICK RESPONSE HEADS QUALIFIES FOR AN AREA REDUCTION. AREA SIZES SHALL BE DETERMINED BY THE REGULATIONS OF NFPA-13. ROOM TYPES SHALL INCLUDE BUT NOT BE LIMITED TO CLASSROOMS. TOILET ROOMS. CORRIDORS. VESTIBULES. MULTI-PURPOSE ROOMS, STAIRWAYS, EXAM ROOMS, OFFICE SPACES, ETC.
- 2.5 ORDINARY HAZARD GROUP 1 AREAS SHALL BE DESIGNED TO 0.15 GPM PER SQUARE FOOT. 130 SQ.FT PER HEAD WITH A REMOTE AREA OF 1,500 SQUARE FEET. ROOM TYPES SHALL INCLUDE BUT NOT BE LIMITED TO STORAGE ROOMS, ELECTRICAL ROOMS, MECHANICAL ROOMS, BOILER ROOM. SERVER ROOMS, ETC.

PIPE HANGERS AND SUPPORTS

- 3.1 ALL FIRE PROTECTION PIPING SHALL BE SUSPENDED WITH APPROVED/LISTED PIPE HANGERS IN COMPLIANCE WITH NFPA STANDARDS. CUTTING STRUCTURAL MEMBERS TO RUN PIPING, OR TO FACILITATE HANGER FASTENING IS NOT PERMITTED.
- 3.2 VERTICAL ATTACHMENT TO METAL DECK AND WOOD TRUSS'S SHALL NOT BE PERMITTED. HORIZONTAL ATTACHMENT TO WOOD TRUSS SHALL BE MADE BY HORIZONTAL SUPPORT TO BOTTOM CORD OF TRUSS.

SPRINKLER SYSTEM COMPONENTS AND ACCESSORIES

- 4.1 FIRE PROTECTION SYSTEM SHALL INCLUDE ALL ITEMS FOR A COMPLETE SYSTEM. SPECIFICALLY THIS IS TO INCLUDE BUT NOT LIMITED TO: PIPE SUPPORTS, VALVES, GAUGES, TRIM, ALARMS, SPECIALTY DEVICES, CONTROLS, AND ITEMS INCIDENTAL TO A COMPLETE SYSTEM.
- 4.2 EACH INSPECTOR'S TEST CONNECTION SHALL HAVE AN INSPECTOR'S TEST CONNECTION SIGN ATTACHED THERETO.
- 4.4 A FLOW DATA PLACARD SHALL BE PROVIDED FOR EACH HYDRAULICALLY CALCULATED REMOTE AREA. PLACARDS SHALL BE PROVIDED ON EACH SYSTEM RISER. FLOW DATA SHALL BE PROFESSIONALLY PRINTED WITH PERMANENT MEANS. HAND WRITTEN WITH PERMANENT MARKER ON LABEL SHALL NOT BE PERMITTED.
- 4.5 INSPECTORS TEST DRAIN AND MAIN DRAIN SHALL BE ROUTED THRU THE EXTERIOR WALL AND SPILL TO GRADE. IN CONDITIONS WHERE THIS IS NOT POSSIBLE, INSPECTORS TEST AND MAIN DRAIN SHALL BE ROUTED TO AN APPROVED INTERIOR OPEN SITE DRAIN AS APPROVED ARCHITECT AND ENGINEER.
- 4.6 AUXILIARY DRAINS AND SIGNS SHALL BE PROVIDED AT THE LOW POINT OF EACH TRAPPED SECTION OF PIPING AND IDENTIFYING SIGNS SHALL BE ATTACHED THERETO. INSTALL ALL AUXILIARY DRAIN VALVES IN ACCESSIBLE AREAS. FIELD COORDINATE LOCATIONS WITH ARCHITECT/OWNER PRIOR TO INSTALLATION.
- 4.7 THE INTERCONNECTION OF THE ALARM SUPERVISORY SIGNALS MUST BE APPROVED BY THE PROPER ALARM REPRESENTATIVE. AND WORKING PLANS INDICATING THE LOCATIONS OF ALL ELECTRICAL COMPONENTS SHALL BE FURNISHED TO THE FIRE ALARM CONTRACTOR.

- 4.8 A SPARE HEAD CABINET WITH THE APPROPRIATE NUMBER OF SPARE HEADS BY TYPE USED ON THIS PROJECT AND A HEAD WRENCH SHALL BE INSTALLED ADJACENT TO THE RISER PER NFPA-13 SECTION 6.2.9.
- 4.9 CONTRACTOR SHALL PROVIDE ALL MEANS TO SHUT-DOWN EXISTING PIPING SYSTEMS WHERE REQUIRED TO COMPLETE WORK UNDER THIS CONTRACT. CONTRACTOR SHALL PROVIDE ALL NECESSARY VALVES TO ISOLATE RENOVATED SECTIONS OF THE BUILDING WITHOUT DISTURBING SECTIONS OF THE BUILDING NOT UNDER RENOVATION.
- 4.10 INSTALL VALVES WITH STEMS UPRIGHT OR HORIZONTAL, NOT INVERTED.
- 4.11 PROVIDE ACCESS TO ALL VALVES AND SYSTEM COMPONENTS REQUIRING ACCESS. ALL PIPING ACCESSORIES AND EQUIPMENT SUCH AS VALVES SHALL BE INSTALLED AT A REASONABLE HEIGHT AND POSITION IN ORDER TO FACILITATE MAINTENANCE.

SPRINKLER HEADS

- 5.1 ALL SPRINKLER HEADS SHALL BE LOCATED IN THE CENTER OF 2x2 TILE OR QUARTER POINT OF 2x4 CEILING TILE UNLESS OTHERWISE NOTED OR DIRECTED BY THE ARCHITECT/ENGINEER OR LOCAL FIRE DEPARTMENT AUTHORITIES.
- 5.2 SPRINKLER HEADS IN FINISHED CEILING SHALL BE SEMI-RECESSED OR CONCEALED. TYPE AS INDICATED ON DRAWINGS. QUICK RESPONSE, WHITE PENDENT WITH ESCUTCHEON, K=5.6, 155 DEGREE UNLESS OTHERWISE NOTED. OPTION FOR QUICK RESPONSE SPRINKLERS ALLOWED WHERE PRESSURE PERMITS.
- 5.3 SPRINKLER HEADS IN NON-CEILING AREAS SHALL BE BRASS UPRIGHT. STANDARD RESPONSE, K=5.6, 155 DEGREE UNLESS OTHERWISE NOTED. OPTION FOR QUICK RESPONSE SPRINKLERS ALLOWED WHERE PRESSURE PERMITS.
- 5.5 SPRINKLER HEADS LOCATED WITHIN MECHANICAL ROOMS, SAUNA, STEAM, SPA ROOMS SHALL BE RATED FOR 212 DEGREES.
- 5.7 ALL SPRINKLER HEADS BELOW 7'-0" FEET OR IN MECHANICAL ROOMS, STORAGE ROOMS, GYMNASIUMS OR IN AREAS SUBJECTED TO MECHANICAL INJURY SHALL HAVE AN APPROVED HEAD GUARD.
- 5.8 CONTRACTOR SHALL PROVIDE ADDITIONAL SPRINKLER HEADS ABOVE AND BELOW MECHANICAL/ ELECTRICAL DUCTS AND EQUIPMENT WHICH EXCEEDS 48 INCHES IN WIDTH
- 5.9 SPRINKLER HEADS SHOWN ARE MINIMUMS. CONTRACTOR SHALL PROVIDE ADDITIONAL HEADS AS REQUIRED TO COORDINATE WITH ARCHITECTURAL REFLECTED CEILING PLANS OR TO PROVIDE ADEQUATE COVERAGE AS SPECIFIED OR REQUIRED BY APPROPRIATE HAZARD CLASS.

FIRE PROTECTION (SPRINKLER) PIPING

- 6.1 MINIMUM PIPE SIZE SHALL BE 1 INCH. ANY REDUCING OF SIZE SHALL OCCUR AT SPRINKLER HEAD CONNECTION.
- 6.2 SPRINKLER PIPING SHALL NOT BE INSTALLED DIRECTLY OVER ANY ELECTRICAL EQUIPMENT PANELS, TELEPHONE OR LOW VOLTAGE EQUIPMENT OR SIMILAR TYPE OF EQUIPMENT.
- 6.3 ALL PIPE AND FITTINGS SHALL BE INSTALLED IN RUST-FREE CONDITION.
- 6.4 THE USE OF THREADED BUSHINGS WILL NOT BE PERMITTED IN ANY AREA OF THIS
- 6.5 ALL PIPING AND COMPONENTS NECESSARY FOR INSTALLATION MAY BE PREFABRICATED. HOWEVER, THE CONTRACTOR MUST BE WILLING TO REWORK THE PREFABRICATED PIPE. FITTINGS, AND THE LIKE, AS NECESSARY TO CONSTITUTE A PROPER APPROVED INSTALLATION. EXISTING SITE CONDITIONS NOTWITHSTANDING, AT NO ADDITIONAL COST TO THE OWNER.
- 6.6 ALL NEW PIPING SHALL BE HYDROSTATICALLY TESTED @ 200 PSI FOR NO LESS THAN 2 HOURS. THE FIRE DEPARTMENT SHALL BE NOTIFIED (NO LESS THAN 48 HOURS PRIOR) OF THE DATE AND TIME OF THE TEST AND MAY WITNESS IT IF SO DESIRED OR REQUIRED.
- 6.7 ALL PIPING PASSING THRU' FLOOR CONSTRUCTION SHALL HAVE A SCHEDULE 40 STEEL PIPE SLEEVE INSTALLED AROUND PIPE ONLY. ALL PIPE PASSING THRU WALLS SHALL HAVE A GALVANIZED SHEET METAL OR SCHEDULE 40 STEEL PIPE SLEEVE INSTALLED AROUND THE PIPE. ALL EXPOSED PIPE WHICH PASSES THROUGH A WALL OR CEILING SHALL BE EQUIPPED WITH AN ESCUTCHEON PLATE.
- 6.8 ALL PIPING SHALL BE INSTALLED TO ALLOW FOR PROPER DRAINING OF ENTIRE SYSTEM PER NFPA-13.
- 6.9 SCREWED UNIONS SHALL NOT BE PERMITTED ON PIPING LARGER THAN 1 1/2 INCHES.
- 6.10 ALL NEW CONNECTIONS MADE TO AN EXISTING SYSTEM MAIN SHALL BE ACCOMPLISHED WITH A CUT-IN OR TEE FITTING OF EQUAL SIZE TO THAT OF THE EXISTING MAIN.
- 6.11 FIRE PROTECTION PIPING SHALL BE AS FOLLOWS:
 - A. (1"-6") STEEL PIPE: ASTM A795; SCHEDULE 40, BLACK STEEL FITTINGS: ASME B16.5, STEEL FLANGES AND FITTINGS. CAST IRON FITTINGS: ASME 16.1, FLANGES AND FLANGED FITTINGS: OR ASME B16.4, THREADED FITTINGS. MALLEABLE IRON FITTINGS: ASME B16.3, THREADED FITTINGS
- B. (2 1/2"-6") STEEL PIPE: ASTM A795; SCHEDULE 40, BLACK. GROOVED END FITTINGS: ASTM A536 DUCTILE IRON HOUSING TO ENGAGE AND LOCK. MECHANICAL GROOVED COUPLINGS: DUCTILE IRON HOUSING CLAMPS TO ENGAGE AND LOCK, "C" SHAPED ELASTOMERIC SEALING GASKET, STEEL BOLTS, NUTS, AND WASHERS.
- C. (1 1/4"-6") STEEL PIPE: ASTM A135, SCHEDULE 10, BLACK. STEEL FITTINGS: ASME B16.5, STEEL FLANGES AND FITTINGS. GROOVED END FITTINGS: ASTM A536 DUCTILE IRON HOUSING TO ENGAGE AND LOCK. MECHANICAL GROOVED COUPLINGS: DUCTILE IRON HOUSING CLAMPS TO ENGAGE AND LOCK, "C" SHAPED ELASTOMERIC SEALING GASKET, STEEL BOLTS, NUTS, AND WASHERS.


PIPE AND VALVE IDENTIFICATION

7.1 PROVIDE PIPE LABELING IDENTIFICATION PER ASME A13.1. SEE DETAIL FOR ADDITIONAL INFORMATION. PIPE LABELS SHALL BE WRAP AROUND TYPE. SELF ADHESIVE TYPE SHALL NOT BE PERMITTED.

FIRE STOP SYSTEMS 7.2 GENERAL PURPOSE FIRE STOPPING SEALANT SHALL BE DOW CORNING, NELSON OR 3M COMPANY; WATER BASED. NON SLUMPING. PREMIXED SEALANT WITH INTUMESCENT PROPERTIES. RATED FOR 3 HOURS PER ASTM E814, NFPA AND UL-1479. FILL ALL VOIDS AROUND ALL PIPING PENETRATIONS THROUGH WALLS AND CEILINGS WITH A MINIMUM 1 HOUR FIRE RATING. PROVIDE PVC COLLAR ASSEMBLY AT ALL PVC PIPING PENETRATIONS THROUGH FIRE WALLS, FLOORS OR CEILING WHERE REQUIRED BY LOCAL FIRE DISTRICT.

FIRE PROTECTION SYMBOLS AND ABBREVIATIONS

• 0 0 EXISTING SPRINKLER HEAD TO REMAIN. NEW SPRINKLER HEAD \bullet \odot \circ STANDARD COVERAGE SPRINKLER, WHITE SEMI-RECESSED PENDENT, QUICK-RESPONSE, K=5.6 STANDARD COVERAGE SPRINKLER, WHITE CONCEALED PENDENT, QUICK-RESPONSE, K=5.6 STANDARD COVERAGE SPRINKLER, BRASS UPRIGHT. QUICK-RESPONSE, K=5.6 EXTENDED COVERAGE SPRINKLER, PENDENT _____ QUICK-RESPONSE, K=8.0 R R R• 0 0 EXISTING SPRINKLER HEAD TO BE REMOVED \odot N REMOVE EXISTING HEAD AND PROVIDE NEW HEAD AT LOCATION SHOWN FIRE PROTECTION (SPRINKLER) PIPE GATE VALVE CHECK VALVE BALL VALVE PRESSURE GAUGE AND NEEDLE VALVE DIRECTION OF FLOW PIPE ELBOW (TURNED UP) PIPE ELBOW (TURNED DOWN) PIPE TEE DOWN (DROP) PIPE TEE UP PIPE TEE UP OR ANGLE PIPE TEE DOWN OR ANGLE PIPE CAP

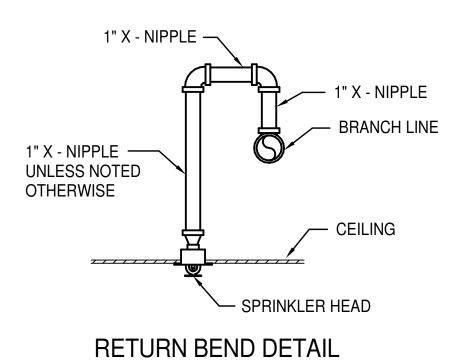

FIRE PROTECTION SYMBOLS AND ABBREVIATIONS

NO SCALE

AFF.	ABOVE FINISHED FLOOR	G	GUARD
BFP	BACKFLOW PREVENTER	GPM	GALLONS PER MINUTE
	DRY	OS&Y	OUTSIDE STEM AND YOKE
DN.	DOWN	PH	PHASE
FD	FLOOR DRAIN	PSI	POUNDS PER SQUARE INCH
FDC	FIRE DEPARTMENT CONNECTION	TYP.	TYPICAL
FP	FIRE PROTECTION	V	VANDAL RESISTANT

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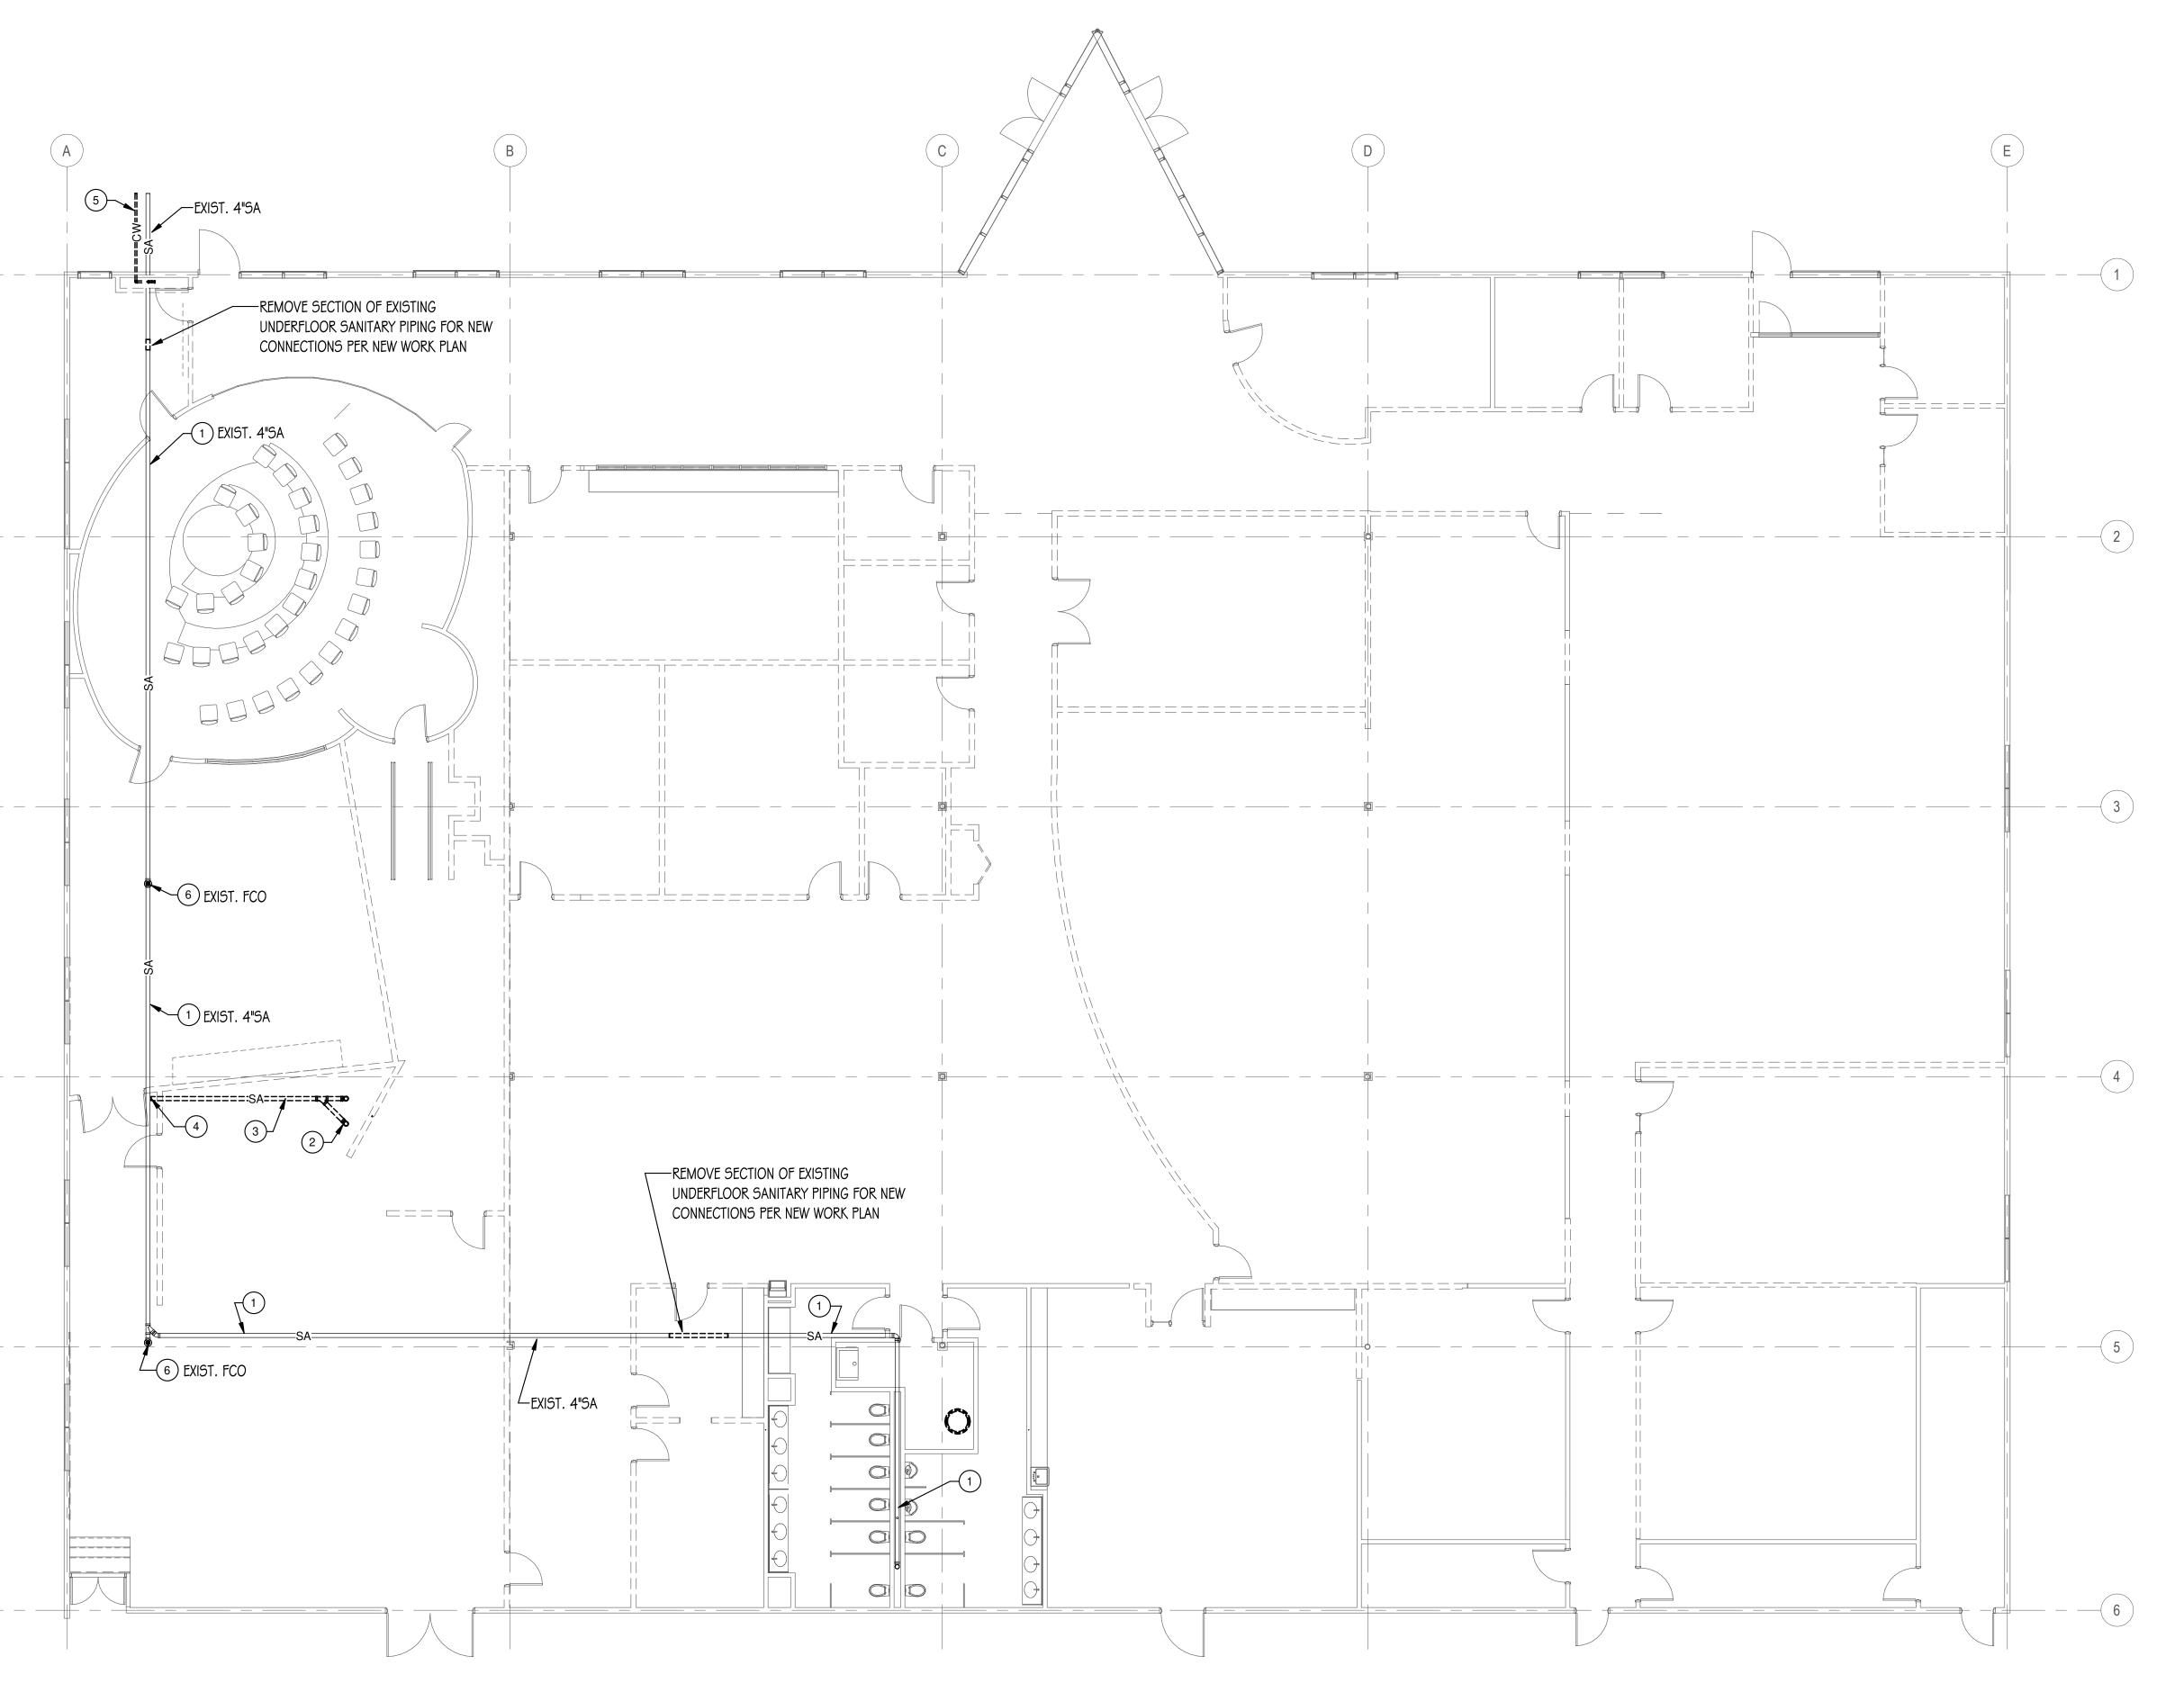
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> FIRE PROTECTION **GENERAL NOTES** SYMBOLS AND **ABBREVIATIONS**

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UNDERFLOOR PIPING AND FLOOR SAW CUTTING NOTES:

I. PLUMBING CONTRACTOR SHALL BE RESPONSIBLE FOR FLOOR CUTTING AND PATCHING OF EXISTING FLOOR TO ACCOMMODATE DEMOLITION AND NEW UNDERGROUND PIPING SHOWN UNDER EXISTING FLOORS.

2. ALL EXISTING PIPING INFORMATION SHOWN ON THIS DRAWING HAS BEEN OBTAINED FROM OWNER'S EXISTING CONSTRUCTION DOCUMENTS AND LIMITED FIELD SURVEY. EXACT LOCATION OF EXISTING UNDERGROUND SANITARY, VENT STORM PIPING ALL PIPE SIZES SHALL BE FIELD VERIFIED BEFORE STARTING INSTALLATION. FOR UNDERGROUND PIPING, CONTRACTOR SHALL FIELD VERIFY EXISTING PIPE LOCATIONS, CONNECTION LOCATION, SIZE, DIRECTION OF FLOW, AND DEPTH VIA PIPE LOCATING/TELEVISING EQUIPMENT PRIOR TO SAW CUTTING OF FLOOR OR BEGINNING WORK.

3. WHEN SAW CUTTING THE FLOOR, CONTRACTOR SHALL USE CAUTION TO PREVENT CUTTING OF ANY UNDERFLOOR UTILITIES. CONTRACTOR SHALL VERIFY ALL EXISTING UNDERFLOOR UTILITIES PRIOR TO CUTTING OF FLOOR VIA X-RAY FLOOR SCANNING EQUIPMENT. IT SHALL BE THE CONTRACTORS RESPONSIBILITY TO REPAIR ANY DAMAGES TO THE EXISTING UNDERFLOOR UTILITIES OCCURRED DURING CONSTRUCTION AT NO COST TO THE OWNER.

4. DRILL AND DOWEL EXISTING CONCRETE FOR #4 ROD AT 16" O.C.. #4 ROD TO BE 12" LONG WITH 6" PROJECTION INTO EXISTING CONCRETE. REPLACE WITH 5" CONCRETE SLAB INFILL WITH ONE LAYER 6X6-8/8 WWF 1" CLR TO TOP ON 30 MIL. VAPOR BARRIER OVER COMPACTED GRANULAR FILL - TYPICAL. (FIELD VERIFY EXISTING SLAB THICKNESS) EXERCISE CARE SO AS NOT TO UNDERMINE OR DISTURB BUILDING FOUNDATIONS OR REMAINING SLAB ON GRADE. SLOPE EXCAVATIONS AS REQUIRED TO GRADUALLY REACH THE ELEVATIONS.

5. WHERE UNDERGROUND PIPING IS TO BE DISCONNECTED OR REMOVED, PIPING SHALL BE CAPPED AT MAIN PER IDPH REQUIREMENTS.

DRAWING NOTES

- I EXISTING PLUMBING PIPING TO REMAIN.
- 2 REMOVE EXISTING FLOOR DRAIN AND CLEANOUT, REMOVE PIPING TO BELOW FLOOR AND CAP. PATCH FLOOR TO MATCH EXISTING.
- 3 ABANDON PIPING BELOW SLAB.
- 4 DISCONNECT PIPING AT MAIN AND CAP AT MAIN.
- 5 ABANDON EXISTING WATER MAIN, WATER MAIN TO BE DISCONNECTED AND CAPPED AT MAIN, SEE CIVIL DRAWINGS FOR ADDITIONAL INFORMATION.

6 REMOVE EXISTING FLOOR CLEANOUT AND PROVIDE NEW FLOOR CELANOUT,

TYPE AS INDICATED WITH CARPET MARKER. OPEN AND PATCH FLOOR AS REQUIRED TO REPLACE FLOOR CLEANOUT, COORDINATE WITH NEW FLOOR FINISH LEVEL.

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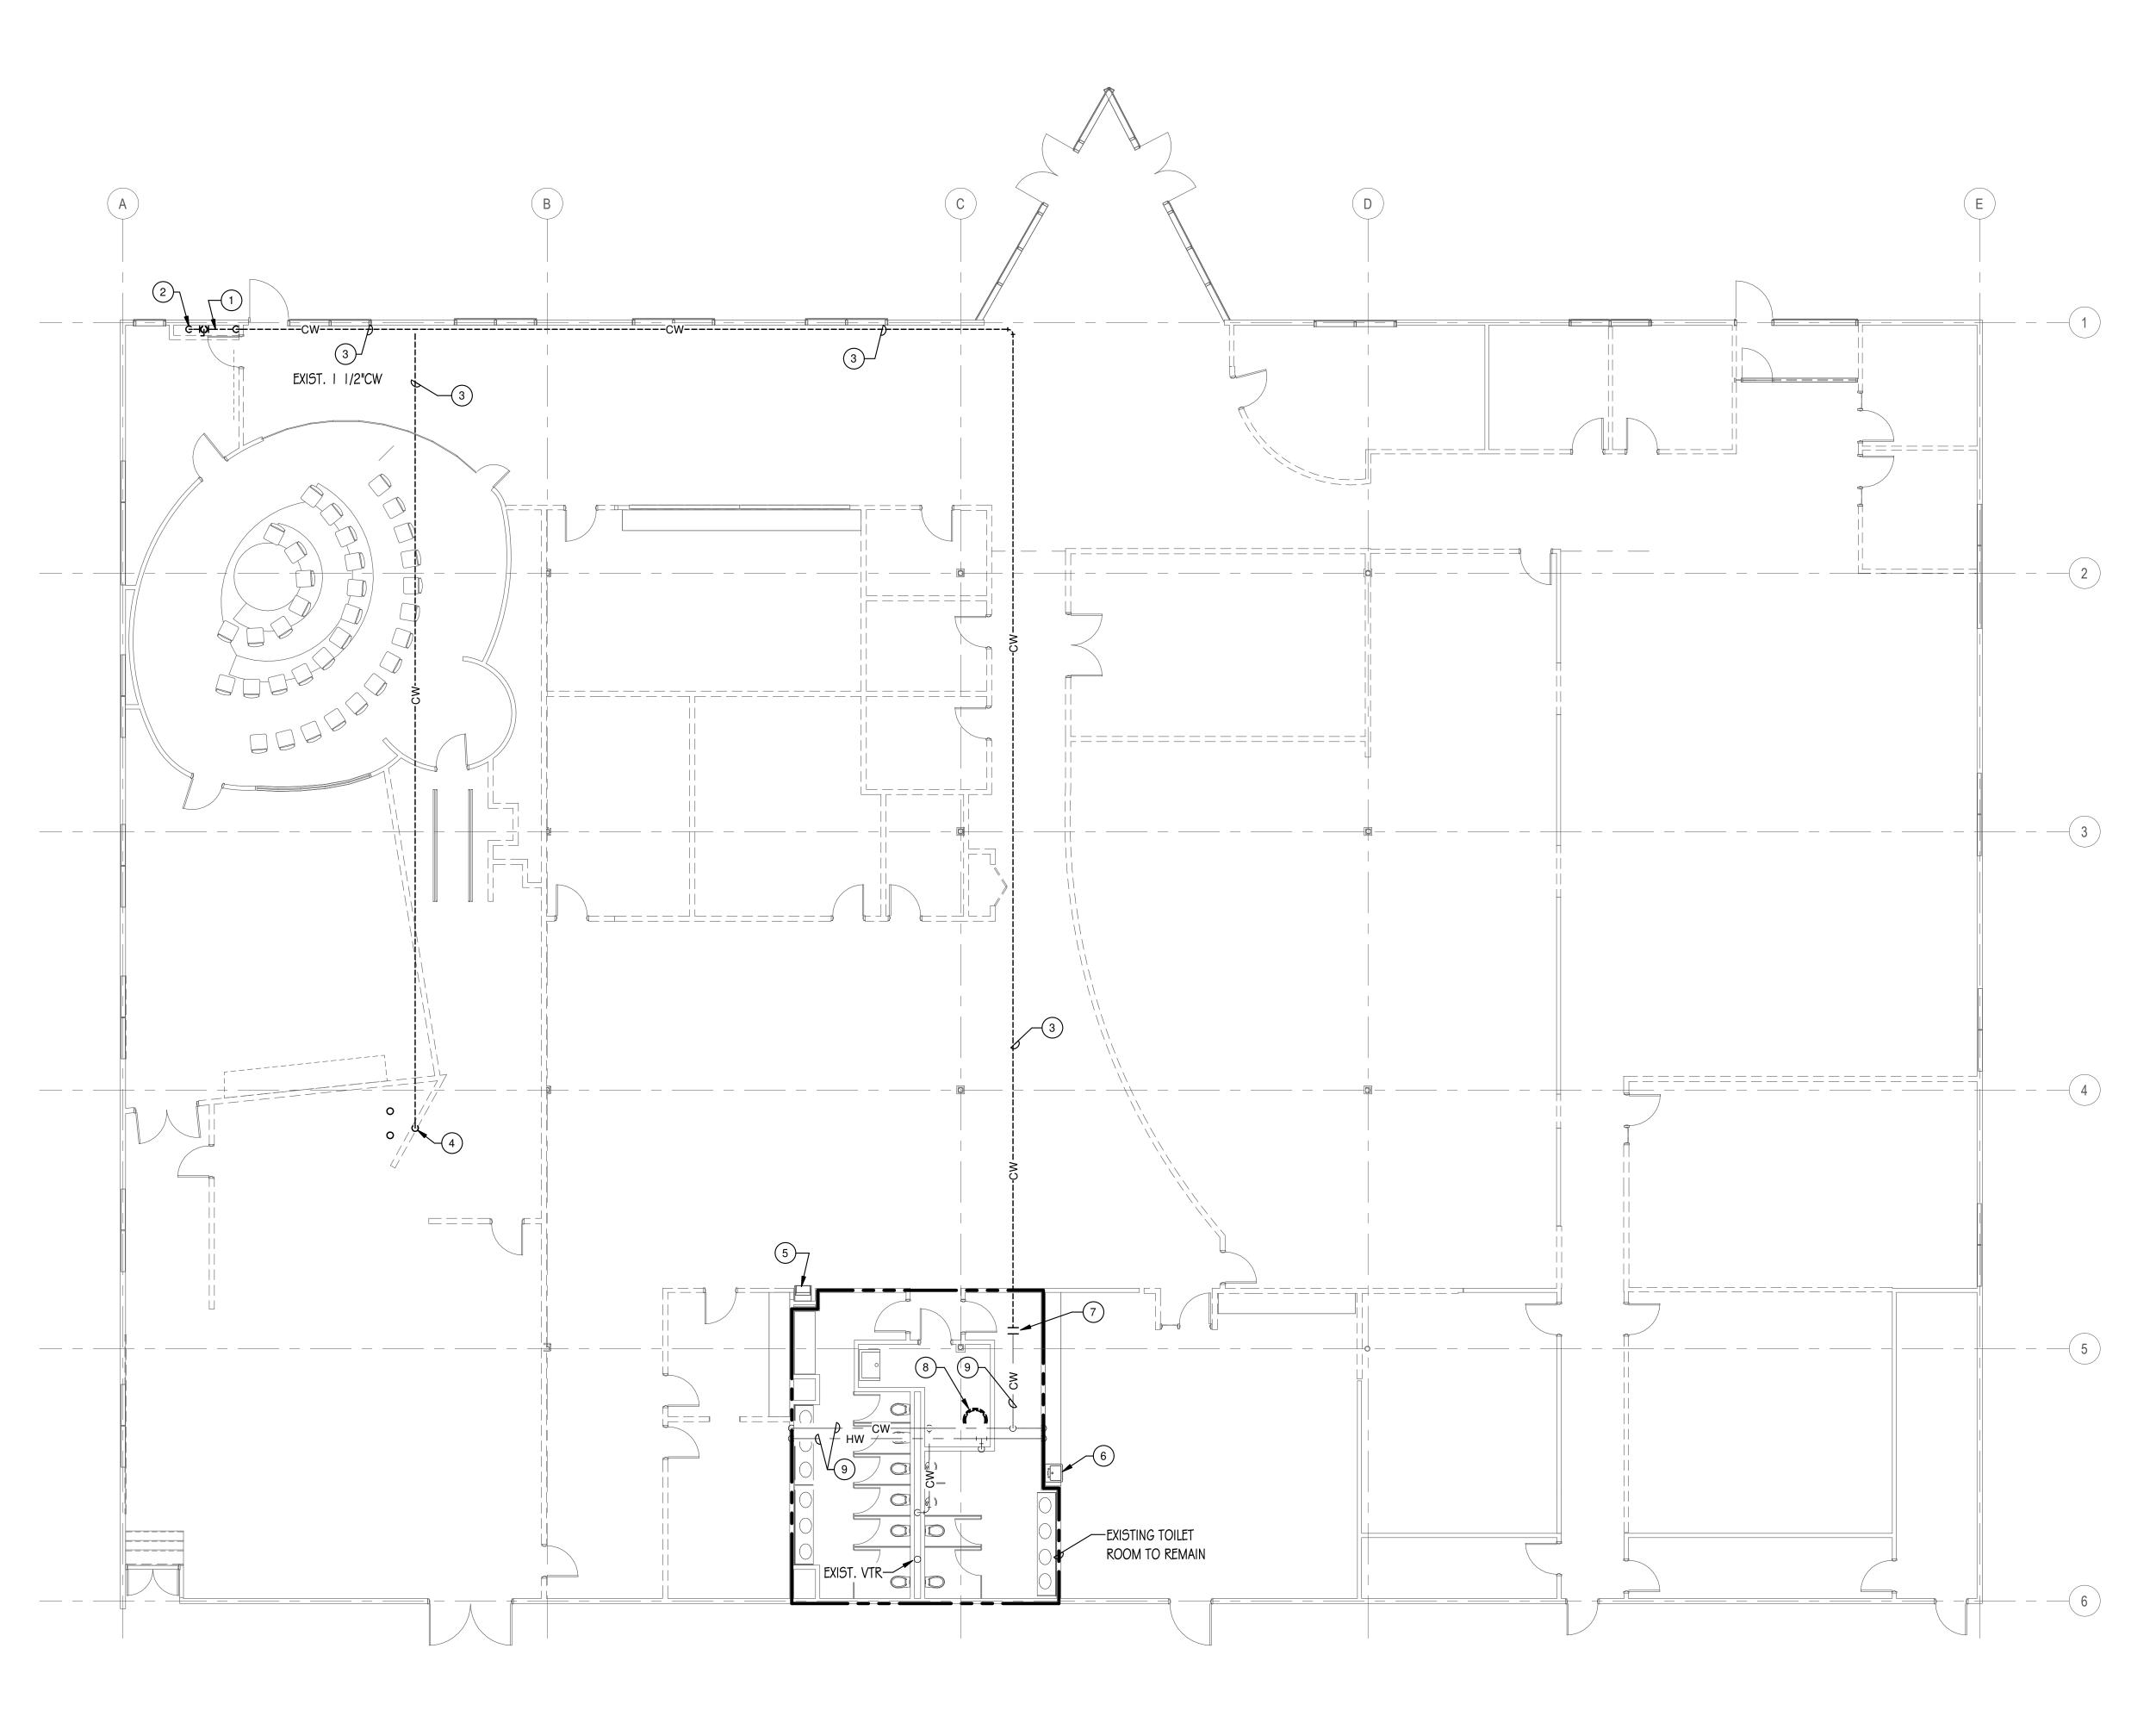
UNDERFLOOR
PLUMBING
DEMOLITION PLAN

SHEET NUMBER:

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1 UNDERFLOOR PLUMBING DEMOLITION PLAN



PLUMBING DEMOLITION PLAN
1/8" = 1'-0"

DRAWING NOTES

- REMOVE EXISTING WATER SERVICE, METER, ETC, CAP AND ABANDON EXISTING WATER MAIN, REMOVE ALL ASSOCIATED SUSPENDED COLD WATER PIPING SHOWN DASHED.
- 2 REMOVE EXIST. HOSE VALVE, PATCH WALL TO MATCH EXISTING.
- 3 REMOVE SUSPENDED PLUMBING PIPING SHOWN DASHED.
- 4 REMOVE HOSE VALVE, REMOVE ALL ASSOCIATED COLD WATER PIPING SHOWN DASHED BACK TO LOCATION SHOWN.
- 5 REMOVE ELEC WATER COOLER. REMOVE EXIST. COLD WATER ROUGH-IN. MODIFY SAN AND VENT ROUGH-IN PER NEW WORK PLAN FOR NEW FIXTURE.
- 6 REMOVE EXISTING SINK. REMOVE EXISTING CW/HW ROUGH-IN. MODIFY SAN AND VENT
- ROUGH-IN PER NEW WORK PLAN FOR NEW FIXTURE.
- 7 NEW CONNECTION TO BE MADE AT THIS LOCATION, REMOVE ALL PIPING SHOWN DASHED BEYOND THIS POINT.
- 8 DISCONNECT AND REMOVE EXISTING WATER HEATER FOR REPLACEMENT PER NEW WORK
- 9 EXISTING PLUMBING PIPING TO REMAIN.



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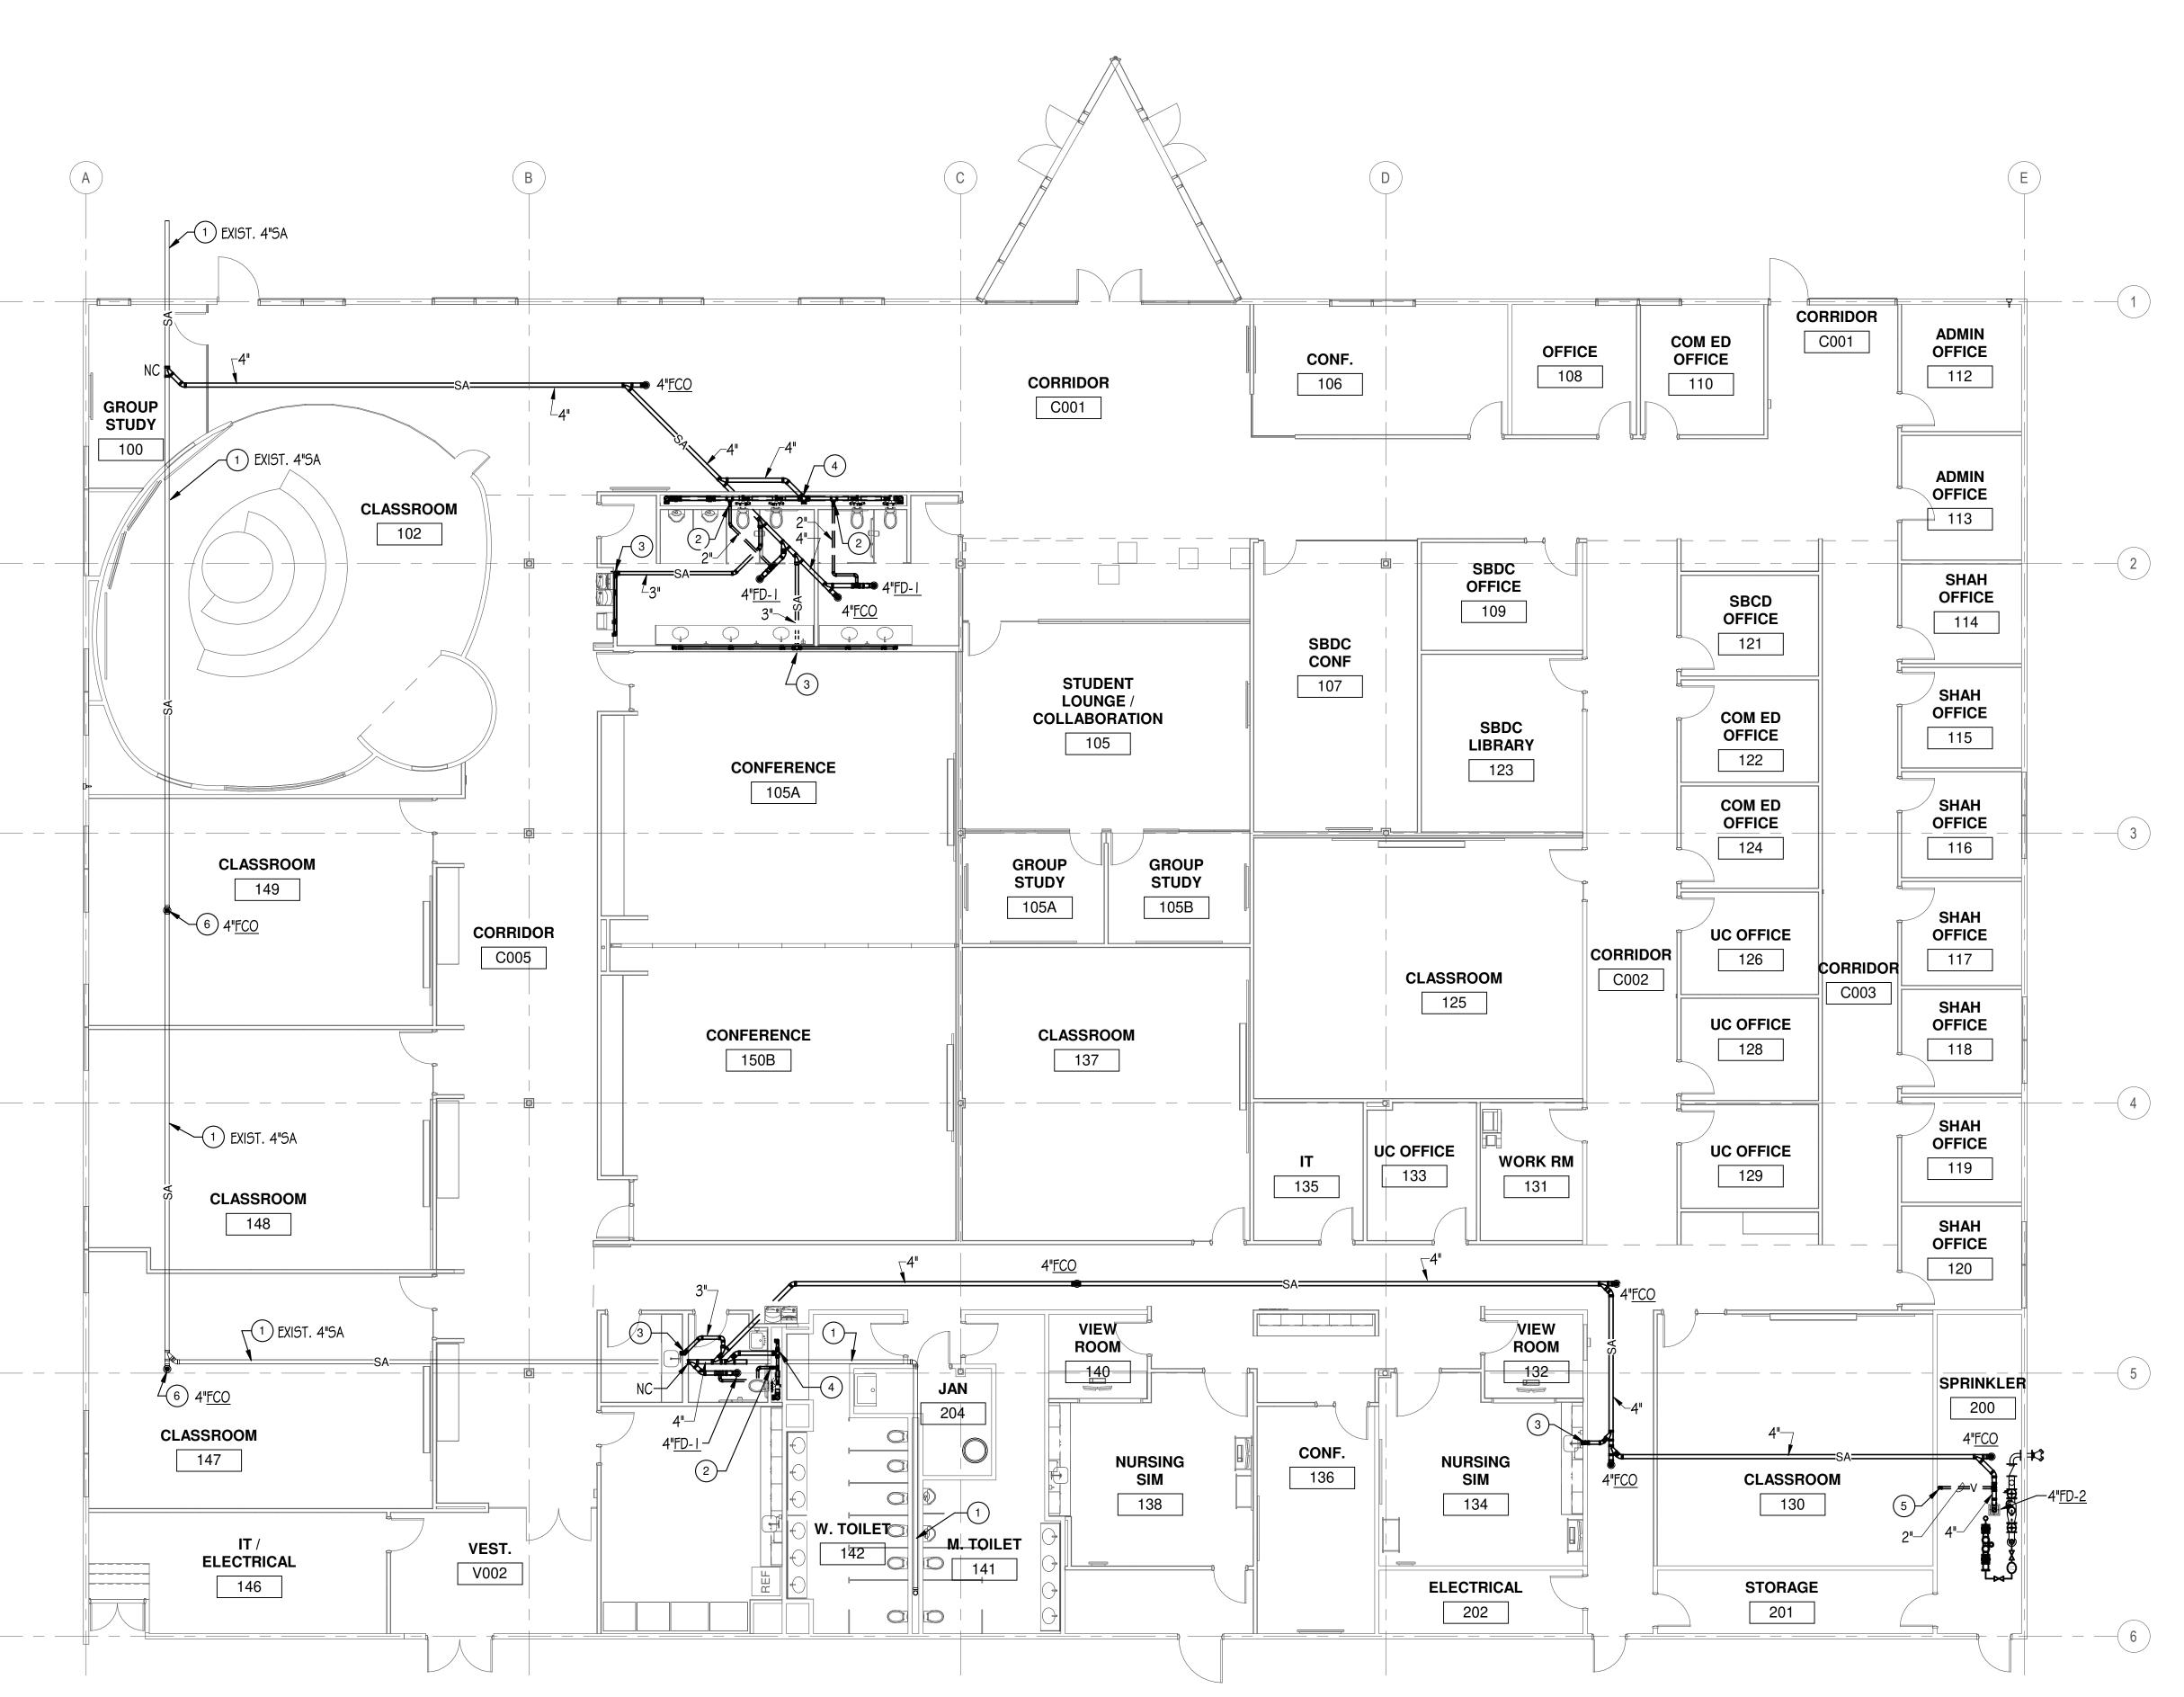
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UNDERFLOOR PLUMBING PLAN

UNDERFLOOR PIPING AND FLOOR SAW CUTTING NOTES:

I. PLUMBING CONTRACTOR SHALL BE RESPONSIBLE FOR FLOOR CUTTING AND PATCHING OF EXISTING FLOOR TO ACCOMMODATE DEMOLITION AND NEW UNDERGROUND PIPING SHOWN UNDER EXISTING FLOORS.

2. ALL EXISTING PIPING INFORMATION SHOWN ON THIS DRAWING HAS BEEN OBTAINED FROM OWNER'S EXISTING CONSTRUCTION DOCUMENTS AND LIMITED FIELD SURVEY. EXACT LOCATION OF EXISTING UNDERGROUND SANITARY, VENT STORM PIPING ALL PIPE SIZES SHALL BE FIELD VERIFIED BEFORE STARTING INSTALLATION. FOR UNDERGROUND PIPING, CONTRACTOR SHALL FIELD VERIFY EXISTING PIPE LOCATIONS, CONNECTION LOCATION, SIZE, DIRECTION OF FLOW, AND DEPTH VIA PIPE LOCATING/TELEVISING EQUIPMENT PRIOR TO SAW CUTTING OF FLOOR OR BEGINNING WORK.

3. WHEN SAW CUTTING THE FLOOR, CONTRACTOR SHALL USE CAUTION TO PREVENT CUTTING OF ANY UNDERFLOOR UTILITIES. CONTRACTOR SHALL VERIFY ALL EXISTING UNDERFLOOR UTILITIES PRIOR TO CUTTING OF FLOOR VIA X-RAY FLOOR SCANNING EQUIPMENT. IT SHALL BE THE CONTRACTORS RESPONSIBILITY TO REPAIR ANY DAMAGES TO THE EXISTING UNDERFLOOR UTILITIES OCCURRED DURING CONSTRUCTION AT NO COST TO THE OWNER.

4. DRILL AND DOWEL EXISTING CONCRETE FOR #4 ROD AT 16" O.C.. #4 ROD TO BE 12" LONG WITH 6" PROJECTION INTO EXISTING CONCRETE. REPLACE WITH 5" CONCRETE SLAB INFILL WITH ONE LAYER 6X6-8/8 WWF I" CLR TO TOP ON 30 MIL. VAPOR BARRIER OVER COMPACTED GRANULAR FILL - TYPICAL. (FIELD VERIFY EXISTING SLAB THICKNESS) EXERCISE CARE SO AS NOT TO UNDERMINE OR DISTURB BUILDING FOUNDATIONS OR REMAINING SLAB ON GRADE. SLOPE EXCAVATIONS AS REQUIRED TO GRADUALLY REACH THE ELEVATIONS.

5. WHERE UNDERGROUND PIPING IS TO BE DISCONNECTED OR REMOVED, PIPING SHALL BE CAPPED AT MAIN PER IDPH REQUIREMENTS.

DRAWING NOTES

- I EXISTING PLUMBING PIPING TO REMAIN.
- 2 2"V UP IN WALL FOR CHASE.
- 3 3"SA UP IN WALL OR CHASE.
- 4 4"SA UP IN WALL OR CHASE.
- 5 2"V UP ALONG WALL.
- 6 REMOVE EXISTING FLOOR CLEANOUT AND PROVIDE NEW FLOOR CELANOUT, TYPE AS INDICATED WITH CARPET MARKER. OPEN AND PATCH FLOOR AS REQUIRED TO REPLACE FLOOR CLEANOUT, COORDINATE WITH NEW FLOOR FINISH LEVEL.

ARCHITECT OF RECORD DEMONICA KEMPER ARCHITECTS 125 N. HALSTED STREET, SUITE 301 **CHICAGO, IL 60661** P: 312.496.0000

MEP-FP-T-ENGINEERS 20/10 ENGINEERING GROUP, LLC 1216 TOWER ROAD SCHAUMBURG,IL 60173

P: 847.882.2010 F: 847.882.2201 CIVIL ENGINEERS **HRG GREEN** 1391 CORPORATE DRIVE, SUITE 203 MCHENRY ,IL 60050 P:815.385.1778 F:815.385.1781

KEY PLAN:


SHEET STATUS: 9.19.23 **ISSUED FOR BIDS**

DESCRIPTION: SHEET TITLE:

UNDERFLOOR **PLUMBING PLAN**

SHEET NUMBER:

9/19/2023 11:37:52 AM

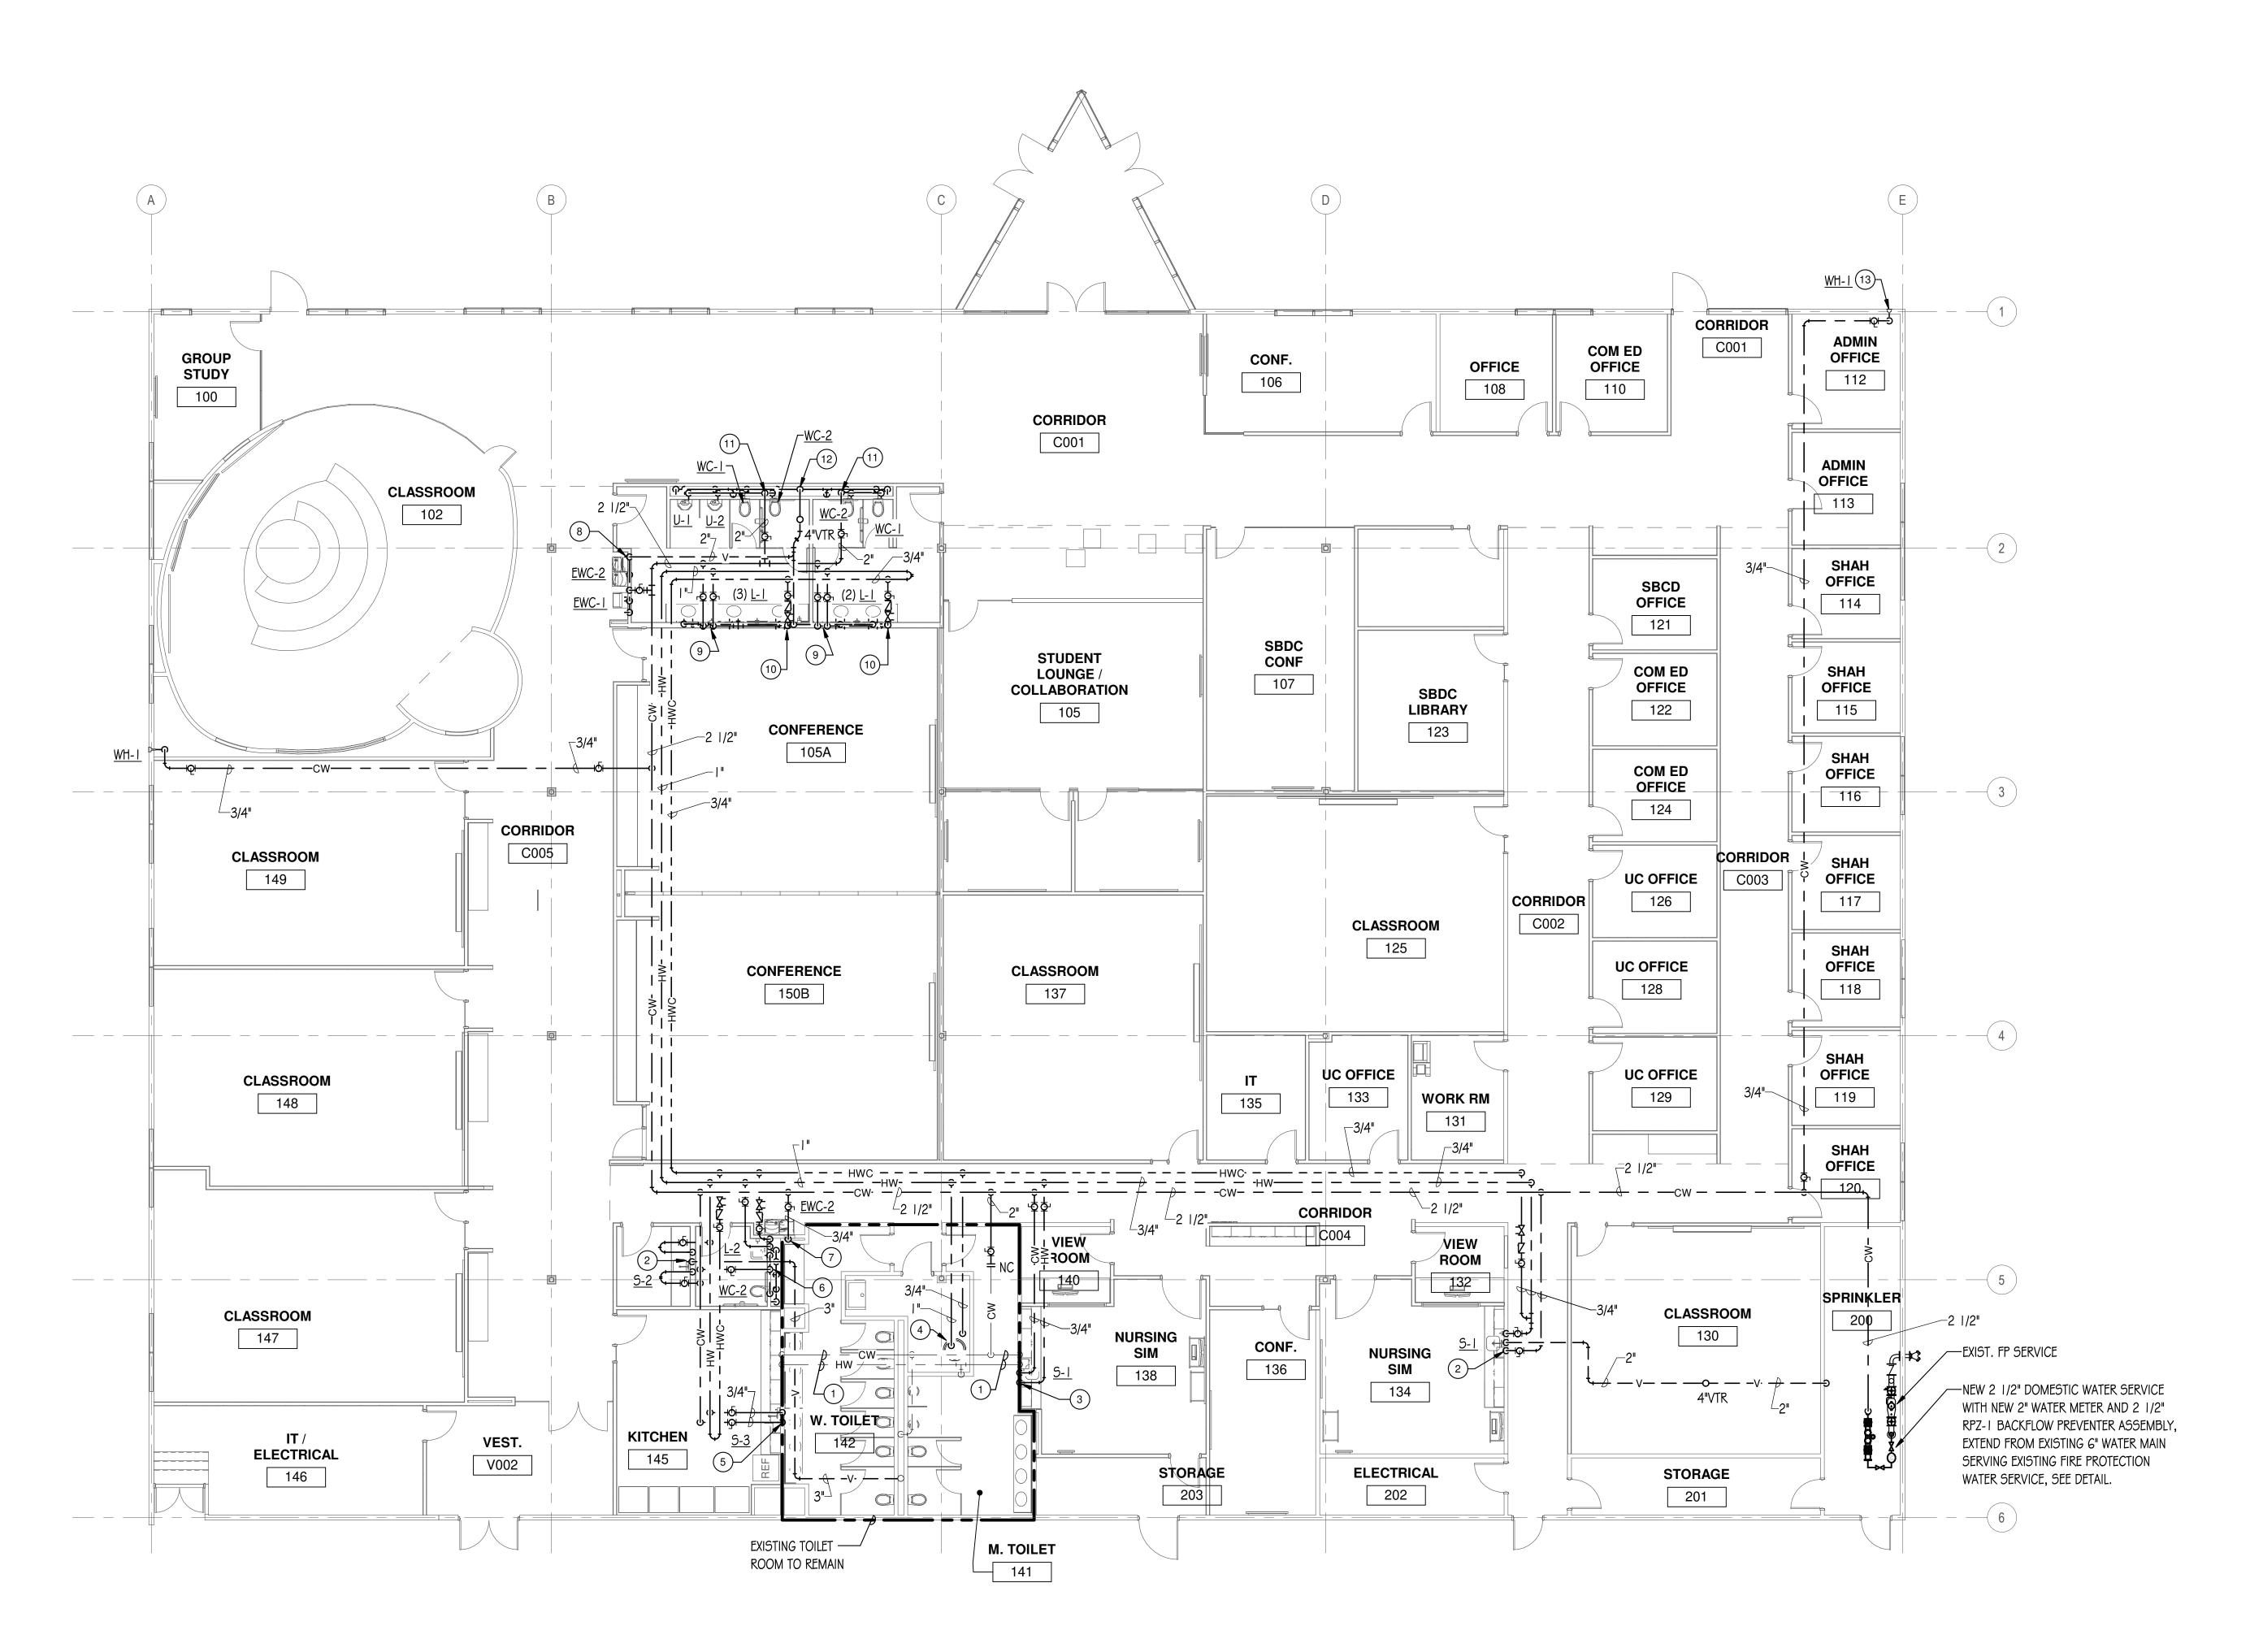

PLUMBING NEW WORK PLAN

DRAWING NOTES

- I EXISTING PLUMBING PIPING TO REMAIN.
- 2 3/4"CW/HW \$ 2"V DOWN IN WALL.
- 3 3/4"CW/HW DOWN IN WALL, SINK IN THIS ROOM TO BE SERVED FROM SEPARATE WATER SUPPLY BRANCH PIPING AND VALVES FROM ADJACENT TOILET ROOM. MODIFY EXISTING DWV ROUGH-IN TO ACCOMMODATE NEW SINK AT SHIFTED LOCATION.
- 4 PROVIDE REPLACEMENT WATER HEATER (DWH-I), TYPE AS INDICATED. PROVIDE NEW EXPANSION TANK (DWET-1) AND IN-LINE RECIRC PUMP (DWP-1). SEE DETAIL FOR ADDITIONAL INFORMATION.
- 5 3/4"CW/HW DOWN IN WALL, SINK IN THIS ROOM TO BE SERVED FROM SEPARATE WATER SUPPLY BRANCH PIPING AND VALVES FROM ADJACENT TOILET ROOM. PROVIDE NEW SANITARY/VENT ROUGH-IN, MAKE NEW CONNECTION TO EXISTING SANITARY AND VENT IN WALL SERVING LAVATORIES ON OPPOSITE SIDE OF WALL.
- 6 I 1/2"CW, 3/4"HW, 3/4"HWC \$ 3"V DOWN IN CHASE.
- 7 3/4"CW DOWN IN WALL, EWC TO BE SERVED BY SEPARATE BRANCH PIPING AND VALVE.
- 8 3/4"CW \$ 2"V DOWN IN WALL.
- 9 3/4"CW/HW DOWN IN WALL.
- 10 3/4"HWC DOWN IN WALL.
- II 2"CW DOWN IN CHASE.
- 12 4"V DOWN IN CHASE.
- 13 REMOVE AND REPLACE EXISTING WALL HYDRANT ON EXTERIOR WALL, ROUTE NEW 3/4"CW DOWN IN EXISTING CHASE/WALL. OPEN AND PATCH WALL TO ROUTE NEW PIPING.



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KEY PLAN:


9.19.23 SHEET STATUS: **ISSUED FOR BIDS**

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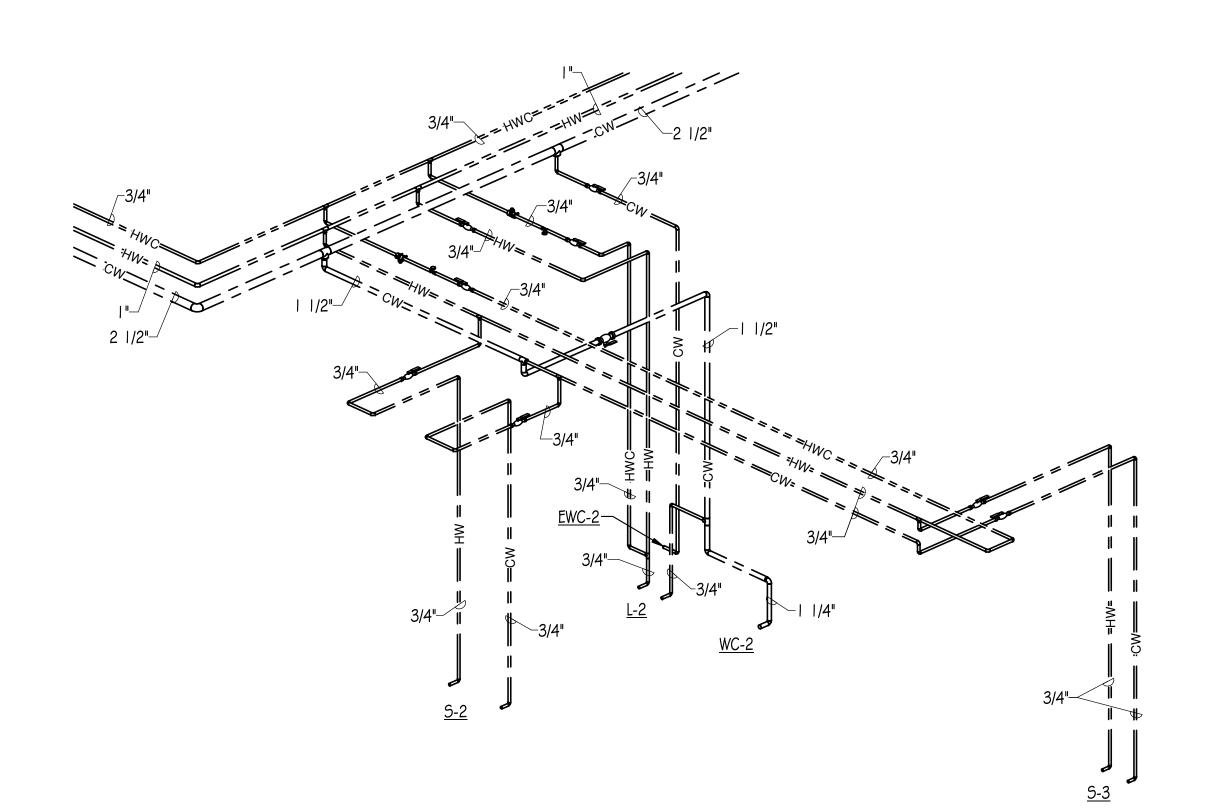
SHEET TITLE: **PLUMBING PLAN**

SHEET NUMBER:

9/19/2023 11:37:55 AM

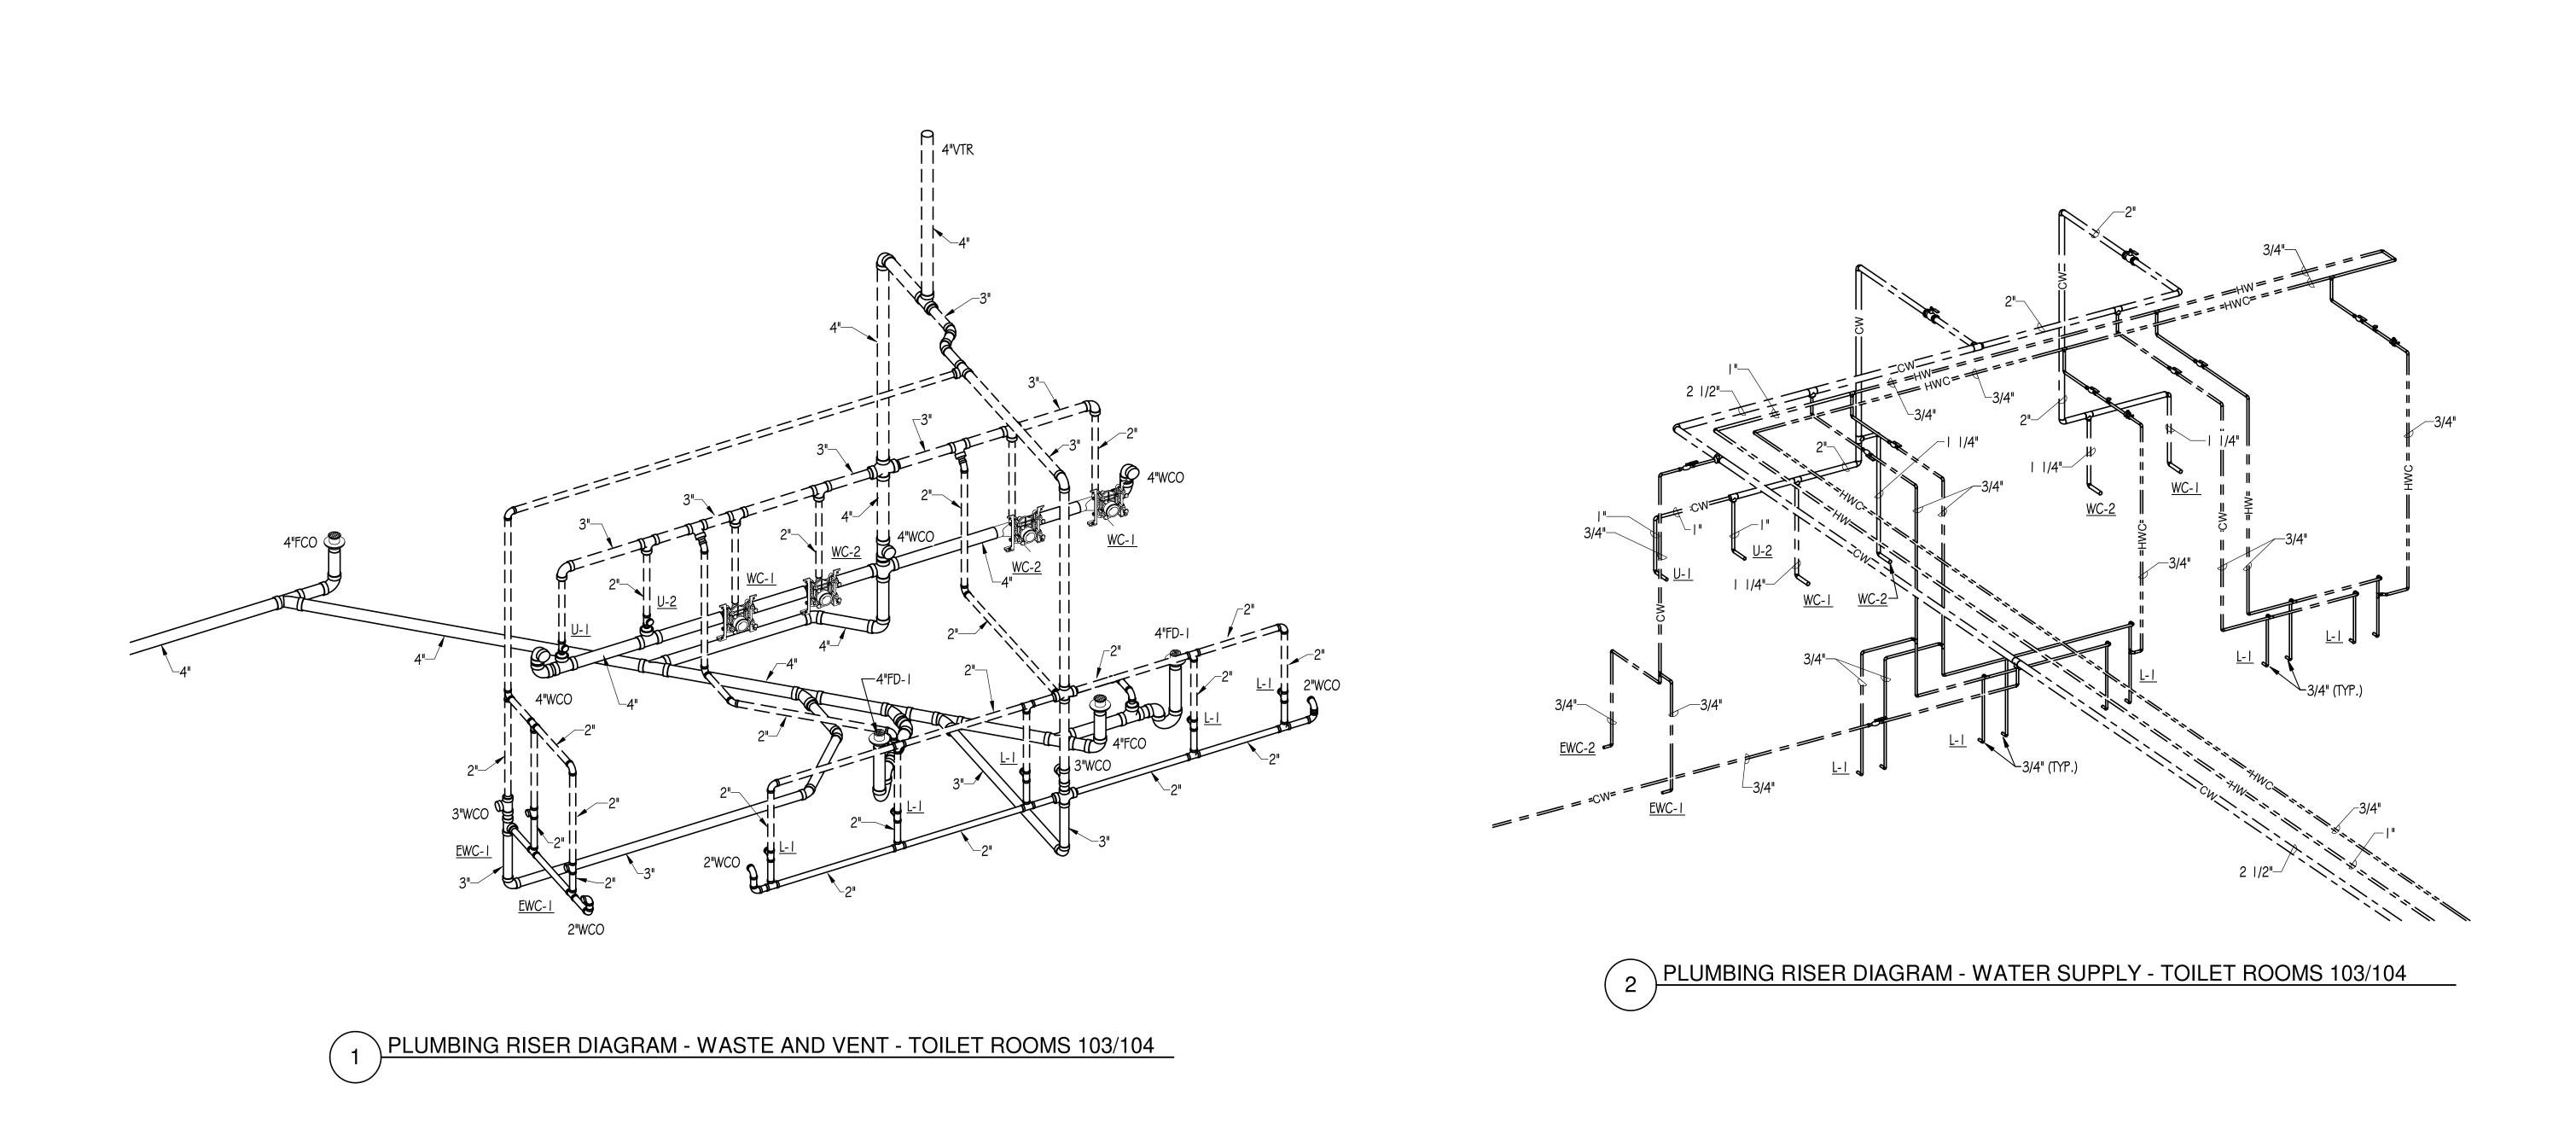

3 PLUMBING RISER DIAGRAM - WASTE AND VENT - TOILET ROOMS 144



4 PLUMBING RISER DIAGRAM - WATER SUPPLY - TOILET ROOMS 144



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COUNTY COLLE

KEY PLAN:

SHEET STATUS: 9.19.2

NO: DESCRIPTION: DATE

PLUMBING RISER DIAGRAMS

SHEET NUMBER:

P4.00

9/19/2023 11:37:57 AM

PLUMBING SYMBOLS AND ABBREVIATIONS DOMESTIC COLD WATER DOMESTIC HOT WATER DOMESTIC HOT WATER CIRCULATING SUSPENDED STORM SEWER UNDERGROUND SANITARY SEWER UNDERGROUND STORM SEWER SUSPENDED VENT PIPING PIPING TO BE REMOVED ______ (DEMOLITION DRAWING ONLY) GATE VALVE CHECK VALVE BALL VALVE CIRCUIT BALANCING VALVE DIRECTION OF FLOW PIPE ELBOW (TURNED UP) PIPE ELBOW (TURNED DOWN) PIPE TEE DOWN (DROP) PIPE TEE UP PIPE TEE UP OR ANGLE PIPE TEE DOWN OR ANGLE NEW CONNECTION WALL HYDRANT CLEANOUT IN SUSPENDED CEILING FLOOR CLEANOUT (ROUND) FLOOR DRAIN (ROUND) CO CLEANOUT COLD WATER DOMESTIC WATER HEATER DOMESTIC WATER PUMP DWET DOMESTIC WATER EXPANSION TANK ELECTRIC WATER COOLER FCO FLOOR CLEANOUT FD FLOOR DRAIN HOT WATER HOT WATER CIRCULATING LAVATORY MOP BASIN NEW CONNECTION SANITARY STORM THERMOSTATIC MIXING VALVE TYP. TYPICAL URINAL **VENT** VENT THROUGH ROOF WATER CLOSET WALL CLEANOUT

WALL HYDRANT

PLUMBING GENERAL NOTES

GENERAL

- 1.1 ALL WORK SHALL BE INSTALLED AND ALL MATERIALS SHALL BE IN STRICT ACCORDANCE WITH ALL APPLICABLE RULES AND REGULATIONS OF ILLINOIS DEPARTMENT OF PUBLIC HEALTH ILLINOIS PLUMBING CODE 2014 EDITION AND ALL LOCAL AMENDMENTS TO THE PLUMBING CODE.
- 1.2 IT SHALL BE THE CONTRACTORS RESPONSIBILITY TO COORDINATE ALL INSPECTIONS WITH THE ILLINOIS DEPARTMENT OF PUBLIC HEALTH STATE PLUMBING INSPECTORS AND THE LOCAL PLUMBING INSPECTOR HAVING JURISDICTION.
- 1.3 EXACT LOCATION OF PLUMBING FIXTURES AND DEVICES SHALL BE VERIFIED WITH ARCHITECTURAL DRAWINGS, ACTUAL BUILDING WALLS, FLOORS AND CEILING, CABINETRY AND EQUIPMENT SHOP DRAWINGS PRIOR TO STARTING ANY WORK.
- 1.4 DRAWINGS ARE GENERALLY DIAGRAMMATIC. ROUTING OF PIPING, ETC., AS SHOWN ON DRAWINGS, DOES NOT INTEND TO SHOW EVERY RISE, DROP, OFFSET, FITTING NOR EVERY STRUCTURAL ELEMENT THAT MAY BE ENCOUNTERED DURING THE INSTALLATION OF THIS WORK. CONTRACTOR SHALL MAKE ANY REQUIRED CHANGES FROM THE GENERAL ROUTING SHOWN ON THESE DRAWINGS, SUCH AS OFFSETS, BENDS OR CHANGES IN ELEVATION DUE TO COORDINATION WITH THE WORK OF OTHER TRADES AND BUILDING CONSTRUCTION. ALL CHANGES SHALL BE MADE WITHOUT ADDITIONAL COST TO THE OWNER OR DELAY IN COMPLETION DATE OF THE PROJECT.
- 1.5 PITCH ALL SUPPLY AND RETURN WATER LINES TO DRAIN COMPLETELY THROUGH LOWER EQUIPMENT FIXTURES, UNIONS, OR DRAIN VALVES. INSTALL A 1/2" DRAIN VALVE WITH 3/4" HOSE THREAD OUTLET IN ALL MAIN PIPING RUNS WHICH WOULD NOT BE ABLE TO DRAIN THRU A LOWER PIECE OF EQUIPMENT.
- 1.6 ALL VENT AND WASTE PIPING SIZES ARE MINIMUM. ADDITIONAL VENTS SHALL BE ADDED AND/OR PIPE SIZE INCREASED AS REQUIRED BY APPLICABLE CODES, STATUTES AND REGULATIONS, ETC. WITHOUT ADDITIONAL COST TO THE OWNER.
- 1.7 PIPE SIZE SHALL BE MAINTAINED FULL SIZE UP TO "LOOK-OUT" AT FIXTURE CONNECTION.
- 1.8 STERILIZATION: UPON COMPLETION OF TESTING AND FLUSHING OF NEW DOMESTIC WATER PIPING, THE CONTRACTOR SHALL STERILIZE ALL WATER PIPING INCLUDING ALL DOMESTIC HOT WATER SUPPLY AND RETURN AND ALL DOMESTIC COLD WATER PIPING. CONTRACTOR SHALL FURNISH AND INSTALL ALL TEMPORARY TAPPINGS, VALVE OPENINGS, DRAIN FITTINGS, ETC., AS REQUIRED TO STERILIZE THE WATER PIPING, INCLUDING ALL REQUIRED EXCAVATION WORK, FITTING AND LABOR. WATER PIPING SHALL BE FLUSHED AND CHLORINATED AS SPECIFIED IN AWWA-C-601-54 STANDARD PROCEDURE FOR DISINFECTING WATER MAINS AND AS REQUIRED BY ILLINOIS DEPARTMENT OF PUBLIC HEALTH. DISINFECTING SHALL NOT BE DEEMED COMPLETED UNTIL SATISFACTORY BACTERIOLOGICAL ANALYSIS REPORTS ARE RECEIVED FOR SAMPLES OF WATER COLLECTED AND TESTED FROM THE NEW WATER PIPING SYSTEM ALL BY PLUMBING CONTRACTOR.
- 1.9 PROVIDER AIR CHAMBERS ON WATER SUPPLY PIPING AT EACH FIXTURE PER ILLINOIS PLUMBING CODE. OR PROVIDE WATER HAMMER ARRESTORS MIFAB MWH SERIES OR APPROVED EQUAL. WATER HAMMER ARRESTORS SHALL BE INSTALLED IN AN ACCESSIBLE LOCATION FOR SERVICE AND EASY REPLACEMENT. LOCATIONS, SIZE AND QUANTITIES SHALL BE DETERMINED BY CONTRACTOR. LOCATIONS IN PLUMBING CHASE SHALL REQUIRE AN ACCESS PANEL AND ALL ACCESS PANEL LOCATIONS SHELL BE COORDINATED AND APPROVED BY ARCHITECT/OWNER.
- 1.10 ALL EXISTING PIPING INFORMATION SHOWN ON THIS DRAWING HAS BEEN OBTAINED FROM OWNER'S EXISTING CONSTRUCTION DOCUMENTS AND LIMITED FIELD SURVEY. EXACT LOCATION OF EXISTING SANITARY/STORM LINES, WATER LINES, VENT LINES, VALVES AND ALL PIPE SIZES SHALL BE FIELD VERIFIED BEFORE STARTING INSTALLATION. FOR UNDERGROUND PIPING, CONTRACTOR SHALL FIELD VERIFY EXISTING PIPE LOCATIONS, CONNECTION LOCATION, SIZE, DIRECTION OF FLOW, AND DEPTH VIA PIPE LOCATING/TELEVISING EQUIPMENT AS REQUIRED PRIOR TO SAW CUTTING OF FLOOR OR BEGINNING WORK. CONTRACTOR'S BID SHALL INCLUDE SAW CUTTING, PATCHING TO MATCH EXISTING, PIPING, LABOR, ETC. TO LOCATE, MAKE CONNECTIONS TO EXISTING UNDERFLOOR PIPING WITHIN 10 FEET OF LOCATION SHOWN ON DRAWINGS. IF LOCATION SHOWN FOR ANY CONNECTION DOES NOT EXIST OR IS NOT ACCESSIBLE, CONTRACTOR SHALL NOTIFY ARCHITECT/ENGINEER IMMEDIATELY.
- 1.11 PLUMBING CONTRACTOR SHALL PROVIDE STACK TEST ON ALL ROUGH AND UNDERGROUND PLUMBING PER ILLINOIS PLUMBING CODE.
- 1.12 PLUMBING CONTRACTOR SHALL PROVIDE PRESSURE TEST ON ALL ABOVE GROUND SANITARY AND VENT PIPING PER ILLINOIS PLUMBING CODE.
- 1.13 PLUMBING CONTRACTOR SHALL PROVIDE 100LB AIR TEST OR WATER PRESSURE TEST ON ALL WATER PIPING AT TIME OF ROUGH INSPECTION PER ILLINOIS PLUMBING CODE.
- 1.14 PROVIDE WALL CLEANOUT AT THE BASE OF ALL WASTE AND STORM RISERS/STACKS PER ILLINOIS PLUMBING CODE. WALL CLEANOUTS SHALL BE PROVIDED AT ALL WASTE STACKS SERVING WATER CLOSETS INCLUDING SINGLE STORY STACKS. WALL CLEANOUTS SHALL BE PROVIDED AT THE END OF SANITARY RUN IN ALL TOILET ROOMS. ALL CLEANOUTS SHALL BE LOCATED WITH POINT OF PLUG/COVER ACCESS LOCATED WITHIN MENS TOILET ROOM WHERE APPLICABLE.
- 1.15 DOUBLE COMBINATION FITTINGS SHALL NOT BE PERMITTED IN ALL HORIZONTAL FLOW CONDITIONS. DOUBLE WYE FITTINGS MAY BE USED WHEN ONLY LONG EXTENSIONS ARE USED BETWEEN WYE AND 1/8 BEND AND A CLEANOUT IS ADDED AT WYE FITTING.
- 1.16 DEAD END PIPING BEYOND 24 INCHES IN WATER SUPPLY PIPING SHALL NOT BE PERMITTED. DEAD END PIPING BEYOND 10 FEET OF NEAREST VENTED SANITARY PIPING WILL NOT BE PERMITTED PER I.D.P.H. SECTION 890.1320.
- 1.17 THERMOSTATIC MIXING VALVES SERVING LAVATORIES AND SINKS USED FOR

HAND WASHING SHALL BE SET TO A MAXIMUM 110 DEGREES.

1.18 ALL FLOOR DRAINS SHALL BE PROTECTED TO PREVENT THE LOSS OF THE TRAP SEAL BY EVAPORATION. APPROVED METHODS SHALL BE PER I.D.P.H. SECTION 890.420(f).

PIPE INSULATION

- 2.1 ALL DOMESTIC COLD WATER AND DOMESTIC HOT WATER SUPPLY/RETURN PIPING SHALL BE INSULATED WITH ASTM C547 FIBERGLASS PIPE INSULATION WITH ASTM C1136 VAPOR BARRIER JACKET COMPLETE WITH PVC FITTING COVERS. ALL COLD WATER PIPING SHALL BE INSULATED WITH 1" THICK INSULATION. ALL DOMESTIC HOT WATER AND RECIRC PIPING 1 1/4" AND SMALLER SHALL BE INSULATED WITH 1" INSULATION. ALL DOMESTIC HOT WATER AND RECIRC PIPING 1 1/2" AND LARGER SHALL BE INSULATED WITH 1 1/2" THICK INSULATION. INSULATE ALL DOMESTIC WATER SUPPLY PIPING TO THE FIXTURE CONNECTION. INSULATE ALL WATER SUPPLY PIPING IN CEILINGS, PLUMBING CHASES AND WALLS.
- 2.2 PATCH AND REFINISH ALL DAMAGED INSULATED SURFACES OF ALL EXISTING PLUMBING PIPING AND ASSOCIATED FITTINGS WHERE NEW CONNECTIONS ARE MADE. INCLUDING BUT NOT LIMITED DOMESTIC COLD WATER, HOT WATER SUPPLY/RETURN AND WASTE.

PIPE HANGERS AND SUPPORTS

- 3.1 ALL SANITARY, VENT, STORM, DOMESTIC SUPPLY AND RETURN PIPING SHALL BE SUSPENDED WITH CLEVIS AND/OR TRAPEZE PIPE HANGERS. ALL HORIZONTAL STORM, DOMESTIC SUPPLY AND RETURN PIPING SHALL BE INSULATED AND REST ON SHEET METAL INSULATION SHIELDS. SEE DETAIL ON MECHANICAL/ELECTRICAL COORDINATION DRAWINGS FOR ADDITIONAL INFORMATION. SWIVEL JOINT HANGERS MAY BE USED ONLY ON WASTE AND VENT PIPING WHEN PIPING IS NOT INSULATED. HANGER MATERIAL SHALL BE OF COMPATIBLE MATERIAL TO PIPING MATERIAL TO PREVENT CORROSION. HANGERS SHALL BE SUPPORTED FROM STRUCTURAL MEMBERS ONLY.
- 3.2 WHEN WATER SUPPLY PIPING IS INSTALLED IN PARALLEL AND SAME ELEVATION, PROVIDE TRAPEZE HANGERS. PIPING SHALL REST ON SHEET METAL SHIELD AT EACH TRAPEZE HANGER WITH ATTACHMENT TO STEEL CHANNEL EVERY 30 FEET UTILIZING A STRUT MOUNTED INSULATION COUPLING WITH STRUT CLAMP FOR USE WITH COPPER PIPING AND FIBERGLASS INSULATION.
- 3.3 VERTICAL ATTACHMENT TO METAL DECK AND WOOD TRUSS'S SHALL NOT BE PERMITTED. HORIZONTAL ATTACHMENT TO WOOD TRUSS SHALL BE MADE BY HORIZONTAL SUPPORT TO BOTTOM CORD OF TRUSS.

3.4 HANGER SPACING SHALL BE AS FOLLOWS.

PIPE MATERIAL		MAX HANGER SPAC	ING ROD DIAMETER
CAST IRON (ALL SIZES)	5 FEET	5/8"
CAST IRON (ALL SIZES) WITH	10 FEET	5/8"
10 FOOT LENGTH OF P	IPE		
COPPER TUBE, 1 INCH	AND SMALLER	8 FEET	1/2"
COPPER TUBE, 1 1/4 IN	ICH AND LARGER	10 FEET	1/2"

PIPE AND VALVE IDENTIFICATION

4.1 PROVIDE PIPE LABELING IDENTIFICATION PER ASME A13.1. SEE DETAIL FOR ADDITIONAL INFORMATION.

VALVES

5.1 PLUMBING CONTRACTOR SHALL PROVIDE ALL REQUIRED ISOLATION VALVES PER I.D.P.H. SECTION 890.1190. VALVES SHALL BE INSTALLED TO ISOLATE ONE ROOM WITHOUT AFFECTING WATER SUPPLY TO ANY OTHER ROOM. ONLY EXCEPTION SHALL BE DIRECT BACK-TO-BACK FIXTURES SERVING PUBLIC SPACES.

- 5.2 INSTALL BALL VALVES ON PIPING 3" AND SMALLER AND OS&Y GATE VALVES ON PIPING 4" AND LARGER IN EACH RISER OR BRANCH TAKEOFF FROM MAINS, RISERS AND AS INDICATED ON DRAWINGS.
- 5.3 BALL VALVES SHALL BE MILWAUKEE, NIBCO, STOCKHAM, APOLLO, KITZ, WATTS, OR JOMAR; LEAD FREE NSF-61 CERTIFIED, WITH BRONZE TWO PIECE BODY, STAINLESS STEEL BALL, TEFLON SEATS AND STUFFING BOX RING, LEVER HANDLE, SOLDER ENDS, FULL PORT AND CONFORM TO MSS SP-110. WHEN PRESS FITTINGS ARE USED, VIEGA OR NIBCO SHALL BE AN ACCEPTABLE MANUFACTURER OF BALL VALVES.
- 5.4 CHECK VALVES SHALL BE MILWAUKEE, NIBCO, STOCKHAM, APOLLO, KITZ, WATTS, OR JOMAR; LEAD FREE NSF-61 CERTIFIED WITH BRONZE BODY, BRONZE HORIZONTAL SWING DISC AND CONFORM TO MSS SP-80.
- 5.5 STRAINERS SHALL BE WATTS, KECKLEY, LESLIE, WILKINS, KITZ, OR NIBCO; LEAD FREE NSF-61 CERTIFIED, BRONZE BODY, WITH 1/32 INCH STAINLESS STEEL PERFORATED SCREEN AND 3/4" BLOW DOWN VALVE.
- 5.6 CIRCUIT SETTER SHALL BE BELL & GOSSETT, NIBCO, WATTS, ARMSTRONG, ILLINOIS, HCI, NEXUS; LEAD FREE NSF-61 CERTIFIED, CALIBRATED BALL TYPE BALANCING VALVE WITH PRECISION MACHINED ORIFICE, READOUT VALVES EQUIPPED WITH INTEGRAL CHECK VALVES AND GASKETED CAPS, CALIBRATED, NAMEPLATE AND INDICATING POINTER.
- 5.7 INSTALL VALVES WITH STEMS UPRIGHT OR HORIZONTAL, NOT INVERTED.
- 5.8 INSTALL VALVES WITH CLEARANCE FOR INSTALLATION OF INSULATION AND ALLOWING ACCESS.
- 5.9 PROVIDE ACCESS TO ALL VALVES AND SYSTEM COMPONENTS REQUIRING ACCESS. ALL PIPING ACCESSORIES AND EQUIPMENT SUCH AS ISOLATION VALVES AND IN-LINE PUMPS SHALL BE INSTALLED AT A REASONABLE HEIGHT AND POSITION IN ORDER TO FACILITATE MAINTENANCE.

WATER SHUT-DOWN

- 6.1 CONTRACTOR SHALL PROVIDE ALL MEANS TO SHUT-DOWN EXISTING PIPING SYSTEMS WHERE REQUIRED TO COMPLETE WORK UNDER THIS CONTRACT. CONTRACTOR SHALL PROVIDE ALL NECESSARY VALVES TO ISOLATE RENOVATED SECTIONS OF THE BUILDING WITHOUT DISTURBING SECTIONS OF THE BUILDING NOT UNDER RENOVATION. CONTRACTOR SHALL PROVIDE ALL MEANS TO DRAIN WATER SUPPLY PIPING WHERE REQUIRED TO MODIFY PIPING CONFIGURATION OR MAKE NEW CONNECTIONS TO EXISTING PIPING. CONTRACTOR SHALL BE RESPONSIBLE FOR ANY WATER DAMAGE CAUSED BY DRAINING OF WATER SUPPLY PIPING. UPON REACTIVATION OF WATER IN PIPING, CONTRACTOR SHALL OPERATE ALL ASSOCIATED FAUCETS, FLUSH VALVES, HOSE VALVES, PLUMBING FIXTURES AND REMOVE ALL REMAINING AIR IN THE SYSTEM.
- 6.2 ALL TIMES OF WATER SHUT-DOWN ARE SUBJECT TO OWNERS DISCRETION AND MAY HAVE RESTRICTIONS BASED ON SCHEDULED EVENTS AT FACILITY. ALL ASPECTS OF WATER SHUT-DOWN SHALL BE COORDINATED WITH OWNER.

FIRE STOP SYSTEMS

7.1 PROVIDE FIRE RATED SEALANT AROUND ALL NEW PENETRATIONS FOR PIPING, CONDUIT, ETC. AT WALLS, FLOORS AND CEILINGS. GENERAL PURPOSE FIRE STOPPING SEALANT SHALL BE DOW CORNING, NELSON OR 3M COMPANY; WATER BASED, NON SLUMPING, PREMIXED SEALANT WITH INTUMESCENT PROPERTIES, RATED FOR 3 HOURS PER ASTM E814, NFPA AND UL-1479. FILL ALL VOIDS AROUND ALL PIPING PENETRATIONS THROUGH WALLS AND CEILINGS WITH A MINIMUM 1 HOUR FIRE RATING. PROVIDE PVC COLLAR ASSEMBLY AT ALL PVC PIPING PENETRATIONS THROUGH FIRE WALLS, FLOORS OR CEILING WHERE REQUIRED BY LOCAL FIRE DISTRICT.

PIPE ROUTING AND REPLACEMENT

- 8.1 PLUMBING CONTRACTOR SHALL BE RESPONSIBLE FOR DISMANTLING THE EXISTING SUSPENDED ACOUSTICAL CEILING TILE SYSTEM AND REINSTALLING CEILING AS REQUIRED TO ACCOMMODATE THE INSTALLATION OF NEW PIPING.
- 8.2 PLUMBING CONTRACTOR SHALL BE RESPONSIBLE FOR ALL DAMAGE CAUSED TO SUSPENDED CEILING MATERIALS BY THE DISMANTLING, STORAGE AND REINSTALLATION OF CEILING MATERIALS.
- 8.3 PLUMBING CONTRACTOR SHALL BE RESPONSIBLE TO VERIFY THAT ALL PLUMBING FIXTURES EFFECTED BY THE REMOVAL OR ABANDONMENT OF THE EXISTING WATER SUPPLY PIPING IS STILL FUNCTIONAL AT THE COMPLETION OF THE PROJECT.
- 8.4 PLUMBING CONTRACTOR SHALL BE RESPONSIBLE FOR ALL CORING THROUGH WALLS, PIPE HANGERS AND MODIFICATIONS TO STRUCTURE FOR THE INSTALLATION OF PIPE HANGERS. CONTRACTOR SHALL BE REQUIRED TO PROVIDE FLOOR MOUNTED POSTS WITH STRUCTURAL BRIDGING BELOW LARGE DUCTWORK WHERE TYPICAL TOP OF DECK MOUNTED PIPE HANGERS ARE NOT CAPABLE OF BEING INSTALLED.
- 8.5 PIPE SIZES INDICATED ON DRAWINGS ARE MINIMUMS. CONTRACTOR SHALL MATCH PIPE SIZE WHEN CONNECTING TO EXISTING PIPING LARGER THAN SIZED LISTED.
- 8.6 NEW PIPING SHALL NOT BE PERMITTED OVER ANY ELECTRICAL PANELS OR EQUIPMENT.
- 8.7 NEW PIPE ROUTING SHALL NOT INTERFERE WITH NORMAL MAINTENANCE OPERATION OF EXISTING EQUIPMENT, ACCESS PANELS, DUCTWORK ACCESS PANELS, DUCTWORK ACCESSORIES, AND ALL HVAC AND ELECTRICAL EQUIPMENT.
- 8.8 ALL PIPING, FITTINGS AND JOINTS SHALL COMPLY WITH THE STATE AND LOCAL AMENDMENTS AND THE AUTHORITY HAVING JURISDICTION. MATERIALS LISTED IN THE SPECIFICATION THAT DO NOT COMPLY WITH THESE AMENDMENTS SHALL NOT BE USED IN THE BIDDING PROCESS. IT SHALL BE THE CONTRACTOR'S RESPONSIBILITY TO VERIFY THESE ADOPTED AMENDMENTS.
- 8.9 WATER SUPPLY PIPING SIZES SHOWN ON DRAWING ARE BASED ON COPPER PIPING. SANITARY, VENT AND STORM PIPING SIZES SHOWN ARE BASED ON CAST IRON PIPING. INNER DIAMETERS SHALL BE REVIEWED WITH IDPH STATE PLUMBING INSPECTOR PRIOR TO INSTALLATION AND SHALL BE OF SUFFICIENT SIZE TO PROVIDE ADEQUATE FLOW AT MINIMAL PRESSURE DROP TO INSURE PLUMBING FIXTURES OPERATE TO OWNER'S SATISFACTION.

SHOP DRAWINGS, SUBMITTALS AND CLOSE OUT DOCUMENTS

- 9.1 CONTRACTOR SHALL SUBMIT ELECTRONIC COPIES IN PDF FORMAT SHOP DRAWINGS OF ALL PIPING, VALVES, PIPE HANGERS, PIPE INSULATION, MISC DEVICES, PUMPS, MIXING VALVES, PLUMBING FIXTURES, ACCESS PANELS, EQUIPMENT, TO ENGINEER FOR APPROVAL PRIOR TO ORDERING ANY ITEMS OR FABRICATING ANY DUCTWORK. SUBMITTALS SHALL BE RETURNED WITHIN TEN BUSINESS DAYS.
- 9.2 CONTRACTOR SHALL PROVIDE OWNER TRAINING ON ALL EQUIPMENT AND BUILDING SYSTEMS PROVIDED/ALTERED BY HIS WORK. TRAINING SHALL BE ACCOMPLISHED DURING TIME DEDICATED FOR THAT PURPOSE, NOT IN CONJUNCTION WITH SERVICE WORK.
- 9.3 AT COMPLETION OF PROJECT, CONTRACTOR SHALL SUBMIT PDF FORMAT OF OPERATION AND MAINTENANCE MANUALS FOR ALL WORK PROVIDED BY HIM ON PROJECT. MANUALS SHALL BE CLEARLY ORGANIZED AND CONTAIN COPIES OF APPROVED EQUIPMENT, COMPONENT BREAK-DOWN AND PARTS LISTS, MAINTENANCE/CLEANING AND TROUBLESHOOTING MANUALS, SERVICE CONTACTS, CONTRACTOR AND MANUFACTURER WARRANTEES, AND "AS BUILT" FLOOR PLANS INDICATING ALL APPROVED DEVIATIONS AND REVISIONS TO BIDDING DOCUMENTS.

BIDDING NOTE

SEE DRAWING ME1.00 FOR GENERAL
NOTES AND ADDITIONAL DETAILS
APPLICABLE TO THIS TRADE'S WORK.

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HENRY COUNTY COI

M M

KEY PLAN:

SHEET STATUS: 9.19.23

ISSUED FOR BIDS

NO: DESCRIPTION: DATE:

PLUMBING GENERAL NOTES, SYMBOLS AND ABBREVIATIONS

SHEET NUMBER:

P3.0

9/19/2023 11:37:58 AM

	DRAINAGE FIXTURE SCHEDULE										
PLUMBING FIXTURE TAG	TYPE	MANUFACTURER AND MODEL	The state of the s								
<u>FD-1</u>	FLOOR DRAIN	MIFAB, MODEL F1100	ANSIA112.21.1; LACQUERED CAST IRON BODY WITH DOUBLE DRAINAGE FLANGE, WEEPHOLES, AND ROUND ADJUSTABLE NICKEL BRONZE STRAINER, SQUARE STRAINER IN FLOORS WITH CERAMIC TILE.	J.R. SMITH, WADE, MIFAB JOSAM, WATTS							
<u>FD-2</u>	FLOOR DRAIN	MIFAB, MODEL FS1730-150	ANSI A112.21.1; 12" SQUARE, 8" DEEP, PORCELAIN ENAMEL CAST IRON FLOOR SINK WITH STAINLESS STEEL DOME STRAINER AND HALF GRATE.	J.R. SMITH, WADE, MIFAB JOSAM, WATTS							
<u>FCO</u>	FLOOR CLEANOUT	MIFAB, MODEL C1224 MIFAB, MODEL C1226	ANSI A112.21.1; LACQUERED CAST IRON BODY WITH DOUBLE DRAINAGE FLANGE, INTERIOR FINISHED FLOOR AREAS (FCO) LACQUERED CAST IRON BODY, ABS GASKETED PLUG AND ADJUSTABLE ROUND SCORIATED COVER. PROVIDE CARPET MARKER AT LOCATION WHERE NOTED.	J.R. SMITH, WADE, MIFAB JOSAM, WATTS							
<u>WCO</u>	WALL CLEANOUT	MIFAB, MODEL 1460-RD-3	INTERIOR FINISHED WALL AREAS: LINE TYPE WITH LACQUERED CAST IRON BODY AND ROUND BRASS GASKETED PLUG AND ROUND STAINLESS STEEL ACCESS COVER SECURED WITH MACHINE SCREW.	J.R. SMITH, WADE, ZURN JOSAM, WATTS							

	DOMESTIC WATER HEATER SCHEDULE											
EQUIPMENT TAG	LOCATION	MANUELOTUDED	MODEL	TYPE	INPUT	TANK VOLUME	GPH 90°	ELECTRICAL			NOTEO	
	LOCATION MANUFACTUR	MANUFACTURER	MODEL			(GALLONS)	TEMP. RISE	AMP.	PHASE	VOLT	NOTES	
DWH-1	JAN CLOSET	A.O. SMITH	GCV-40	GAS FIRED	40,000 BTUH	40			1	120	1,2	
NOTES:	NOTES: 1. OTHER ACCEPTABLE MANUFACTURERS: SEE SPECIFICATIONS.											

NOTES: 1. OTHER ACCEPTABLE MANUFACTURERS: SEE SPECIFICATIONS 2. PRESSURE AND TEMPERATURE RELIEF VALVE.

	PLUMBING PUMP SCHEDULE											
EQUIPMENT	LOCATION	SERVICE	MANUFACTURER	MODEL	TYPE	GPM HEAD		RPM	MOTOR			NOTES
TAG					111 🗠	GI W	vi (FT.)	I ti ivi	WATTS	PHASE	VOLT	NOTES
DWP-1	JAN CLOSET	DOMESTIC HOT WATER RECIRCULATION (120 LOOP)	BELL & GOSSETT	NBF-12	INLINE, ALL BRONZE	2.0	10	1725	55	1	115	1,2

NOTES

1. OTHER ACCEPTABLE MANUFACTURERS: SEE SPECIFICATIONS.

2. PROVIDE 120V. AQUASTAT TO CONTROL PUMP ON/OFF.

3. BLADDER SHALL BE MADE OF HEAVY DUTY BUTYL RUBBER.

	DOMESTIC WATER EXPANSION TANK SCHEDULE									
EQUIPMENT TAG	LOCATION	SERVICE	MANUFACTURER	MODEL	TYPE	CAPACITY	CONNECTION SIZE (IN)	NOTES		
DWET-1	JAN CLOSET	DOMESTIC WATER SYSTEM	WESSELS	T-5	BLADDER	1.3 GAL. ACCEPT. 2.1 GAL. TANK	3/4"	1,2,3		
<u>NOTES:</u> 1.	NOTES: 1. OTHER ACCEPTABLE MANUFACTURERS: SEE SPECIFICATIONS.									

2. TANK TO BE SPECIFICALLY FOR USE IN POTABLE WATER SYSTEMS, NSF/ANSI STANDARD 61 CERTIFIED.

LUMBING FIXTURE TAG	TYPE	MANUFACTURER AND MODEL	DESCRIPTION	OTHER ACCEPTABLE MANUFACTURERS	NOTES
<u>WC-1</u>	WATER CLOSET	BOWL: KOHLER KINGSTON K-4325 FLUSH VALVE: SLOAN OPTIMA PLUS G2 8111-1.28 SEAT: BEMIS 2155-SSCT CARRIER: ZURN EZCARRY Z1201	WALL HUNG, SIPHON JET, 1.28 GALLON FLUSH, WHITE VITREOUS CHINA BOWL WITH ELONGATED BOWL & 1 1/2" TOP SPUD. FLUSH VALVE: EXPOSED CHROME PLATED, BATTERY POWERED SENSOR ACTIVATED, 1.28 GALLONS PER FLUSH, INTEGRAL SCREWDRIVER STOP AND VACUUM BREAKER. SEAT: WHITE, ELONGATED, OPEN FRONT, ANTI-MICROBACTERIAL. CARRIER: ADJUSTABLE HORIZONTAL CONFIGURATION, 500 LB WEIGHT RATING. FIXTURE SHALL BE WATERSENSE CERTIFIED.	BOWL: NONE. FLUSH VALVE: NONE. SEAT: CHURCH, OLSONITE & SPERZAL CARRIER: JR SMITH, WADE, MIFAB	1,2,9,10
<u>WC-2</u>	WATER CLOSET	SAME AS WC-1	SAME AS WC-1, (INSTALLED AT ADA HEIGHT.)	SAME AS WC-1	1.9.10
<u>U-1</u>	URINAL	BOWL: KOHLER KINGSTON K-4991-ET FLUSH VALVE: SLOAN OPTIMA G2 8186-0.5 CARRIER: ZURN MODEL Z1221	CHINA: WALL MOUNTED, WHITE VITREOUS CHINA WITH 3/4" TOP SPUD. CHINA SHALL BE UNIVERSAL FLOW COMPATIBLE AND OPERATE IN THE RANGE OF 0.125 TO 1.0 GPF. FLUSH VALVE: EXPOSED CHROME PLATED, BATTERY OPERATED SENSOR, (0.5) GALLONS PER FLUSH, INTEGRAL SCREWDRIVER STOP AND VACUUM BREAKER. CARRIER: LACQUERED STEEL FRAME WITH LEGS, FEET FOR FLOOR ATTACHMENT, TOP AND BOTTOM ADJUSTABLE UNIVERSAL SUPPORT PLATES.	BOWL: NONE. FLUSH VALVE: NONE. CARRIER: JR SMITH, WADE, MIFAB	1,2,9,10
<u>U-2</u>	URINAL	SAME AS U-1	SAME AS U-1, (INSTALLED AT ADA HEIGHT.)	SAME AS U-1	1,9,10
<u>L-1</u>	LAVATORY	BASIN: BOWL INTEGRAL TO COUNTER, SPECIFIED ELSEWHERE TRIM: SLOAN OPTIMA MODEL EBF-650	SEE ARCHITECTURAL DRAWINGS FOR LAVATORY BOWL SPEC. FAUCET: DECK MOUNTED CHROME PLATED, BATTERY OPERATED SENSOR, 4" CENTERS WITH 0.5 GPM VANDAL RESISTANT AERATOR. 3-YEAR MANUF. WARRANTY ON ELEC. FAUCET. FIXTURE SHALL BE WATERSENSE CERTIFIED.	BOWL: NONE. FAUCET: NONE.	1,2,3,4,5, 7,9
<u>L-2</u>	LAVATORY	BASIN: KOHLER KINGSTON K-2005 TRIM: SLOAN OPTIMA MODEL EBF-650 CARRIER: ZURN MODEL Z1231	WHITE VITREOUS CHINA WALL HUNG LAVATORY, 21x18 MINIMUM, 5" HIGH BACK, DRILLINGS ON 4" CENTERS, CONCEALED ARM SUPPORT, RECTANGULAR BASIN WITH SPLASH LIP AND FRONT OVERFLOW. FAUCET: DECK MOUNTED CHROME PLATED, BATTERY OPERATED SENSOR, 4" CENTERS WITH 0.5 GPM VANDAL RESISTANT AERATOR, . CARRIER: LACQUERED STEEL FRAME WITH LEGS, FEET FOR FLOOR ATTACHMENT, CONCEALED ARMS. 3-YEAR MANUF. WARRANTY ON ELEC. FAUCET. FIXTURE SHALL BE WATERSENSE CERTIFIED.	BOWL: NONE. FAUCET: NONE. CARRIER: JR SMITH, WADE, MIFAB, JOSAM, WATTS	1,2,3,4,5 7,9,10
<u>S-1</u>	SINK	BASIN: ELKAY, MODEL LUSTERTONE ELUHAD211555 TRIM: MOEN COMMERCIAL MODEL 8225-SMF15	ASME A112.19.3; 23.5"L x 18.25"W x 5.5"D INCH OUTSIDE DIMENSIONS, 18 GAUGE, TYPE 304 STAINLESS STEEL, UNDERMOUNT. FAUCET SHALL BE CHROME PLATED BRASS SUPPLY WITH 8" SWING SPOUT, WATER ECONOMY AERATOR WITH MAXIMUM 1.5 GPM FLOW RATE, WITH INDEXED WRISTBLADE LEVER HANDLES ON 8" CENTERS.	BASIN: JUST TRIM: T&S BRASS, ZURN, CHICAGO FAUCET	1,2,3,5,7, 9,11
<u>S-2</u>	SINK	BASIN: ELKAY, MODEL LUSTERTONE ELUHAD211555 TRIM: MOEN COMMERCIAL MODEL 8225-SMF15	ASME A112.19.3; 23.5"L x 18.25"W x 5.5"D INCH OUTSIDE DIMENSIONS, 18 GAUGE, TYPE 304 STAINLESS STEEL, UNDERMOUNT. FAUCET SHALL BE CHROME PLATED BRASS SUPPLY WITH 8" SWING SPOUT, WATER ECONOMY AERATOR WITH MAXIMUM 1.5 GPM FLOW RATE, WITH INDEXED WRISTBLADE LEVER HANDLES ON 8" CENTERS.	BASIN: JUST TRIM: T&S BRASS, ZURN, CHICAGO FAUCET	1,2,3,5,7 9,11
<u>S-3</u>	SINK	BASIN: ELKAY, MODEL LUSTERTONE ELUHAD211555 TRIM: MOEN COMMERCIAL MODEL 8225-SMF15	ASME A112.19.3; 23.5"L x 18.25"W x 5.5"D INCH OUTSIDE DIMENSIONS, 18 GAUGE, TYPE 304 STAINLESS STEEL, UNDERMOUNT. FAUCET SHALL BE CHROME PLATED BRASS SUPPLY WITH 8" SWING SPOUT, WATER ECONOMY AERATOR WITH MAXIMUM 1.5 GPM FLOW RATE, WITH INDEXED WRISTBLADE LEVER HANDLES ON 8" CENTERS.	BASIN: JUST TRIM: T&S BRASS, ZURN, CHICAGO FAUCET	1,2,3,5,7 9,11
<u>EWC-1</u>	ELECTRIC WATER COOLER	FOUNTAIN: ELKAY, MODEL LZS8WSSP	ARI 1010; SINGLE STATION WALL MOUNTED ELECTRIC WATER COOLER WITH BOTTLE FILLING STATION, WATER FILTER, STAINLESS STEEL BODY, ELEVATED ANTI-SQUIRT BUBBLER, LOWER STAINLESS STEEL SHROUD.	NONE.	1,2,3,5
EWC-2	ELECTRIC WATER COOLER	FOUNTAIN: ELKAY, MODEL LZSTL8WSSP	ARI 1010; TWO STATION WALL MOUNTED ELECTRIC WATER COOLER WITH BOTTLE FILLING STATION, WATER FILTER, STAINLESS STEEL BODY, ELEVATED ANTI-SQUIRT BUBBLER, LOWER STAINLESS STEEL SHROUD.	NONE.	1,2,3,5
<u>TMV-1</u>	THERMOSTATIC MIXING VALVE	LEONARD MODLE 170LF	ASSE 1070; CAST BRASS BODY WITH ROUGH BRONZE FINISH, LOCKING TEMPERATURE REGULATOR, WITH INTEGRAL CHECK VALVES AND INLINE SCREENS ON BOTH INLETS.	POWERS, WATTS, ZURN.	
<u>RPZ-1</u>	BACKFLOW PREVENTER	WATTS LF909 (OSY)(S) SERIES	2 1/2" AND LARGER - ASSE 1013; REDUCED PRESSURE ZONE BACKFLOW PREVENTER WITH STRAINER AND OS&Y GATE VALVES, BFP SHALL BE LEAD FREE AND HAVE PRESSURE DIFFERENTIAL RELIEF VALVE LOCATED IN A ZONE BETWEEN TWO POSITIVE SEATING CHECK VALVES. SIZE AS INDICATED ON DRAWING.	ZURN- WILKINS, APOLLO	
<u>WH-1</u>	WALL HYDRANT	WOODFORD MODEL B65	ASSE 1019; NON-FREEZE, HEAVY DUTY CHROME LOCKABLE RECESSED BOX, 3/4" HOSE THREAD SPOUT, LOCKSHIELD AND REMOVABLE KEY, AND INTEGRAL SELF-DRAINING VACUUM BREAKER.	JR SMITH, WADE, MIFAB, ZURN	

PLUMBING FIXTURE SCHEDULE

NOTES: 1. MOUNTING HEIGHTS SHALL BE COORDINATED AND VERIFIED WITH ARCHITECTURAL DRAWINGS. ROUGH-IN HEIGHTS SHALL BE COORDINATED WITH FIXTURE MOUNTING HEIGHTS. ROUGH-IN HEIGHTS SHALL BE ADJUSTED ACCORDINGLY TO ACCOMMODATE FIXTURE HEIGHT AND FIXTURE CHARACTERISTICS.

2. FIXTURE SHALL BE ADA COMPLIANT AND MOUNTED AT HANDICAP HEIGHT. SEE ARCHITECTURAL DRAWINGS FOR MOUNTING HEIGHTS.

3. PROVIDE CHROME PLATED 17 GAGE BRASS P-TRAP AND ARM ESCUTCHEON.

4. PROVIDE CHROME PERFORATED OPEN STRAINER.
5. PROVIDE (BRASSCRAFT MODEL KTSCR19XC) CHROME QUARTER-TURN AND

5. PROVIDE (BRASSCRAFT MODEL KTSCR19XC) CHROME QUARTER-TURN ANGLE STOP VALVES WITH LOOSE KEY, CHROME ESCUTCHEONS, CHROME PLATED RIGID SUPPLIES OR APPROVED EQUAL.

6. INSULATE P-TRAP, DRAIN AND SUPPLY PIPING WITH TRUEBRO OR PLUMBEREX MODEL X4333 INSULATION OR APPROVED EQUAL. MATERIAL SHALL BE MOLDED (PVC) POLYVINYL CHLORIDE BASED, FOAM BASED MATERIAL WILL NOT BE PERMITTED. WHITE IN COLOR.

7. PROVIDE ASSE 1070 POINT OF USE THERMOSTATIC MIXING VALVE TYPE TMV-1 WITH CHROME RIGID SUPPLIES.

8. PROVIDE ELKAY MODEL LK35 STRAINER BASKET

9. CAULK FIXTURE TO FLOOR, WALL OR COUNTER TOP WITH MATCHING COLOR CAULK.
10. ELECTRONIC FLUSH VALVES AND FAUCETS SHALL HAVE A MINIMUM 3-YEAR WARRANTY.

11. FAUCETS ON 8" CENTERS SHALL HAVE INTERCONNECTING COPPER TUBING.

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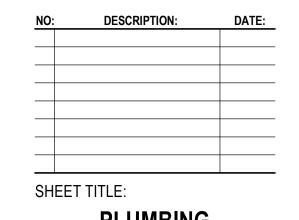
CIVIL ENGINEERS

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1391 CORPORATE DRIVE, SUITE
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HENRY COUNTY COI

KEY PLAN:

SHEET STATUS: 9.19.23
ISSUED FOR BIDS





SCHEDULES


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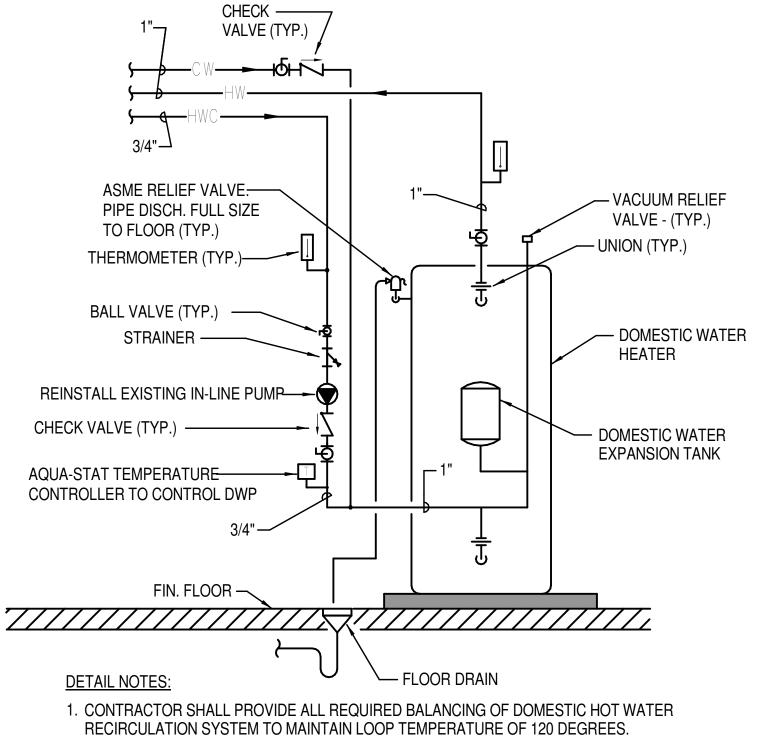


WATER SERVICE DETAIL NOTES: 1. PLUMBING CONTRACTOR SHALL PROVIDE CROSS CONNECTION CONTROL DEVICE TESTING AND CERTIFICATION AT ALL REDUCED PRESSURE ZONE BACKFLOW PREVENTERS. CERTIFICATION SHALL BE POSTED AT BACKFLOW PREVENTER. 2. WATER METER SHALL BE PURCHASED BY THE CONTRACTOR FROM THE LOCAL

PUBLIC WORKS WATER DEPARTMENT AND INSTALLED BY THE PLUMBING CONTRACTOR 3. PROVIDE FULL PORT OS&Y GATE VALVES ON INLET AND OUTLET OF WATER METER, PROVIDE DRAIN VALVE AT OUTLET OF METER.

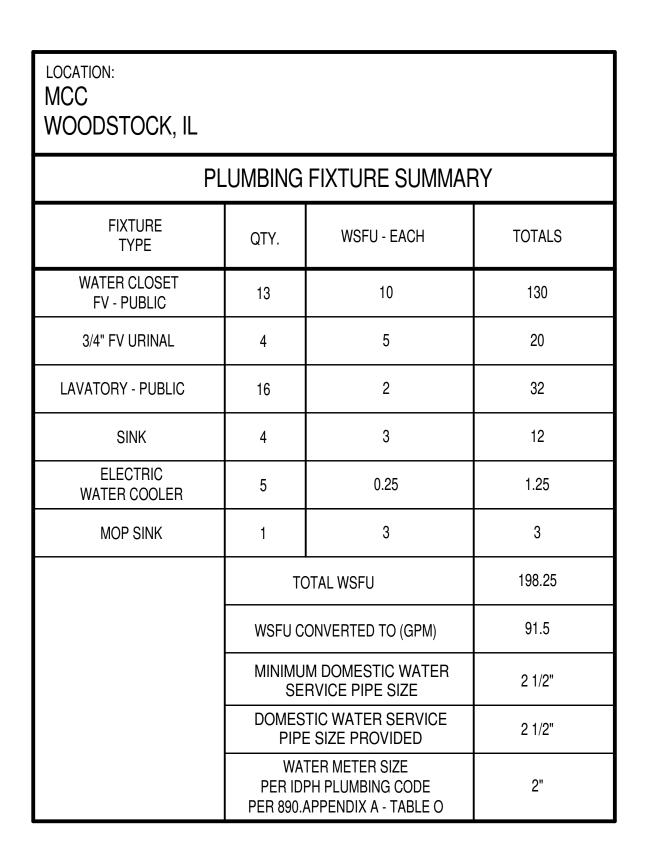
4. MAINTAIN AIR GAP AT RPZ DRAIN TO FLOOR DRAIN, PROVIDE DOWNWARD ELBOW TO DIRECT WATER TO INSIDE RECEPTOR.

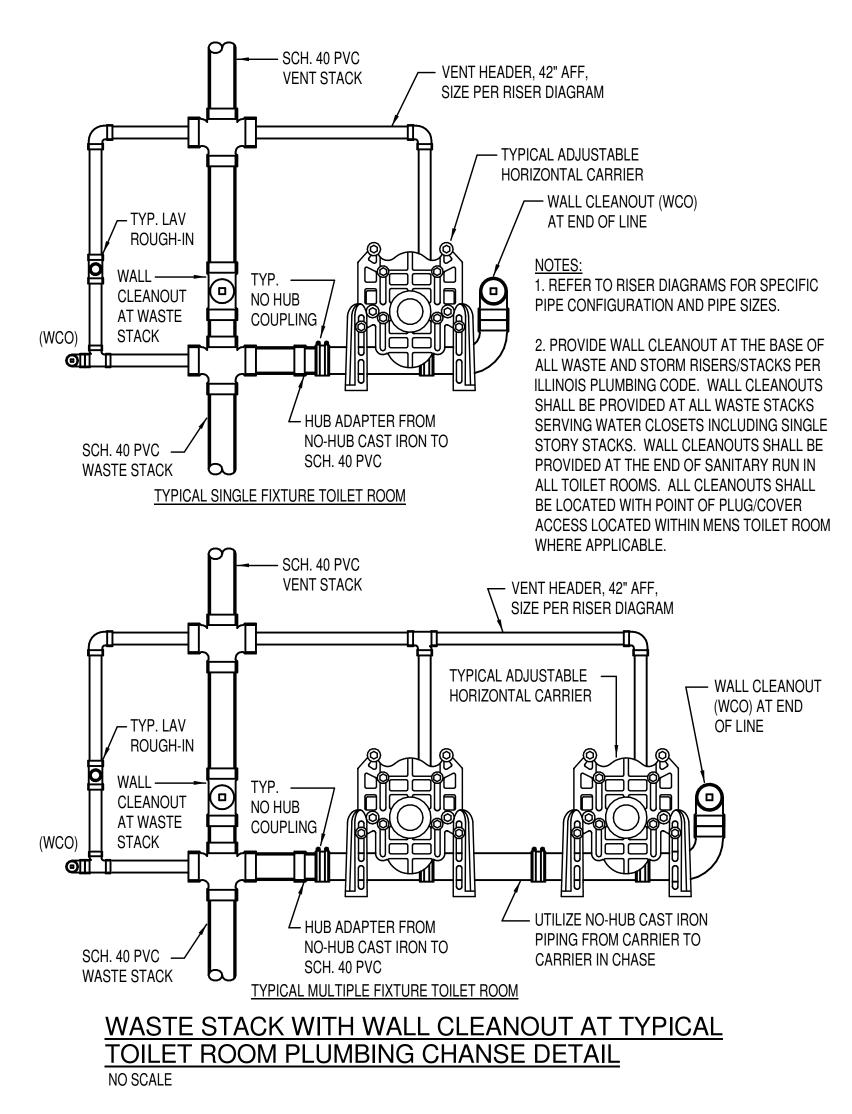
WATER SERVICE DIAGRAM

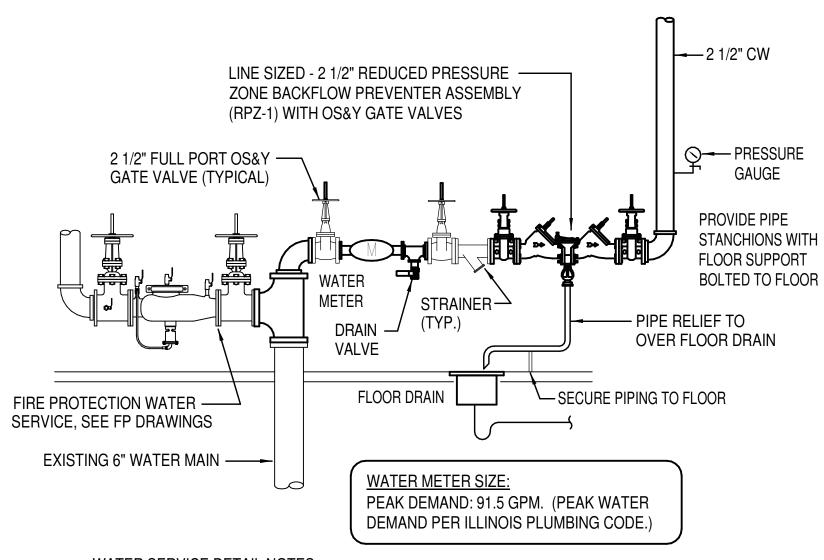

CONTRACTOR SHALL INSTALL ADDITIONAL CHECK VALVES, BALL VALVES AND/OR BALANCING VALVES AS PART OF THIS BID THROUGHOUT THE ENTIRE RECIRC PIPING SYSTEM IN ORDER TO ACHIEVE A FULLY FUNCTIONAL 120 DEGREE LOOP.

DOMESTIC WATER HEATER DETAIL NO SCALE

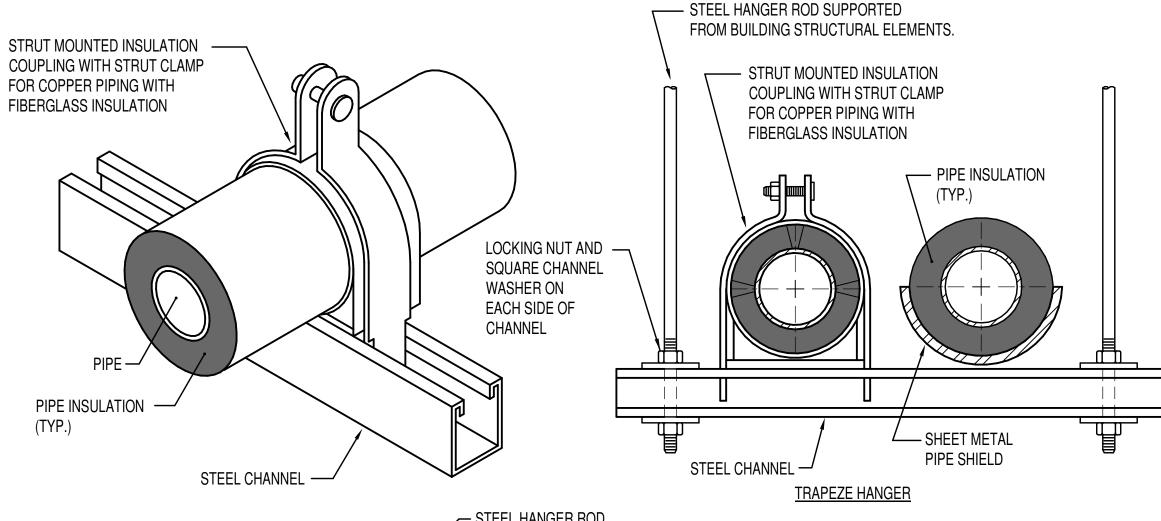


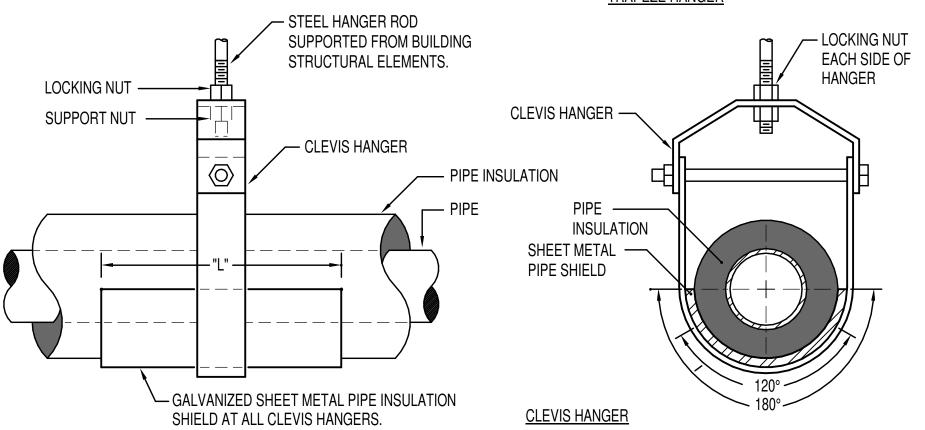

- 1. CONFER WITH ARCHITECT AND REFER TO STRUCTURAL DRAWINGS FOR ADDITIONAL INFORMATION ON ACCEPTABLE METHODS AND LOCATIONS FOR HANGER SUPPORTS.
- 2. WHEN WATER SUPPLY PIPING IS INSTALLED IN PARALLEL AND SAME ELEVATION, PROVIDE TRAPEZE HANGERS. PIPING SHALL REST ON SHEET METAL SHIELD AT EACH TRAPEZE HANGER WITH ATTACHMENT TO STEEL CHANNEL EVERY 30 FEET UTILIZING A STRUT MOUNTED INSULATION COUPLING WITH STRUT CLAMP FOR USE WITH COPPER PIPING AND FIBERGLASS INSULATION.

PIPE INSULAT	PIPE INSULATION SHIELD SCHEDULE								
PIPE SIZE	LENGTH	GAUGE							
UP TO 3/4"	8"	20 GA.							
1" - 2"	12"	18 GA.							
2 1/2" - 4"	12"	16 GA.							
5" & 6"	18"	16 GA.							
8" & UP	24"	14 GA.							

TYPICAL PIPE HANGER DETAILS NO SCALE

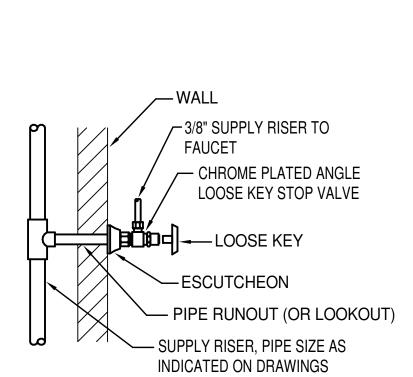


NOTE: PIPE RUNOUT OR LOOKOUT SHALL BE DEFINED AS THE HORIZONTAL PIPE FROM THE SUPPLY RISER STUBBED THRU WALL TO STOP VALVE OR FLUSH VALVE

AT FIXTURE.		
PIPE RUNOUT (OR LOC	KOUT) SCHEDULE	
PLUMBING FIXTURE	SUPPLY RISER SIZE	PIPE RUNOUT SIZE
LAVATORY	3/4"	1/2"
SHOWER	3/4"	1/2"
SINK	3/4"	1/2"
DRINKING FOUNTAIN	3/4"	1/2"
WATER CLOSETS WITH FLUSH VALVE	1 1/4"	1"
URINAL WITH FLUSH VALVE	1"	3/4"

PIPE RUNOUT SIZING DETAIL

NO SCALE

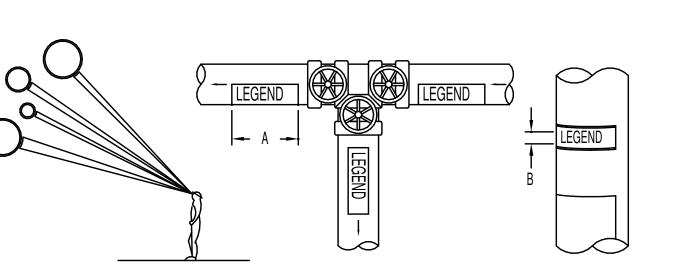

IDENTIFICATION MARKERS OR STRIPS TO BE PLACED ON ALL EXPOSED COVERED AND UNCOVERED PIPES AT 50'-0" INTERVALS, ADJACENT TO ALL VALVES OR BRANCHES, AND AT BOTH SIDES OF WALL/FLOOR PENETRATIONS. ARROWS OF SAME COLOR AS IDENTIFICATION MARKERS SHALL ALSO BE PLACED ON PIPES POINTING AWAY FROM MARKER INDICATING DIRECTION OF FLOW.

SIZE (OF LEGEND LETTERS	
OUTSIDE DIAMETER	LENGTH OF	SIZE OF
OF PIPE	COLOR FIELD	LETTERS
OR COVERING	A	B
3/4" TO 1 1/4"	8"	1/2"
1 1/2" TO 2"	8"	3/4"
2" 1/2" TO 6"	12"	1 1/4"
8" TO 10"	24"	2 1/2"
OVER 10"	32"	3 1/2"

SERVICE	BACKGROUND OR COLOR BAND	IDENTIFICATION MARKER
SANITARY DRAIN STORM WATER PLUMBING VENT PLUMBING OIL VENT DOMESTIC COLD WATER DOMESTIC HOT WATER	GREEN GREEN GREEN GREEN GREEN GREEN GREEN	WHITE ON GREEN
DOMESTIC HOT WATER CIRC. NON POTABLE WATER	GREEN GREEN	WHITE ON GREEN WHITE ON GREEN

TYPICAL PIPE IDENTIFICATION MARKERS NO SCALE

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> OUN S E

KEY PLAN:

SHEET STATUS: 9.19.23 **ISSUED FOR BIDS**

NO: DESCRIPTION: DATE: SHEET TITLE:

PLUMBING DETAILS

SHEET NUMBER:

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DRAWING NOTES

- I EXISTING MECHANICAL EQUIPMENT TO REMAIN. PROTECT EXISTING ELECTRICAL FEED TO MAINTAIN PROPER OPERATION OF EQUIPMENT. AT THE SOURCE OF THE FEEDER, PROVIDE NEW JUNCTION BOX AND SPLICE CONDUCTORS OF MATCHING GAUGE FOR EXTENSION TO NEW PANEL "PP-3". CONDUCTORS SHALL BE MINIMUM SIZE OF #1 OAWG. INFORM ARCHITECT/ENGINEER IF OTHERWISE. TERMINATE BRANCH CIRCUITS TO NEW CIRCUIT BREAKERS OF SAME SIZE AS PREVIOUSLY INSTALLED. FIELD VERIFY EXACT REQUIREMENTS.
- 2 DISCONNECT AND PULL BACK EXISTING EXTERIOR LIGHTING CIRCUITS TO REMAIN. PROTECT DURING CONSTRUCTION FOR EXTENSION TO NEW PANEL "LP-I". PROVIDE NEW JUNCTION BOX AND SPLICE CONDUCTORS OF MATCHING GAUGE TO MAINTAIN FUNCTIONALITY OF EXISTING EXTERIOR LIGHTING. FIELD VERIFY EXACT REQUIREMENTS.



1 ELECTRICAL DEMOLITION PLAN

GENERAL DEMOLITION NOTE:

CAREFULLY DISCONNECT, REMOVE AND TURN OVER REMOVED LOW VOLTAGE DEVICE/EQUIPMENT INCLUDING, BUT NOT LIMITED TO, WIRELESS ACCESS POINTS, SECURITY CAMERAS, SPECIALTY LIGHTING, AUDIO/VIDEO EQUIPMENT, AUDIO/VIDEO RACK, CARD READERS, ETC. TO OWNER'S REPRESENTATIVE.

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KEY PLAN:

SHEET STATUS: 9.19
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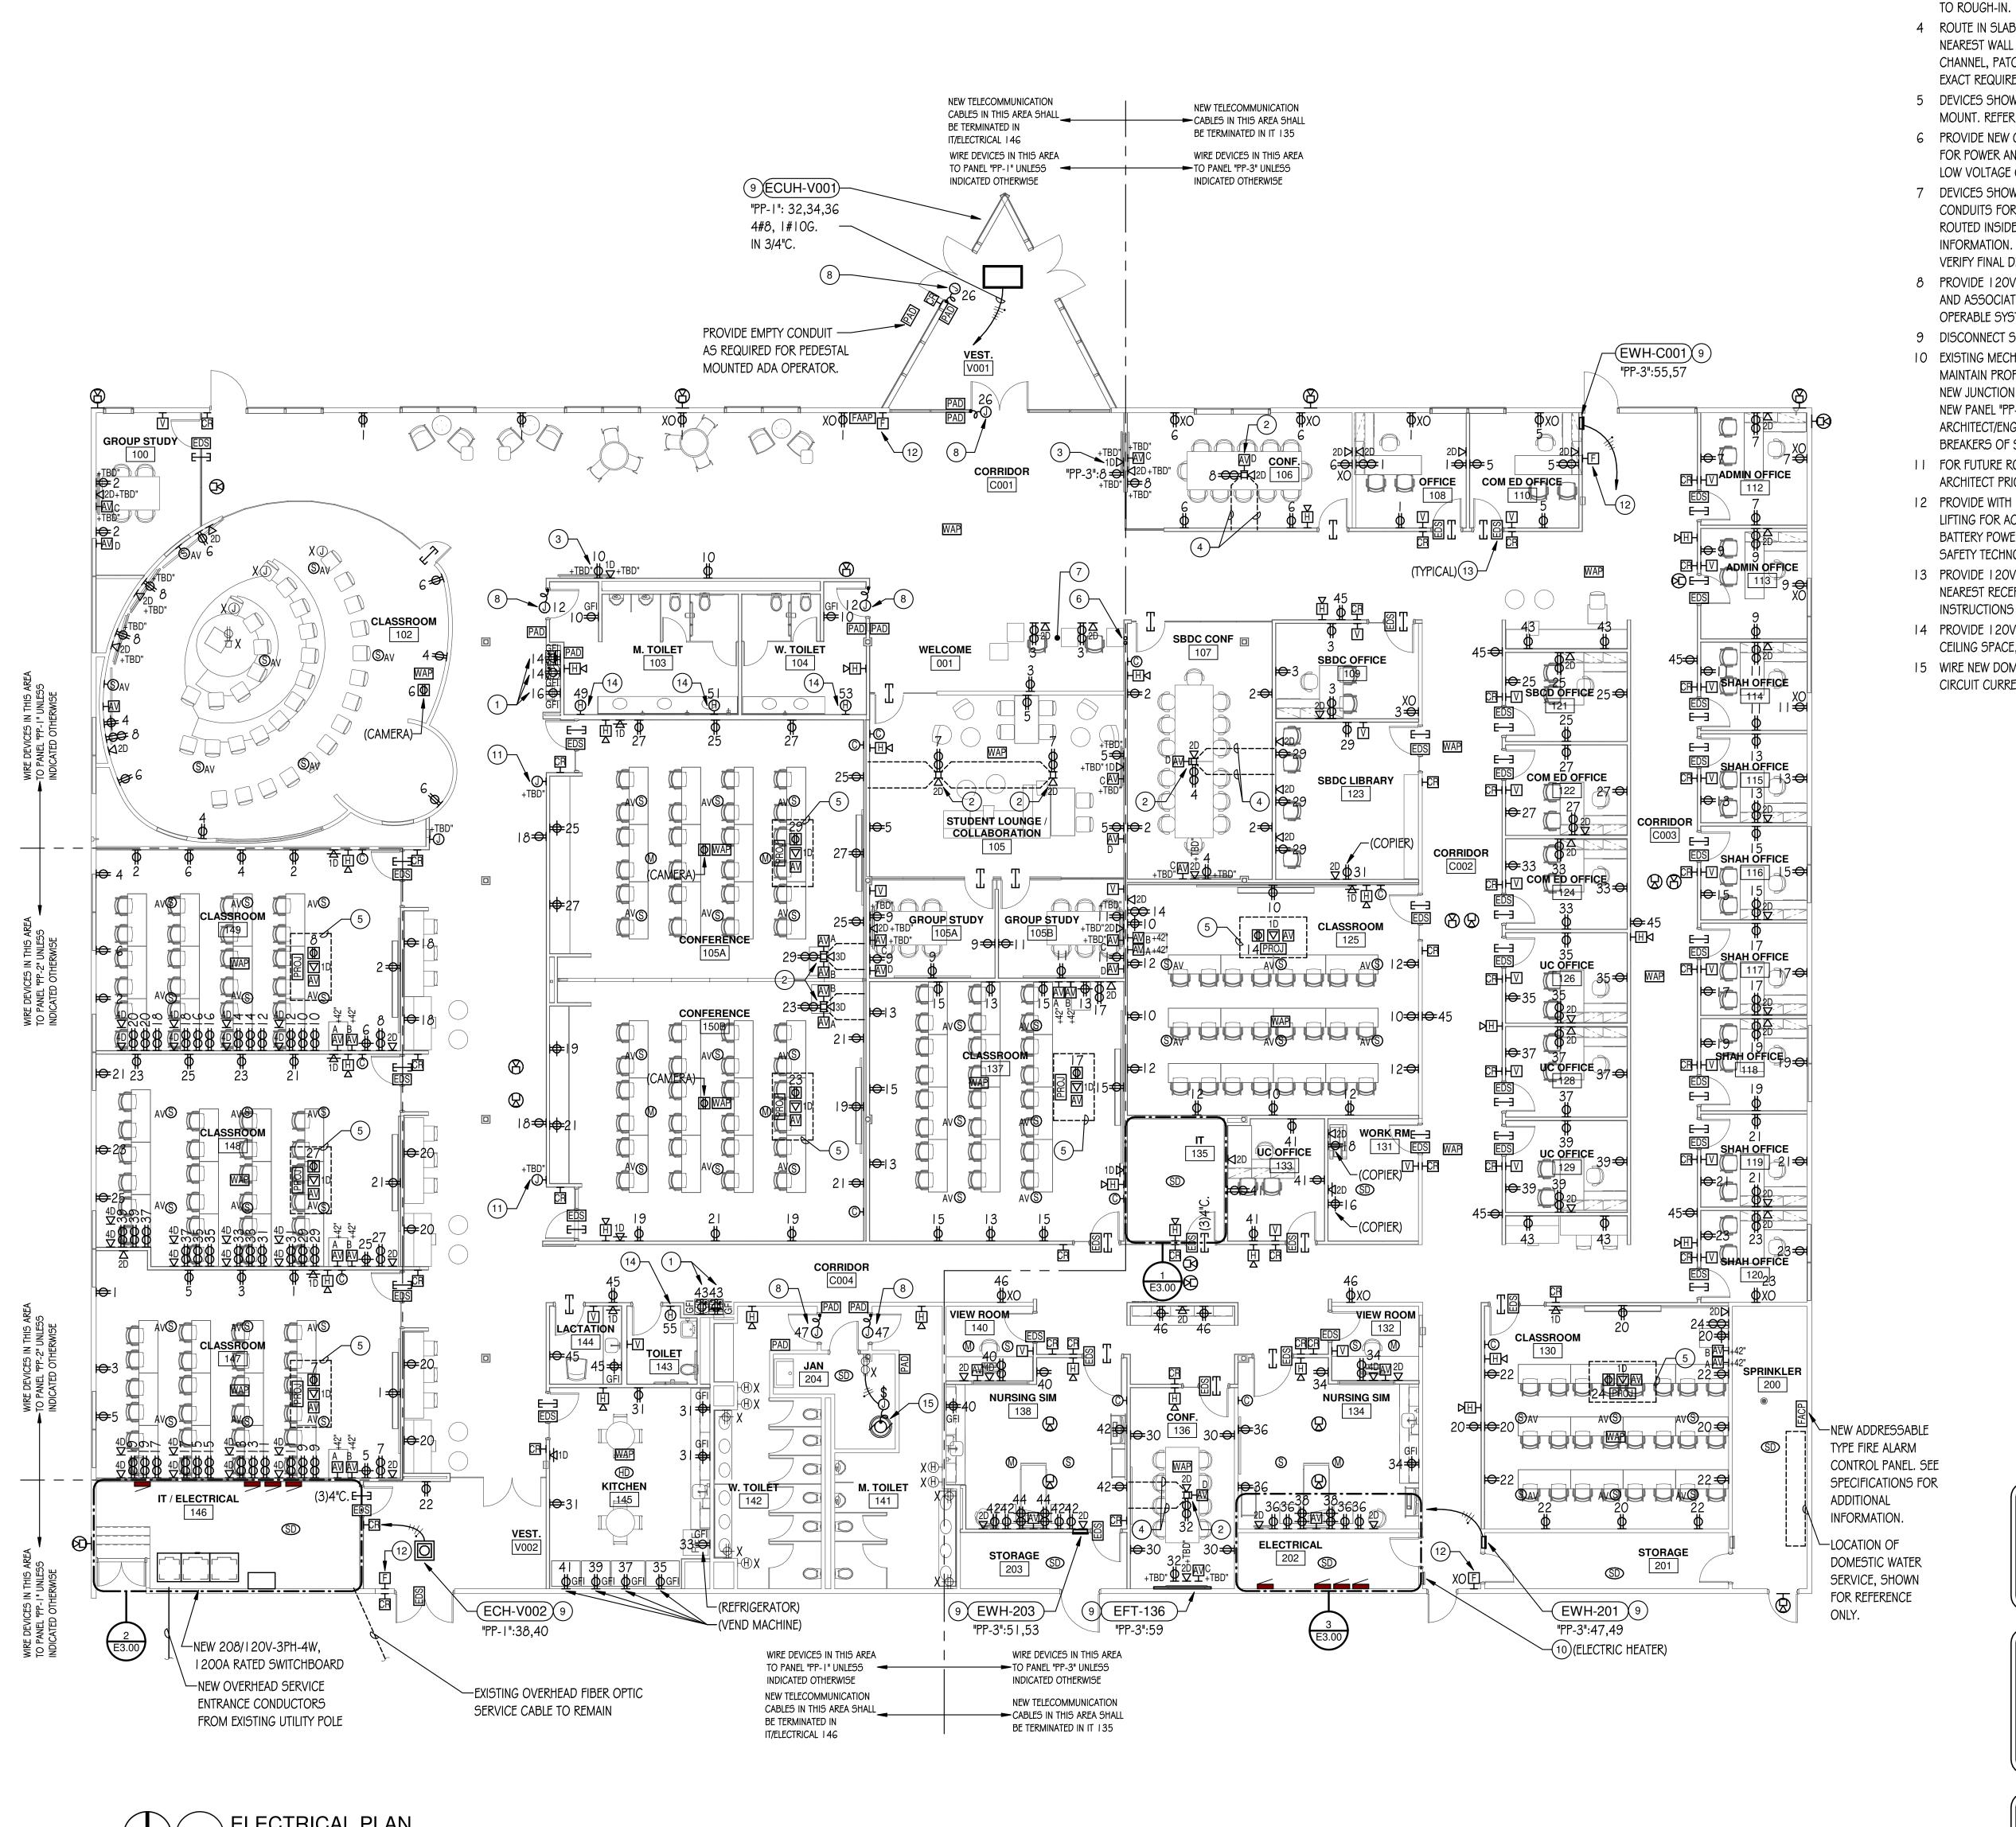
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ELECTRICAL DEMOLITION PLAN

SHEET NUMBER:

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DRAWING NOTES

- I INSTALL RECEPTACLE FOR ELECTRIC WATER COOLER (EWC) WITHIN EWC CABINET AS RECOMMENDED BY MANUFACTURER.
- 2 PROVIDE FOUR-COMPARTMENT, ON-GRADE, CAST IRON FLOOR BOX AS MANUFACTURED BY LEGRAND WIREMOLD RFB4-CI SERIES OR EQUAL, WITH FLANGED COVER ASSEMBLY #FPBTC. COVER FINISH SHALL BE SELECTED BY THE ARCHITECT. PROVIDE ALL INTERNAL BRACKETS AS REQUIRED TO ACCOMMODATE BOTH POWER AND LOW VOLTAGE. ROUTE (1) 3/4" CONDUIT FOR POWER AND (2) 1 1/4" CONDUIT FOR LOW VOLTAGE. VERIFY FINAL LOCATION WITH ARCHITECT PRIOR TO INSTALLATION.
- 3 FOR DISPLAY MONITOR. FIELD VERIFY EXACT HEIGHT AND LOCATION WITH ARCHITECT PRIOR
- 4 ROUTE IN SLAB 3/4" CONDUIT FOR POWER AND (2) 1 1/4" CONDUITS FOR LOW VOLTAGE TO NEAREST WALL FOR TRANSITION UP ACCESSIBLE CEILING SPACE. CONTRACTOR SHALL CHANNEL, PATCH AND REPAIR FLOOR TO MATCH SURROUNDING SURFACE. FIELD VERIFY EXACT REQUIREMENTS.
- 5 DEVICES SHOWN SHALL BE LOCATED INSIDE CEILING MOUNTED ENCLOSURE / PROJECTOR MOUNT. REFER TO ELECTRICAL DETAILS SHEET FOR ADDITIONAL INFORMATION.
- 6 PROVIDE NEW CONDUITS FOR FEED TO DEVICES IN MILLWORK. INSTALL (1) 3/4" CONDUIT FOR POWER AND (2) I" EMPTY CONDUITS STUBBED TO ACCESSIBLE CEILING SPACE FOR LOW VOLTAGE CABLES. FIELD VERIFY EXACT REQUIREMENTS.
- 7 DEVICES SHOWN SHALL BE RECESSED IN MILLWORK KNEEWALL. PROVIDE MINIMUM 3/4" CONDUITS FOR POWER, MINIMUM I" CONDUITS FOR LOW VOLTAGE. CONDUITS SHALL BE ROUTED INSIDE UTILITY CHASE. REFER TO ARCHITECTURAL SHEETS FOR ADDITIONAL INFORMATION. COORDINATE INSTALLATION WITH MILLWORK CONTRACTOR AND FIELD VERIFY FINAL DEVICE LOCATION PRIOR TO ROUGH-IN.
- 8 PROVIDE I 20VAC. CONNECTION AND JUNCTION BOXES FOR DOOR ACTUATOR, PUSH PADS AND ASSOCIATED WIRING PER MANUFACTURER'S INSTRUCTIONS FOR A COMPLETE AND OPERABLE SYSTEM. FIELD VERIFY FINAL LOCATION PRIOR TO ROUGH-IN.
- 9 DISCONNECT SWITCH FURNISHED WITH EQUIPMENT, WIRED BY ELECTRICAL CONTRACTOR.
- IO EXISTING MECHANICAL EQUIPMENT TO REMAIN. PROTECT EXISTING ELECTRICAL FEED TO MAINTAIN PROPER OPERATION OF EQUIPMENT. AT THE SOURCE OF THE FEEDER, PROVIDE NEW JUNCTION BOX AND SPLICE CONDUCTORS OF MATCHING GAUGE FOR EXTENSION TO NEW PANEL "PP-3". CONDUCTORS SHALL BE MINIMUM SIZE OF # I OAWG. INFORM ARCHITECT/ENGINEER IF OTHERWISE. TERMINATE BRANCH CIRCUITS TO NEW CIRCUIT BREAKERS OF SAME SIZE AS PREVIOUSLY INSTALLED. FIELD VERIFY EXACT REQUIREMENTS.
- I I FOR FUTURE ROOM SCHEDULER DEVICE. FIELD VERIFY EXACT HEIGHT AND LOCATION WITH ARCHITECT PRIOR TO ROUGH-IN.
- PROVIDE WITH PROTECTIVE CLEAR PLASTIC ENCLOSURE, HINGED AT THE TOP TO PERMIT LIFTING FOR ACCESS TO INITIATE ALARM. LIFTING THE COVER ACTUATES AN INTEGRAL BATTERY POWERED AUDIBLE HORN INTENDED TO DISCOURAGE FALSE-ALARM OPERATION. SAFETY TECHNOLOGY INTERNATIONAL, INC. #STI-1100 OR EQUAL.
- 13 PROVIDE I 20VAC CONNECTION TO LOW VOLTAGE TRANSFORMER FOR ELECTRIC STRIKE TO NEAREST RECEPTACLE BRANCH CIRCUIT. INSTALL AND WIRE PER DOOR MANUFACTURER'S INSTRUCTIONS FOR A COMPLETE AND OPERABLE SYSTEM.
- 14 PROVIDE 120VAC. 20AMP. TOGGLE DISCONNECT SWITCH LOCATED IN THE ACCESSIBLE CEILING SPACE, WITHIN SIGHT OF THE HAND DRYER PER NEC ARTICLE 422.31(C).
- I 5 WIRE NEW DOMESTIC WATER CIRCULATION PUMP TO EXISTING RECEPTACLE BRANCH CIRCUIT CURRENTLY SERVING THIS AREA. FIELD VERIFY EXACT REQUIREMENTS.

HENRY COUNTY FERSITY CENTER AT

ARCHITECT OF RECORD

CHICAGO, IL 60661

MEP-FP-T-ENGINEERS

1216 TOWER ROAD

CIVIL ENGINEERS

HRG GREEN

SCHAUMBURG,IL 60173

203 MCHENRY ,IL 60050

P: 312.496.0000

DEMONICA KEMPER ARCHITECTS 125 N. HALSTED STREET, SUITE 301

20/10 ENGINEERING GROUP, LLC

P: 847.882.2010 F: 847.882.2201

1391 CORPORATE DRIVE, SUITE

P:815.385.1778 F:815.385.1781

KEY PLAN:

SHEET STATUS: 9.19.23

ISSUED FOR BIDS

NO: DESCRIPTION: DATE

SHEET TITLE:

ELECTRICAL PLAN

SHEET NUMBER:

F1 10

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GENERAL FLOOR BOX NOTE:


THE ARCHITECT AND LOCATE/MARK ANY EXISTING UTILITIES IN AREA BY EMPLOYING SERVICE TO SCAN THE FLOOR SLAB. IT SHALL BE THE CONTRACTOR'S RESPONSIBILITY TO REPAIR ANY DAMAGES TO EXISTING UTILITIES DUE TO SAWCUTTING.

GENERAL NOTE:

UNLESS INDICATED OTHERWISE, CONTRACTOR SHALL CHANNEL EXISTING DRYWALL AS REQUIRED TO CONCEAL CONDUITS AND RECESS MOUNTED JUNCTION BOXES FOR ELECTRICAL DEVICES. COORDINATE WALL PATCHING REQUIREMENTS WITH GENERAL TRADES CONTRACTOR. WHERE RECESS MOUNTING IS NOT FEASIBLE, INFORM ARCHITECT AND/OR GENERAL CONTRACTOR PRIOR TO INSTALLATION.

THERMOSTAT NOTE:

REFER TO MECHANICAL PLANS FOR EXACT LOCATIONS OF THERMOSTAT/CARBON DIOXIDE DETECTORS. PROVIDE SINGLE GANG BACKBOX AND EMPTY 3/4" CONDUIT WITH PULL STRING STUBBED INTO AN ACCESSIBLE CEILING SPACE FOR INSTALLATION OF THERMOSTAT/CARBON DIOXIDE DETECTORS.

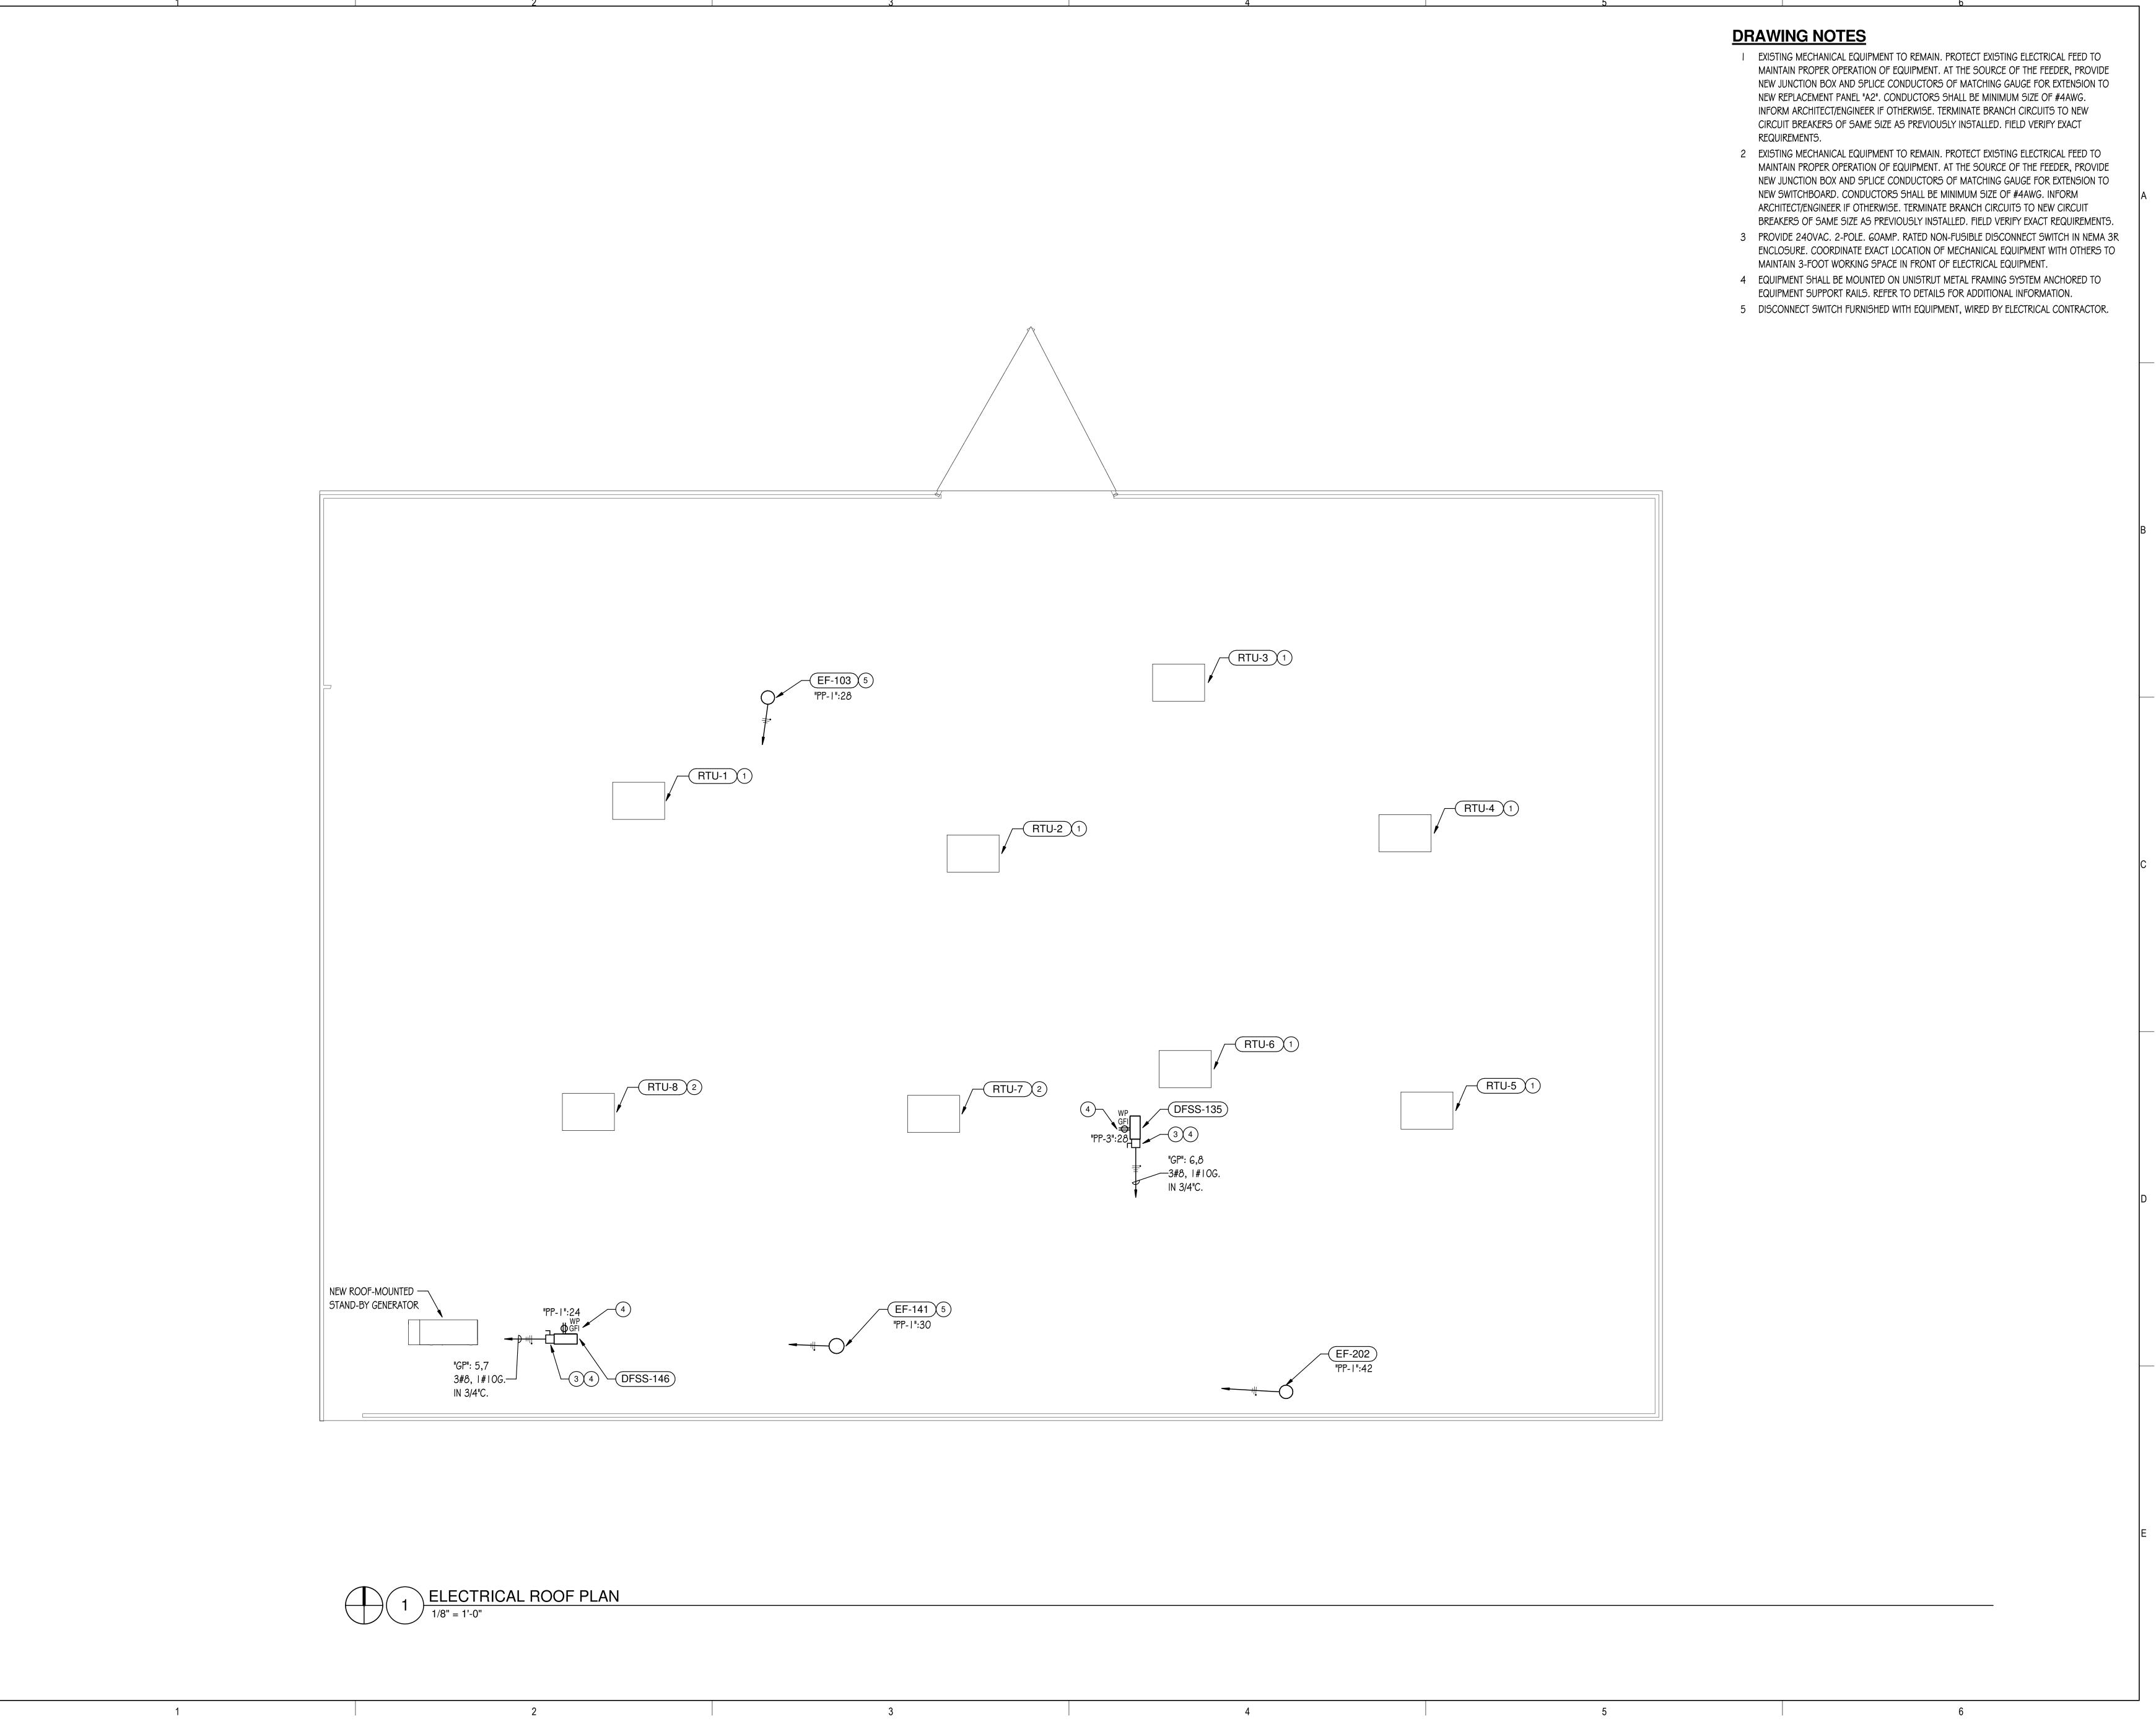



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ARY COUNTY COLLISITY CENTER AT MCC

KEY PLAN:

SHEET STATUS: 9.19.3

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SHEET TITLE:

ELECTRICAL ROOF PLAN

SHEET NUMBER:

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DRAWING NOTES I PROVIDE NETWORK INTERFACE

- I PROVIDE NETWORK INTERFACE MODULE TO COMMUNICATE WITH NETWORKED LIGHTING
- ZONES. INCLUDE ALL NETWORK REQUIREMENTS FOR A COMPLETE AND OPERABLE SYSTEM.

 2 PROVIDE RELAY PANEL WITH (8) RELAYS TO CONTROL EXISTING EXTERIOR LIGHTING
- CIRCUITS. RELAY PANEL WITH (8) RELAYS TO CONTROL EXISTING EXTERIOR LIGHTING
 CIRCUITS. RELAY PANEL SHALL BE ACUITY NLIGHT

 #ARP-INTENC | 6-NLT-8FCR-MVOLT-HLK-SM-DTC OR APPROVED EQUAL WITH #ARPA-APS-OL
 PHOTOSENSOR. LOCATE PHOTOSENSOR ON ROOF FACING NORTH. COORDINATE FINAL

LIGHTING CONTROL NOTE:

AND OPERABLE SYSTEM.

<u>SEQUENCE OF OPERATION</u>

• NORMAL LUMINAIRES:

• NIGHT LIGHT LUMINAIRES:

NEW LUMINAIRES DESIGNATED WITH LIGHTING ZONES 'LC(X)' SHALL

GATEWAYS, POWER SUPPLIES, ETC.) ARE SHOWN ON DRAWINGS.

CONTRACTOR TO PROVIDE ALL DEVICES REQUIRED FOR A COMPLETE

BE CONNECTED TO A FULLY NETWORKED LIGHTING CONTROL SYSTEM. NOT ALL NETWORKED CONTROL DEVICES (BRIDGES,

0% WHEN OCCUPANCY SENSOR DETECTS NO MOTION; 100% WHEN OCCUPANCY SENSOR DETECTS MOTION.

50% WHEN OCCUPANCY SENSOR DETECTS NO MOTION; 100% WHEN OCCUPANCY SENSOR DETECTS MOTION.

PHOTOSENSOR LOCATION WITH ARCHITECT.



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KEY PLAN:


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LIGHTING PLAN

SHEET NUMBER:



DRAWING NOTES

- I INDOOR UNIT POWER IS SUPPLIED FROM OUTDOOR UNIT. PROVIDE 3#12 \$ 1#12G. IN 3/4"C. TO OUTDOOR UNIT INCLUDING ADDITIONAL WIRES IF REQUIRED PER MANUFACTURER'S INSTRUCTIONS. FOLLOW REFRIGERANT PIPING FOR ROUTING OF CONDUIT, NO EXCEPTIONS WILL BE ALLOWED. PROVIDE 240VAC. 20AMP. MOTOR RATED TOGGLE DISCONNECT SWITCH ADJACENT TO INDOOR UNIT WITH MACHINE MADE LABEL (P-TOUCH TYPE) INDICATING EQUIPMENT SERVED.
- 2 PROVIDE 240VAC. 3-POLE. 30AMP. RATED NON-FUSIBLE DISCONNECT SWITCH IN NEMA I ENCLOSURE. COORDINATE EXACT LOCATION OF MECHANICAL EQUIPMENT WITH OTHERS TO MAINTAIN 3-FOOT WORKING SPACE IN FRONT OF ELECTRICAL EQUIPMENT.

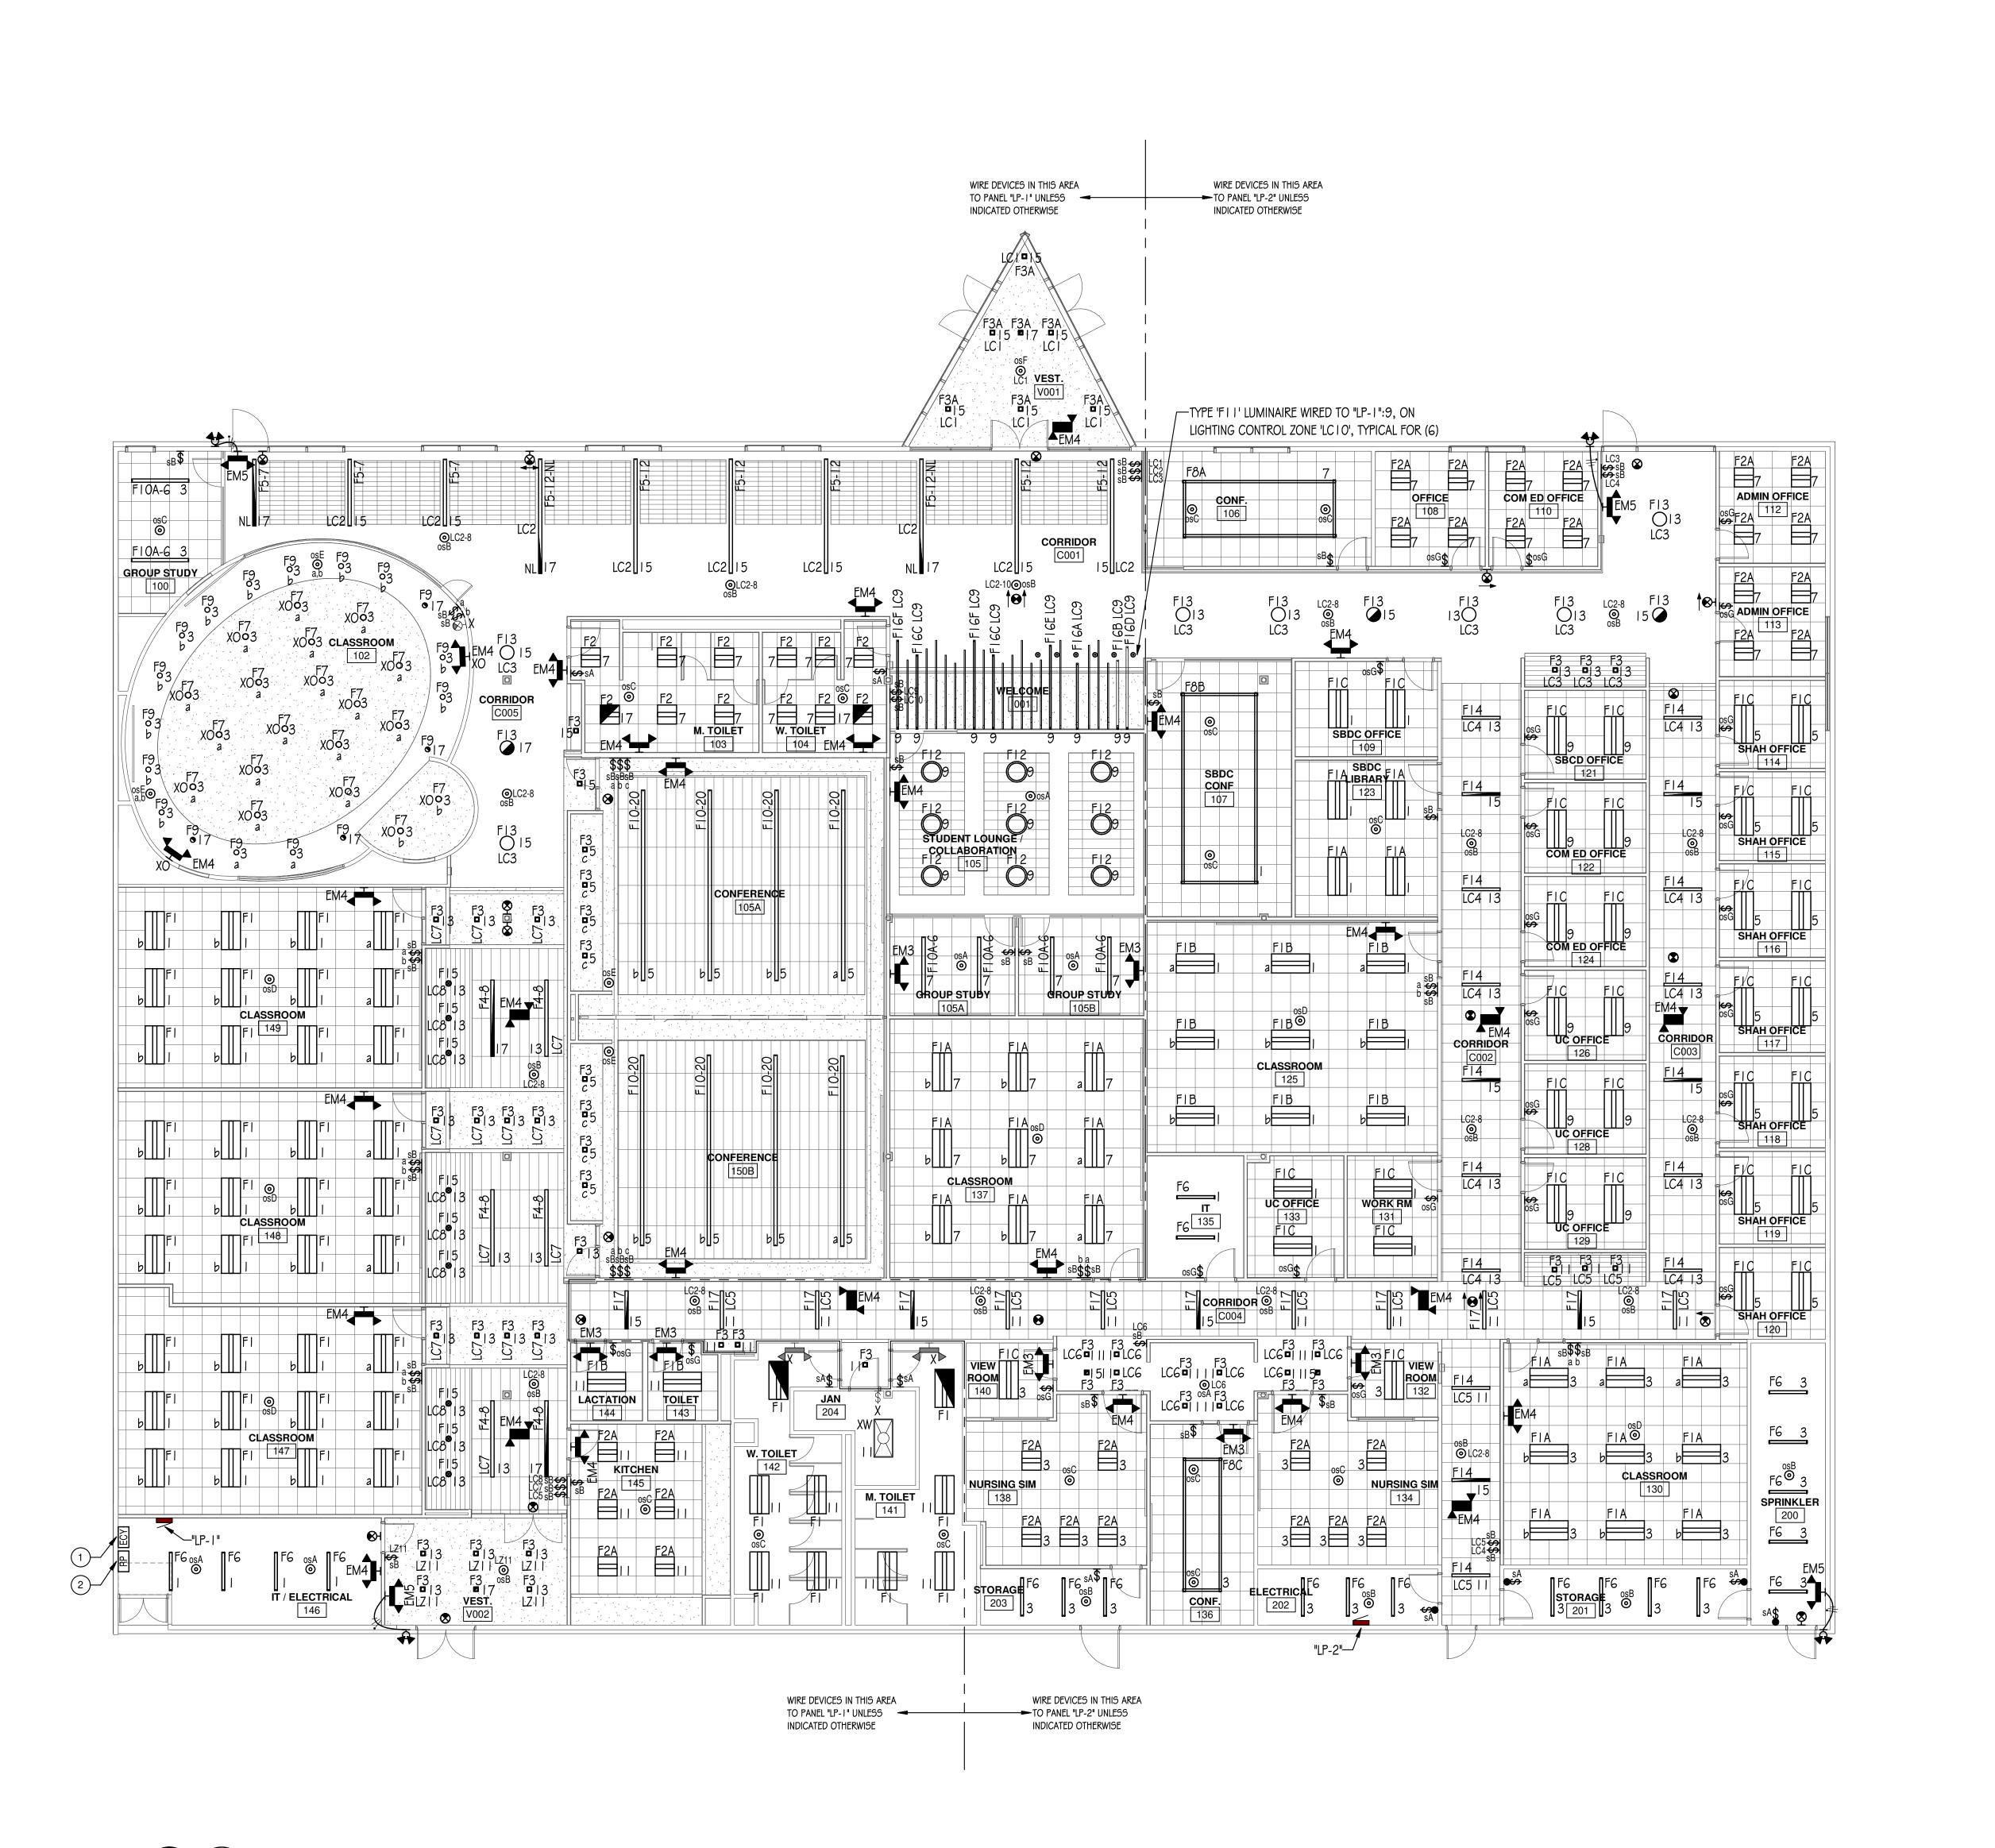

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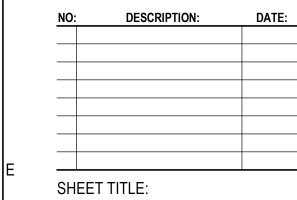
203 MCHENRY ,IL 60050

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KEY PLAN:

SHEET STATUS: 9.19.23
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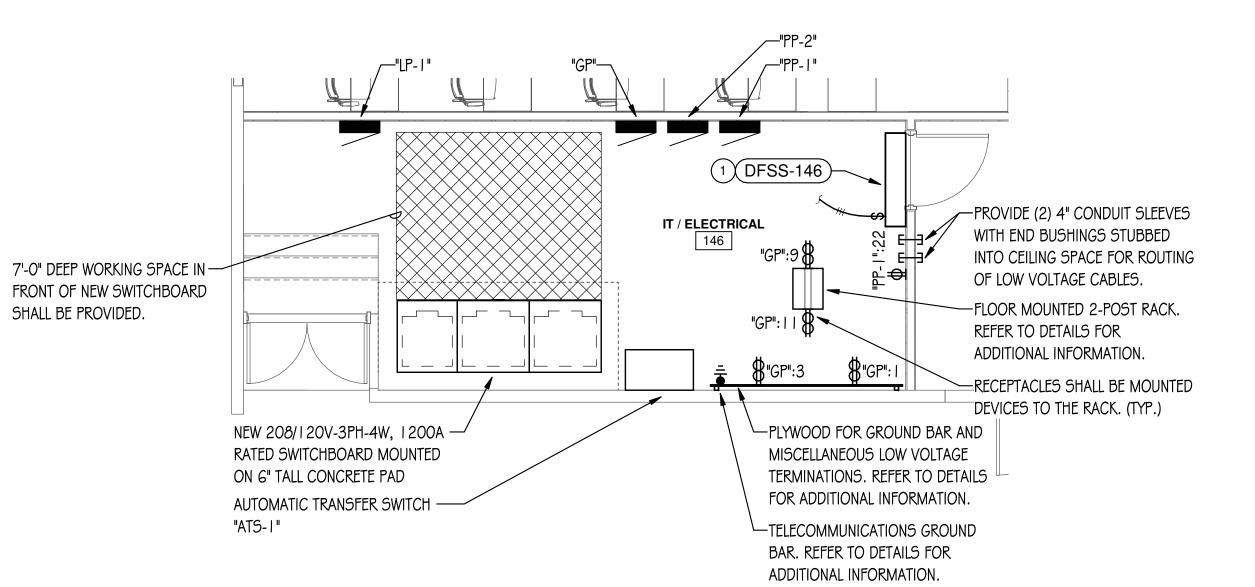
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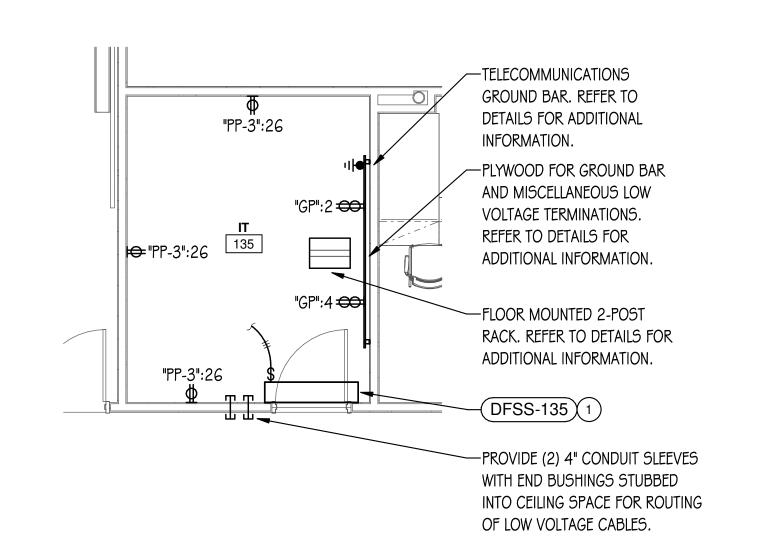
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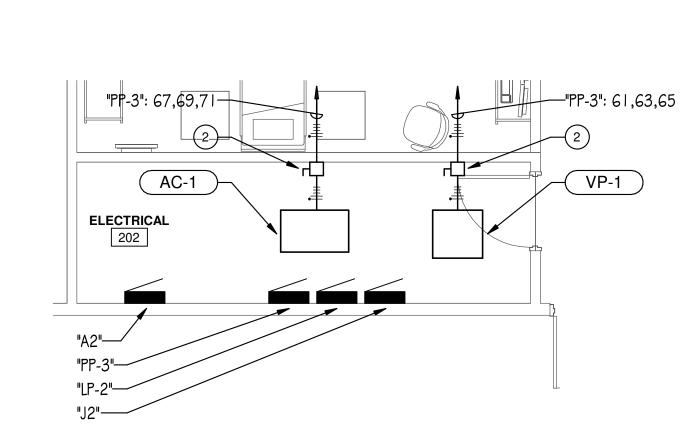
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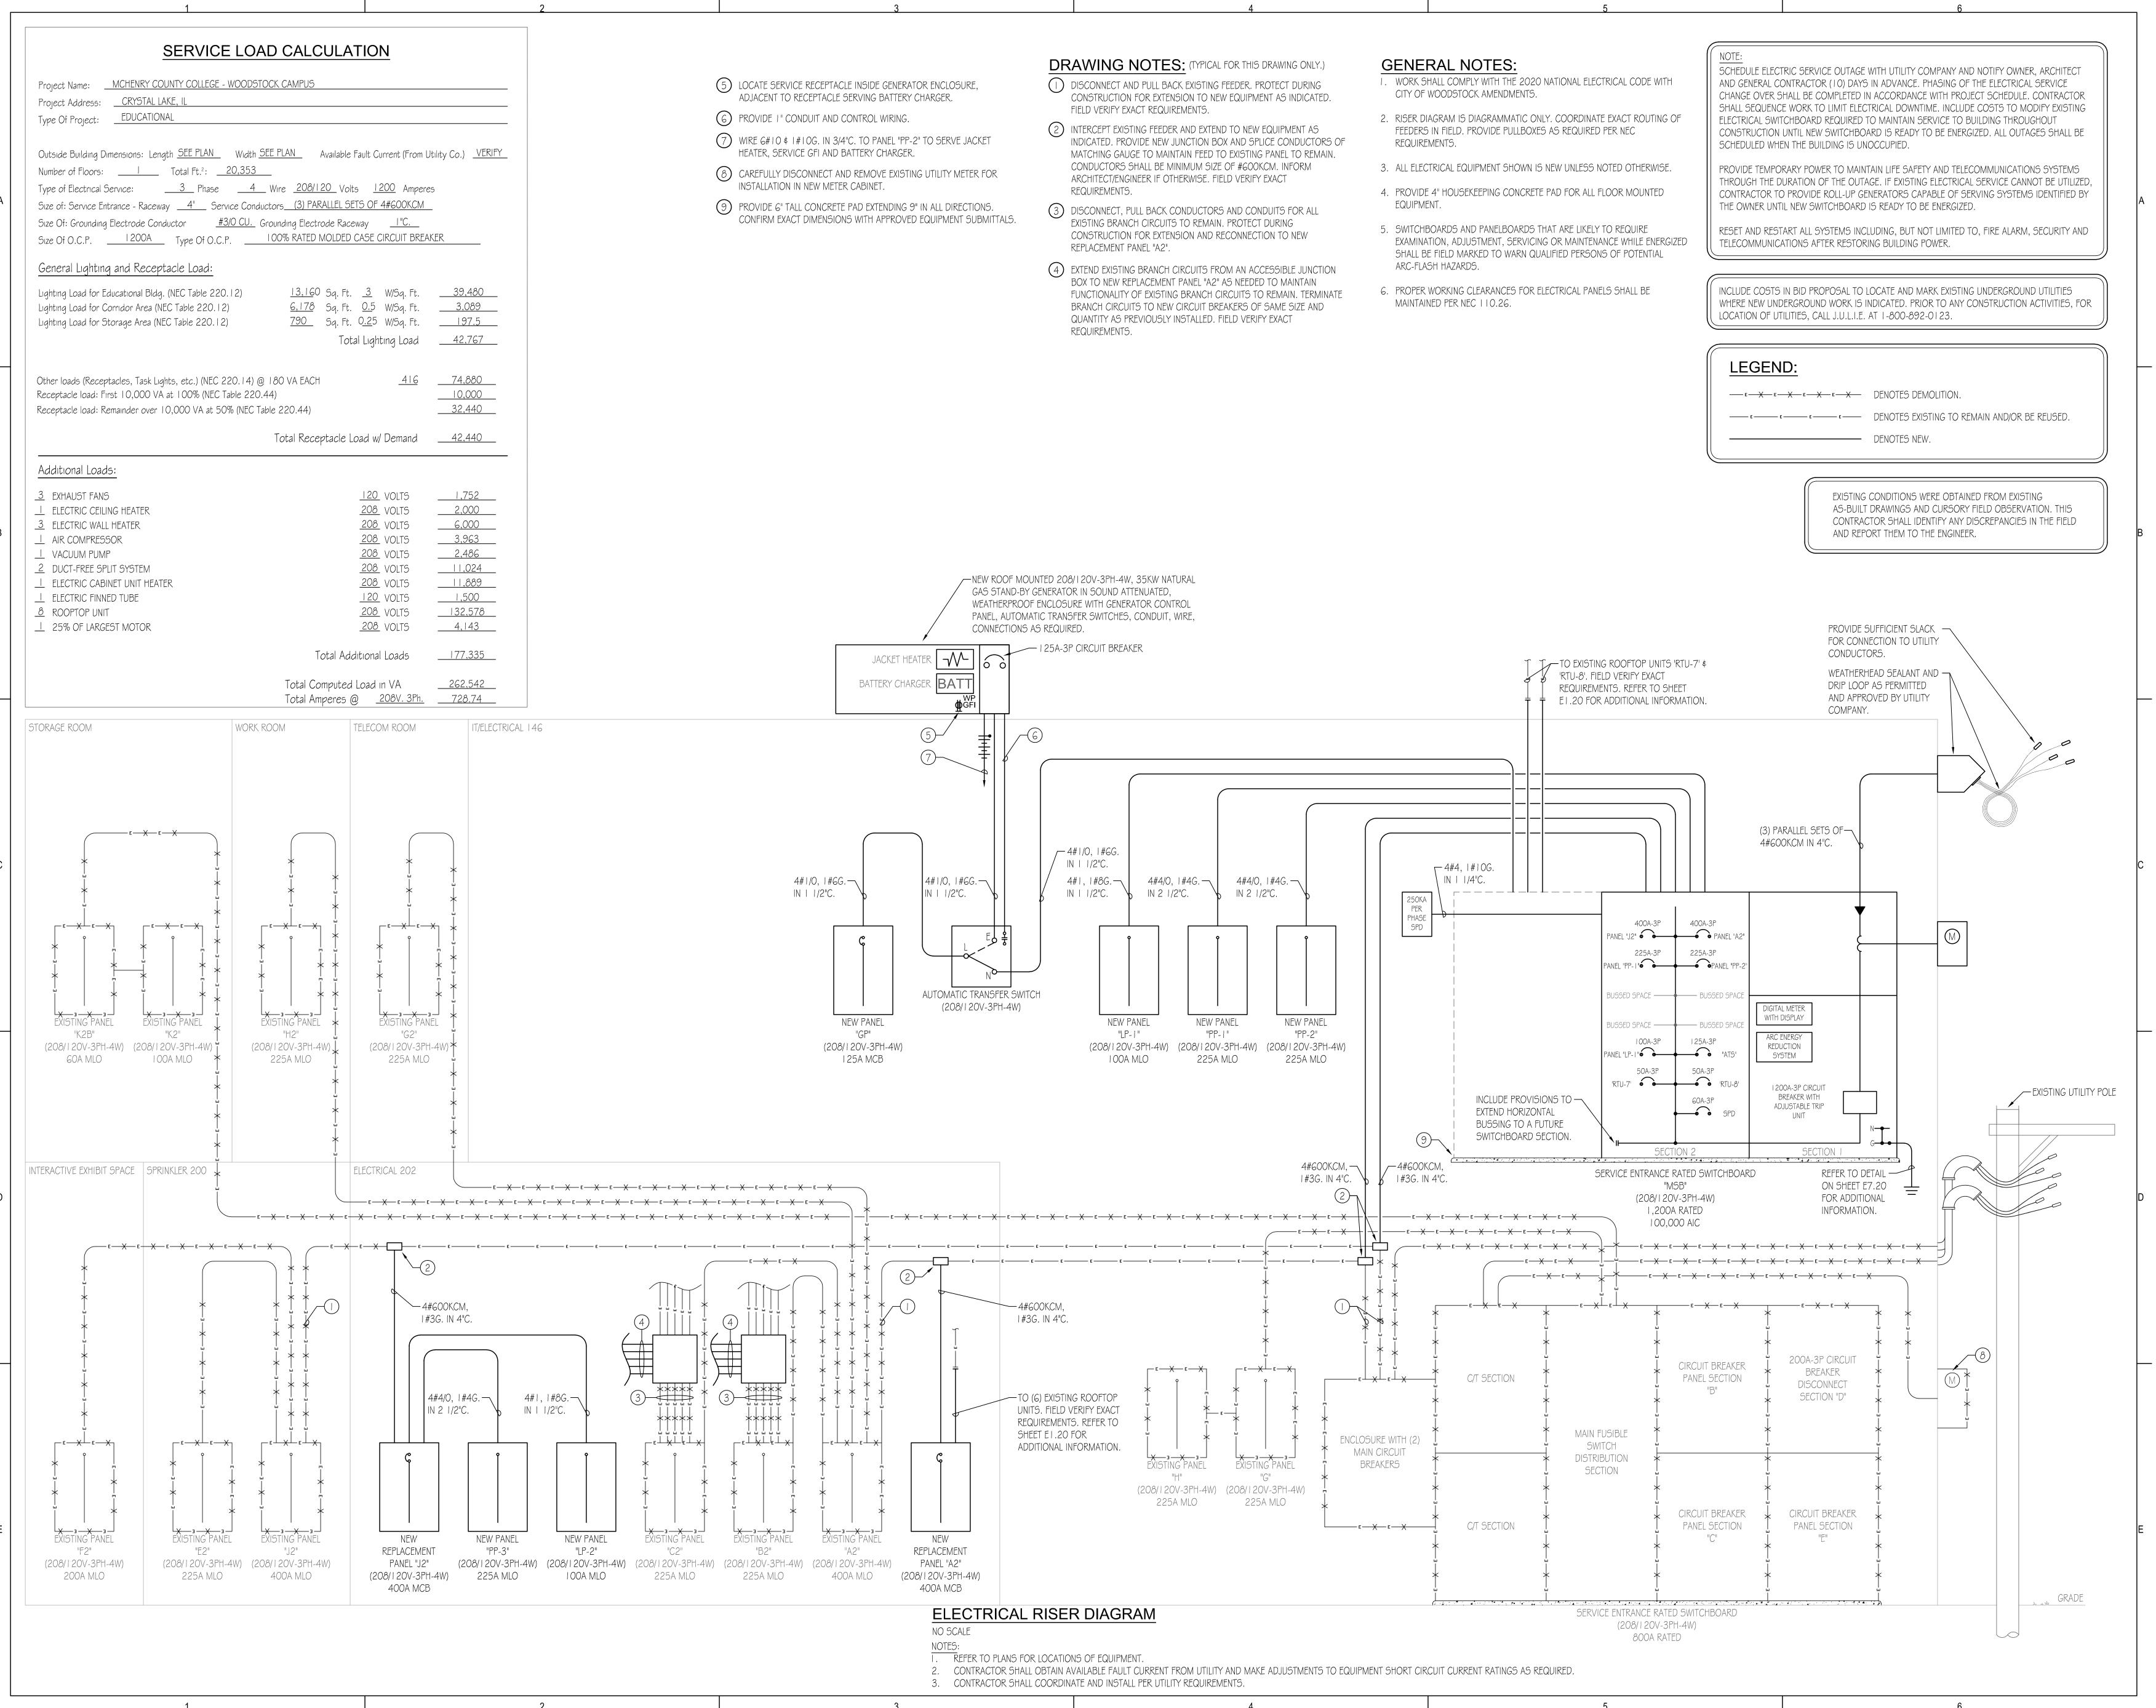








3 ENLARGED ELECTRICAL PLAN - STORAGE 202





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SHEET STATUS: 9.

ISSUED FOR BIDS

KEY PLAN:

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DIAGRAM

SHEET NUMBER:

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	DEMOLITION SYMBOLS
SYMBOL	DESCRIPTION
Χ	EXISTING ELECTRICAL EQUIPMENT OR OUTLET TO REMAIN.
R	EXISTING ELECTRICAL EQUIPMENT OR OUTLET TO BE REMOVED.
XRR	EXISTING ELECTRICAL EQUIPMENT OR OUTLET TO BE REMOVED, RELOCATED AND JUNCTION BOX REMOVED OR CAPPED AS REQUIRED. STORE AND PROTECT EXISTING DEVICE FOR RE-USE AND RE-INSTALLATION.
XR	EXISTING ELECTRICAL EQUIPMENT OR OUTLET RELOCATED (NEW LOCATION). EXTEND EXISTING FEED AS REQUIRED TO MAINTAIN DEVICE/EQUIPMENT OPERATION. PROVIDE NEW FEED OF MATCHING SPECIFICATIONS IN SITUATIONS WHERE THEY CANNOT BE SPLICED OR ARE NOT OF SUFFICIENT LENGTH TO REACH NEW LOCATION.
ХС	EXISTING ELECTRICAL EQUIPMENT OR OUTLET TO BE REMOVED AND JUNCTION BOX CAPPED OR REUSED AS REQUIRED.
ХО	NEW ELECTRICAL EQUIPMENT INSTALLED OVER EXISTING OUTLET.
XA	EXISTING ELECTRICAL EQUIPMENT OR OUTLET TO BE ABANDONED.
XM	EXISTING ELECTRICAL EQUIPMENT OR OUTLET TO BE MODIFIED.
XW	EXISTING ELECTRICAL EQUIPMENT TO BE REWIRED.
XRT	EXISTING ELECTRICAL EQUIPMENT OR OUTLET TO BE TEMPORARILY REMOVED AND REINSTALLED IN SAME LOCATION.

NOTE: NOT ALL SYMBOLS ARE USED ON THIS PROJECT.

GENERAL NOTE:

CONTRACTOR SHALL MAINTAIN FIRE RATING OF ALL PARTITIONS FOR NEW PENETRATIONS. ANY PENETRATIONS THROUGH WALLS AND FLOORS SHALL BE PROPERLY SEALED AND TREATED TO MAINTAIN THE FIRE STOPPING RATING OF THE WALL. CABLING SHALL NOT PENETRATE WALLS UNLESS ROUTED THROUGH RACEWAY SYSTEM OR ROUTED ABOVE ACCESSIBLE CEILINGS THROUGH METALLIC CONDUIT SLEEVES, EXTENDING A MINIMUM OF 6" EACH SIDE OF THE WALL WITH PROTECTIVE END BUSHINGS TO PREVENT DAMAGE TO CABLES. VOIDS AROUND SLEEVES SHALL BE SEALED WITH APPROPRIATE MATERIALS AS TO MAINTAIN THE ACOUSTIC OR FIRE RATING OF WALLS ABOVE AND BELOW CEILINGS. CABLES RAN THROUGH VOIDS WITHOUT SLEEVES OR RACEWAYS WILL NOT BE ACCEPTABLE. CONTRACTOR SHALL VERIFY EXISTING FIRE PARTITIONS IN THE FIELD.

GENERAL NOTE:

INCIDENTAL WORK MAY ALSO BE NECESSARY DUE TO CHANGES AFFECTING, FIRE ALARM, ELECTRICAL, OR OTHER SYSTEMS, SUCH INCIDENTAL WORK IS ALSO PART OF THIS CONTRACT. INSPECT THOSE AREAS, ASCERTAIN WORK NEEDED, AND DO THAT WORK IN ACCORD WITH THE CONTRACT REQUIREMENTS, AT NO ADDITIONAL COST. THE REMOVAL \$ REINSTALLATION OF EXISTING WORK TO ACCOMMODATE CHANGES TO EXISTING, OR INSTALLATION OF, ELECTRICAL, OTHER SYSTEMS IS ALSO PART OF THIS CONTRACT.


GENERAL NOTE:

REFER TO ARCHITECTURAL FLOOR PLANS FOR ADDITIONAL INFORMATION REGARDING MOUNTING HEIGHTS AND LOCATIONS OF ELECTRICAL DEVICES BEFORE ROUGH-IN.

WHERE CONFLICTS BETWEEN ELECTRICAL & ARCHITECTURAL ELEVATIONS ARISE, CONTRACTOR TO VERIFY WITH ARCHITECT/ENGINEER TEAM PRIOR TO ROUGH-IN.

GENERAL NOTE:

EXISTING CONDITIONS WERE OBTAINED FROM EXISTING AS-BUILT DRAWINGS AND CURSORY FIELD OBSERVATION. THIS CONTRACTOR SHALL IDENTIFY ANY DISCREPANCIES IN THE FIELD AND REPORT THEM TO THE ENGINEER.

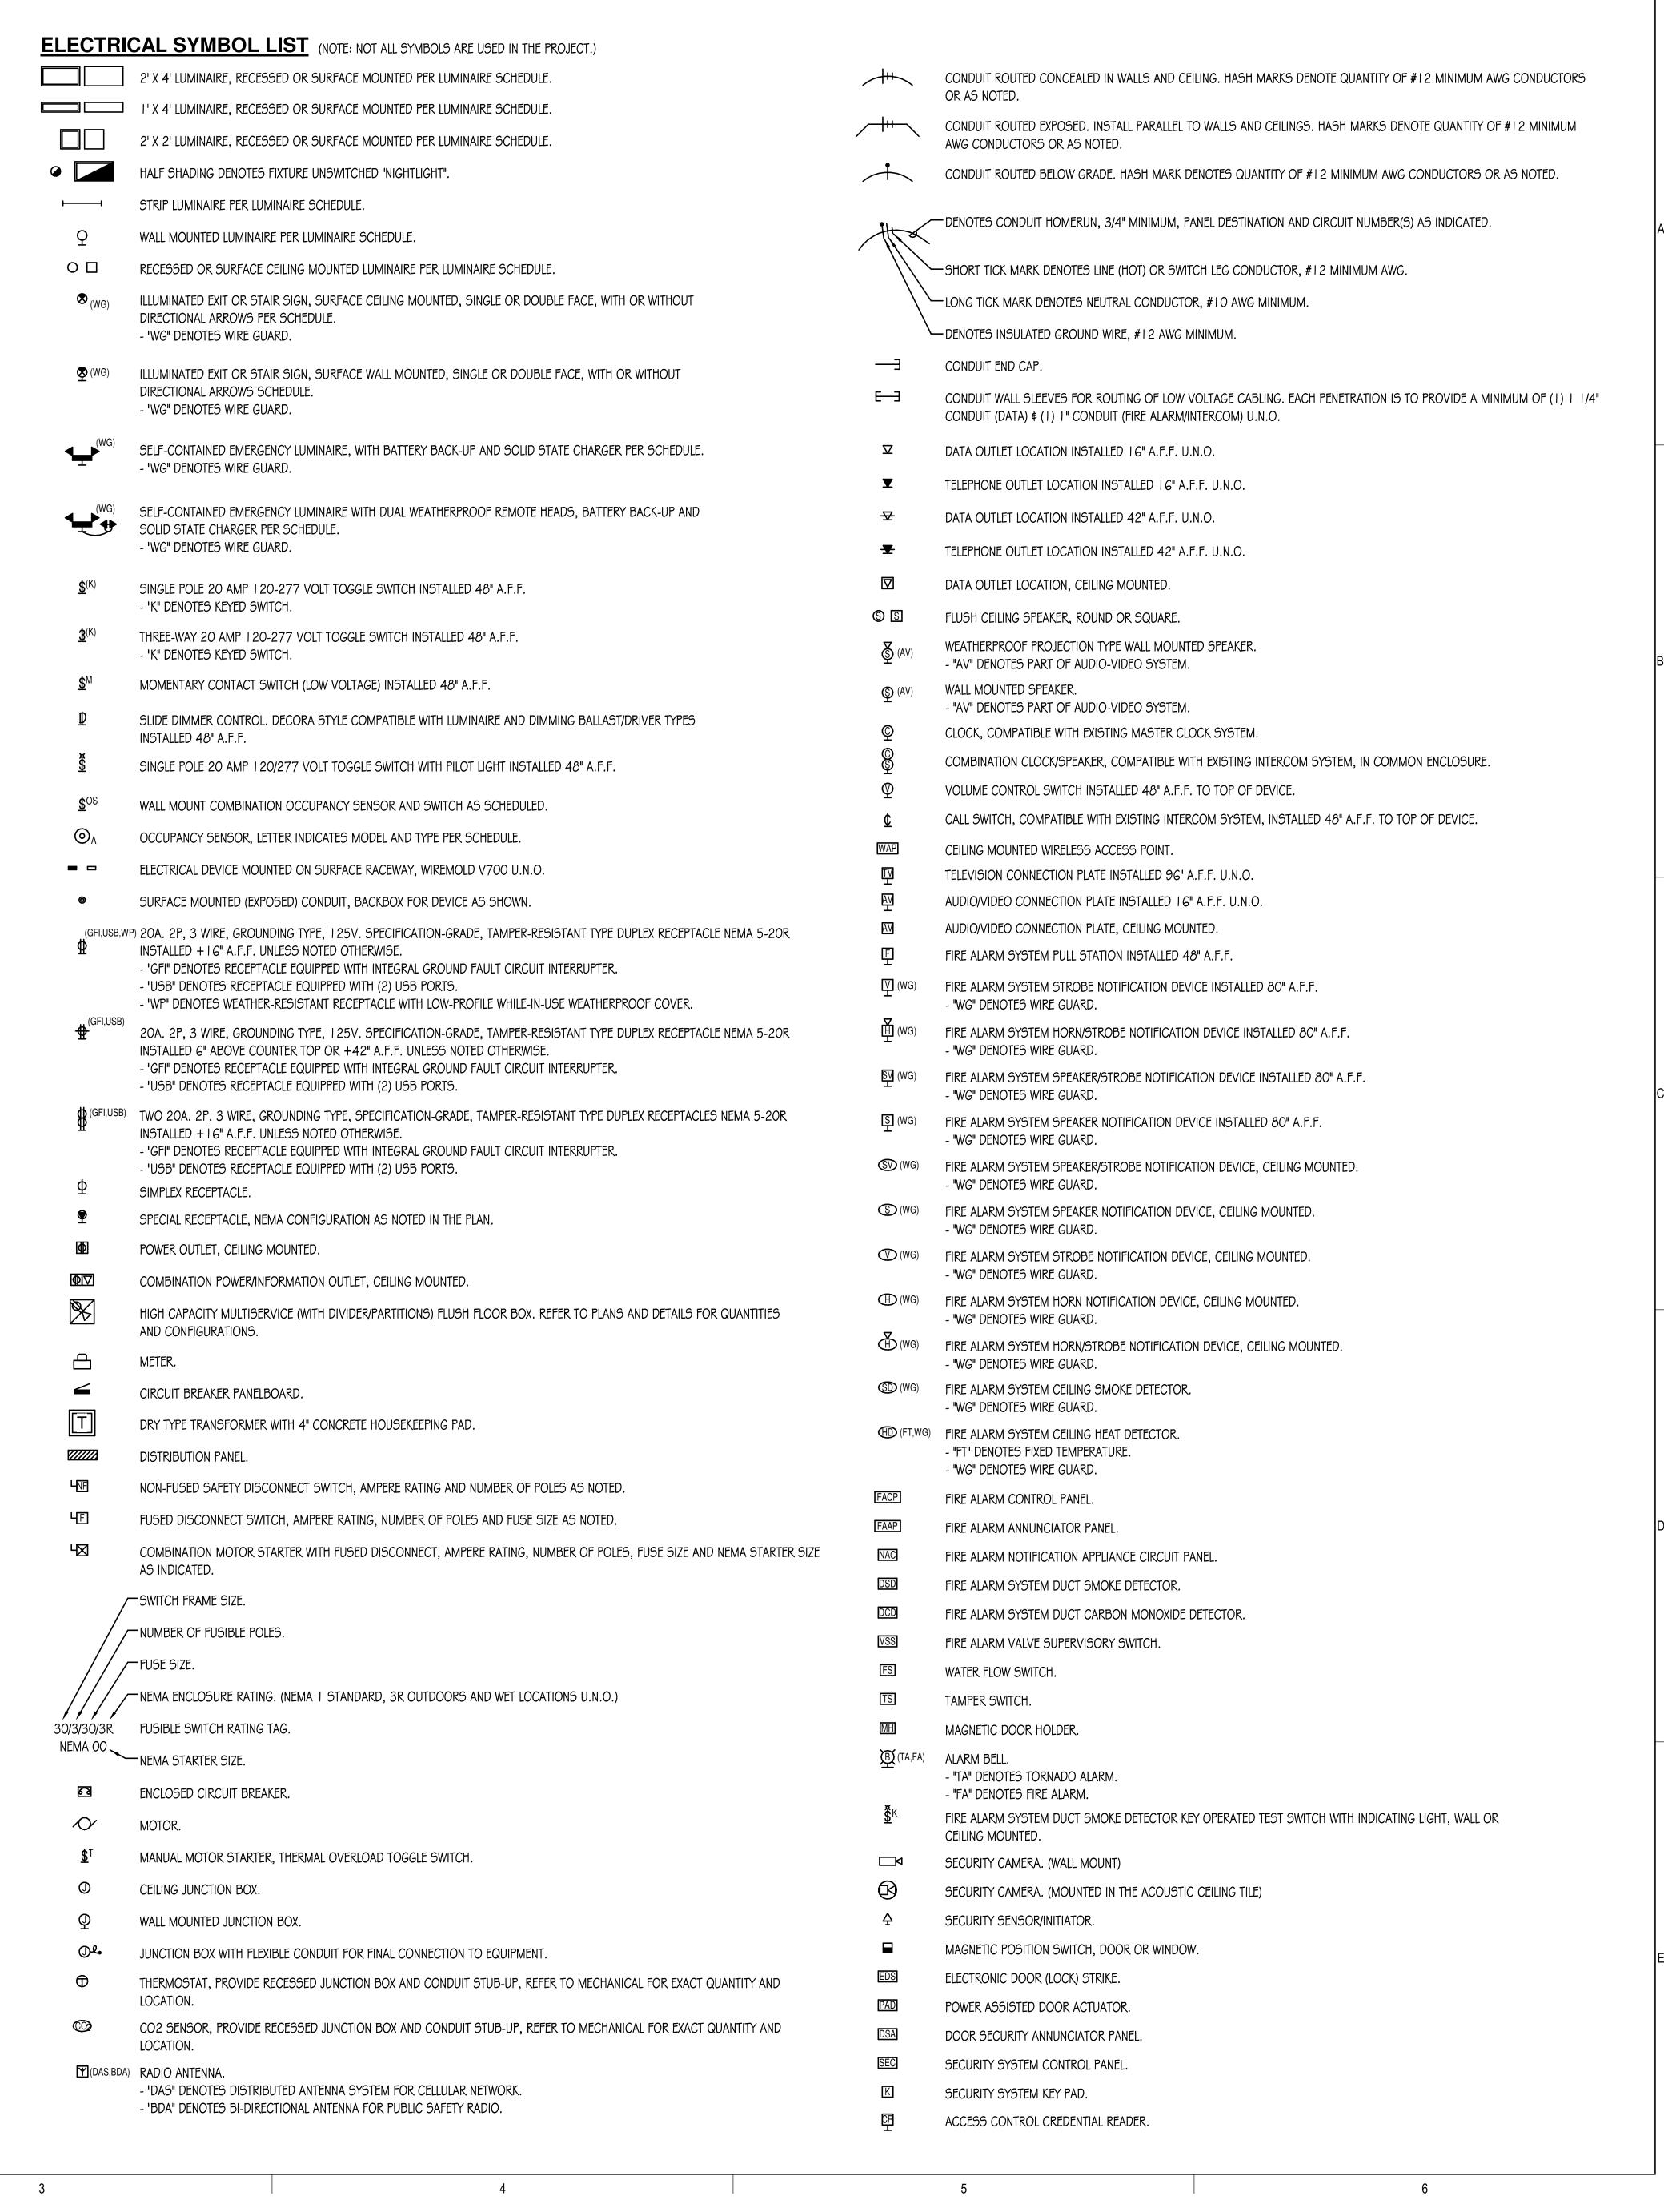



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SHEET STATUS: 9.19.23 **ISSUED FOR BIDS**

KEY PLAN:

NO: DESCRIPTION: DATE:

SHEET TITLE: **ELECTRICAL SYMBOL LIST AND**

ABBREVIATIONS

SHEET NUMBER:

GENERAL REMODELING NOTE: (APPLICABLE TO ALL SHEETS.)

- I. WORK SHOWN ON DRAWINGS SHALL BE CONSIDERED NEW AND IN CONTRACT UNLESS SPECIFICALLY INDICATED OTHERWISE.
- 2. DRAWINGS ARE GENERALLY DIAGRAMMATIC. ROUTING OF CONDUITS, RACEWAYS, ETC., AS SHOWN ON DRAWINGS, DOES NOT INTEND TO SHOW EVERY RISE, DROP, OFFSET, FITTING NOR EVERY STRUCTURAL ELEMENT THAT MAY BE ENCOUNTERED DURING THE INSTALLATION OF THIS WORK. EACH CONTRACTOR SHALL MAKE ANY REQUIRED CHANGES FROM THE GENERAL ROUTING SHOWN ON THESE DRAWINGS, SUCH AS OFFSETS, BENDS OR CHANGES IN ELEVATION DUE TO COORDINATION WITH THE WORK OF OTHER TRADES AND BUILDING CONSTRUCTION. ALL CHANGES SHALL BE MADE WITHOUT ADDITIONAL COST TO THE OWNER OR DELAY IN COMPLETION DATE OF THE PROJECT.
- 3. IT IS INTENDED THAT EQUIPMENT SHALL BE LOCATED SYMMETRICALLY WITH THE ARCHITECTURAL ELEMENTS OF THE BUILDING, NOTWITHSTANDING THE FACT THAT LOCATIONS INDICATED BY THESE DRAWINGS MAY BE DISTORTED FOR CLEARNESS OF PRESENTATION.
- 4. CONTRACTOR SHALL CHECK DRAWINGS OF OTHER TRADES TO VERIFY THAT SPACES IN WHICH THEIR WORK WILL BE INSTALLED ARE CLEAR OF OBSTRUCTIONS. WORK SHALL BE INSTALLED TO MAINTAIN MAXIMUM HEADROOM AND SPACE CONDITIONS AT ALL POINTS IN THE BUILDING. WHERE HEADROOM OR SPACE CONDITIONS APPEAR INADEQUATE, CONTRACTOR SHALL NOTIFY ARCHITECT/ENGINEER BEFORE PROCEEDING WITH THE INSTALLATION OF THEIR WORK.
- 5. CONTRACTOR SHALL FURNISH OTHER TRADES ADVANCE INFORMATION AND/OR SHOP DRAWINGS ON LOCATIONS AND SIZES OF PIPING, DUCTWORK, CONDUIT, RACEWAYS, EQUIPMENT, FRAMES, BOXES, SLEEVES AND OPENINGS, ETC. NEEDED FOR THEIR WORK TO PERMIT OTHER TRADES AFFECTED TO INSTALL THEIR WORK PROPERLY AND WITHOUT DELAY.
- 6. WHERE THERE IS EVIDENCE THAT WORK OF ONE TRADE WILL INTERFERE WITH WORK OF OTHER TRADES, ALL TRADES SHALL MEET ON JOB SITE TO WORK OUT SPACE CONDITIONS AND MAKE SATISFACTORY ADJUSTMENTS TO INSTALLATION OF THE NEW WORK. CONTRACTORS SHALL VERIFY EXACT LOCATIONS OF ALL DEVICES AND EQUIPMENT WITH FIELD CONDITIONS, SHOP DRAWINGS, AND WORK OF OTHER TRADES PRIOR TO ROUGH-IN. EACH CONTRACTOR SHALL BE RESPONSIBLE, AT THEIR OWN EXPENSE, FOR THE REMOVAL AND REINSTALLATION OF ANY PART OF THEIR WORK IF SAME WAS INSTALLED WITHOUT CONSULTING WITH OTHER TRADES BEFORE INSTALLING THEIR WORK.
- 7. CONTRACTOR SHALL PROVIDE SLEEVES IN BEAMS, FLOORS, COLUMNS AND WALLS AS SHOWN ON THE DRAWINGS, AS REQUIRED BY JOB SITE CONDITIONS, AND/OR AS SPECIFIED, WHEN INSTALLING THEIR WORK. ALL BEAMS AND COLUMNS WHICH ARE REQUIRED TO BE SLEEVED SHALL BE CUT AND REINFORCED AS REQUIRED BY FIELD CONDITIONS AND LOCATIONS AND SIZES SHALL BE CHECKED AND APPROVED BY ARCHITECT BEFORE CONTRACTOR CUTS ANY STRUCTURAL BUILDING MEMBER.
- 8. THE SEQUENCE FOR THE INSTALLATION OF ALL WORK SHALL BE COORDINATED BETWEEN ALL CONTRACTORS ON THE PROJECT AND IN STRICT ACCORDANCE WITH ARCHITECT/ENGINEER AND OWNERS STIPULATION AS DIRECTED.
- 9. CONTRACTOR SHALL REFER TO THE ARCHITECTURAL AND STRUCTURAL CONTRACT DRAWINGS (BEFORE SUBMITTING THEIR BIDS) TO FAMILIARIZE THEMSELVES WITH THE EXTENT OF THE GENERAL CONTRACTORS WORK, CEILING HEIGHTS AND CLEARANCE FOR INSTALLING THEIR WORK.
- OF NEW BUILDING CONSTRUCTION REQUIRED TO ACCOMMODATE THE INSTALLATION OR REMOVAL OF THEIR WORK. REMOVE, STORE AND REINSTALL CEILING TILES AS REQUIRED TO INSTALL WORK ABOVE EXISTING CEILINGS WHICH REMAIN, REPLACE TILES BROKEN OR DAMAGED DURING CONSTRUCTION. ALL PATCHING, REPAIRING AND REFINISHING WORK SHALL BE PERFORMED BY THOSE REGULARLY INVOLVED IN THAT TRADE AND SHALL MATCH THE ADJACENT CONSTRUCTION AS CLOSELY AS POSSIBLE. CARE SHALL BE TAKEN SO AS NOT TO DAMAGE ANY EXISTING BUILDING CONSTRUCTION OR ITEMS THAT ARE TO REMAIN. ANY EXISTING FINISHES THAT ARE DAMAGED DURING THE INSTALLATION OF NEW WORK OR REMOVAL OF EXISTING WORK SHALL BE REPAIRED, REPLACED AND PAID FOR BY THE INSTALLING CONTRACTOR, TO THE SATISFACTION OF THE ARCHITECT AND OWNER. REFER TO ARCHITECTURAL DRAWINGS FOR EXISTING BUILDING CONSTRUCTION THAT IS TO REMAIN AND, THEREFORE, SUBJECT TO PATCHING, REPAIRING, REFINISHING, AND REMOVAL/REPLACEMENT.
- II. CONTRACTOR SHALL BE RESPONSIBLE FOR THEIR OWN CLEAN-UP DURING CONSTRUCTION. IF CONTRACTOR FAILS TO PROVIDE SUCH CLEAN-UP, THE ARCHITECT/ENGINEER WILL DIRECT ANOTHER CONTRACTOR TO PERFORM THE CLEAN-UP AND THE NEGLIGENT CONTRACTOR SHALL PAY THE ASSOCIATED BACK-CHARGES AS DEEMED APPROPRIATE BY THE ARCHITECT/ENGINEER.
- 12. CONTRACTOR SHALL INSTALL ALL AUXILIARY SUPPORTING STEEL AS REQUIRED FOR THE SUPPORTING OF THEIR CONDUIT, EQUIPMENT, ETC. ALL SUPPORTING STEEL FOR ITEMS ABOVE A SUSPENDED CEILING SHALL BE FROM BUILDING STRUCTURAL MEMBERS ONLY.
- 13. IT IS MANDATORY THAT THE COMPLETE EXISTING BUILDING REMAIN IN CONTINUOUS AND NON-INTERRUPTED OPERATION DURING REMODELING/ALTERING OF SAID EXISTING BUILDING. THE SPECIFIC AREA(S) BEING REMODELED/ALTERED AT ANY SCHEDULED TIME ARE OBVIOUSLY EXCLUSIVE OF THIS STATEMENT. SERVICES TO EXISTING BUILDING SHALL BE KEPT IN CONTINUOUS OPERATION INCLUDING POWER, SIGNAL SYSTEMS, LIGHTING, TELEPHONE, HEATING, COOLING, VENTILATING, TEMPERATURE CONTROL. ANY ABSOLUTELY NECESSARY INTERRUPTION OF THESE SERVICES TO ACCOMPLISH CONTRACT WORK SHALL BE ARRANGED WITH THE OWNER A MINIMUM OF TEN (10) WORKING DAYS IN ADVANCE. SUCH INTERRUPTIONS SHALL BE KEPT TO AN ABSOLUTE MINIMUM AS FAR AS TIME INTERVAL IS INVOLVED AND TEMPORARY SERVICES SHALL BE FURNISHED AND INSTALLED UNDER THIS CONTRACT WHERE NECESSARY TO ACCOMPLISH THIS PURPOSE. TEMPORARIES SHALL BE REMOVED BY THE CONTRACTOR ONLY AFTER NEW PERMANENT SERVICES ARE INSTALLED AND FULLY OPERATIONAL.
- 14. UNLESS INDICATED OTHERWISE, THE ARCHITECT/ENGINEER MAKES NO REPRESENTATION AS TO WHETHER OR NOT ANY HAZARDOUS OR CONTAMINATED MATERIALS (INCLUDING BUT NOT LIMITED TO ASBESTOS, PCB'S, CONTAMINATED SOILS, ETC.) ARE PRESENT WITHIN THE EXISTING BUILDING OR ON THE SITE. WORK SHOWN ON THE DRAWINGS AND/OR INDICATED IN THE SPECIFICATIONS SHALL NOT BE CONSTRUED TO CALL FOR CONTACT WITH ANY OF THESE MATERIALS. IF THESE MATERIALS ARE ENCOUNTERED OR SUSPECTED, THE CONTRACTOR SHALL NOT DISTURB THEM AND SHALL CONTACT THE ARCHITECT/ENGINEER IMMEDIATELY.
- 15. CONTRACTOR SHALL STORE ALL MATERIALS AND EQUIPMENT SHIPPED TO THE SITE IN A PROTECTED AREA. IF MATERIAL IS STORED OUTSIDE OF THE BUILDING, IT MUST BE STORED OFF THE GROUND A MINIMUM OF SIX INCHES (6") SET ON 6 X 6 PLANKS AND/OR WOOD PALLETS. ALL MATERIAL AND EQUIPMENT MUST BE COMPLETELY COVERED WITH WATERPROOF TARPS OR VISQUIN. ALL CONDUIT WILL HAVE THE ENDS CLOSED TO KEEP OUT DIRT AND OTHER DEBRIS. NO EQUIPMENT WILL BE ALLOWED TO BE STORED ON THE SITE UNLESS IT IS SITTING ON WOOD PLANKS AND COMPLETELY PROTECTED WITH WEATHERPROOF COVERS.
- I.G. THE DRAWINGS, SCHEDULES AND SPECIFICATIONS HAVE BEEN PREPARED USING ONE MANUFACTURER FOR EACH PIECE OF EQUIPMENT AS THE BASIS FOR DIMENSIONAL DESIGN. IF THE CONTRACTOR PURCHASES EQUIPMENT FROM A SPECIFIED ACCEPTABLE MANUFACTURER, BUT NOT THE SCHEDULED MANUFACTURER USED FOR THE BASE DESIGN, THE CONTRACTOR SHALL BE RESPONSIBLE FOR CHECKING ALL THE DIMENSIONS OF THE EQUIPMENT TO VERIFY THAT IT WILL FIT IN THE SPACE SHOWN ON THE DRAWINGS. MINOR DEVIATIONS IN DIMENSIONS WILL BE PERMITTED, PROVIDED THE RATINGS MEET THOSE SHOWN ON THE DRAWINGS AND EQUIPMENT WILL PHYSICALLY FIT INTO THE SPACE ALLOCATED WITH SUITABLE ACCESS AROUND EQUIPMENT FOR OPERATION AND MAINTENANCE OF THE EQUIPMENT. WHEN EQUIPMENT SUBMITTED FOR REVIEW DOES NOT MEET THE PHYSICAL SIZE OR ARRANGEMENT OF THAT SCHEDULED AND SPECIFIED, CONTRACTOR SHALL PAY FOR ALL ALTERATIONS REQUIRED TO ACCOMMODATE SUCH EQUIPMENT AT NO ADDITIONAL COST TO THE OWNER. CONTRACTOR WILL ALSO PAY ALL COSTS FOR ADDITIONAL WORK REQUIRED BY OTHER CONTRACTORS, OWNER, ARCHITECT OR ENGINEER TO MAKE CHANGES WHICH WOULD ALLOW THE EQUIPMENT TO FIT IN THE SPACE AND FUNCTION AS INTENDED.
- 17. CONTRACTOR AND/OR MANUFACTURER SHALL VERIFY THAT THE CHARACTERISTICS OF THE EQUIPMENT HE SUBMITS FOR REVIEW MEET THE CAPACITY AND DUTY SPECIFIED.
- 18. CONTRACTOR SHALL BE RESPONSIBLE FOR OBTAINING ALL NECESSARY PERMITS AND THEIR ASSOCIATED FEES.

GENERAL ELECTRICAL NOTES: (APPLICABLE TO ALL SHEETS.)

- 1. THE MINIMUM WIRE SIZE SHALL BE #12 AWG. THE MINIMUM CONDUIT SIZE FOR HOMERUNS AND BRANCH FEEDS TO POWER OUTLETS SHALL BE 3/4". 1/2" CONDUIT IS ACCEPTABLE FOR BRANCH WIRING TO END OF THE LINE RECEPTACLES ONLY. ALL POWER BRANCH CIRCUITS SHALL TERMINATE AT 20A-1P CIRCUIT BREAKERS IN PANELBOARD INDICATED UNLESS NOTED OTHERWISE.
- 2. PROVIDE ALL PENETRATIONS, SLEEVES, AND SEALANT AS REQUIRED THROUGH PARTITIONS TO ACCOMMODATE THE FIRE ALARM, PAGING, CLOCK, VOICE, AND DATA CABLING. ANY PENETRATIONS THROUGH WALLS AND FLOORS SHALL BE PROPERLY SEALED AND TREATED TO MAINTAIN THE FIRE STOPPING RATING OF THE WALLS, FLOORS, AND CEILINGS.
- 3. BACKBOXES ARE TO BE MOUNTED OFFSET, NOT BACK TO BACK.
- 4. CIRCUIT NUMBER(S), WHERE SHOWN, ARE TO INDICATE QUANTITY OF CIRCUITS REQUIRED. VERIFY EXACT CIRCUIT NUMBER TO BE UTILIZED IN FIELD. CONTRACTOR SHALL PROVIDE ACTUAL CIRCUITING AS PART OF "AS BUILT" DRAWINGS.
- 5. UNLESS INDICATED OTHERWISE, ALL MATERIALS REQUIRED TO PROVIDE BRANCH CIRCUITS AND FEEDERS ARE TO BE NEW.
- 6. DURING THE COURSE OF INVESTIGATION AND DEMOLITION, IF IT IS DETERMINED THAT IT MAY BE FEASIBLE TO UTILIZE EXISTING MATERIALS FOR BRANCH CIRCUITS AND FEEDERS, CONTRACTOR SHALL NOTIFY ENGINEER FOR APPROVAL PRIOR TO PERFORMING ANY WORK.
- 7. ANY ELECTRICAL DEVICES ON NEW WALLS SHALL BE FLUSH MOUNTED. NO WIREMOLDS ARE ACCEPTABLE ON NEW WALLS UNLESS NOTED OTHERWISE.
- 8. VERIFY RECEPTACLE LOCATIONS WITH ARCHITECTURAL FURNITURE LAYOUT TO ENSURE PROPER ACCESSIBILITY.
- 9. DRAWINGS DO NOT REPRESENT ALL EXISTING FIRE ALARM DEVICES. INITIATING AND NOTIFICATION DEVICES NOT SHOWN ON THE DRAWINGS ARE EXISTING TO REMAIN. IT IS THE CONTRACTOR'S RESPONSIBILITY TO MAINTAIN OPERATION OF THE EXISTING DEVICES NOT SHOWN.
- 10. EXISTING FIRE ALARM SYSTEM SHALL BE OPERATIONAL AT ALL TIMES. THE OCCUPIED AREA OF THE BUILDING SHALL NOT BE LEFT UNPROTECTED AT ANY TIME. IF AN INTERRUPTION OF FIRE ALARM SYSTEM IS REQUIRED TO FACILITATE DEVICE INSTALLATION, PROVIDE 48 HOURS OF ADVANCE NOTICE TO THE OWNER AND THE LOCAL FIRE DEPARTMENT. CONTRACTOR SHALL HIRE AN AUTHORIZED PERSONNEL TO WATCH/GUARD ANY UNPROTECTED AREAS OF THE BUILDING WHERE NECESSARY.
- II. UNLESS INDICATED ON ARCHITECTURAL DRAWINGS, THE CONTRACTOR SHALL BE RESPONSIBLE AND PAY FOR ALL CORING, CUTTING, PATCHING, REPAIRING, REFINISHING, AND REMOVAL/REPLACEMENT OF NEW OR EXISTING BUILDING CONSTRUCTION REQUIRED TO ACCOMMODATE THE INSTALLATION OR REMOVAL OF THEIR WORK. REMOVE, STORE, AND REINSTALL CEILING TILES AS REQUIRED TO INSTALL WORK ABOVE EXISTING REMOVABLE CEILINGS WHICH REMAIN; REPLACE TILES BROKEN OR DAMAGED DURING CONSTRUCTION. ALL PATCHING, REPAIRING, AND REFINISHING WORK TO OTHER FINISHES AND STRUCTURAL ELEMENTS SHALL BE PERFORMED BY THOSE REGULARLY INVOLVED IN THAT TRADE AND SHALL MATCH THE ADJACENT CONSTRUCTION AS CLOSELY AS POSSIBLE WHILE MAINTAINING EXISTING FIRE RATINGS. CONTRACTOR SHALL BE RESPONSIBLE FOR DETERMINING EXISTING FIRE RATINGS OF CEILINGS AND PARTITIONS SYSTEMS. CARE SHALL BE TAKEN SO AS NOT TO DAMAGE ANY EXISTING BUILDING CONSTRUCTION OR ITEMS THAT ARE TO REMAIN. ANY EXISTING FINISHES THAT ARE DAMAGED DURING THE INSTALLATION OF NEW WORK OR REMOVAL OF EXISTING WORK SHALL BE REPAIRED, REPLACED, AND PAID FOR BY THE INSTALLING CONSTRUCTION THAT IS TO REMAIN AND, THEREFORE, SUBJECT TO PATCHING, REPAIRING, REFINISHING, AND REMOVAL/REPLACEMENT.
- I 2. REMOVE AND REINSTALL CEILING MOUNTED DEVICES AS REQUIRED TO ALLOW INSTALLATION OF FEEDERS, BRANCH CIRCUITS, MECHANICAL PIPING, AND DUCT WORK. DEVICES INCLUDE BUT ARE NOT LIMITED TO: LUMINAIRES, SPEAKERS, FIRE ALARM, AND PAGING DEVICES.
- 13. PROVIDE PULL BOX(ES) BETWEEN PULL POINTS AS REQUIRED TO COMPLY WITH NEC 344.26 SUCH THAT THERE SHALL NOT BE MORE THAN THE EQUIVALENT OF FOUR QUARTER BENDS (360 DEGREE TOTAL) BETWEEN PULL POINTS.
- 14. SPECIAL ATTENTION SHALL BE PAID TO ALL CONDUIT ROUTING IN OPEN CEILING SPACE FOR AESTHETIC PURPOSES. ALL EXPOSED CONDUITS SHALL BE ROUTED PERPENDICULAR AND PARALLEL TO BUILDING LINES AND TIGHT TO CEILING/STRUCTURAL CORNERS. WHERE THIS IS NOT FEASIBLE, SUBMIT CONDUIT ROUTING PLAN TO ARCHITECT/ENGINEER FOR APPROVAL PRIOR TO INSTALLATION.
- 15. IN RENOVATIONS, IF AN EXISTING RECEPTACLE/JUNCTION BOX LOCATION WILL END UP HIDDEN BEHIND PERMANENTLY INSTALLED EQUIPMENT OR CASEWORK, PROCEED AS NOTED BELOW:
- A. IF THE RECEPTACLE IS AN END OF LINE DEVICE (IT DOES NOT FEED OTHER DEVICES), IT SHALL BE REMOVED INCLUDING ASSOCIATED WIRING BACK TO LAST ACTIVE DEVICE OR JUNCTION BOX AND A BLANK COVER PLATE INSTALLED.

 B. IF THE RECEPTACLE DOES SERVE DOWNSTREAM DEVICES, REMOVE RECEPTACLE AND REWORK WIRING TO A NEW OR EXISTING JUNCTION BOX ABOVE CEILING SUCH THAT NO WIRES ARE PRESENT IN THE JUNCTION BOX. A BLANK COVER PLATE SHALL BE INSTALLED.
- 16. CONTRACTOR SHALL PROVIDE DEDICATED NEUTRAL FOR EACH BRANCH CIRCUIT TO MEET THE REQUIREMENTS OF NEC ARTICLE 210.4(B).
- 17. LOW VOLTAGE CABLES INCLUDING, BUT NOT LIMITED TO, TELECOMMUNICATIONS, PAGING, TEMPERATURE CONTROL, FIRE ALARM, LIGHTING CONTROL, AND AUDIO/VIDEO SYSTEMS, ETC., SHALL BE INSTALLED IN A COMPLETE RACEWAY SYSTEM IN ALL INACCESSIBLE AREAS.
- 18. IN JUNCTION BOXES WHERE CURRENT CARRYING CONDUCTORS ARE SPLICED OR TERMINATED, PROVIDE BOND TO JUNCTION BOX FROM EQUIPMENT GROUNDING CONDUCTOR.
- 19. IN AREAS OF THE BUILDING WHERE NEW CEILING HEIGHT IS HIGHER THAN THE EXISTING CEILING HEIGHT, ANY EXISTING CONDUITS/CONDUCTORS AND JUNCTION BOXES SERVING EXISTING DEVICES/EQUIPEMNT TO REMAIN SHALL BE RE-ROUTED, RELOCATED, AND MODIFIED AS REQUIRED TO ACCOMMODATE NEW CEILING HEIGHT. FIELD VERIFY EXACT CONDITIONS.
- 20. IN AREAS OF THE BUILDING WHERE NEW DRYWALL OR PLASTER CEILING IS SCHEDULED TO BE INSTALLED, ANY EXISTING JUNCTION BOXES AND ASSOCIATED CONDUITS/CONDUCTORS SHALL BE MODIFIED AND RELOCATED AS REQUIRED TO AN ACCESSIBLE LOCATION UNLESS NEW ACCESS PANELS ARE PERMITTED TO BE INSTALLED IN NEW CEILING BY THE ARCHITECT.
- 21. COORDINATE POWER REQUIREMENTS FOR BUILDING AUTOMATION SYSTEM (BAS) CONTROLLERS WITH MECHANICAL/BAS CONTRACTORS. PROVIDE 2#12, 1#12G. IN 3/4"C. FROM EACH BAS CONTROLLER TO A NEW 20A-1P CIRCUIT BREAKER IN ELECTRICAL PANEL SERVING AREA WITH SPACE AND CAPACITY.
- 22. REFER TO MECHANICAL PLANS FOR EXACT LOCATIONS OF THERMOSTAT/CARBON DIOXIDE DETECTORS. PROVIDE SINGLE GANG BACKBOX AND EMPTY 3/4" CONDUIT WITH PULL STRING STUBBED INTO ACCESSIBLE CEILING SPACE FOR INSTALLATION OF THERMOSTAT/CARBON DIOXIDE DETECTORS. CABLING AND DEVICE SHALL BE BY OTHERS.
- 23. ALL EXPOSED CONDUIT SHALL BE PAINTED TO MATCH SURROUNDING FINISHES.
- 24. CONDUITS AND RACEWAYS SHALL NOT BE ROUTED ACROSS FLOORS OR SLABS.
- 25. CONDUCTORS FOR EQUIPMENT RATED 100AMP. AND BELOW ARE SIZED PER ARTICLE 110.14(C)(1)(a)(2) WHICH INDICATES TO UTILIZE THE 60° TEMPERATURE RATING COLUMN OF TABLE 310.15(B)(16) REGARDLESS OF CONDUCTOR INSULATION RATING.
- 26. WHERE EXISTING RACEWAYS ARE REUSED, CONTRACTOR SHALL BE RESPONSIBLE FOR MECHANICAL INTEGRITY OF RACEWAY. CONTRACTOR SHALL PERFORM ALL REPAIRS TO ANY REUSED EXISTING RACEWAY SO THAT RACEWAY SYSTEM IS CONTINUOUS AND CODE COMPLIANT. CONTRACTOR SHALL ENSURE ANY EXISTING RACEWAY SYSTEM DOES NOT DAMAGE NEW CONDUCTORS/CABLES. CONTRACTOR SHALL BE FULLY RESPONSIBLE FOR THE REUSED RACEWAY AND WARRANTY THEM AS NEW.
- 27. LOCATE NOTIFICATION APPLIANCE CIRCUIT (NAC) PANELS, IN SERVICE SPACES SUCH AS JANITOR/STORAGE CLOSET OR MECHANICAL/ELECTRICAL ROOMS. PROVIDE A SMOKE DETECTOR ABOVE EACH NAC PANEL.
- 28. PROVIDE A DEDICATED 120VAC. 20AMP. BRANCH CIRCUIT TO EACH NAC PANEL FROM THE NEAREST ELECTRICAL PANEL WITH SPARE SPACE/CAPACITY. PROVIDE 20A-1P CIRCUIT BREAKER OF TYPE TO MATCH PANEL WITH ACCESSORY TO LOCK FIRE ALARM CIRCUIT BREAKER IN THE "ON" POSITION. PROVIDE UPDATED PANELBOARD DIRECTORY TO REFLECT ANY CHANGES.
- 29. ROOM NAMES AND NUMBERS ARE SHOWN ON THE DRAWINGS FOR REFERENCES ONLY. CONTRACTOR SHALL FIELD VERIFY AND OBTAIN EXACT ROOM NAMES AND NUMBERS TO BE UTILIZED FOR PROGRAMMING AND ALL CLOSEOUT DOCUMENTS.
- 30. EACH INITIATING DEVICE SHALL BE PROVIDED WITH A VISIBLE LABEL WITH BAR CODE TO INCLUDE THE DEVICE ADDRESS NUMBER.
- 31. ADJUST LOCATION OF SMOKE/HEAT DETECTORS A MINIMUM OF 3 FEET AWAY FROM HVAC DIFFUSERS.
- 32. PROVIDE ALL REQUIRED COMPONENT FOR AN OPERABLE FIRE ALARM SYSTEM, INCLUDING BUT NOT LIMITED TO NAC PANELS, AMPLIFIERS, BATTERY CABINETS, ETC.

GENERAL ELECTRICAL DEMOLITION NOTES: (APPLICABLE TO ALL SHEETS.)

- 1. ALL INDICATED ELECTRICAL EQUIPMENT, LUMINAIRES, DEVICES, AND RELATED CONDUIT AND WIRING TO BE REMOVED UNLESS NOTED OTHERWISE.
- 2. ALL DEMOLITION OF THE ELECTRICAL SYSTEM AS NOTED ON THE DEMOLITION DRAWINGS SHALL BE COORDINATED WITH THE RENOVATION REQUIREMENTS TO DETERMINE THIS CONTRACTOR'S WORK.
- 3. IT IS THE INTENT OF THE ELECTRICAL DEMOLITION DRAWING(S) TO INDICATE AREAS IN WHICH ELECTRICAL EQUIPMENT, CONDUIT, LUMINAIRES, DEVICES, ETC. NEED TO BE REMOVED, RELOCATED, OR MODIFIED BY THIS CONTRACTOR TO ALLOW FOR THE RENOVATION PHASE OF CONSTRUCTION. THE ELECTRICAL DEMOLITION PLAN IS FOR REFERENCE PURPOSES ONLY AND IT IS NOT INTENDED TO BE THE SOLE SOURCE OF EXISTING CONDITIONS.
- 4. CONTRACTOR SHALL VISIT THE BUILDING, BEFORE SUBMITTING THEIR BID, TO VERIFY THE EXISTING CONDITIONS WHICH WILL AFFECT THEIR WORK.
- 5. CONTRACTOR SHALL BE RESPONSIBLE FOR THE COMPLETE ELECTRICAL DEMOLITION REQUIRED TO ACCOMMODATE THE RENOVATION. REMOVE AS REQUIRED ALL LUMINAIRES, CONNECTIONS TO MECHANICAL EQUIPMENT, DEVICES, ETC.. PULL OUT ALL UNUSED CONDUCTORS AND CABLES, AND REMOVE ALL ABANDONED CONDUIT. ELECTRICALLY DISCONNECT AIR HANDLING UNITS, PUMPS, BOILERS, AND OTHER SUCH EQUIPMENT FOR REMOVAL BY OTHERS. BACKFEED AS REQUIRED ALL DOWNSTREAM DEVICES WHICH REMAIN. (THE CONTRACTOR SHALL COORDINATE WITH THE OWNER WHICH ITEMS INDICATED TO BE REMOVED \$ DISCONNECTED SHALL BE SALVAGED AND PRESENTED TO THE OWNER PRIOR TO ANY DISPOSAL OF THESE ITEMS.)
- 6. ALL REMOVED EQUIPMENT SHALL BECOME THE PROPERTY OF THE CONTRACTOR AND SHALL BE REMOVED FROM THE SITE. WHERE WORK CALLED FOR ON THE DRAWINGS OR IN THE SPECIFICATIONS INVOLVES THE REMOVAL OF FLUORESCENT LAMPS CONTAINING MERCURY OR CLOTH INSULATED CONDUCTORS, THEY SHALL BE PROPERLY HANDLED AND REMOVED FROM SITE BY APPROVED METHODS PER EPA REGULATIONS.
- 7. ALL EXISTING RECEPTACLES/DATA OUTLETS/DEVICES/EQUIPMENT THAT ARE NOT PART OF DEMOLITION SHALL REMAIN AS IS UNLESS NOTED OTHERWISE. CONTRACTOR SHALL CHECK AND VERIFY FOR CONTINUING OPERATION OF THESE DEVICES PRIOR TO SUBSTANTIAL COMPLETION. IF ANY EXISTING CIRCUITS TO REMAIN ARE INTERRUPTED BY DEMOLITION OR NEW CONSTRUCTION, CONTRACTOR SHALL BE RESPONSIBLE FOR REPLACEMENT/REMOVAL/REROUTING/MODIFICATION OF CONDUITS AND WIRES INCLUDING EXTENSION, AS REQUIRED TO MAINTAIN FUNCTIONALITY OF DOWNSTREAM RECEPTACLES/DATA OUTLETS/DEVICES/EQUIPMENT.
- 8. THE CONTRACTOR SHALL COORDINATE WITH THE PROJECT PHASING AND MAINTAIN EXISTING SYSTEMS ACTIVE IN AREAS WHICH REMAIN OCCUPIED.
- 9. EXISTING CEILING MOUNTED SPEAKERS, PROGRAM BELLS, FIRE ALARM DEVICES, AND SIMILAR ELECTRICAL EQUIPMENT AND DEVICES TO REMAIN SHALL BE EXTENDED AND REINSTALLED AS REQUIRED IN NEW CEILINGS. FIELD VERIFY EXACT QUANTITIES AND REQUIREMENTS.
- IO. SUPPORT ALL CABLING DRAPED OR LYING LOOSE ABOVE EXISTING CEILINGS WHICH ARE SCHEDULED TO BE REMOVED. TIE WRAP CABLING TO JOISTS OR OTHER STRUCTURAL MEMBERS AS REQUIRED. UPON THE COMPLETION OF THE PROJECT, NO CABLING SHALL BE LYING ON ACCESSIBLE CEILINGS.
- I I. WHERE EXISTING DEVICE IS REMOVED FROM WALL WITH NO NEW DEVICE GOING BACK AT SAME LOCATION, PROVIDE BLANK BRUSHED STAINLESS STEEL COVER PLATES AS REQUIRED. COVER PLATES SHALL BE OF PROPER SIZE AND INSTALLED FLUSH WITH WALL.

GENERAL LIGHTING NOTES: (APPLICABLE TO ALL SHEETS.)

- 1. THE MINIMUM WIRE SIZE SHALL BE #12 AWG. THE MINIMUM CONDUIT SIZE FOR HOMERUNS SHALL BE 3/4". 1/2" CONDUIT IS ACCEPTABLE FOR BRANCH WIRING TO LUMINAIRES WHERE APPLICABLE. ALL LIGHTING BRANCH CIRCUITS SHALL TERMINATE AT 20A-1P CIRCUIT BREAKERS IN PANELBOARD INDICATED UNLESS NOTED OTHERWISE.
- 2. PROVIDE LOCK-ON CIRCUIT BREAKER DEVICES FOR ALL EMERGENCY LIGHTING \$ EXIT SIGN BRANCH CIRCUITS.
- 3. REFER TO ARCHITECTURAL REFLECTED CEILING PLANS FOR EXACT LUMINAIRE LOCATIONS.
- 4. CIRCUIT NUMBER(S), WHERE SHOWN, ARE TO INDICATE QUANTITY OF CIRCUITS REQUIRED. VERIFY EXACT CIRCUIT NUMBER TO BE UTILIZED IN FIELD. CONTRACTOR SHALL PROVIDE ACTUAL CIRCUITING AS PART OF "AS BUILT" DRAWINGS.
- 5. EMERGENCY BATTERY PACKS SHOWN ARE TO BE CONNECTED TO THE NEAREST LIGHTING BRANCH CIRCUIT AHEAD OF LOCAL SWITCH UNLESS NOTED OTHERWISE.
- 6. ALL LAY-IN LUMINAIRES SHALL BE INDEPENDENTLY SUPPORTED AT OPPOSITE CORNERS TO A STRUCTURAL MEMBER.
- 7. PROVIDE PULL BOX(ES) BETWEEN PULL POINTS AS REQUIRED TO COMPLY WITH NEC 344.26 SUCH THAT THERE SHALL NOT BE MORE THAN THE EQUIVALENT OF FOUR QUARTER BENDS (360 DEGREE TOTAL) BETWEEN PULL POINTS.
- 8. PROVIDE DEDICATED NEUTRAL FOR EACH BRANCH CIRCUIT TO MEET THE REQUIREMENTS OF NEC ARTICLE 210.4(B).
- 9. IN JUNCTION BOXES WHERE CURRENT CARRYING CONDUCTORS ARE SPLICED OR TERMINATED, PROVIDE BOND TO JUNCTION BOX FROM EQUIPMENT GROUNDING CONDUCTOR.

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COLLEGE

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KEY PLAN:

SHEET STATUS: 9.19.23
ISSUED FOR BIDS

NO: DESCRIPTION: DATE:

ELECTRICAL NOTES

E SHEET TITLE:

SHEET NUMBER:

L5 1

	EXIT SIGN & EMERGENCY LIGHTING SCHEDULE												
SYMBOL	TAG	DESCRIPTION	MOUNTING	LAMPS	VOLTAGE	MANUFACTURER & CATALOG NUMBER	ALTERNATIVE MANUFACTURER	NOTES					
⊗ ⊗	EMI	SELF POWERED EMERGENCY EXIT SIGN, SINGLE FACE, DIE CAST ALUMINUM HOUSING WITH WHITE FINISH AND RED LETTERS, FIELD KNOCKOUT ARROWS AS REQUIRED	TOP OR END MOUNT	LED	UNV	LITHONIA LIGHTING #LQC-W- I -R-ELN	HLI DUAL-LITE, SIGNIFY CHLORIDE	I					
፟	EM2	SELF POWERED EMERGENCY EXIT SIGN, SINGLE FACE, DIE CAST ALUMINUM HOUSING WITH WHITE FINISH AND RED LETTERS, FIELD KNOCKOUT ARROWS AS REQUIRED	WALL	LED	UNV	LITHONIA LIGHTING #LQC-W- I -R-ELN	HLI DUAL-LITE, SIGNIFY CHLORIDE	1					
+	EM3	DUAL HEAD EMERGENCY LIGHTING UNIT WITH WHITE CONTEMPORARY THERMOPLASTIC ENCLOSURE	SURFACE/ WALL	LED	UNV	LITHONIA LIGHTING #ELM4L-UVOLT-LTP-SDRT	HLI DUAL-LITE, SIGNIFY CHLORIDE	I					
+	EM4	DUAL HEAD EMERGENCY LIGHTING UNIT WITH WHITE CONTEMPORARY THERMOPLASTIC ENCLOSURE	SURFACE/ WALL	LED	UNV	LITHONIA LIGHTING #ELMGL-UVOLT-LTP-SDRT	HLI DUAL-LITE, SIGNIFY CHLORIDE	1					
-	EM5	DUAL HEAD EMERGENCY LIGHTING UNIT WITH WHITE CONTEMPORARY THERMOPLASTIC ENCLOSURE AND WEATHER-PROOF REMOTE HEADS	SURFACE/ WALL	LED	UNV	LITHONIA LIGHTING #ELMGL-UVOLT-LTP-SDRT-HO #ELMRW-LP22OL-DDBTXD-T	HLI DUAL-LITE, SIGNIFY CHLORIDE	l					

. CONNECT ALL DEVICES TO LOCAL UNSWITCHED NORMAL LIGHTING CIRCUIT.

GENERAL NOTES:

- a. CONTRACTOR TO PROVIDE ALL NECESSARY MOUNTING HARDWARE AND LABOR FOR ALL DEVICES.
- b. BATTERIES SHALL BE CAPABLE OF PROVIDING ILLUMINATION FOR A MINIMUM OF 90 MINUTES.

		c.	NOT ALL SYMBOLS WILL BE ACCOMPANIED BY TAGS ON THE FLOOR PLANS FOR CLARITY PURPOSES
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GENERAL NOTES:

- . ALL SENSOR LOCATIONS ARE APPROXIMATE, REFER TO MANUFACTURERS INSTALLATION INSTRUCTIONS PRIOR TO INSTALLATION.
- ULTRASONIC CEILING MOUNT SENSORS SHOULD BE LOCATED A MINIMUM OF SIX FEET FROM HVAC SUPPLY/RETURN VENTS.
- CONTRACTOR IS RESPONSIBLE FOR: PROPER SENSITIVITY & TIME DELAY SETTINGS (FOR NON-ADAPTIVE PRODUCTS) RECOMMENDED PLACEMENT, AND FIELD VERIFICATION OF CIRCUITS WITH IN RESPECT TO POWER PLACEMENT.
- CONTRACTOR IS RESPONSIBLE FOR FIELD VERIFICATION OF REQUIRED NUMBER OF POWER PACKS:
- ONE POWER PACK IS REQUIRED FOR EACH CIRCUIT TO BE CONTROLLED.
- ONE POWER PACK IS REQUIRED FOR EACH ZONE. • IF MULTIPLE CIRCUITS ARE TO BE CONTROLLED BY A SENSOR, AN AUXILIARY RELAY CAN BE USED IN CONJUNCTION WITH THE POWER PACK.
- THE MAXIMUM NUMBER OF SENSORS THAT CAN BE PUT ON A POWER PACK IS TO BE REDUCED BY ONE FOR EACH SLAVE PACK USED.
- MOUNT CONTROL UNITS WITHIN JUNCTION BOXES INSTALLED PER ALL CODE REQUIREMENTS. CONTROL WIRING BETWEEN SENSORS AND CONTROLS UNITS SHALL BE CLASS II, 18-24 AWG, STRANDED UL CLASSIFIED. ALL CONTROL CABLING SHALL BE PLENUM-RATED.
- SENSORS MOUNTED OVER THE DOOR MUST BE PLACED ONE FOOT INSIDE THE THRESHOLD. SENSOR PLACEMENT ON PLANS IS APPROXIMATE. CONTRACTOR IS RESPONSIBLE FOR ENGAGING A MANUFACTURER TO PRODUCE A MOTION SENSOR LAYOUT THAT IS COMPLIANT WITH THE GOVERNING ENERGY CODE.
- CONTRACTOR IS RESPONSIBLE FOR ENSURING MOTION CONTROL OF ALL LOCATIONS SHOWN ON PLAN. CONTRACTOR IS RESPONSIBLE FOR INSTALLING EQUIPMENT IN COMPLIANCE WITH LOCAL CODE.
- PRODUCTS FROM SPECIFIED AND ACCEPTABLE MANUFACTURERS SHALL PROVIDE SAME LEVEL OF CONTROL.

		LIGHTING CONTRO	OL DEVI	CES SCHEDUL	.E
SYMBOL	TYPE	DESCRIPTION	MOUNTING	MANUFACTURER & CATALOG NUMBER	ACCEPTABLE MANUFACTURERS
ECY		LIGHTING SYSTEM CONTROLLER	WALL	ACUITY nLIGHT #nECY-MVOLT-ENC	HUBBELL LIGHTING CONTROLS, WATTSTOPPER
0	osA	STANDARD RANGE 360°, LOW VOLTAGE, PASSIVE INFRARED	CEILING	ACUITY nLIGHT #nCM-9-RJB	HUBBELL LIGHTING CONTROLS, WATTSTOPPER
0	оѕВ	EXTENDED RANGE 360°, LOW VOLTAGE, PASSIVE INFRARED	CEILING	ACUITY nLIGHT #nCM-10-RJB	HUBBELL LIGHTING CONTROLS, WATTSTOPPER
0	osC	STANDARD RANGE 360°, LOW VOLTAGE, DUAL TECHNOLOGY	CEILING	ACUITY nLIGHT #nCM-PDT-9-RJB	HUBBELL LIGHTING CONTROLS, WATTSTOPPER
0	osD	EXTENDED RANGE 360°, LOW VOLTAGE, DUAL TECHNOLOGY	CEILING	ACUITY nLIGHT #nCM-PDT-10-RJB	HUBBELL LIGHTING CONTROLS, WATTSTOPPER
0	osE	WIDE VIEW, CEILING MOUNT, LOW VOLTAGE, DUAL TECHNOLOGY WITH WV BR BRACKET	CEILING	ACUITY nLIGHT #nWV-PDT-16-KIT	HUBBELL LIGHTING CONTROLS, WATTSTOPPER
0	osF	HIGH BAY RANGE 360°, LOW VOLTAGE, PASSIVE INFRARED	CEILING	ACUITY nLIGHT #nCM-G-RJB	HUBBELL LIGHTING CONTROLS, WATTSTOPPER
\$	osG	ON/OFF/DIM WALL SWITCH SENSOR, LOW VOLTAGE, DUAL TECHNOLOGY	WALL	ACUITY nLIGHT #nWSXA-PDT-LV-DX	HUBBELL LIGHTING CONTROLS, WATTSTOPPER
\$	sA	ON/OFF PUSHBUTTON CONTROL STATION	WALL	ACUITY nLIGHT #nPODMA	HUBBELL LIGHTING CONTROLS, WATTSTOPPER
\$	sВ	ON/OFF/DIM PUSHBUTTON CONTROL STATION	WALL	ACUITY nLIGHT #nPODMA-DX	HUBBELL LIGHTING CONTROLS, WATTSTOPPER

			OCCUPANCY SEN	ISOR		PHC	TOSEN	SOR	SWI	TCH T	YPE	TIME	CLOCK	
	VACANCY MODE	OCCUPANCY MODE	SENSOR TIMEOUT PERIOD (MINUTES)	OCCUPIED LEVEL %	UNOCCUPIED LEVEL %	SWITCHING (ON/OFF)	DIMMING	TARGET LIGHT LEVEL (FC)	MANUAL (ON/OFF)	MANUAL (ON/OFF/DIM)	KEY SWITCH	SCHEDULED ON AT	SCHEDULED OFF AT	NOTES
TYPICAL CLASSROOM	Х	П	20 MIN							Х				
TYPICAL OFFICE	Х		20 MIN							Χ				
TYPICAL STORAGE / MECHANICAL / ELECTRICAL	Х		20 MIN						Х					
TYPICAL RESTROOMS		Х	20 MIN	100	0				Х					
CORRIDOR		Х	20 MIN	100	0					Х				
CORRIDOR - NIGHT LIGHTS		Х	20 MIN	100	50				Χ					1
EXTERIOR LIGHTS						Х						DUSK - GOMIN	DAWN + GOMIN	
		Ш												
		Н												

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TYPE	DESCRIPTION	MOUNTING	LAMPS	VOLTAGE	INPUT WATTS	MANUFACTURER & CATALOG NUMBER	ALTERNATE MANUFACTURER	NOTES
FI	2'X4' LED TROFFER, 4000 NOMINAL LUMENS	RECESSED	LED	120 V	30.5	LITHONIA LIGHTING	HLI COLUMBIA LIGHTING,	1
FIA	2'X4' LED TROFFER, 4800 NOMINAL LUMENS	RECESSED	LED	120 V	39.3	#2BLT4-4OL-ADP-GZ1O-LP84O LITHONIA LIGHTING	SIGNIFY DAY-BRITE HLI COLUMBIA LIGHTING,	I
FIB	2'X4' LED TROFFER, 6000 NOMINAL LUMENS	RECESSED	LED	120 V	46.6	#2BLT4-48L-ADP-GZ O-LP840 LITHONIA LIGHTING	SIGNIFY DAY-BRITE HLI COLUMBIA LIGHTING.	
110	ZAT LED TROTTER, 6000 NOWINAL LUNIENS	RECESSED	LLD	120 V		#2BLT4-60L-ADP-GZ10-LP840	SIGNIFY DAY-BRITE	'
FIC	2'X4' LED TROFFER, 7200 NOMINAL LUMENS	RECESSED	LED	120 V	59.2	LITHONIA LIGHTING #2BLT4-72L-ADP-GZ10-LP840	HLI COLUMBIA LIGHTING, SIGNIFY DAY-BRITE	1
F2	2'X2' LED TROFFER, 3300 NOMINAL LUMENS	RECESSED	LED	120 V	26.5	LITHONIA LIGHTING #2BLT2-33L-ADP-GZ10-LP840	HLI COLUMBIA LIGHTING, SIGNIFY DAY-BRITE	1
F2A	2'X2' LED TROFFER, 4000 NOMINAL LUMENS	RECESSED	LED	120 V	31	LITHONIA LIGHTING	HLI COLUMBIA LIGHTING,	1
F3	4" SQUARE LED DOWNLIGHT, 1000 NOMINAL LUMENS	RECESSED	LED	120 V	10.6	#2BLT2-4OL-ADP-GZ O-LP84O LITHONIA LIGHTING	SIGNIFY DAY-BRITE HLI PRESCOLITE,	1
13	4 SQUARE LED DOWNLIGHT, TOOU NOWINAL LUWIENS	RECESSED	LLD	120 V		#LDN4SQ-40/10-LS4-WR-MVOLT-GZ10	SIGNIFY LIGHTOLIER	'
F3A	4" SQUARE LED DOWNLIGHT, 2000 NOMINAL LUMENS	RECESSED	LED	120 V	22.8	LITHONIA LIGHTING #LDN45Q-40/20-L54-WR-MVOLT-GZ I 0	HLI PRESCOLITE, SIGNIFY LIGHTOLIER	1
F4-8	8'-0" LONG LINEAR LED	RECESSED	LED	120 V	37.4	MARK LIGHTING	HLI LITECONTROL,	1
F5-7	7'-0" LONG LINEAR SUSPENDED LED	SUSPENDED	LED	120 V	32.8	#SL4L-LOP-8FT-FLP-TG-80CRI-40K-600LMF- I 20 MARK LIGHTING	SIGNIFY LEDALITE HLI LITECONTROL,	1,2
						#S4PD-LLP-7FT-MSL7-80CRI-40K-600LMF-SCT-MIN I 0-FLL-MV OLT-WHTT-ZT-F2/72A-RDCY-BLKCY-BCRD-MCS	SIGNIFY LEDALITE	
F5-12	I 2'-O" LONG LINEAR SUSPENDED LED	SUSPENDED	LED	120 V	56.2	MARK LIGHTING	HLI LITECONTROL,	1,2
						#S4PD-LLP- 2FT-MSL6-80CRI-40K-600LMF-SCT-MIN 0-FLL-M VOLT-WHTT-ZT-F2/72A-RDCY-BLKCY-BCRD-MCS	SIGNIFY LEDALITE	
5-12-NL	I 2'-0" LONG LINEAR SUSPENDED LED WITH NIGHT LIGHT SECTION	SUSPENDED	LED	120 V	56.2	MARK LIGHTING #S4PD-LLP- I 2FT-MSL6-80CRI-40K-600LMF-SCT-MIN I 0-FLL-M	HLI LITECONTROL, SIGNIFY LEDALITE	1,2
						VOLT-WHTT-1EC-ZT-F2/72A-RDCY-BLKCY-BCRD-MC5		
F6	4' LED STRIP LIGHT	SURFACE/ PENDANT	LED	120 V	31.8	LITHONIA LIGHTING #CLX-L48-5000LM-SEF-RDL-MVOLT-GZ 0-40K-80CRI-WH	HLI COLUMBIA LIGHTING, SIGNIFY DAY-BRITE	-
F7	6" ROUND RETROFIT LED DOWNLIGHT	SURFACE	LED	120 V	19	LITHONIA LIGHTING #LBRG-ALO2-SWW1-WR-WD-MVOLT-UGZ	HLI COLUMBIA LIGHTING, SIGNIFY DAY-BRITE	1
F8A	6'x20' CUSTOM LINEAR LED	SURFACE	LED	120 V	288.6	AXIS LIGHTING	FOCAL POINT,	1,3
F8B	8'x20' CUSTOM LINEAR LED	SURFACE	LED	120 V	310.8	#SCSPAT-R(6'x20')-500-80-40-FL-NL-W-UNV-DP-1-SB15 AXIS LIGHTING	LUMENWERX FOCAL POINT,	1,3
						#SCSPAT-R(8'x20')-500-80-40-FL-NL-W-UNV-DP-1-SB15	LUMENWERX	
F8C	4'x14' CUSTOM LINEAR LED	SURFACE	LED	120 V	199.8	AXIS LIGHTING #SCSPAT-R(4'x 4')-500-80-40-FL-NL-W-UNV-DP- -SB 5	FOCAL POINT, LUMENWERX	1,3
F9	6" ROUND PENDANT LED DOWNLIGHT	PENDANT	LED	120 V	14.7	GOTHAM LIGHTING #EVOGPC-40/15-WR-MD-MVOLT-GZ10-JBX-PCAN-S12-DBL	HLI PRESCOLITE, SIGNIFY LIGHTOLIER	1,2
10-20	20'-0" LONG DIRECT/INDIRECT LINEAR LED	SUSPENDED	LED	120 V	113.8	MARK LIGHTING	HLI LITECONTROL,	1,2
						#S4PID-LLP-20FT-MSL4-80CRI-80CRI-40K-400LMF-DBW-180C RI-140K-1400LMF-BW-SCT-MIN I 0-FLL-DC-MVOLT-WHTT-F I /72A	SIGNIFY LEDALITE	
*10A-6	6'-0" LONG DIRECT/INDIRECT LINEAR LED	SUSPENDED	LED	120 V	67.1	-RDCY-WHTCY-WCRD-MC5 MARK LIGHTING	HLI LITECONTROL,	1,2
10A-6	6-0 LONG DIRLCHAINDIRLCT LINEAR LLD	JUJI LINDLD	LLD	120 V	67.1	#54PID-LLP-6FT-MSL6-80CRI-80CRI-40K-800LMF-DBW-180CRI	SIGNIFY LEDALITE	1,2
						-I40K-I800LMF-BW-SCT-MIN I 0-FLL-DC-MVOLT-WHTT-F I/72A-R DCY-WHTCY-WCRD-MCS		
FII	LINEAR DECORATIVE LED PENDANT	PENDANT	LED	120 V	11	OCL #GS I -P I CF-30-CR-(FINISH)-LED I -40K-UNV- I 44-DM I	-	1,2
FI2	ROUND DECORATIVE LED PENDANT	PENDANT	LED	120 V	43	STRUCTURA	-	1,2
FI3	CIRCULAR LED PENDANT	PENDANT	LED	120 V	65	#AURA-OVAL-D-3.5-L4O-HO-(FINISH)-CE/I-STD DELRAY LIGHTING		1,2
						#IL793-(FINISH)-(FINISH)-W40-M-I-D-CM I (LENGTH)		1,5
FI4	4'-0" LONG LINEAR LED WITH POP-DOWN LENS	SURFACE	LED	120 V	51	FOCAL POINT #FSM4LS-PD 5- OOOLF-40K- C-UNV-LD -SM-(FINISH)-4'	AXIS LIGHTING, LUMENWERX	-
FI5	DECORATIVE LED PENDANT	PENDANT	LED	120 V	75	CERCHIO LIGHTING #10148.E12.(FINISH)	-	1,2
FIGA	6'-10" LONG DIRECT LINEAR LED WITH ACOUSTIC PANEL	SUSPENDED	LED	120 V	30.7	FOCAL POINT	-	1,2,4
FI6B	7'-2" LONG DIRECT LINEAR LED WITH ACOUSTIC PANEL	SUSPENDED	LED	120 V	32.3	#ASM2S-RL- 2-500LF-40K- C-UNV-LD -J96BK-DTS-6FT OIN FOCAL POINT	_	1,2,4
						#ASM25-RL-12-500LF-40K-1C-UNV-LD1-J96BK-DTS-7FT2IN		
FI6C	7'-9" LONG DIRECT LINEAR LED WITH ACOUSTIC PANEL	SUSPENDED	LED	120 V	34.9	FOCAL POINT #ASM25-RL- 2-500LF-40K- C-UNV-LD -J96BK-DTS-7FT9IN	-	1,2,4
F16D	8'-7" LONG DIRECT LINEAR LED WITH ACOUSTIC PANEL	SUSPENDED	LED	120 V	38.6	FOCAL POINT	-	1,2,4
FIGE	8'-9" LONG DIRECT LINEAR LED WITH ACOUSTIC PANEL	SUSPENDED	LED	120 V	39.4	#ASM2S-RL-12-500LF-40K-1C-UNV-LD1-J96BK-DTS-8FT7IN FOCAL POINT	-	1,2,4
F16F	9'-3" LONG DIRECT LINEAR LED WITH ACOUSTIC PANEL	SUSPENDED	LED	120 V	41.6	#ASM2S-RL-12-500LF-40K-1C-UNV-LD1-J96BK-DTS-8FT9IN FOCAL POINT	_	1,2,4
						#ASM25-RL-12-500LF-40K-1C-UNV-LD1-J96BK-DTS-9FT3IN	-	1,4,4
FI7	4'-0" LONG LINEAR LED	RECESSED	LED	120 V	37	FOCAL POINT #FSM4L-FL-1000LF-40K-1C-UNV-LD1-G1-WH-4FT0IN	AXIS LIGHTING, LUMENWERX	

LUMINAIRE SCHEDULE

- CONTRACTOR TO PROVIDE ALL OPTIONS AND ACCESSORIES AS REQUIRED TO INSTALL LUMINAIRE IN VARYING CEILING TYPES AS SHOWN ON THE PLANS.
- REFER TO ARCHITECTURAL PLANS AND ELEVATIONS FOR EXACT SUSPENSION LENGTHS.
- INCLUDE ALL CONNECTORS AND JOINT TO MATCH THE PATTERN/SHAPE SHOWN ON PLANS. REFER TO ARCHITECTURAL RCP PLANS FOR EXACT LENGTH OF LUMINAIRE REQUIRED.

GENERAL NOTES:

- CONTRACTOR TO PROVIDE NECESSARY MOUNTING HARDWARE AND LABOR FOR LUMINAIRES.
- LAY IN CEILING GRID LUMINAIRES SHALL BE FOR USE WITH STANDARD 15/16" GRID SYSTEM.
- CEILING TYPES, FINISHES AND HEIGHTS MAY VARY. SEE ARCHITECTURAL RCP PLANS FOR MORE INFO. CONTRACTOR TO COORDINATE \$ PROVIDE PROPER MOUNTING HARDWARE, FLANGE, AND ACCESSORIES AS REQUIRED. d. ALL FINISH COLORS AND COLOR TEMPERATURES TO BE CONFIRMED BY THE ARCHITECT.

ARCHITECT OF RECORD DEMONICA KEMPER ARCHITECTS 125 N. HALSTED STREET, SUITE 301 **CHICAGO, IL 60661** P: 312.496.0000

MEP-FP-T-ENGINEERS 20/10 ENGINEERING GROUP, LLC 1216 TOWER ROAD SCHAUMBURG,IL 60173


P: 847.882.2010 F: 847.882.2201 CIVIL ENGINEERS **HRG GREEN** 1391 CORPORATE DRIVE, SUITE

P:815.385.1778 F:815.385.1781

203 MCHENRY ,IL 60050

KEY PLAN:

9.19.23 SHEET STATUS: **ISSUED FOR BIDS**

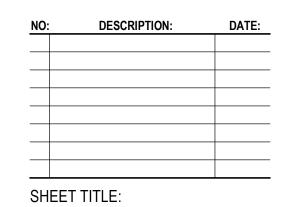

ELECTRICAL SCHEDULES

SHEET NUMBER:

PANEL SCHEULE: "F	P-2"		LOCA	ATION:	IT /	ELE	CTRIC	CAL 146 C.B. RATING: 42 KAIC
VOLT: 208/120V, 3Ø, 4W	MAINS: 225 /	A MLO	MOU	NTING:	SUR	RFA	CE	TYPE: BOLT-ON
REMARKS: NEW PANEL.			V.A.		_			
USE AND/OR AREA SERVED	C/B CIR.	Α	В	С	CIR. NO.	(C/B	USE AND/OR AREA SERVED
R: CLASSROOM 147	20 A IP I	540 720			2	 I P	20 4	R: CLASSROOM 149
R: CLASSROOM 147	20 A IP 3	720	360					
R: CLASSROOM 147	20 A IP 5		360	540	4			R: CLASSROOM 149
R: CLASSROOM 147	20 A IP 7	675		540	6	1P 	20 A	R: CLASSROOM 149
R: CLASSROOM 147	20 A IP 9	675	1600		8	1P	20 A	R: CLASSROOM 149
			1600	1,000	10	ΙP	20 A	R: CLASSROOM 149
R: CLASSROOM 147	20 A IP II			1600	12	 1P	20 A	R: CLASSROOM 149
R: CLASSROOM 147	20 A IP 13	1600			14	 IP	20 A	R: CLASSROOM 149
R: CLASSROOM 147	20 A IP 15		1600		16	 IP	20 A	R: CLASSROOM 149
R: CLASSROOM 147	20 A IP 17			1600				R: CLASSROOM 149
R: CLASSROOM 147	20 A IP 19			1600				
R: CLASSROOM 148	20 A IP 21	1600	540			1P 	20 A	R: CLASSROOM 149
R: CLASSROOM 148	20 A IP 23			540	22			
R: CLASSROOM 148	20 A IP 25				24			
		340	077		26			
R: CLASSROOM 148	20 A IP 27		675		28			
R: CLASSROOM 148	20 A IP 29			1600	30			
R: CLASSROOM 148	20 A IP 31	1600			32			
R: CLASSROOM 148	20 A IP 33		1600					
R: CLASSROOM 148	20 A IP 35			1600	34			
R: CLASSROOM 148	20 A IP 37	1600			36			
R: CLASSROOM 148	20 A IP 39		1600		38			
<u> </u>			1600		40			
					42			
	43				44			
	45				46			
	47							
	49				48			
	51				50			
	53				52			
					54			
	55				56			
	57				58			
	59				60			
	61							
	63				62			
	 65				64			
	67				66			
	69				68			
					70			
					72			
	73				74			
	75				76			
	77							
	79				78			
	81				80			
			I		1	l	I.	1
					82			
					84			35,505 VA

VOLT: 208/120V 20 4W	MAINIC: 225	A	IMOLI	NITINIC	GIIE	ΕΛ	CE.	TVDE: BOLT ON
VOLT: 208/120V, 3Ø, 4W REMARKS: NEW PANEL.	MAINS: 225	A MLO	IMOU	NTING:	SUR	(FA ——	CE	TYPE: BOLT-ON
TILIVIATING. INLW FAINLE.			V.A.	-				
USE AND/OR AREA SERVED	C/B CIF). A	В	С	CIR. NO.	(C/B	USE AND/OR AREA SERVED
R: CORRIDOR COO I	20 A IP I	720 360			2	 1P	20 A	R: GROUP STUDY 100
R: WELCOME OO I	20 A IP 3		900 540		4	 IP	20 A	R: CLASSROOM 102
R: LOUNGE 105	20 A IP 5			720 900	6	 IP	20 A	R: CLASSROOM 102
R: LOUNGE 105	20 A IP 7	720 720			8	 I P	20 A	R: CLASSROOM 102
R: GROUP STUDY 105A	20 A IP 9		720					
R: GROUP STUDY 105B	20 A IP I I		720	720				R: TOILET 103 + 104
R: CLASSROOM 137	20 A IP 13			1200	12			TOILET ADA OPERATORS
R: CLASSROOM 137	20 A IP 15	800	1080		14	1P 	20 A	R: CORRIDOR (EWC)
R: CLASSROOM 137	20 A IP 17	7	400	675	16	1P 	20 A	R: CORRIDOR (EWC)
R: CONFERENCE 50B	20 A IP 19	720		720	18	1P 	20 A	R: CORRIDOR
R: CONFERENCE 50B	20 A I P 2 I	720	720		20	1P	20 A	R: CORRIDOR
R: CONFERENCE 50B	20 A I P 23		360	675	22	ΙP	20 A	R: IT/ELECTRICAL 146
				180	24	IP	20 A	R: ROOFTOP
R: CONFERENCE 50A	20 A IP 25	1200			26	 IP	20 A	VEST. VOO I ADA OPERATO
R: CONFERENCE 50A	20 A IP 27		720 528		28	 IP	20 A	M: EF-103
R: CONFERENCE 50A	20 A IP 29)		675 696	30	 1P	20 A	M: EF-141
R: KITCHEN 145	20 A IP 3 I	720 3333			32			
R: KITCHEN 145 (FRIDGE)	20 A IP 33		1200			3P	35 A	M: ECUH-VOOI
R: KITCHEN 145 (VEND)	20 A IP 35	5	3333	1200)		1011-1001
R: KITCHEN 145 (VEND)	20 A IP 37			3333	36			
R: KITCHEN 145 (VEND)	20 A IP 39	1000	1200			2P	20 A	M: ECH-V003
R: KITCHEN 145 (VEND)	20 A IP 4 I		1000	1200	40			
R: CORRIDOR COO4 (EWC)	20 A IP 43	8 800		528	42	1P 	20 A	M: EF-202
R: LACTATION / TOILET	20 A IP 45	5	540		44			
TOILET ADA OPERATORS	20 A IP 47	7		1200	46			
HAND DRYER (TOILET 103)	20 A IP 49	1725			48			
HAND DRYER (TOILET 103)	20 A I P 5 I		1725		50			
			1723	1705	52			
HAND DRYER (TOILET 104)	20 A IP 53			1725	54			
HAND DRYER (TOILET 143)	20 A IP 55				56			
	57	7			58			
	59)			00			
	61				62			
	63	3			64			
	65	5						
	67	7			66			
	69)			68			
	71				70			
	73	3			72			
	75	5			74			
	77				76			
	79				78			
					80			
					82			
	83	3			84			
TOTAL CONNECTED LOAD I	PED DHAGE.	18083	15686	16347	TC	OTA	L =	50,117 VA

VOLT: 208/120V, 3Ø, 4W	MAIN	S: 1	00	A MLO	MOI	JNTING:	SUF	RFA	CE		TYPE:	BOLT-ON
REMARKS: NEW PANEL.	1											
					V.A.							
USE AND/OR AREA SERVED	C/I	3	CIR. NO.	Α	В	С	CIR. NO.	(C/B	USE ANI	D/OR AF	REA SERVED
L: CLASSROOM/IT/ELECT	20 A	IР	1	1098								
				0			2	IР	20 A	Δ L: EXIS	STING E	XTERIOR
L: GROUP STUDY/CLASSROO	. 20 A	. IP	3		701							
					0		4	IР	20 A	Δ L: EXIS	STING E	XTERIOR
L: CONFERENCE/TOILETS	20 A	. IP	5			995	<u> </u>					
						0	6	IР	20 A	Δ L: EXIS	STING E	XTERIOR
L: TOILETS/STUDY	20 A	IР	7	887								
				0			8	IР	20 A	Δ L: EXIS	STING E	XTERIOR
L: WELCOME/LOUNGE	20 A	IP	9		742		-			A 1 = 14		
					0		10	IР	20 A	∆ L: EXIS	STING E	XTERIOR
L: KITCHEN/TOILETS	20 A	IP	11			569	-					
L CORRIDOR WEST	00.4			1005			12					
L: CORRIDOR WEST	20 A	IP	13	1005								
. NORTH CORRIDOR	00.4				205		14					
L: NORTH CORRIDOR	20 A	IP	15		635		1.0					
L AUGUT LIGHTO	00.4					400	16					
L: NIGHT LIGHTS	20 A	IP	17			430	1.0					
			10				18					
			19				20					
			0.1				20					
			21				20					
			22				22					
			23				24					
			25				24					
			25				26					
							26					
			27				28					
			29				20					
			20				30	_ 				
								\	L =	7,061 \	/Δ	
TOTAL CONNECTED LOAD P	ER PH	ASE	:	2990	2077	1994						
				_	, .			19.	.6	AMPS		

 Δ - DENOTES CIRCUIT TO BE CONTROLLED BY LIGHTING RELAY PANEL.

PANEL SCHEULE: "(ЭР"					LOC	ATION:	IT/	ELE	CTRIC	CAL 146	C.B. RA	ATING: 22 kAI
VOLT: 208/120V, 3Ø, 4W	MAIN	S: 1	25 .	А МСВ		MOU	NTING:	SUF	RFA	CE		TYPE:	BOLT-ON
REMARKS: NEW PANEL.	-											!	
					V.	Α.	i				·		
USE AND/OR AREA SERVED	C/E	3	CIR. NO.	Α	E	3	С	CIR. NO.	(C/B	USE ANI	D/OR AF	REA SERVED
R: IT/ELECTRICAL 146	20 A	ΙP	1	800									
				800				2	ΙP	20 A	R: IT 13	5	
R: IT/ELECTRICAL 146	20 A	ΙP	3		80	00							
					80	00		4	IР	20 A	R: IT 13	5	
			5				2912						
M: DFSS-146	35 A	2P					2600	6					
			7	2912					2P	35 A	M: DFSS	5-135	
D. ITIELECTRICAL LAC	00.			2600	. –	00		8					
R: IT/ELECTRICAL 146	20 A		9		15	00		1.0					
D. IT/ELECTRICAL 1.40	20 A	 I D	1 1				1500	10					
R: IT/ELECTRICAL 146	20 A		11				1500	12					
			13					12					
			13					14					
			15					' -					
			1.5					16					
			17					'					
			· ·					18					
			19										
								20					
			21										
								22					
			23										
								24					
			25										
								26					
			27										
								28					
			29										
								30					
TOTAL CONNECTED LOAD	PER PH	ASF	<u>. </u>	7112	31	00	7012	L TC	ΣΤΑ	L =	17,224	VA	
	、 , , , , ,			, _			'	2	17.8	3۱	AMPS		

SPARE CIRCUIT BREAKER NOTE:

PROVIDE A MINIMUM OF (6) SPARE 20A- I P CIRCUIT BREAKERS IN NEW ELECTRICAL PANELS.

ARCHITECT OF RECORD

DEMONICA KEMPER ARCHITECTS

125 N. HALSTED STREET, SUITE 301

CHICAGO, IL 60661

P: 312.496.0000

MEP-FP-T-ENGINEERS

20/10 ENGINEERING GROUP, LLC

1216 TOWER ROAD

SCHAUMBURG,IL 60173

P: 847.882.2010 F: 847.882.2201

CIVIL ENGINEERS

HRG GREEN

1391 CORPORATE DRIVE, SUITE

203 MCHENRY, IL 60050

P:815.385.1778 F:815.385.1781

NRY COUNTY COL

KEY PLAN:

SHEET STATUS: 9.19.23
ISSUED FOR BIDS

NO: DESCRIPTION: DATE:

ELECTRICAL SCHEDULES

SHEET NUMBER:

PANEL SCHEULE: "J	2"				L	_OC/	ATION:	ELE	CTR	CICAL	202	C.B. RA	TING: 22 kAIC
VOLT: 208/120V, 3Ø, 4W	MAIN	S: 4	100	А МСВ	N	MOU	NTING:	SUF	RFA	CE		TYPE:	BOLT-ON
REMARKS: NEW PANEL.													
	_				V.A	٩.					i		
USE AND/OR AREA SERVED	C/E	3	CIR. NO.	Α	В		С	CIR. NO.	(C/B	USE AN	D/OR AR	EA SERVED
	100			2894 17785				2					
"LP-2"	100 A	3P	3		231	13				225			
					168	10		4	3P	A	"PP-3"		
			5				1396						
							18826	6					
			7										
								8					
			9					10					
			11					10					
			1 1					12					
			13					12					
			-					14					
			15										
								16					
			17										
								18					
			19										
								20					
			21										
								22					
			23										
			0.5					24					
			25					0.0					
			27					26					
			27					28					
			29					20					
								30					
			31					-					
			- *					32					
			33										
								34					
			35										
								36					
			37										
			_					38					
			39										
			4.					40					
			41					40					
								42			60.000)	
TOTAL CONNECTED LOAD P	ER PH	ASE	<u>:</u> :	20679	191	23	20221	\vdash	۱Α -	L = _	60,009	VA	
									<u>66.</u>	57	AMPS		

PANEL SCHEULE: "F	P-3"			LOCA	ATION:	ELE	CTR	CICAL	202	C.B. RATING: 22 kAIC
VOLT: 208/120V, 3Ø, 4W	MAINS: 2	225	A MLO	MOU	NTING:	SUF	RFA	CE		TYPE: BOLT-ON
REMARKS: NEW PANEL.	•					1				
USE AND/OR AREA SERVED	C/B	CIR.	Α	V.A. B	С	CIR.		 C/B	USE AND	D/OR AREA SERVED
R: OFFICE 108	20 A I P	NO.	900			NO.				
R: OFFICE 109	20 A I P	3	720	900		2	1P	20 A	R: CONF	107
				540		4	ΙP	20 A	R: CONF	107
R: OFFICE O	20 A I P	5			900	6	 IP	20 A	R: CONF	: 106
R: OFFICE 2	20 A I P	7	900 720			8	 IP	20 A	R: CONF	: 106
R: OFFICE 3	20 A I P	9	, 20	900						
R: OFFICE 4	20 A I P	11		900	900					SROOM 125
R: OFFICE 5	20 A I P	13	900		1080					SROOM 125
R: OFFICE 6	20 A I P	15	675	900		14	1P 	20 A	R: CLAS	SROOM 125
R: OFFICE 7	20 A I P	17		600	900	16	IP	20 A	R: WORK	(131 (COPIER)
					1800	18	ΙP	20 A	R: WORK	(131 (COPIER)
R: OFFICE 8	20 A I P	19	900			20	 1P	20 A	R: CLAS	5ROOM 130
R: OFFICE 9	20 A I P	21		900		22	 IP	20 A	R: CLAS	SROOM 130
R: OFFICE 20	20 A I P	23			900					
R: OFFICE 2	20 A I P	25	900		675					SROOM 130
R: OFFICE 22	20 A I P	27	540	900		26	1P 	20 A	R: IT 13	5
R: LIBRARY I 23	20 A I P	29		180	720	28	1P	20 A	R: ROOF	TOP
R: LIBRARY 23 (COPIER)	20 A I P	31	1800		720	30	1P	20 A	R: CONF	136
			540	900		32	ΙP	20 A	R: CONF	136
R: OFFICE 24	20 A IP			540		34	IP	20 A	R: NURS	ING SIM 134
R: OFFICE 26	20 A IP	35			900	36	 IP	20 A	R: NURS	ING SIM 134
R: OFFICE 28	20 A I P	37	900 720							ING SIM 134
R: OFFICE 29	20 A I P	39	720	900						
R: OFFICE 133	20 A I P	41		540	900					ING SIM 138
R: CORRIDOR	20 A I P	43	720		1080	42	1P 	20 A	R: NURS	ING SIM 138
R: CORRIDOR	20 A I P	45	720	1260		44	1P 	20 A	R: NURS	ING SIM 138
				720	1000	46	ΙP	20 A	R: CORR	RIDOR COO4
M: EWH-201	20 A 2P	47			1000	48				
		49	1000			50				
NA 51441 000	00 4 05	51		1000						
M: EWH-203	20 A 2P	53			1000	52				
		55	1000			54				
M: EWH-COO I	20 A 2P)	1000	1000		56				
		57		1000		58				
M: EFT-136	20 A IP	59			1500	60				
		61	829							
M: VP-I	15 A 3P	63		829		62				
		65			829	64				
		67	1321			66				
			1061			68				
M: AC-I	20 A 3P	69		1321		70				
		71			1321	72				
		73								
		75				74				
		77				76				
		79				78				
						80				
		81				82				
		83				84		_		
TOTAL CONNECTED LOAD		<u>-</u>	17785	16810	18826	TC			-	VA
. J. AL JOHNLOILD LOAD		·	.,,05		. 5526	1.	48.	24	AMPS	

PANEL SCHEULE: "A	12				ATION:				202	C.D. H	ATING: 22 k/
VOLT: 208/120V, 3Ø, 4W	MAINS: 4	100	A MCB	MOL	JNTING:	SUR	?FA	CE		TYPE:	BOLT-ON
REMARKS: NEW REPLACEMENT	NT PANEL.										
	1	CIR.		V.A.	1	CIR.					
USE AND/OR AREA SERVED	C/B	NO.	А	В	С	NO.	(C/B	USE ANI	D/OR AF	REA SERVED
		1	5524								
			5524			2					
M: RTU-I	50 A 3P	3		5524						•	
		_		5524	5504	4	32	50 A	M: RTU-	4	
		5			5524	6					
		7	5524		5524	6	- 1				
		'	5524			8					
M: RTU-2	50 A 3F	9	332-1	5524							
				5524		10	3P	50 A	M: RTU-	5	
		11			5524						
					5524	12					
		13	5524								
			5524			14					
M: RTU-3	50 A 3P	15		5524							
				5524		16	3P	50 A	M: RTU-	6	
		17			5524						
					5524	18					
		19									
		0.1				20					
		21				22					
		23									
		23				24					
		25				-					
						26					
		27									
						28					
		29					1				
						30					
		31									
		_				32					
		33									
		25				34					
		35				36					
		37				36					
		5/				38					
		39					- 1				
						40					
		41					- 1				
						42					
		_				TC	TA	L =	99,434	VA	
TOTAL CONNECTED LOAD F	PER PHASE	: :	33 45	33145	33145		27		AMPS		

PANEL SCHEULE: "I	_P-2"				LOC	ATION:	ELE	CTRICA	_ 202	C.B. RA	TING: 22 kAI
VOLT: 208/120V, 3Ø, 4W	MAIN	S: I	00 /	A MLO	MOI	JNTING:	SUR	RFACE		TYPE:	BOLT-ON
REMARKS: NEW PANEL.	•				•						
					V.A.						
USE AND/OR AREA SERVED	C/E	3	CIR. NO.	Α	В	С	CIR. NO.	C/B	USE AN	ID/OR AR	EA SERVED
L: CLASSROOM / SBDC	20 A	IР	I	1243							
							2				
L: NURSING/CLASSROOM	20 A		3		1049		4				
L: OFFICES	20 A	 . IP	5			829	4				
L. OTTICLS	20 A					029	6				
L: OFFICES	20 A	 . IP	7	785			0				
L. 01110L0	207		'	, 00			8				
L: OFFICES	20 A		9		710						
2. 0111020	207				7.0		10				
L: EAST/WEST CORRIDOR	20 A	IР	11			568					
							12				
L: NORTH/WEST CORRIDOR	20 A	IР	13	867							
							14				
L: NIGHT LIGHTS	20 A	ΙP	15		554						
							16				
			17								
							18				
			19								
							20				
			21								
							22				
			23								
							24				
			25								
			27				26				
			27				28				
			29				20				
			23				30				
)ΤΔ! —	6,604	\/Δ	
TOTAL CONNECTED LOAD	PER PH	ASE	<u>:</u> :	2894	2313	1396		8.33	6,604 AMPS	<u> </u>	

SPARE CIRCUIT BREAKER NOTE: PROVIDE A MINIMUM OF (6) SPARE 20A-1P CIRCUIT BREAKERS IN NEW ELECTRICAL PANELS.

ARCHITECT OF RECORD DEMONICA KEMPER ARCHITECTS 125 N. HALSTED STREET, SUITE 301 CHICAGO, IL 60661 P: 312.496.0000

MEP-FP-T-ENGINEERS 20/10 ENGINEERING GROUP, LLC **1216 TOWER ROAD** SCHAUMBURG,IL 60173 P: 847.882.2010 F: 847.882.2201

CIVIL ENGINEERS **HRG GREEN** 1391 CORPORATE DRIVE, SUITE 203 MCHENRY ,IL 60050 P:815.385.1778 F:815.385.1781


KEY PLAN:

SHEET STATUS: 9.19.23 **ISSUED FOR BIDS**

NO: DESCRIPTION: DATE: SHEET TITLE:

ELECTRICAL SCHEDULES

SHEET NUMBER:

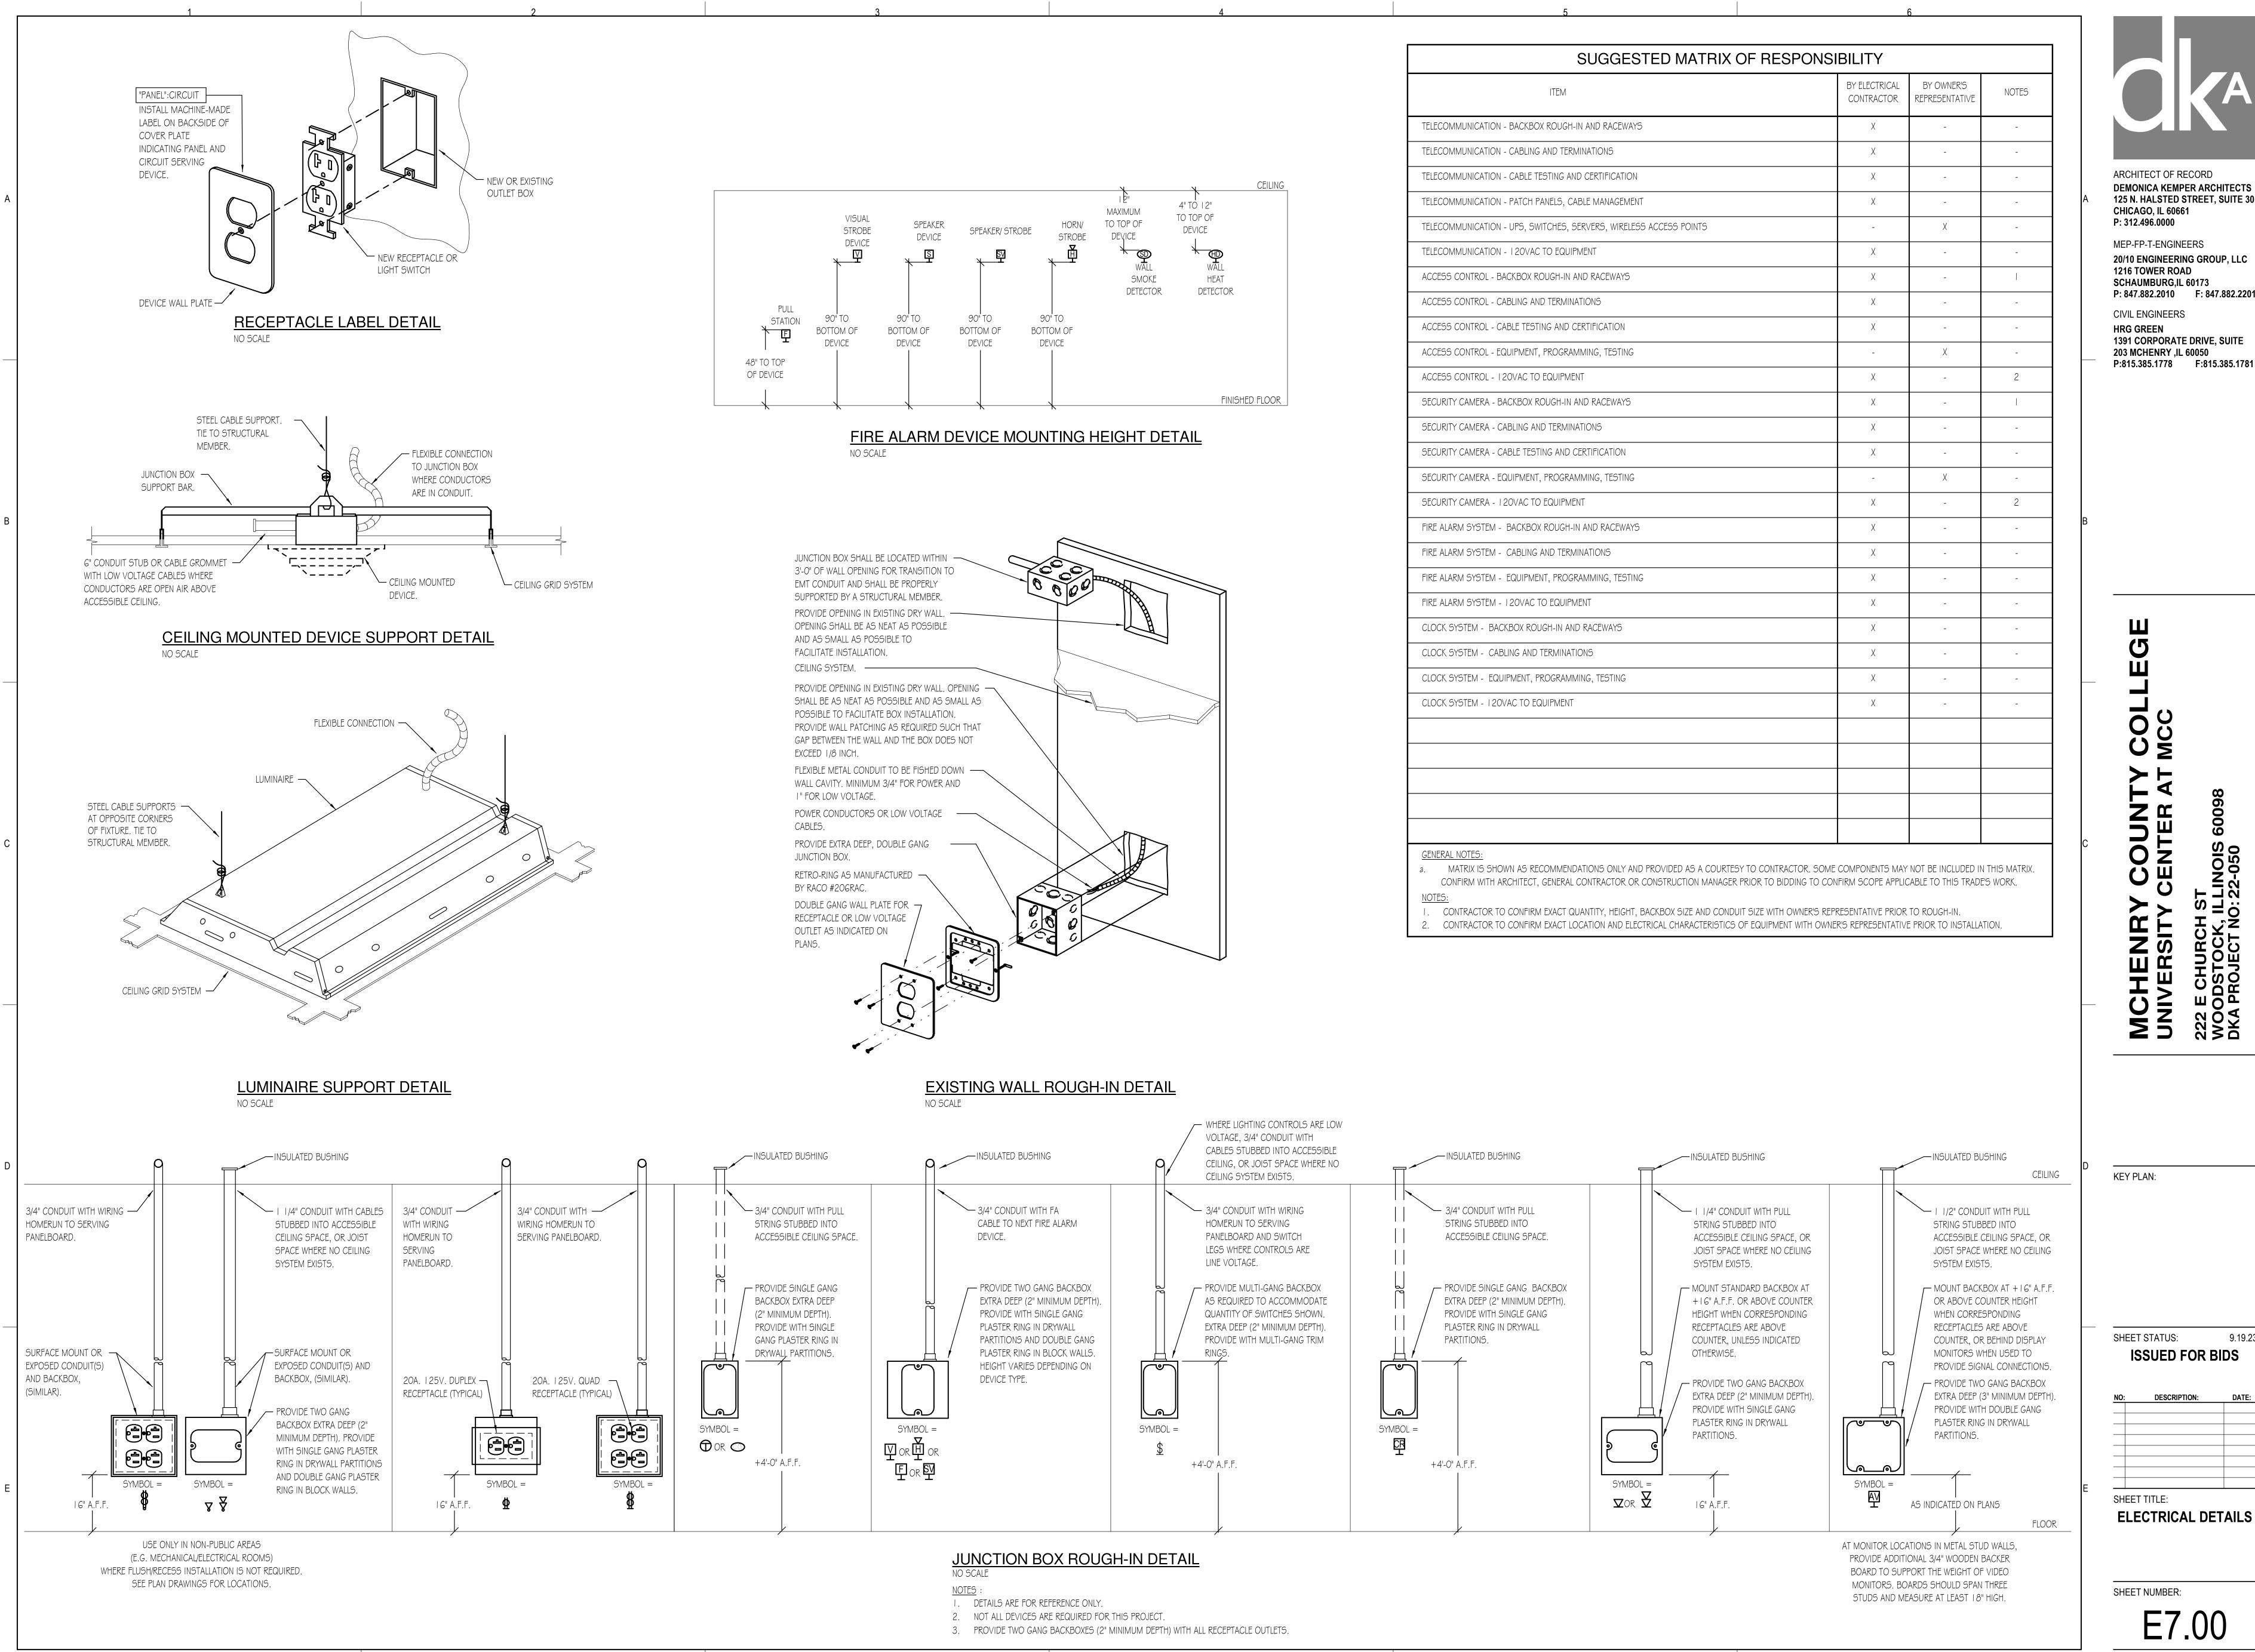

MEP-FP-T-ENGINEERS 20/10 ENGINEERING GROUP, LLC 1216 TOWER ROAD SCHAUMBURG,IL 60173 P: 847.882.2010 F: 847.882.2201

CIVIL ENGINEERS HRG GREEN 1391 CORPORATE DRIVE, SUITE 203 MCHENRY ,IL 60050


KEY PLAN:

9.19.23

NO: DESCRIPTION: DATE:

ELECTRICAL DETAILS

E7.00

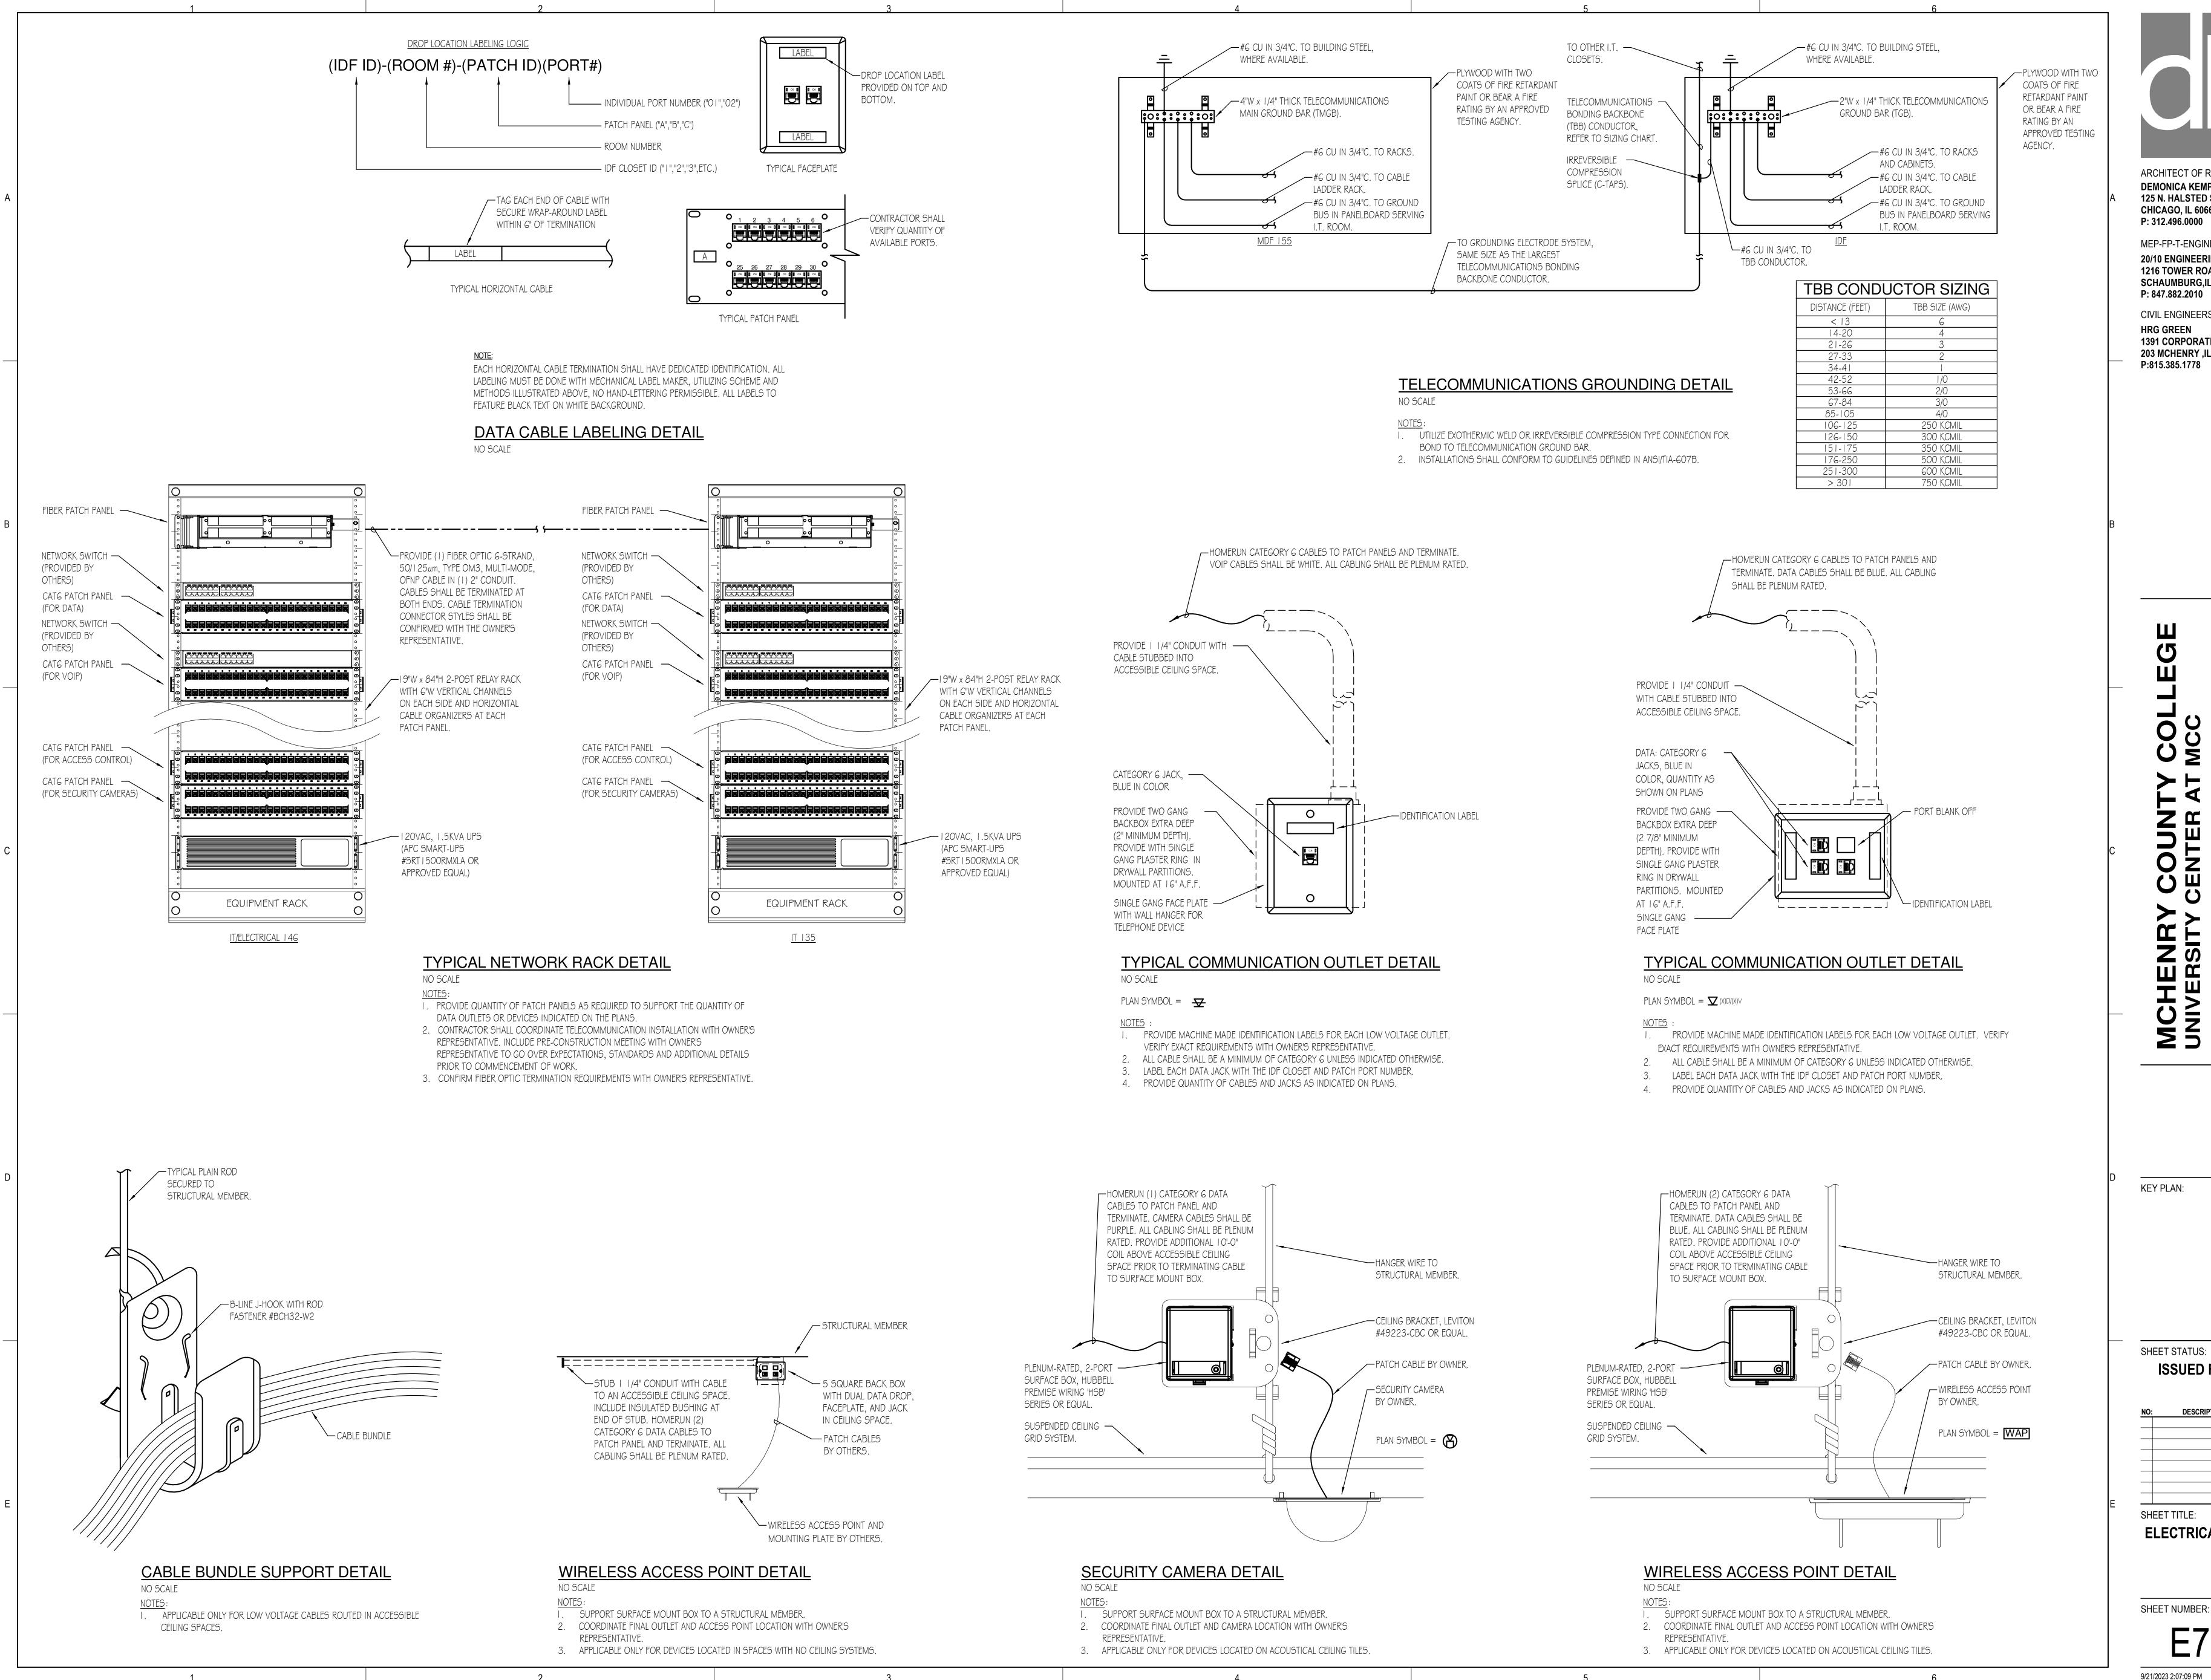

MEP-FP-T-ENGINEERS 20/10 ENGINEERING GROUP, LLC **1216 TOWER ROAD** SCHAUMBURG,IL 60173 P: 847.882.2010 F: 847.882.2201

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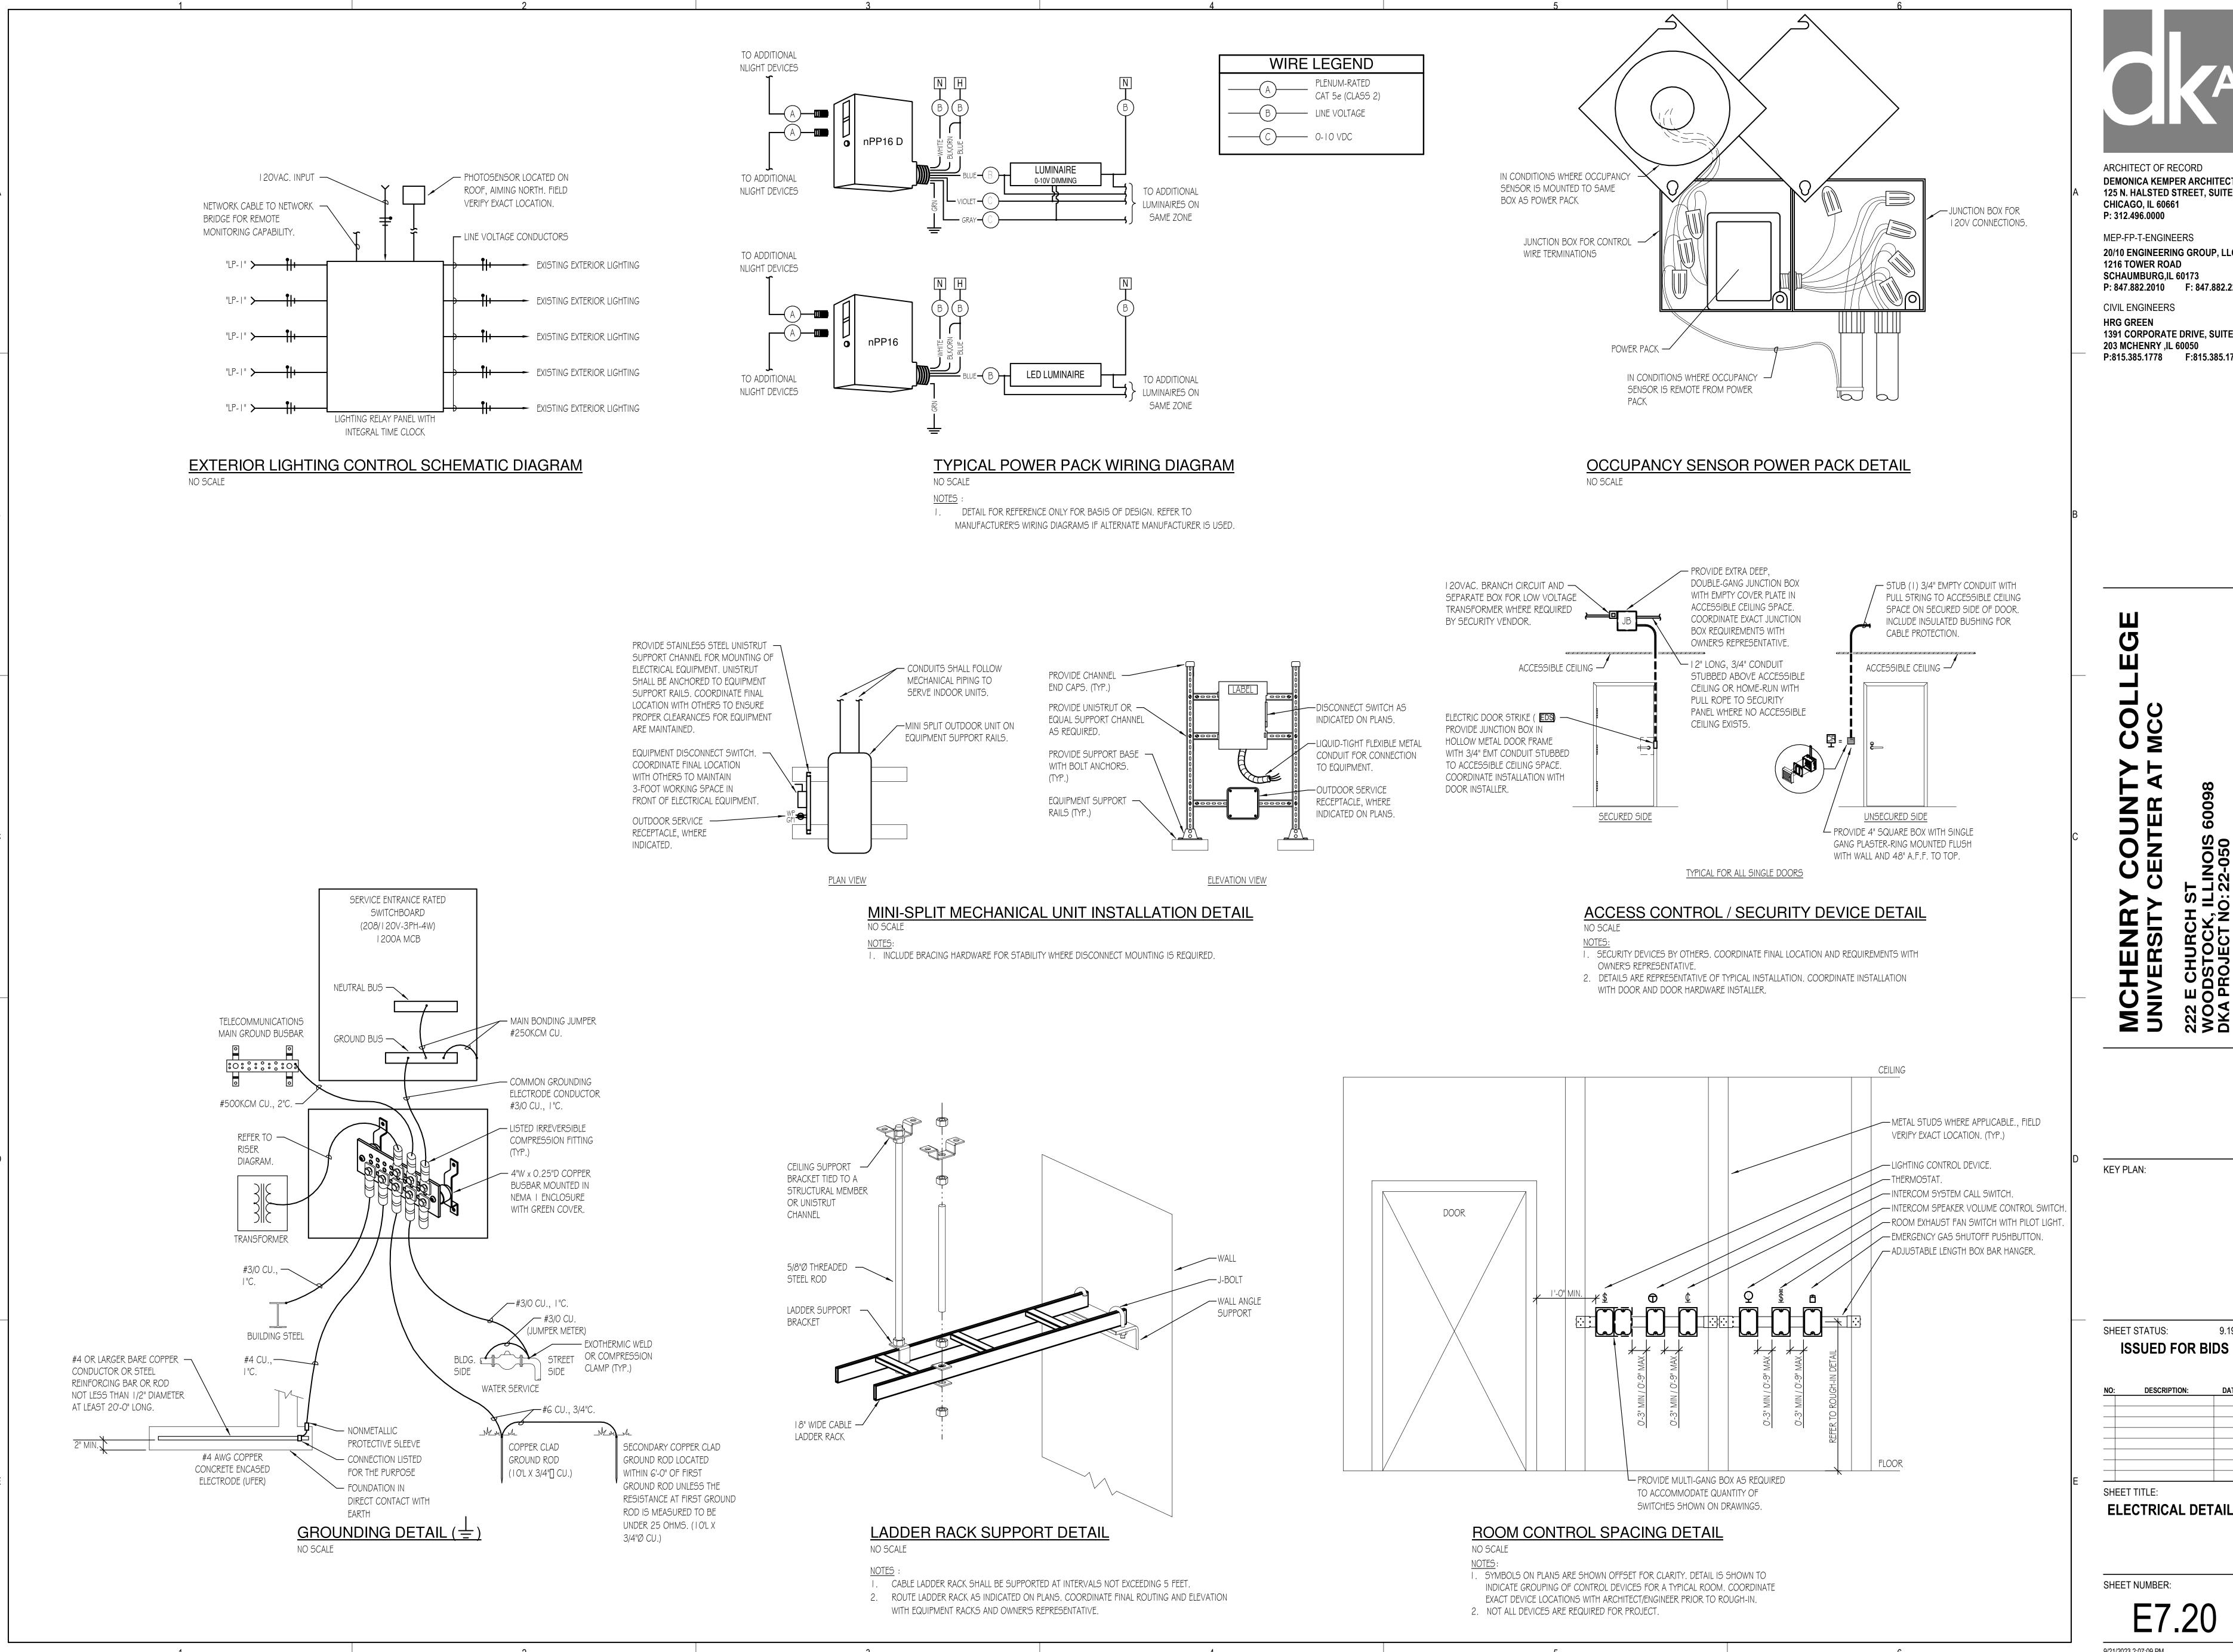
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9.19.23 **ISSUED FOR BIDS**

NO: DESCRIPTION: DATE:

ELECTRICAL DETAILS

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MEP-FP-T-ENGINEERS 20/10 ENGINEERING GROUP, LLC 1216 TOWER ROAD SCHAUMBURG,IL 60173 P: 847.882.2010 F: 847.882.2201

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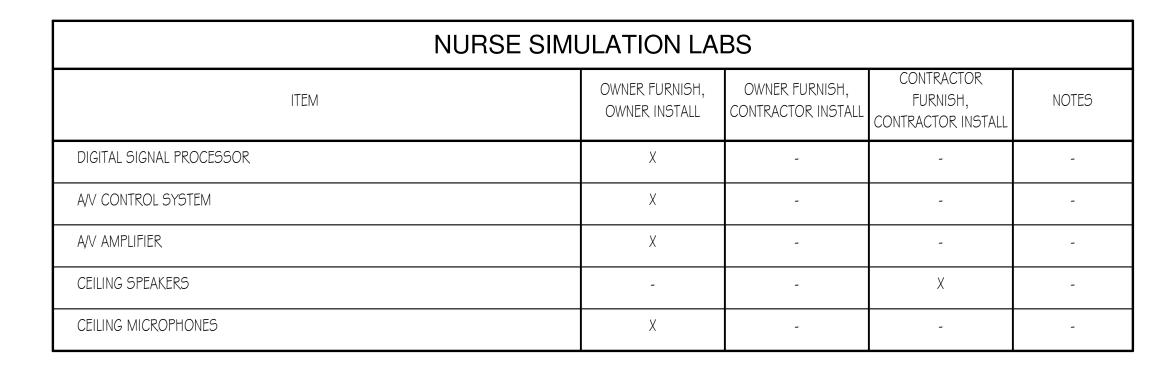
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9.19.23 SHEET STATUS:

NO: DESCRIPTION: DATE:

SHEET TITLE: **ELECTRICAL DETAILS**

SHEET NUMBER:



STUDY ROOMS / STUDENT LOUNGE / CONFERENCE ROOMS				
ITEM	OWNER FURNISH, OWNER INSTALL	OWNER FURNISH, CONTRACTOR INSTALL	CONTRACTOR FURNISH, CONTRACTOR INSTALL	NOTES
DISPLAY MONITORS	X	-	-	-
WEBCAM AND MICROPHONE	Х	-	-	-


IT EQU	JIPMENT			
ITEM	OWNER FURNISH, OWNER INSTALL	OWNER FURNISH, CONTRACTOR INSTALL	CONTRACTOR FURNISH, CONTRACTOR INSTALL	NOTES
IT RACK	-	-	X	-
UPS	-	-	X	-
CATG PATCH PANELS	-	-	X	-
FIBER PATCH PANELS	Х	-	-	-
NETWORK SWITCHES	X	-	-	-
WIRELESS ACCESS POINT	X	-	-	-

ACCESS CONTROL / SECURITY EQUIPMENT					
ITEM	OWNER FURNISH, OWNER INSTALL	OWNER FURNISH, CONTRACTOR INSTALL	CONTRACTOR FURNISH, CONTRACTOR INSTALL	NOTES	
CAMERAS	X	-	-	-	
CARD READERS	Х	-	-	-	
HEAD-END EQUIPMENT	Х	-	-	-	

STANDARD CLASSROOM A/V EQUIPMENT				
ITEM	OWNER FURNISH, OWNER INSTALL	OWNER FURNISH, CONTRACTOR INSTALL	CONTRACTOR FURNISH, CONTRACTOR INSTALL	NOTES
DESKTOP AIO COMPUTER	Х	-	-	-
DOCUMENT CAMERA	Х	-	-	-
AV SWITCHER (KRAMER 6 I DT)	Х	-	-	-
CEILING SPEAKERS	-	-	Х	-
PROJECTOR (EPSON 530)	-	Х	-	-
PROJECTOR SCREEN (DALITE MODEL B)	-	-	Х	-
A/V AMPLIFIER (CABLES2GO #40881)	Х	-	-	-

ROUND CLASSROOM 102					
ITEM	OWNER FURNISH, OWNER INSTALL	OWNER FURNISH, CONTRACTOR INSTALL	CONTRACTOR FURNISH, CONTRACTOR INSTALL	NOTES	
DESKTOP AIO COMPUTER	Х	-	-	-	
DOCUMENT CAMERA	Х	-	-	-	
A/V SWITCHER (KRAMER G I I DT)	Х	-	-	-	
CEILING SPEAKERS	-	-	Х	-	
75" DISPLAY MONITORS	Х	-	-	-	
CEILING CAMERA	Х	-	-	-	

CONFERENCE ROOMS 105A & 150B					
ITEM	OWNER FURNISH, OWNER INSTALL	OWNER FURNISH, CONTRACTOR INSTALL	CONTRACTOR FURNISH, CONTRACTOR INSTALL	NOTES	
DIGITAL SIGNAL PROCESSOR	Х	-	-	-	
AV CONTROL SYSTEM	Х	-	-	-	
AV INPUT DEVICE	Х	-	-	-	
A/V TOUCH SCREEN CONTROL	Х	-	-	-	
CEILING SPEAKERS	-	-	Х	-	
CEILING MICROPHONES	X	-	-	-	
PROJECTOR (EPSON 530)	-	Х	-	-	
PROJECTOR SCREEN (DALITE MODEL B)	-	-	X	-	

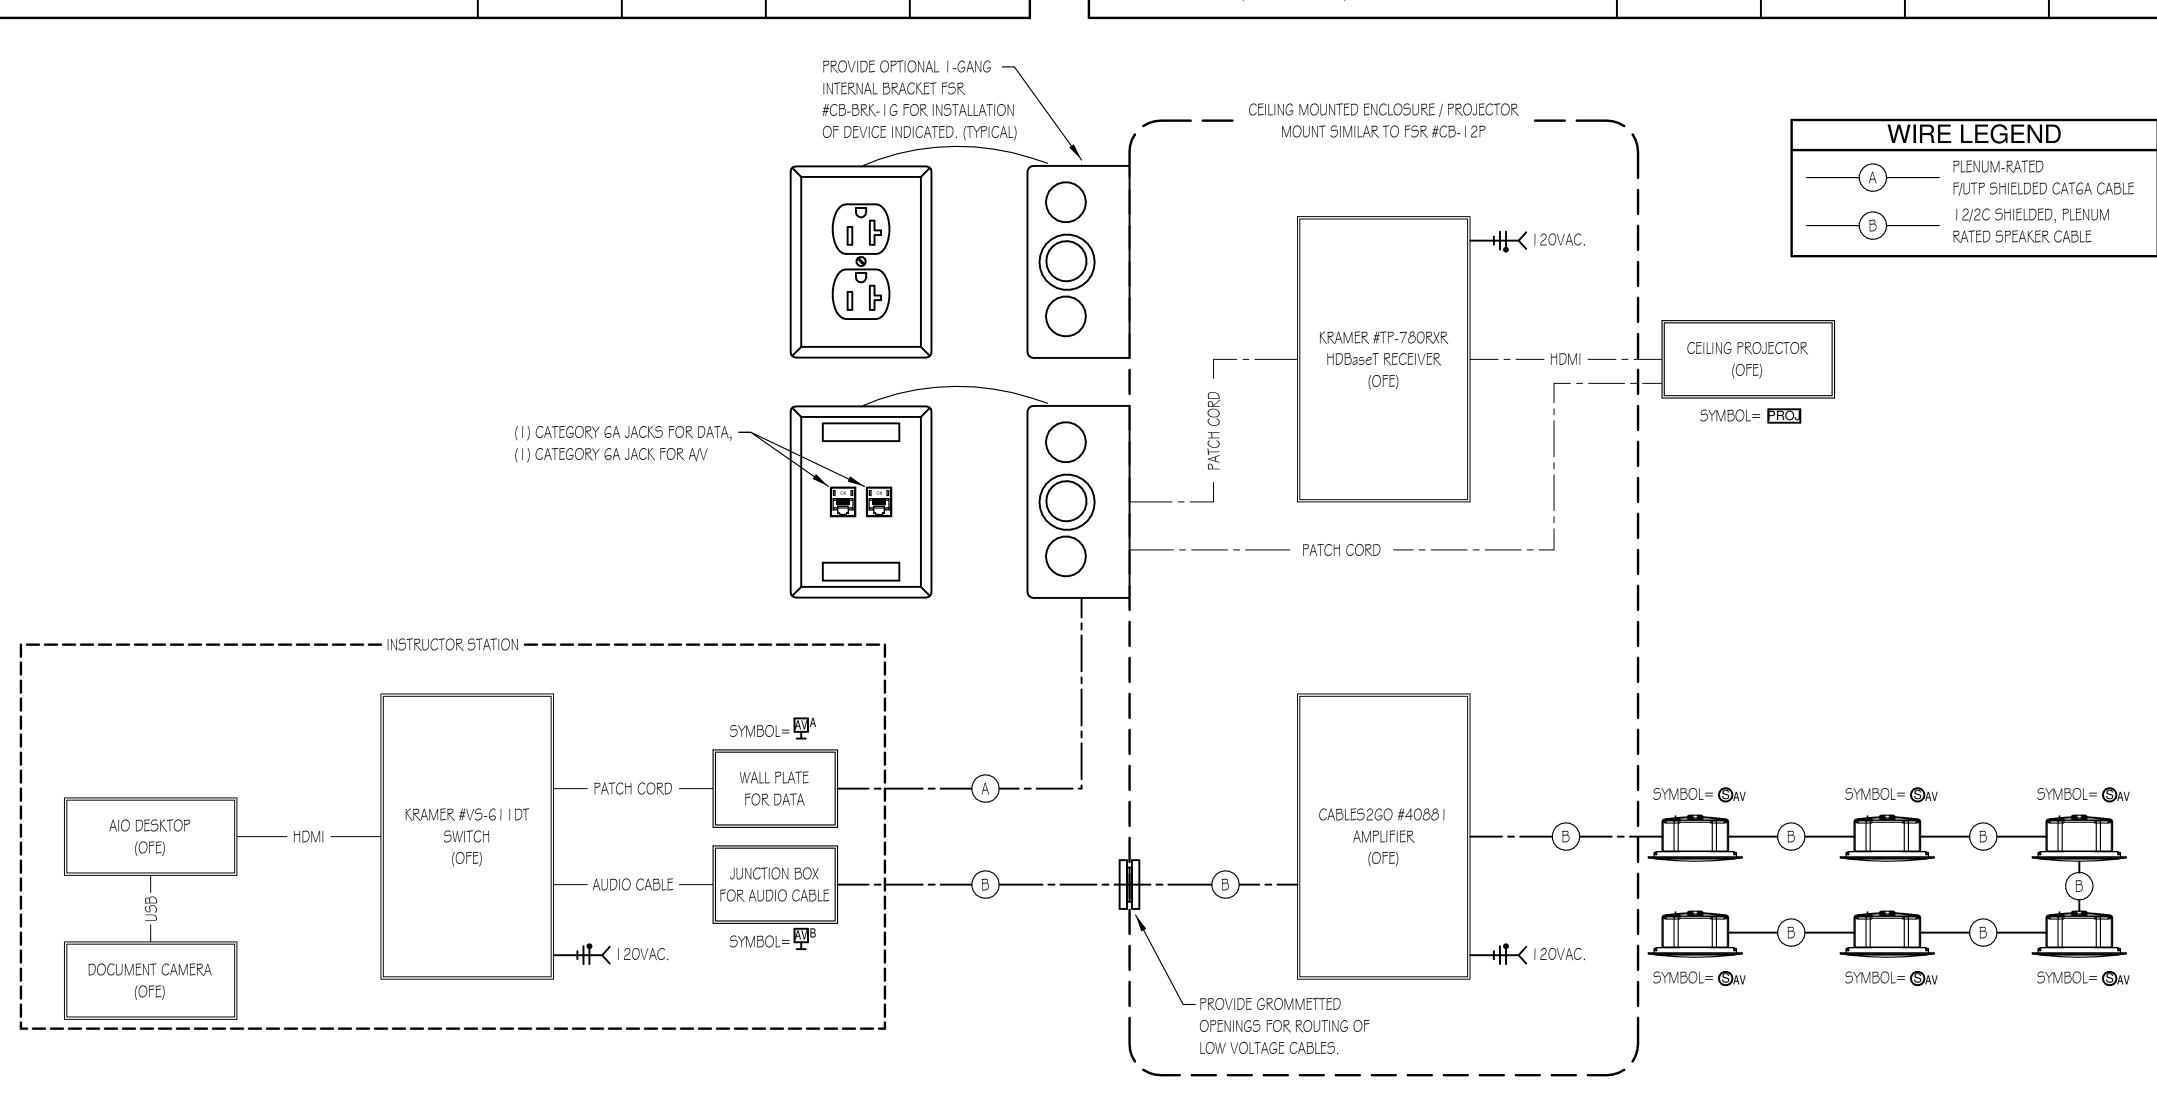



MEP-FP-T-ENGINEERS 20/10 ENGINEERING GROUP, LLC 1216 TOWER ROAD SCHAUMBURG,IL 60173 P: 847.882.2010 F: 847.882.2201

CIVIL ENGINEERS **HRG GREEN** 1391 CORPORATE DRIVE, SUITE

203 MCHENRY ,IL 60050 P:815.385.1778 F:815.385.1781

KEY PLAN:

SHEET STATUS: 9.19.23 **ISSUED FOR BIDS**

NO: DESCRIPTION: DATE: SHEET TITLE:

ELECTRICAL DETAILS


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I. ALL LOW VOLTAGE CABLES SHALL BE PLENUM-RATED.

2. 'OFE' DENOTES OWNER FURNISHED EQUIPMENT.


CLASSROOMS A/V SCHEMATIC DIAGRAM



A/V TRANSMITTER OUTLET DETAIL NO SCALE

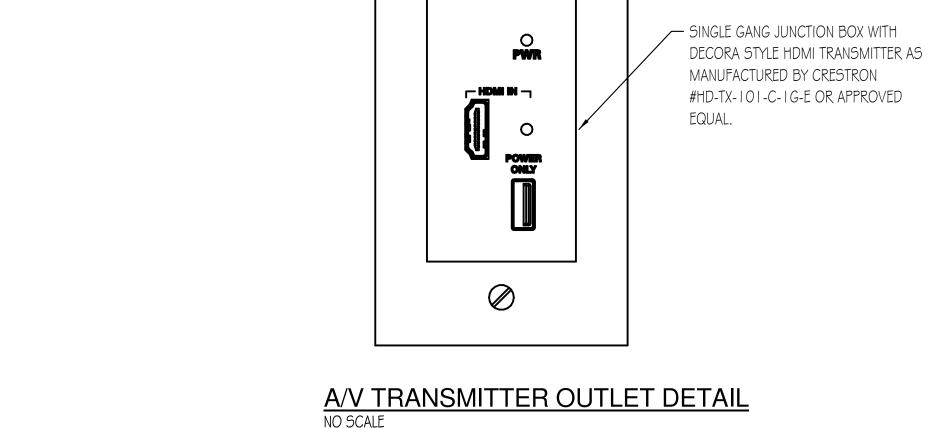- STUB (I) I" CONDUIT WITH (I) PLNEUM-RATED, F/UTP SHIELDED CAT6A CABLE TO 'AV-D' OUTLET.

PLAN SYMBOL = AYD

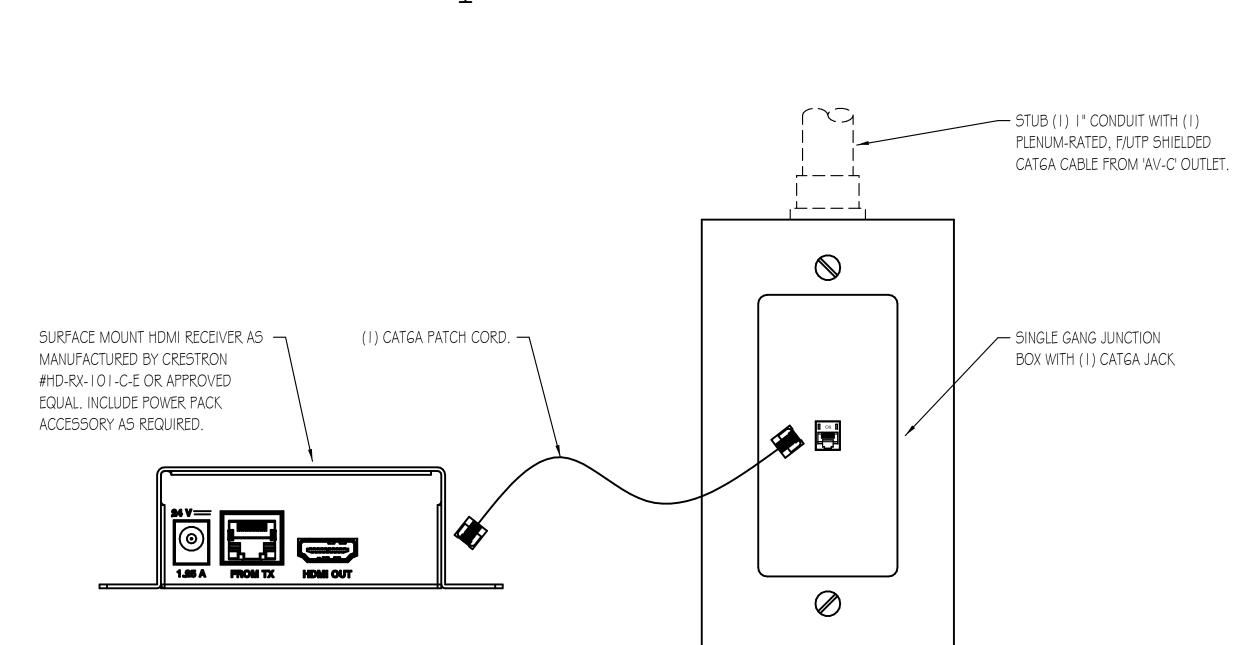

A/V RECEIVER OUTLET DETAIL NO SCALE

PLAN SYMBOL = AVC

PLAN SYMBOL = Φ COMPARTMENT I DEVICE BRACKET DETAIL COMPARTMENT I TOP VIEW COMPARTMENT 3 JACKS AND A.

CABLES.

INTERNAL DEVICE

MOUNTING BRACKET TO

ACCEPT COMMUNICATION

JACKS. INTERNAL DEVICE MOUNTING — BRACKET TO ACCEPT AUDIO/VISUAL OUTLET. COMPARTMENT 3 DEVICE BRACKET DETAIL PLAN SYMBOL = Φ IN-GRADE FLOOR BOX DEVICE DETAIL

NO SCALE PLAN SYMBOL = $\frac{\mathbf{\Phi}}{\mathbf{\Delta}}$



ARCHITECT OF RECORD

DEMONICA KEMPER ARCHITECTS

125 N. HALSTED STREET, SUITE 301

CHICAGO, IL 60661

P: 312.496.0000

MEP-FP-T-ENGINEERS

20/10 ENGINEERING GROUP, LLC

1216 TOWER ROAD

SCHAUMBURG,IL 60173

P: 847.882.2010 F: 847.882.2201

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CIVIL ENGINEERS

HRG GREEN

1391 CORPORATE DRIVE, SUITE


203 MCHENRY ,IL 60050

P:815.385.1778 F:815.385.1781

MCHENRY COUNTY COLLEGE UNIVERSITY CENTER AT MCC

KEY PLAN:

SHEET STATUS: 9.19.23
ISSUED FOR BIDS

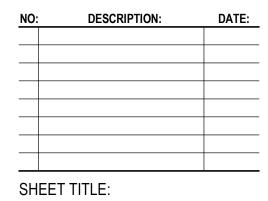

SHEET TITLE:
ELECTRICAL DETAILS

SHEET NUMBER:

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