## MCHENRY COUNTY COLLEGE

## VISITING TEAM CHANGING ROOMS

8900 US Hwy 14 Crystal Lake, IL 60012

DKA PROJECT NO: 22-006

OWNER BID NO: #230427

ISSUED FOR BID - NOT FOR CONSTRUCTION 04/28/2023



ARCHITECT

DEMONICA KEMPER ARCHITECTS 125 N. HALSTED ST., SUITE 301 CHICAGO, IL 60661 T: 312.496.0000 F: 312.496.0001 MEP-FP-T ENGINEER

20/10 ENGINEERING GROUP, LLC 1216 TOWER ROAD, SCHAUMBURG, IL 60173 P: 847.882.2010 F: 847.882.2201

### **ABBREVIATIONS**

CPT CT

CLR

CLO

CONC

CONN

CONST

CONT

CONTR

CNSK CRS

DEPT

DISP

DIV

DBL DS

DRW

DS

EIFS

**ELVTR** 

EP PT

**EXSTG** 

EXPD

FS

FUTR

GALV

GEN

GTC

GD

GND

EXP

CK

CARPET

CLEAR

CLOSET

COLUMN

CONCRETE

CORRIDOR

COURSE

COUNTERSUNK

DEPARTMENT

DEAD LOAD

DIAMETER

DIMENSION

DISPENSER

DOOR OPENING

DRINKING FOUNTAIN

DETECTABLE WARNING TILE

EXTERIOR INSULATION FINISH SYSTEM

ELECTRICAL TRADES CONTRACTOR

ELECTRICAL WATER COOLER

ELECTRICAL PANEL BOARD

DRY STANDPIPE

ELECTRICAL

ELEVATION **ELEVATION** 

**ELEVATOR** 

**ENCLOSURE** 

**EMERGENCY** 

**EPOXY PAINT** 

EXISTING

**EXTERIOR** 

**EXPANSION** 

**EXPANSION JOINT** 

FACE OF CONCRETE

FINISH OR FINISHED

FIRE EXTINGUISHER

FIRE HOSE CABINET

FIBERGLASS REINFORCED PANEL

FIRE EXTINGUISHER CABINET

FACE OF FINISH

FACE OF STUD

FIRE ALARM

FIREPROOF

FLOOR FLOOR DRAIN

FLAT BAR STOCK

**FLUORESCENT** 

FOOT OR FEET FOOTING

FOUNDATION

FRAMING

**FULL SIZE** 

**FURRING** 

**FUTURE** 

GALVANIZED

**GENERAL** 

GRADE

GROUND

GYPSUM BOARD

FABRIC WALLCOVERING

GENERAL CONTRACTOR

GLASS OR GLAZING

GENERAL TRADES CONTRACTOR

**EPOXY FLOORING** 

**EQUIPMENT** 

DIVISION

DOOR

DOUBLE DOWNSPOUT

DRAWER DRAWING

CONNECTION

CONSTRUCTION

CONSTRUCTION MANAGER

CONTINUOUS OR CONTINUE

CONTRACTOR

DEMOLISH OR DEMOLITION

**CERAMIC TILE** 

עוטטוע	LVIATIONS				
AP	ACCESS PANEL	HDW	HARDWARE	TEL	TELEPHONE
ACOUST	ACOUSTICAL	HDWD	HARDWOOD	TV	TELEVISION
ACT	ACOUSTICAL CEILING TILE	HDR	HEADER	TRZ	TERRAZZO
ADJ	ADJACENT	HTG	HEATING	TB	TILE BASE
A.F.F.	ABOVE FINISH FLOOR	HVAC	HEATING, VENTILATING, AIR CONDITIONING	THK	THICK
AGGR	AGGREGATE	HT	HEIGHT	T.O.C.	TOP OF CURB
A/C	AIR CONDITIONING	HC	HOLLOW CORE	TOP	TOP OF PAVEMENT
ALT	ALTERNATE	HM	HOLLOW METAL	TOW	TOP OF WALL
ALUM	ALUMINUM	HMF	HOLLOW METAL FRAME	T&G	TONGUE AND GROOVE
ALUIVI I	ANGLE	HORZ	HORIZONTAL	TYP	TYPICAL
APPD	APPROVED	HB	HOSE BIB	111	TITICAL
APPROX	APPROXIMATE	HR	HOUR	UNF	UNFINISHED
ARCH	ARCHITECTURAL OR ARCHITECT	TIIX	HOOK	U.N.O.	UNLESS NOTED OTHERWISE
ARCH AD	AREA DRAIN	INC	INCLUDE	UR.U.	URINAL
ASB	ASBESTOS	I.D.	INSIDE DIAMETER	UK	URINAL
ASB ASPH	ASPHALT	INSUL	INSULATION	VB	VINYL BASE
ASFII A/V	AUDIO VISUAL	INTR	INTERIOR	VERT	VERTICAL
A/ V	AUDIO VISUAL	INV	INVERT	VEST	VESTIBULE
DCMT	BASEMENT	IIVV	IINVERI		VINYL COMPOSITION TILE
BSMT		IANI	IANITOD	VCT	
BRG	BEARING	JAN	JANITOR	VW	VINYL WALLCOVERING
BM	BEAM	JT	JOINT	MOOT	WAINCOOT
BTW	BETWEEN	KIT	KITCHEN	WSCT	WAINSCOT
BITUM	BITUMINOUS	LAM	LAMINATE	WC	WATER CLOSET
BLK	BLOCK	LAV	LAVATORY	WLK	WALK-OFF MAT
BLKG	BLOCKING	LH	LEFT HAND	WR	WATER RESISTANT
BD	BOARD	LGTH	LENGTH	WT	WALL TILE OR WEIGHT
BRK	BRICK	LT	LIGHT	W	WEST
BLDG	BUILDING	LWC	LIGHT WEIGHT CONCRETE	W	WIDE FLANGE "W16x21"
0.15	0.1711	LTL	LINTEL	W	WIDTH
CAB	CABINET	LN	LINOLEUM	W/	WITH
CIP	CAST IN PLACE	LL	LIVE LOAD	W/O	WITHOUT
CIPC	CAST IN PLACE CONCRETE			WD	WOOD
CI	CURB INLET	MH	MANHOLE	WDP	WOOD PANEL
CB	CATCH BASIN	MFR	MANUFACTURER	X	EXISTING
CLG	CEILING	MAS	MASONRY		
CTR	CENTER	MO	MASONRY OPENING		
CJ	CONTROL JOINT	MTL	METAL		
CL	CENTER LINE	MAX	MAXIMUM		

MECHANICAL

**MEMBRANE** 

MARBLE TILE

MISCELLANEOUS

NOT IN CONTRACT NOT TO SCALE

MINIMUM

MOUNDED

MOUNTING

MULLION

NOMINAL NORTH

NUMBER

OBSCURE

ON CENTER

OPENING

**OPPOSITE** 

OVERALL

PAINTED

PAIR

**PANEL** 

ORIENTED STRAND BOARD

OUTSIDE DIAMETER

OVERFLOW DRAIN

PARTICLE BOARD

PLASTIC LAMINATE

PLYWOOD POUNDS PER SQUARE INCH

PRECAST CONCRETE

RAIN WATER LEADER

PLUMBING TRADES CONTRACTOR

PARTITION

PLASTIC

PRECAST

**RADIUS** 

REGISTER

REINFORCED

REQUIRED

RESILIENT

RETURN AIR

RIGHT HAND RIGHT OF WAY

ROOF DRAIN

**ROUGH OPENING** 

RUBBER BASE

RISER

ROOM

SECTION

SCHEDULE

SHEATHING

SHEET VINYL

SEALED CONCRETE

SPECIFICATION

STAINLESS STEEL

SINGLE PLY MEMBRANE

STRUCTURE OR STRUCTURAL

SUSPENDED ACOUSTICAL TILE

SPRAY APPLIED FIRE RESISTIVE MATERIAL

SHOWER

SIMILAR

SQUARE

STEEL

STORAGE

SUSPENDED

SYMMETRICAL

STANDARD STATION

SHEET

SINK

RETURN AIR GRILLE

**QUARRY TILE** 

REFRIGERATOR

OFFICE

MECHANICAL TRADES CONTRACTOR

MECH

MTC

MTD

MTG

NO OR #

OA

PBD

PTN

PLAS

PTC

RGTR

REINF

RQD

RB

SCHED

SPM

SFRM

STA


STL

STOR

SUSP

STRUCT

### STATE LOCATION MAP

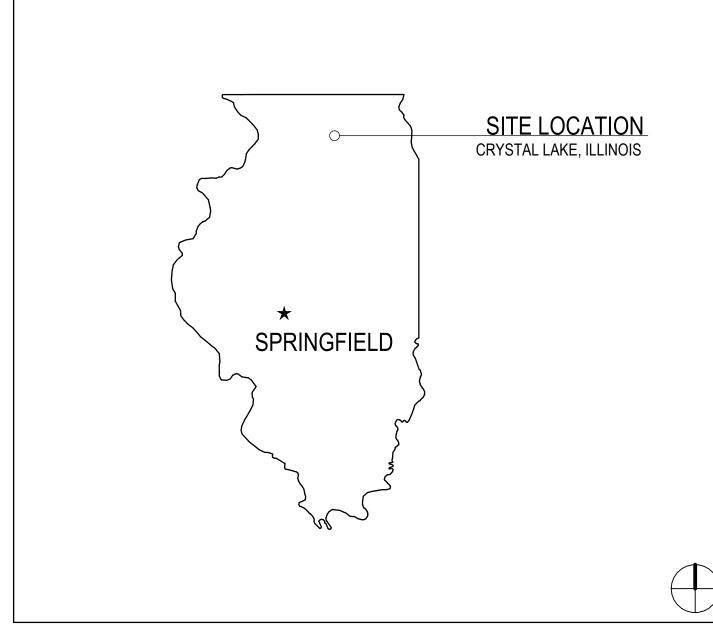

### SHEET INDEX

GENERAL	
G1.00	SHEET INDEX, ABBREVIATIONS, SYMBOLS & NOTES
ARCHITECTURAL	
AD1.10	DEMO PLAN & RCP
41.10	FLOOR PLAN & RCP
MECHANICAL	
ME1.10	MECHANICAL / ELECTRICAL / PLUMBING COORDINATION
HV1.10	HVAC PLANS - VISITING TEAM CHANGING ROOMS

FIRE PROTECTION FP1.10 FIRE PROTECTION PLANS

ELECTRICAL	
E1.10	ELECTRICAL PLANS
E2.00	ELECTRICAL SYMBOL LIST AND NOT
E3.00	ELECTRICAL DETAILS
E4.00	ELECTRICAL SPECIFICATIONS


ARCHITECT DEMONICA KEMPER ARCHITECTS 125 N. HALSTED STREET, SUITE 301 **CHICAGO, IL 60661** P: 312.496.0000

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# MCHENRY COUNTY C

KEY PLAN:


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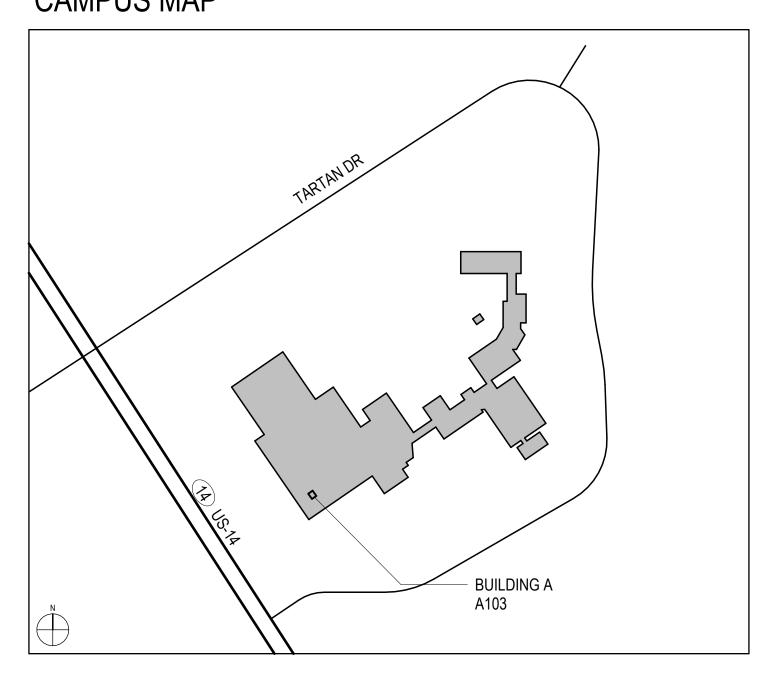
SHEET INDEX, ABBREVIATIONS, **SYMBOLS & NOTES** 


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### CAMPUS MAP

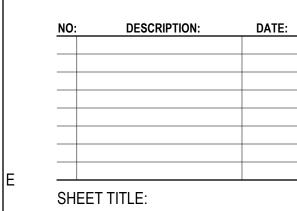




NOTE: IN THE EVENT OF A CONFLICT BETWEEN DIMENSIONS SHOWN ON

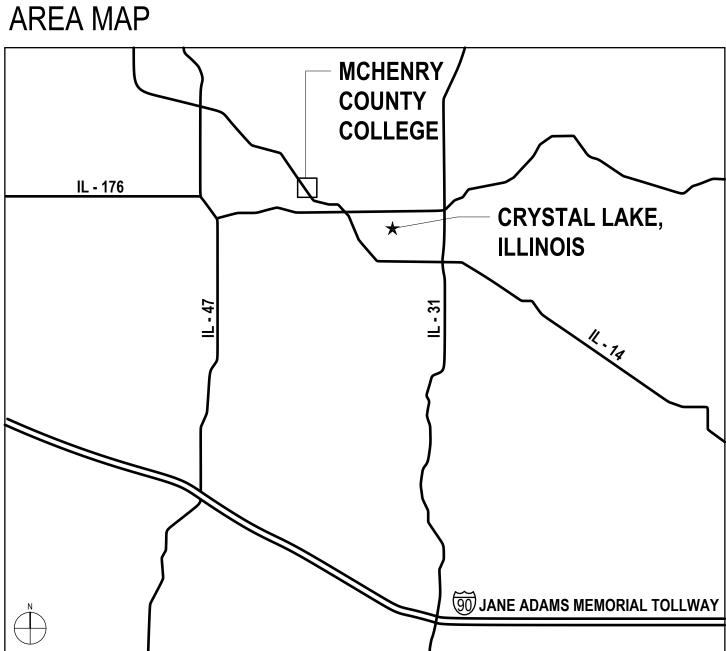THIS DRAWING AND ANY OTHER ARCHITECTURAL, ELECTRICAL, OR MECHANICAL

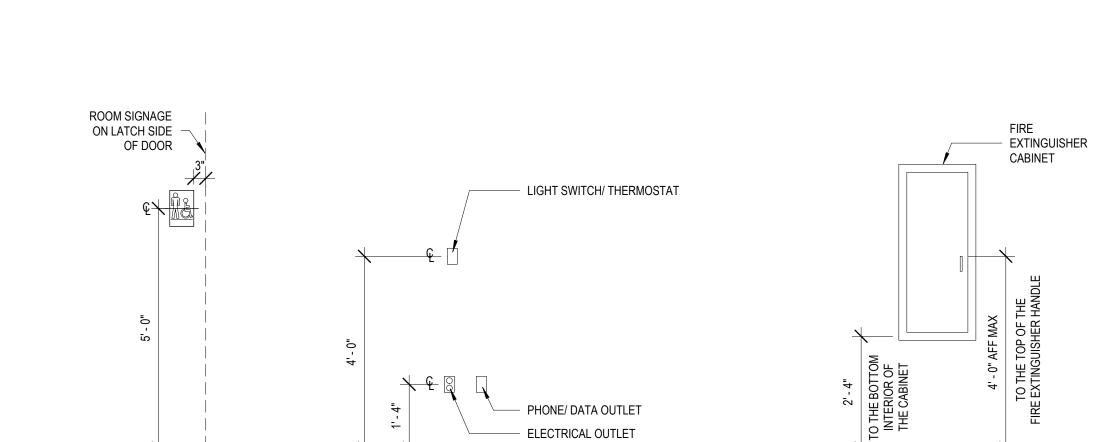SHEETS OR SPECIFICATIONS, NOTIFY ARCHITECT OF DISCREPANCY.

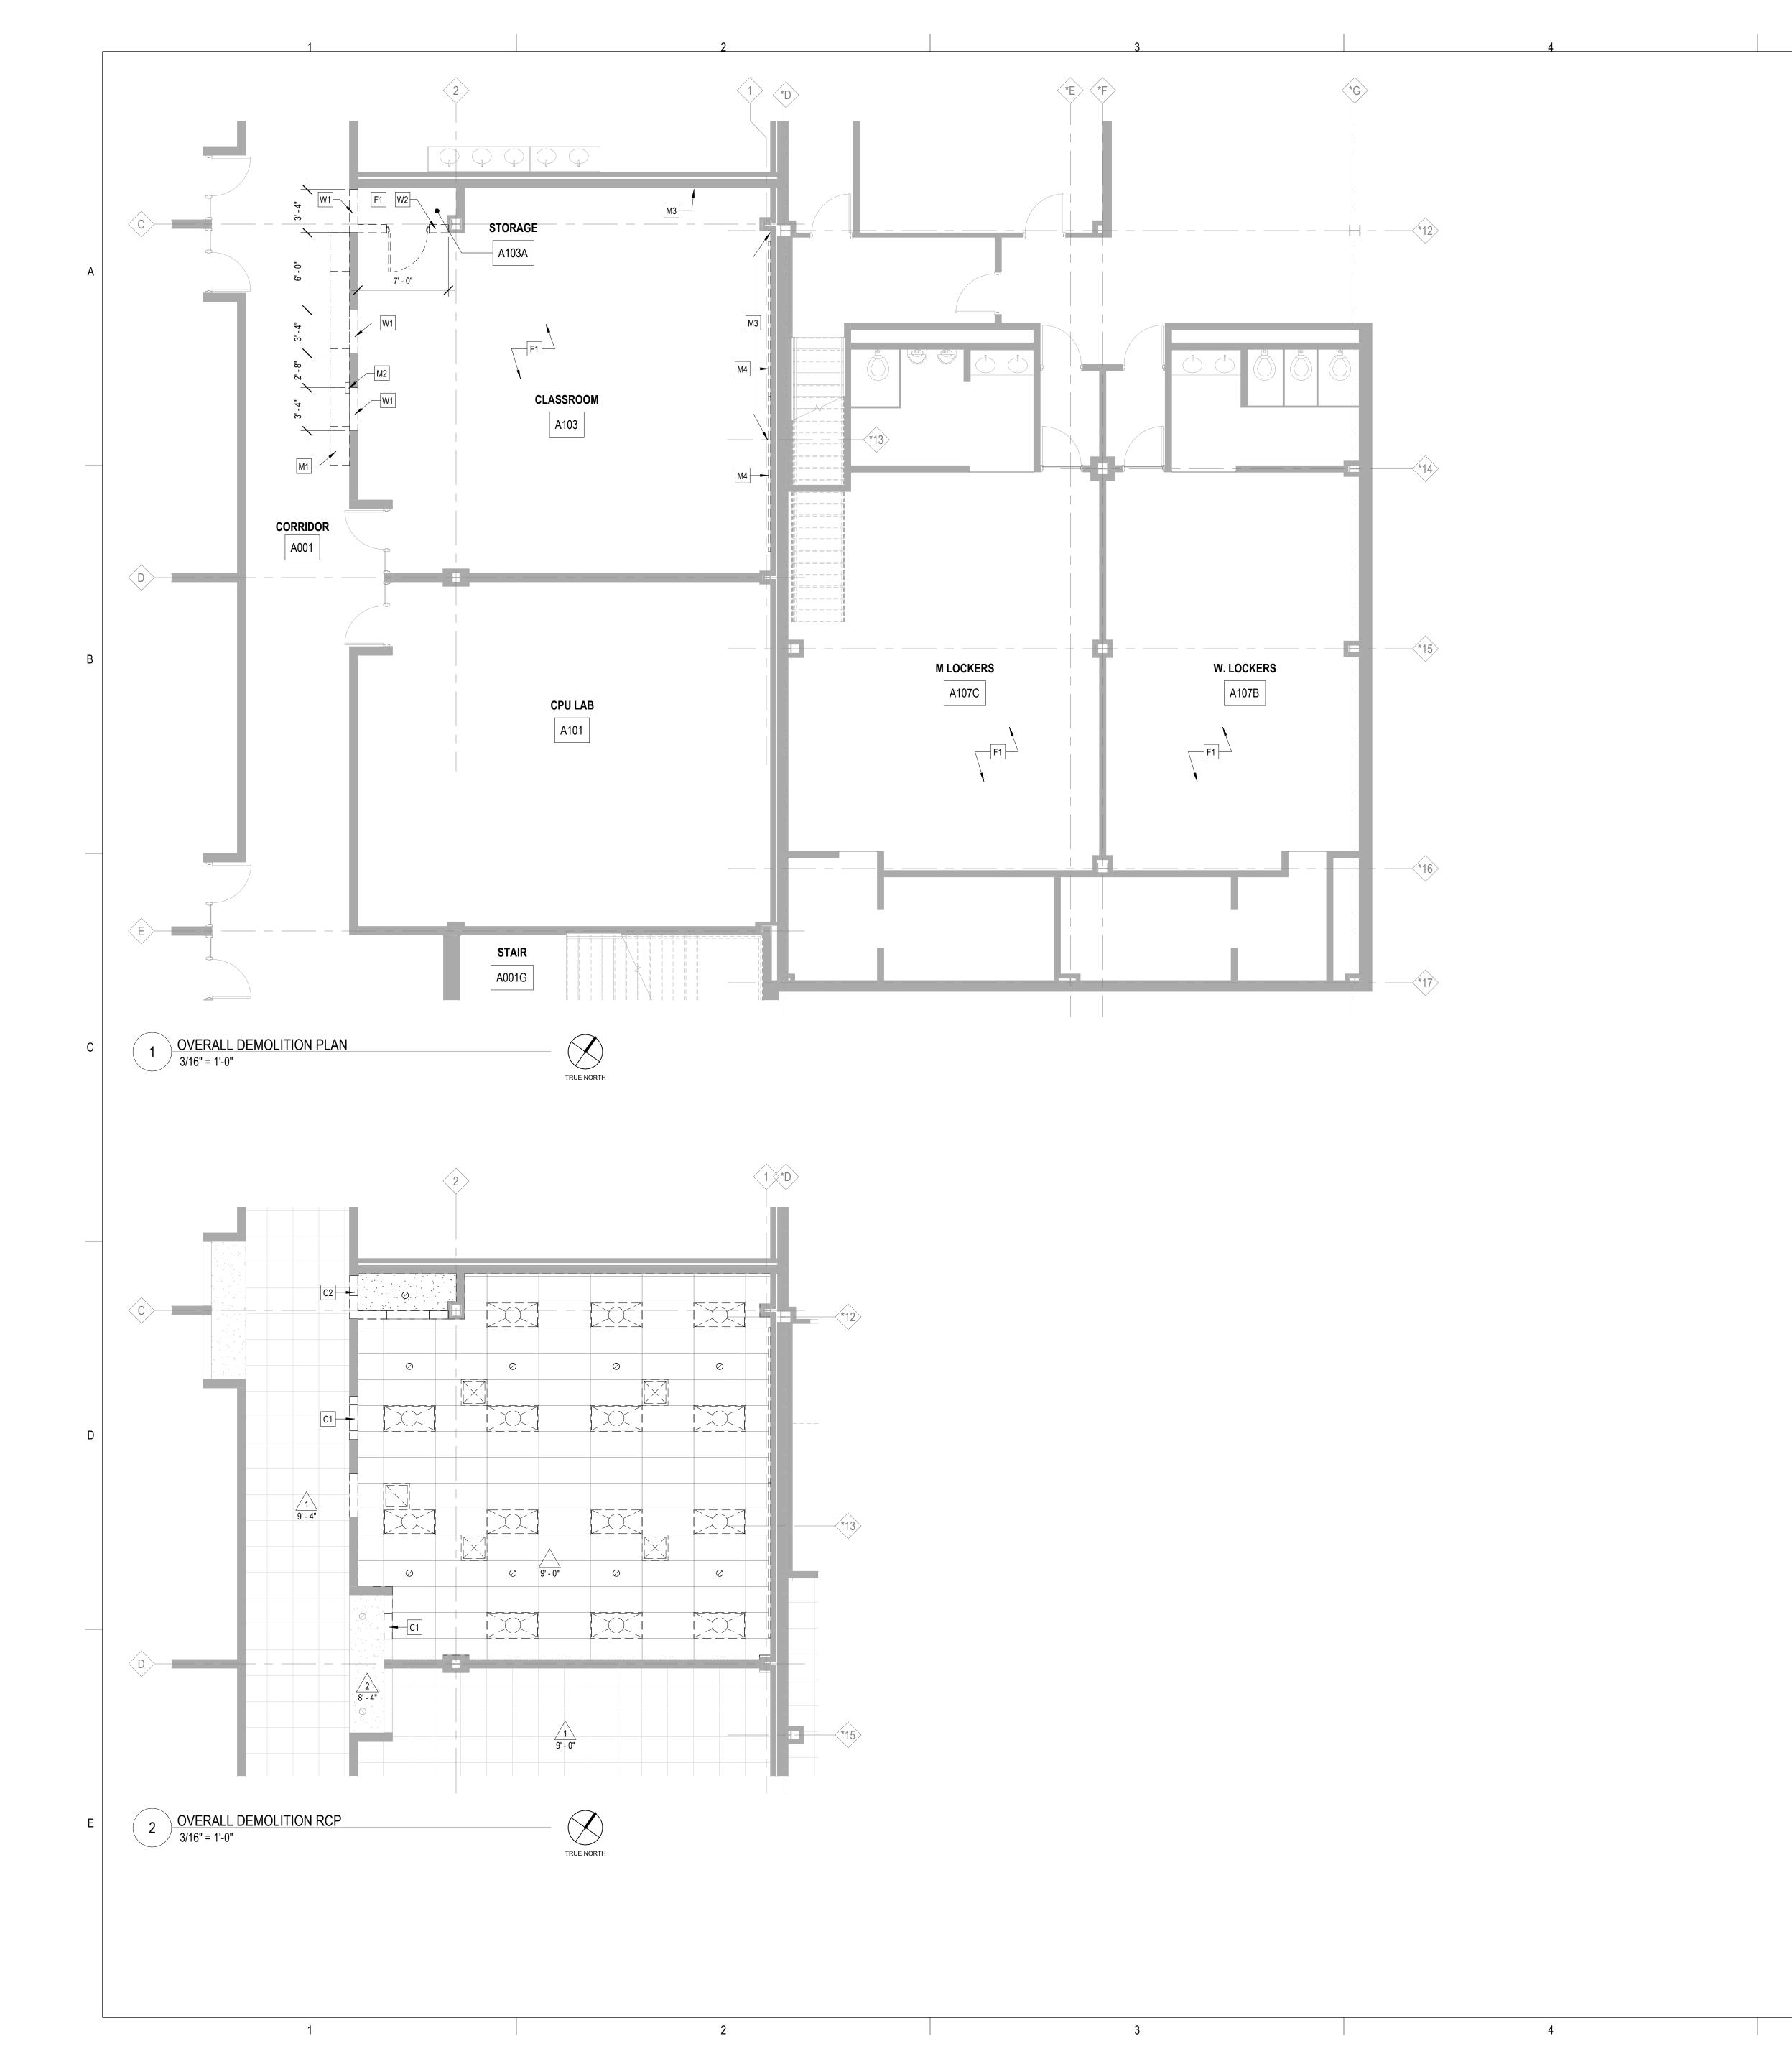

### DEMO SYMBOLS LEGEND:

NOTE: REFER TO M.E.P.F.P. DRAWINGS FOR ADDITIONAL INFORMATION ON MECHANICAL, ELECTRICAL, AND FIRE PROTECTION SYSTEMS GYPSUM BOARD OR PLASTER PARTITION TO BE REMOVED CMU PARTITION TO BE REMOVED FRAME AND DOOR TO BE REMOVED, SALVAGE HARDWARE TO OWNER HATCH INDICATES AREA NOT IN SCOPE SUSPENDED ACOUSTICAL TILE CEILING TO BE REMOVED SUSPENDED ACOUSTICAL TILE CEILING TO REMAIN GYPSUM BOARD OR PLASTER CEILING TO BE REMOVED GYPSUM BOARD OR PLASTER CEILING TO REMAIN RECESSED 2'x4' LAY-IN LIGHT FIXTURE TO BE REMOVED RECESSED 2'x2' LAY-IN LIGHT FIXTURE TO BE REMOVED RECESSED 2'x4' LAY-IN LIGHT FIXTURE TO REMAIN RECESSED 2'x2' LAY-IN LIGHT FIXTURE TO REMAIN RETURN AIR GRILLE TO REMAIN SUPPLY AIR GRILLE TO REMAIN

### **DEMOLITION GENERAL NOTES:**

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. PRIOR TO AND DURING ANY DEMOLITION THE CONTRACTOR SHALL VERIFY AND MAINTAIN THE BUILDING'S STRUCTURAL INTEGRITY.

RETURN AIR GRILLE TO BE REMOVED

SUPPLY AIR GRILLE TO BE REMOVED

- . CONTRACTOR SHALL BE RESPONSIBLE FOR ALL DEMOLITION AS REQUIRED TO INSTALL ALL NEW WORK. REPAIR, PATCH AND FINISH EXISTING FLOORS, WALLS AND CEILINGS
- DESIGNATED TO REMAIN TO MATCH EXISTING CONDITIONS. . REMOVE ALL HANGERS, SUSPENSION SYSTEMS, SUPPORT FRAMING, EQUIPMENT PADS, ANCHORS, ATTACHMENT HARDWARE AND RELATED APPURTENANCES CONNECTED WITH THE WORK TO BE DEMOLISHED. IF COMPLETE REMOVAL IS NOT POSSIBLE, CUT DEVICES AS CLOSE AS POSSIBLE TO ADJOINING SURFACES OR ORIGIN OF SUPPORT. DURING THE BIDDING PERIOD, EACH BIDDING CONTRACTOR SHALL VISIT THE SITE AND THE FACILITY TO DETERMINE EXISTING CONDITIONS. CONTRACTOR 'S FAILURE TO REASONABLY DETERMINE AND/OR ANTICIPATE THE EFFECT OF EXISTING CONDITIONS
- AND THE WORK INVOLVED THEREBY SHALL NOT BE JUSTIFICATION FOR ADDITIONAL COMPENSATION. NOTIFY ARCHITECT OF ANY DISCREPANCIES. . ALL MATERIALS, EQUIPMENT, FIXTURES, SYSTEMS, AND ACCESSORIES WHICH ARE TO REMAIN IN SERVICE SHALL BE CLEANED, REPAIRED, ADJUSTED AND PLACED INTO PROPER
- OPERATIONS IN ALL MODES WITH THE ORIGINAL SYSTEM. 6. WHEN TEMPORARY SHORING AND BRACING IS REQUIRED, CONTRACTOR SHALL RETAIN AND PAY FOR THE SERVICES OF A PROFESSIONAL ENGINEER-LICENSED TO PRACTICE IN THE STATE WHERE THE PROJECT IS LOCATED- TO DESIGN AND PREPARE DETAILED
- CONTRACTOR SHALL COORDINATE SCHEDULE OF DEMOLITION WORK WITH THE OVERALL PHASING PLAN. ALL AREAS SURROUNDING EACH PHASE OF DEMOLITION/CONSTRUCTION WILL BE OCCUPIED BY THE OWNER DURING THE OWNER 'S NORMAL BUSINESS HOURS. DEMOLITION WORK SHALL NOT ENCUMBER THE USE OF EXISTING ADJACENT SPACES.
- . EACH CONTRACTOR SHALL FOLLOW THE PROGRESS OF THE GENERAL DEMOLITION AND REMODELING WORK TO ASSURE THE ACCESSIBILITY AND SAFETY OF EQUIPMENT AND SYSTEMS IN SERVICE IN ORDER TO PROVIDE FOR THE TIMELY REMOVAL AND/OR RELOCATION OF EQUIPMENT, PIPING, ETC.
- 9. REMOVE ALL ABANDONED CONDUIT BOXES, CONDUCTORS, TELEPHONE LINES, ELECTRIC PANELS, AND ANY OTHER MISCELLANEOUS EQUIPMENT NOT REQUIRED FOR THE NEW
- 10. REMOVE ALL RECESSED FLOOR BOXES, WALKER DUCTS, FLOOR SINKS, HUB DRAINS, ELECTRICAL RECEPTACLES, ETC. AND FILL VOIDS AS REQUIRED. 11. REMOVE ALL DOOR STOPS AT ASSOCIATED DOORS TO BE DEMOLISHED.
- 12. NO TOXIC SUBSTANCES HAVE BEEN NOTED ON THE SITE. SHOULD THE CONTRACTOR ENCOUNTER ANY ASBESTOS, ASBESTOS PRODUCTS, PCBs OR OTHER TOXIC SUBSTANCES, THE CONTRACTOR SHOULD REPORT THIS IMMEDIATELY TO THE OWNER IN WRITING PRIOR TO CONTINUING WORK IN THIS AREA. WORK SHALL NOT BE RESUMED
- EXCEPT BY WRITTEN AUTHORIZATION OR AGREEMENT. 13. ALL CONSTRUCTION DEBRIS AND EXCESS MATERIAL IS TO BE REMOVED BY THE CONTRACTOR AT THE END OF EACH WORK DAY. THE JOB SITE IS TO BE LEFT SUFFICIENTLY CLEAN AS TO WARRANT OWNER'S APPROVAL.
- 14. REMOVE ALL CEILING SYSTEMS IN THEIR ENTIRETY, INCLUDING TILE, GRID, SUSPENSION WIRING, ANCHORS AND ALL ASSOCIATED APPURTENANCES. 15. CONTRACTOR SHALL SALVAGE ALL EXISTING CEILING TILES FOR POSSIBLE REUSE OR AS EXTRA STOCK FOR OWNER. SALVAGE ONLY UN-CUT TILES WITH NO VISIBLE DAMAGE. ONCE REMOVED, OWNER AND ARCHITECT WILL FIELD REVIEW AND APPROVE SALVAGED TILES PRIOR TO REUSE OR STORAGE.

### DEMOLITION REFERENCED NOTES:

### FLOOR DEMOLITION KEYED NOTES

F1. REMOVE CARPET FLOORING SYSTEM AND ASSOCIATED BASE COMPLETE. PREP CONCRETE SLAB AS REQUIRED FOR NEW FLOORING INSTALLATION.

### WALL DEMOLITION KEYED NOTES

W1. REMOVE 8" CMU WALL AS REQUIRED FOR NEW OPENINGS. PROVIDE LINTEL AS INDICATED IN NEW WORK DETAILS AT HEAD OF EACH NEW OPENING. REMOVE PARTIAL CMU BLOCKS REMAINING AT EACH JAMB AND INFILL WITH FULL CMU BLOCKS FOR FLUSH FINISHED JAMB CONDITIONS. GRIND EXPOSED CORNERS OF CMU TO REMAIN. W2. REMOVE 8" CMU WALL TO DECK ABOVE FOR EXTENTS INDICATED. BRACE EXISTING TO REMAIN CMU AND PREP EXPOSED EDGE AS REQUIRED FOR NEW WORK.

### **CEILING DEMOLITION KEYED NOTES**

C1. REMOVE 8" X 24" SECTION OF CMU AS INDICATED FOR NEW TRANSFER DUCT PENETRATIONS (REFER TO MECH / NEW WORK PLANS FOR DETAILS) 22. REMOVE 8" X 8" SECTION OF CMU AS INDICATED FOR NEW TRANSFER DUCT

### PENETRATIONS (REFER TO MECH / NEW WORK PLANS FOR DETAILS) MISCELLANEOUS DEMOLITION KEYED NOTES

- M1. FURNITURE REMOVED BY OWNER M2. WALL PHONE - REMOVE AND STORE FOR RE-INSTALLATION IN NEW WORK. M3. REMOVE SURFACE MOUNT CONDUIT COMPLETE. PATCH AND PREP WALLS FOR FINAL
- PAINTED FINISH. M4. REMOVE (2) 4' X 12' MARKERBOARDS AND STORE FOR RE-INSTALLATION IN NEW WORK. PATCH AND PREP WALLS FOR FINAL PAINTED FINISH.

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# CHANG

KEY PLAN:


04/28/2023 SHEET STATUS: **ISSUED FOR BID - NOT** FOR CONSTRUCTION

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SHEET	TITLE:	

**DEMO PLAN & RCP** 

SHEET NUMBER: AD1.10

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CHANGING ROOMS

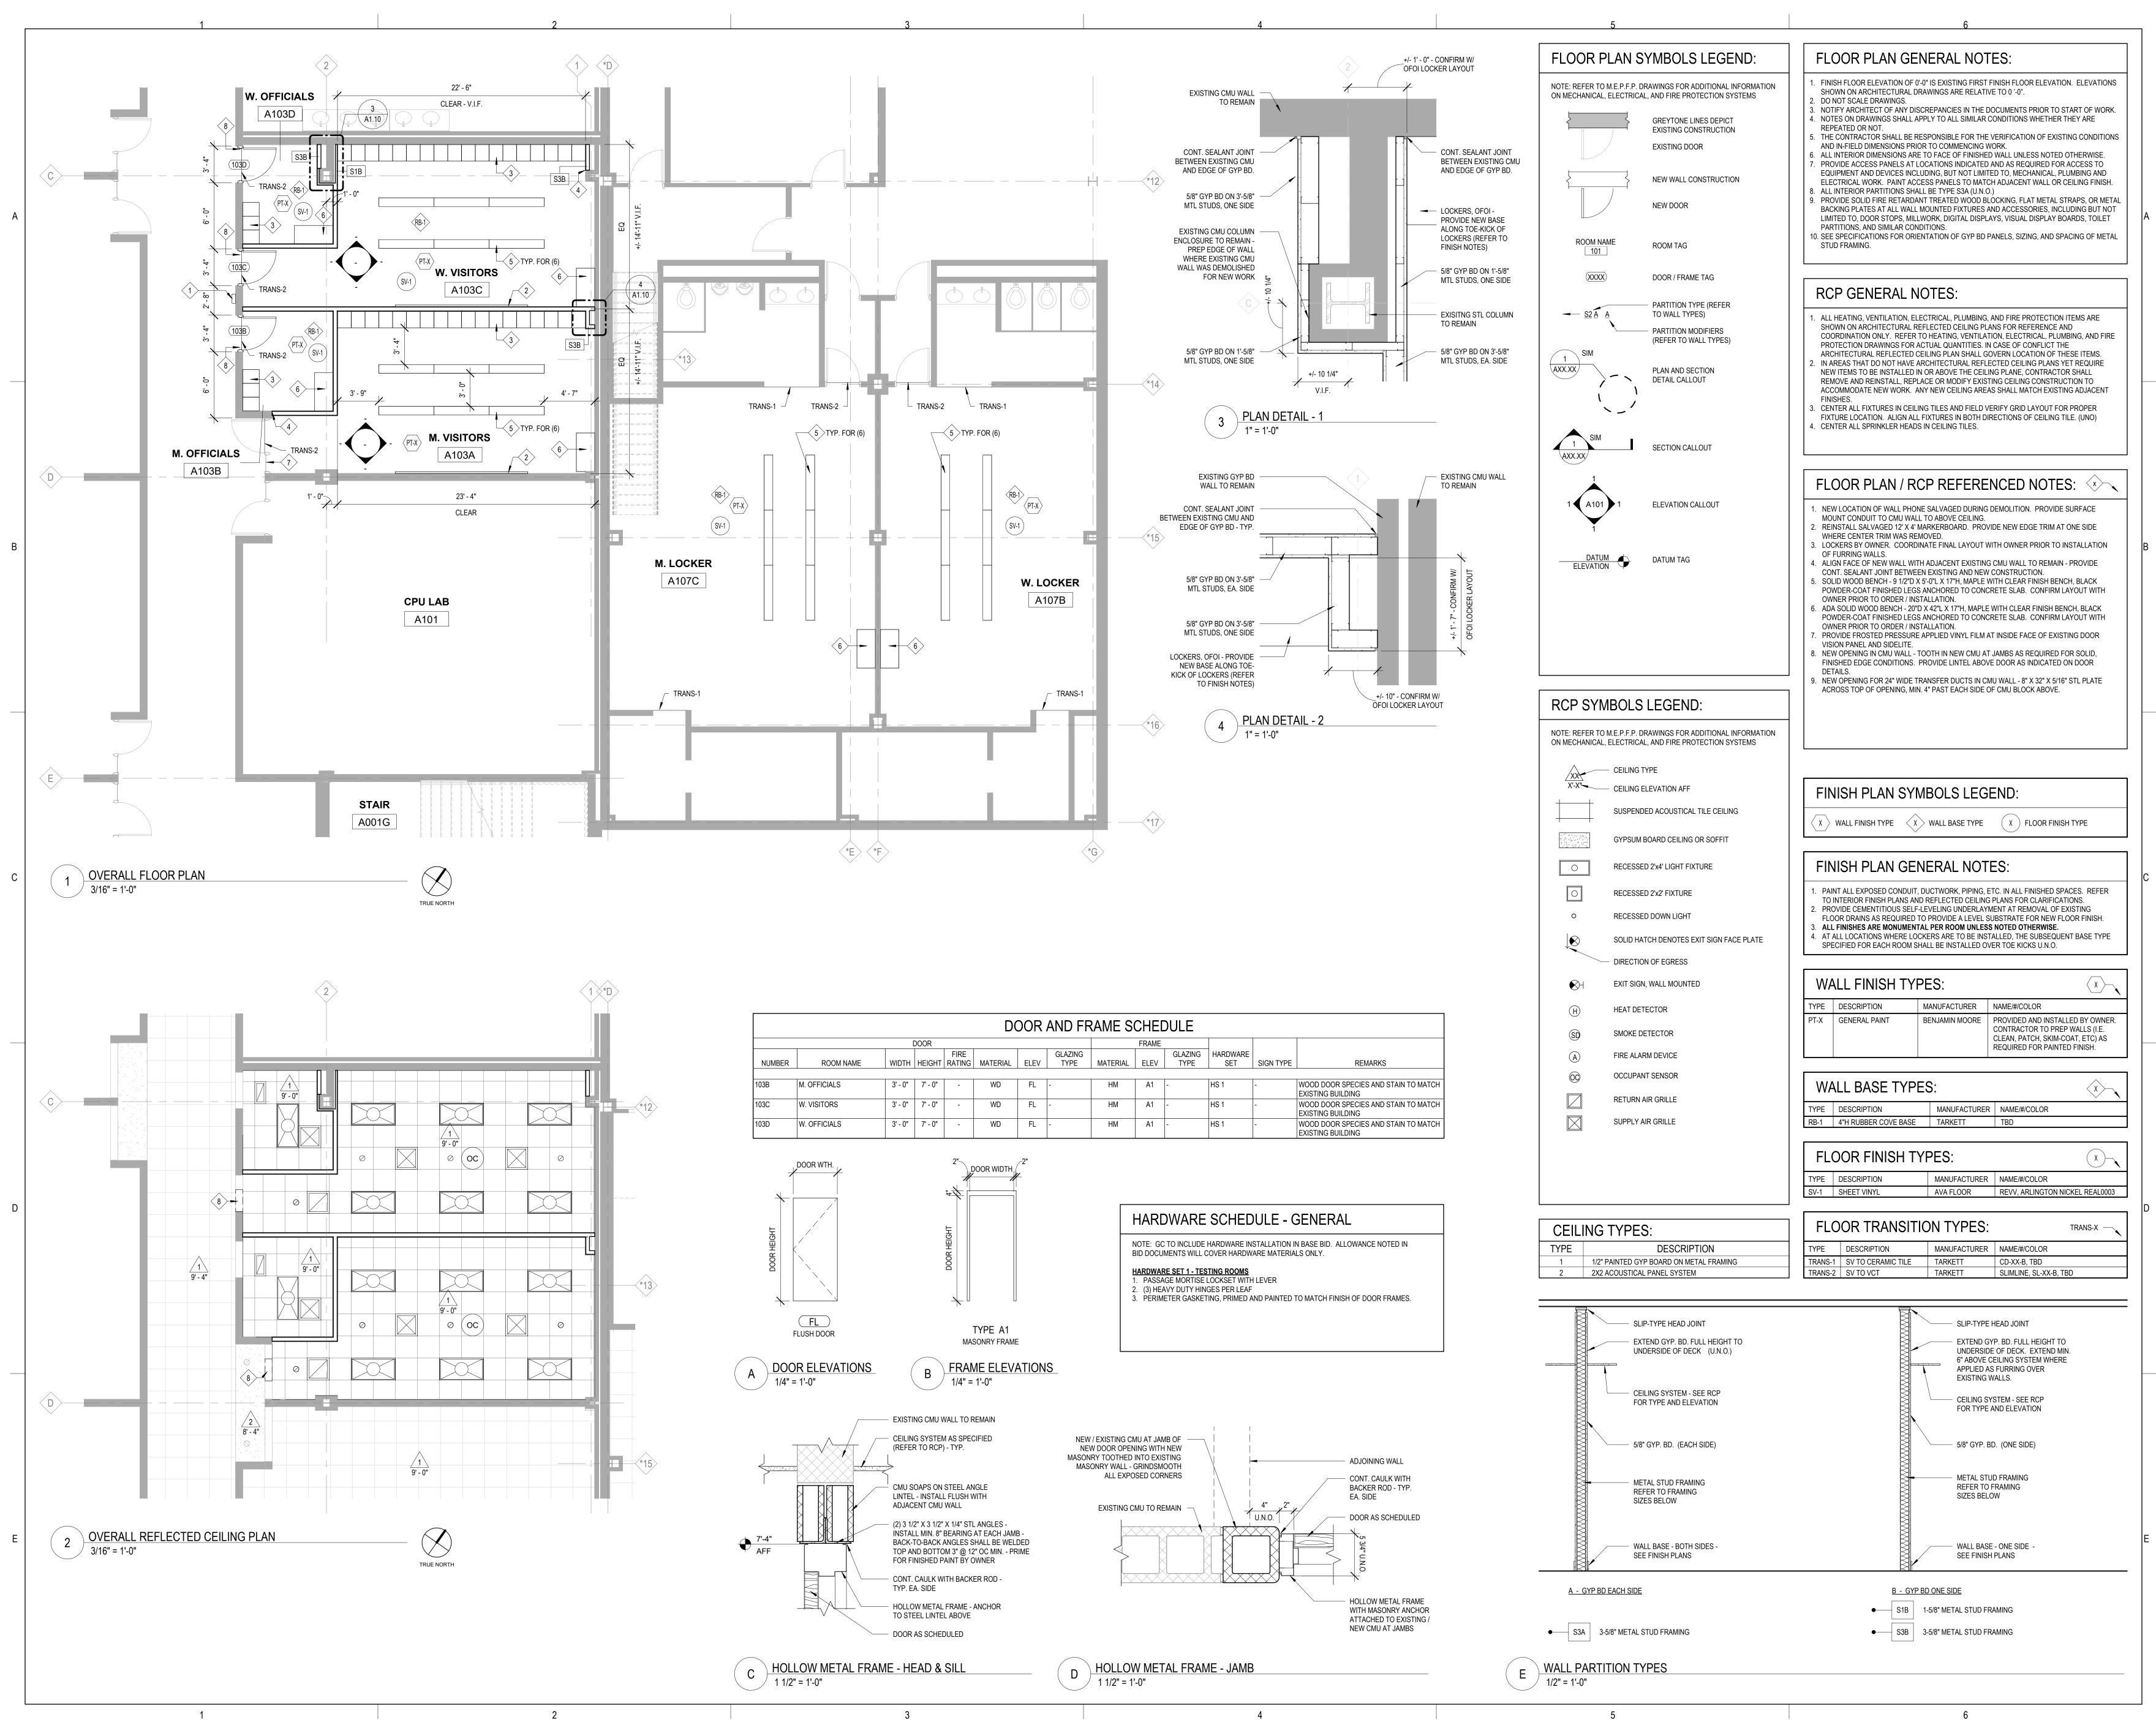8900 US Hwy 14

KEY PLAN:

SHEET STATUS: 04/28/2023

ISSUED FOR BID - NOT FOR CONSTRUCTION

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SHEET TITLE:
FLOOR PLAN & RCP

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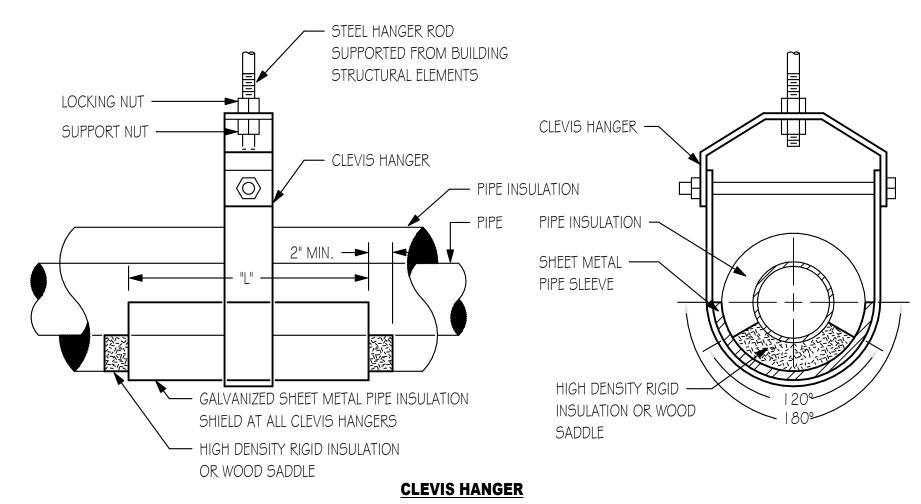
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### **GENERAL REMODELING NOTES - ALL CONTRACTORS**


- I. ALL WORK SHOWN ON DRAWINGS SHALL BE CONSIDERED NEW AND IN CONTRACT UNLESS SPECIFICALLY INDICATED OTHERWISE.
- 2. DRAWINGS ARE GENERALLY DIAGRAMMATIC. ROUTING OF PIPING, DUCTWORK, CONDUITS, RACEWAYS, ETC., AS SHOWN ON DRAWINGS, DOES NOT INTEND TO SHOW EVERY RISE, DROP, OFFSET, FITTING NOR EVERY STRUCTURAL ELEMENT THAT MAY BE ENCOUNTERED DURING THE INSTALLATION OF THIS WORK. EACH CONTRACTOR SHALL MAKE ANY REQUIRED CHANGES FROM THE GENERAL ROUTING SHOWN ON THESE DRAWINGS, SUCH AS OFFSETS, BENDS OR CHANGES IN ELEVATION DUE TO COORDINATION WITH THE WORK OF OTHER TRADES AND BUILDING CONSTRUCTION. ALL CHANGES SHALL BE MADE WITHOUT ADDITIONAL COST TO THE OWNER OR DELAY IN COMPLETION DATE OF THE PROJECT.
- 3. IT IS INTENDED THAT EQUIPMENT SHALL BE LOCATED SYMMETRICALLY WITH THE ARCHITECTURAL ELEMENTS OF THE BUILDING, NOTWITHSTANDING THE FACT THAT LOCATIONS INDICATED BY HESE DRAWINGS MAY BE DISTORTED FOR CLEARNESS OF PRESENTATION.
- 4. CONTRACTOR SHALL CHECK DRAWINGS OF OTHER TRADES TO VERIFY THAT SPACES IN WHICH HEIR WORK WILL BE INSTALLED ARE CLEAR OF OBSTRUCTIONS. WORK SHALL BE INSTALLED TO MAINTAIN MAXIMUM HEADROOM AND SPACE CONDITIONS AT ALL POINTS IN THE BUILDING. WHERE HEADROOM OR SPACE CONDITIONS APPEAR INADEQUATE, CONTRACTOR SHALL NOTIFY OWNER/ARCHITECT/ENGINEER BEFORE PROCEEDING WITH THE INSTALLATION OF THEIR WORK.
- 5. CONTRACTOR SHALL FURNISH OTHER TRADES ADVANCE INFORMATION AND/OR SHOP DRAWINGS ON LOCATIONS AND SIZES OF PIPING, DUCTWORK, CONDUIT, RACEWAYS, EQUIPMENT, FRAMES, BOXES, SLEEVES AND OPENINGS, ETC. NEEDED FOR THEIR WORK TO PERMIT OTHER TRADES AFFECTED TO INSTALL THEIR WORK PROPERLY AND WITHOUT DELAY.
- G. WHERE THERE IS EVIDENCE THAT WORK OF ONE TRADE WILL INTERFERE WITH WORK OF OTHER RADES, ALL TRADES SHALL MEET ON JOB SITE TO WORK OUT SPACE CONDITIONS AND MAKE SATISFACTORY ADJUSTMENTS TO INSTALLATION OF THE NEW WORK. CONTRACTORS SHALL VERIFY EXACT LOCATIONS OF ALL DEVICES AND EQUIPMENT WITH FIELD CONDITIONS, SHOP DRAWINGS, AND WORK OF OTHER TRADES PRIOR TO ROUGH-IN. EACH CONTRACTOR SHALL BE RESPONSIBLE, AT THEIR OWN EXPENSE, FOR THE REMOVAL AND REINSTALLATION OF ANY PART OF THEIR WORK IF SAME WAS INSTALLED WITHOUT CONSULTING WITH OTHER TRADES BEFORE INSTALLING THEIR WORK
- 7. CONTRACTOR SHALL PROVIDE SLEEVES IN BEAMS, FLOORS, COLUMNS AND WALLS AS SHOWN IN THE DRAWINGS, AS REQUIRED BY JOB SITE CONDITIONS, AND/OR AS SPECIFIED, WHEN INSTALLING THEIR WORK. ALL BEAMS AND COLUMNS WHICH ARE REQUIRED TO BE SLEEVED SHALL BE CUT AND REINFORCED AS REQUIRED BY FIELD CONDITIONS AND LOCATIONS AND SIZES SHALL BE CHECKED AND APPROVED BY ARCHITECT BEFORE CONTRACTOR CUTS ANY STRUCTURAL BUILDING MEMBER.
- 8. THE SEQUENCE FOR THE INSTALLATION OF ALL WORK SHALL BE COORDINATED BETWEEN ALL CONTRACTORS ON THE PROJECT AND IN STRICT ACCORDANCE WITH ARCHITECT/ENGINEER AND OWNERS STIPULATION AS DIRECTED.
- 9. CONTRACTOR SHALL REFER TO THE ARCHITECTURAL AND STRUCTURAL CONTRACT DRAWINGS BEFORE SUBMITTING THEIR BIDS) TO FAMILIARIZE THEMSELVES WITH THE EXTENT OF THE GENERAL CONTRACTOR'S WORK, CEILING HEIGHTS AND CLEARANCE FOR INSTALLING THEIR WORK.
- 10. CONTRACTOR SHALL BE RESPONSIBLE AND PAY FOR ALL CORING, CUTTING, PATCHING, REPAIRING, REFINISHING AND REMOVAL/REPLACEMENT OF NEW OR EXISTING BUILDING CONSTRUCTION REQUIRED TO ACCOMMODATE THE INSTALLATION OR REMOVAL OF THEIR WORK. ALL PATCHING, REPAIRING AND REFINISHING WORK SHALL BE PERFORMED BY THOSE REGULARLY INVOLVED IN THAT TRADE AND SHALL MATCH THE ADJACENT CONSTRUCTION AS CLOSELY AS POSSIBLE. CARE SHALL BE TAKEN SO AS NOT TO DAMAGE ANY EXISTING BUILDING CONSTRUCTION OR ITEMS THAT ARE TO REMAIN. ANY EXISTING FINISHES THAT ARE DAMAGED DURING THE INSTALLATION OF NEW WORK OR REMOVAL OF EXISTING WORK SHALL BE REPAIRED, REPLACED AND PAID FOR BY THE INSTALLING CONTRACTOR, TO THE SATISFACTION OF THE ARCHITECT AND OWNER. REFER TO ARCHITECTURAL DRAWINGS FOR EXISTING BUILDING CONSTRUCTION THAT IS TO REMAIN AND, THEREFORE, SUBJECT TO PATCHING, REPAIRING, REFINISHING, AND REMOVAL/REPLACEMENT.
- OVER TO THE EXISTING ITEMS AND EQUIPMENT SCHEDULED TO BE REMOVED SHALL BE TURNED OVER TO THE OWNER. ANY ITEMS THAT THE OWNER WANTS TO RETAIN SHALL BE REMOVED CAREFULLY SO AS NOT TO DAMAGE THEM. ALL OTHER ITEMS TO BE REMOVED SHALL BECOME THE PROPERTY OF THE CONTRACTOR AND REMOVED FROM THE SITE.
- 12. CONTRACTOR SHALL BE RESPONSIBLE FOR THEIR OWN CLEAN-UP DURING CONSTRUCTION. IF CONTRACTOR FAILS TO PROVIDE SUCH CLEAN-UP, THE ARCHITECT/ENGINEER WILL DIRECT ANOTHER CONTRACTOR TO PERFORM THE CLEAN-UP AND THE NEGLIGENT CONTRACTOR SHALL PAY THE ASSOCIATED BACK-CHARGES AS DEEMED APPROPRIATE BY THE ARCHITECT/ENGINEER.
- 13. CONTRACTOR SHALL INSTALL ALL AUXILIARY SUPPORTING STEEL AS REQUIRED FOR THE SUPPORTING OF THEIR PIPING, DUCTWORK, CONDUIT, TANKS, EQUIPMENT, ETC. ALL SUPPORTING STEEL FOR ITEMS ABOVE A SUSPENDED CEILING SHALL BE FROM BUILDING STRUCTURAL MEMBERS ONLY.
- 14. IT IS MANDATORY THAT THE COMPLETE EXISTING BUILDING REMAIN IN CONTINUOUS AND NON-INTERRUPTED OPERATION DURING REMODELING/ALTERING OF SAID EXISTING BUILDING. THE SPECIFIC AREA(S) BEING REMODELED/ALTERED AT ANY SCHEDULED TIME ARE OBVIOUSLY EXCLUSIVE OF THIS STATEMENT. SERVICES TO EXISTING BUILDING SHALL BE KEPT IN CONTINUOUS OPERATION INCLUDING POWER, SIGNAL SYSTEMS, LIGHTING, TELEPHONE, HEATING, COOLING, VENTILATING, TEMPERATURE CONTROL, SEWERS AND HOT AND COLD WATER. ANY ABSOLUTELY NECESSARY INTERRUPTION OF THESE SERVICES TO ACCOMPLISH CONTRACT WORK SHALL BE ARRANGED WITH THE OWNER A MINIMUM OF TEN (10) WORKING DAYS IN ADVANCE. SUCH INTERRUPTIONS SHALL BE KEPT TO AN ABSOLUTE MINIMUM AS FAR AS TIME INTERVAL IS INVOLVED AND TEMPORARY SERVICES SHALL BE FURNISHED AND INSTALLED UNDER THIS CONTRACT WHERE NECESSARY TO ACCOMPLISH THIS PURPOSE. TEMPORARIES SHALL BE REMOVED BY THE CONTRACTOR ONLY AFTER NEW PERMANENT SERVICES ARE INSTALLED AND FULLY OPERATIONAL.


- 15. UNLESS INDICATED OTHERWISE, THE ARCHITECT/ENGINEER MAKES NO REPRESENTATION AS TO WHETHER OR NOT ANY HAZARDOUS OR CONTAMINATED MATERIALS (INCLUDING BUT NOT LIMITED TO ASBESTOS, PCB'S, CONTAMINATED SOILS, ETC.) ARE PRESENT WITHIN THE EXISTING BUILDING OR ON THE SITE. WORK SHOWN ON THE DRAWINGS AND/OR INDICATED IN THE SPECIFICATIONS SHALL NOT BE CONSTRUED TO CALL FOR CONTACT WITH ANY OF THESE MATERIALS. IF THESE MATERIALS ARE ENCOUNTERED OR SUSPECTED, THE CONTRACTOR SHALL NOT DISTURB THEM AND SHALL CONTACT THE ARCHITECT/ENGINEER IMMEDIATELY.
- I 6. WHERE WORK CALLED FOR ON THE DRAWINGS OR IN THE SPECIFICATIONS INVOLVES THE REMOVAL OR RELOCATION OF PIPING OR EQUIPMENT CONTAINING REFRIGERANT, ALL REFRIGERANT SHALL BE RECOVERED BY APPROVED METHODS PER EPA REGULATIONS.
- 17. CONTRACTOR SHALL STORE ALL MATERIALS AND EQUIPMENT SHIPPED TO THE SITE IN A PROTECTED AREA. IF MATERIAL IS STORED OUTSIDE OF THE BUILDING, IT MUST BE STORED OFF THE GROUND A MINIMUM OF SIX INCHES (6") SET ON 6 X 6 PLANKS AND/OR WOOD PALLETS. ALL MATERIAL AND EQUIPMENT MUST BE COMPLETELY COVERED WITH WATERPROOF TARPS OR VISQUIN. ALL PIPING AND DUCTWORK WILL HAVE THE ENDS CLOSED TO KEEP OUT DIRT AND OTHER DEBRIS. NO EQUIPMENT WILL BE ALLOWED TO BE STORED OUTSIDE THE BUILDING ON THE SITE UNLESS IT IS SUPPORTED OFF THE GROUND AND COMPLETELY PROTECTED WITH WEATHERPROOF COVERS.
- 18. THE DRAWINGS, SCHEDULES AND SPECIFICATIONS HAVE BEEN PREPARED USING ONE MANUFACTURER FOR EACH PIECE OF EQUIPMENT AS THE BASIS FOR DIMENSIONAL DESIGN. IF THE CONTRACTOR PURCHASES EQUIPMENT FROM A SPECIFIED ACCEPTABLE MANUFACTURER, BUT NOT THE SCHEDULED MANUFACTURER USED FOR THE BASE DESIGN, THE CONTRACTOR SHALL BE RESPONSIBLE FOR CHECKING ALL THE DIMENSIONS OF THE EQUIPMENT TO VERIFY THAT IT WILL FIT IN THE SPACE SHOWN ON THE DRAWINGS. MINOR DEVIATIONS IN DIMENSIONS WILL BE PERMITTED, PROVIDED THE RATINGS MEET THOSE SHOWN ON THE DRAWINGS AND EQUIPMENT WILL PHYSICALLY FIT INTO THE SPACE ALLOCATED WITH SUITABLE ACCESS AROUND EQUIPMENT FOR OPERATION AND MAINTENANCE OF THE EQUIPMENT. WHEN EQUIPMENT SUBMITTED FOR REVIEW DOES NOT MEET THE PHYSICAL SIZE OR ARRANGEMENT OF THAT SCHEDULED AND SPECIFIED, CONTRACTOR SHALL PAY FOR ALL ALTERATIONS REQUIRED TO ACCOMMODATE SUCH EQUIPMENT AT NO ADDITIONAL COST TO THE OWNER. CONTRACTOR WILL ALSO PAY ALL COSTS FOR ADDITIONAL WORK REQUIRED BY OTHER CONTRACTORS, OWNER, ARCHITECT OR ENGINEER TO MAKE CHANGES WHICH WOULD ALLOW THE EQUIPMENT TO FIT IN THE SPACE AND FUNCTION AS INTENDED.
- 19. CONTRACTOR AND/OR MANUFACTURER SHALL VERIFY THAT THE CHARACTERISTICS OF THE EQUIPMENT HE SUBMITS FOR REVIEW MEET THE CAPACITY AND DUTY SPECIFIED. WHEN EQUIPMENT SUBMITTED FOR REVIEW REQUIRES MODIFICATIONS TO THE WORK OF OTHER CONTRACTORS, SUBMITTING CONTRACTOR SHALL PAY FOR ALL COSTS FOR ADDITIONAL WORK REQUIRED BY OTHER CONTRACTORS, OWNER, ARCHITECT OR ENGINEER TO MAKE CHANGES WHICH WOULD ALLOW THE EQUIPMENT FUNCTION SAFELY AND PROPERLY.
- 20. CONTRACTOR SHALL FIELD VERIFY THE SIZE OF EXISTING OPENINGS, WINDOWS, DOORS, CORRIDORS, ROOMS, ETC. FOR ACCESS OF THE NEW EQUIPMENT INTO OR REMOVAL OF EXISTING EQUIPMENT FROM THE BUILDING. IF OPENINGS ARE TOO SMALL FOR ACCESS THEN CONTRACTOR SHALL, AT HIS OWN EXPENSE, PROVIDE NEW OR ENLARGED OPENINGS AND RESTORE SAME TO ORIGINAL SIZE AND CONDITION. CONTRACTOR MAY ELECT TO ORDER THE EQUIPMENT DISASSEMBLED AND/OR WITH SPLIT HOUSING FOR ENTRANCE INTO THE EXISTING SPACE OR BUILDING. CONTRACTOR SHALL REASSEMBLE EQUIPMENT AFTER IT IS IN THE SPACE AT HIS OWN EXPENSE.
- 21. CONTRACTOR SHALL SUBMIT ELECTRONIC COPIES OF SHOP DRAWINGS OF ALL EQUIPMENT, DIFFUSERS, REGISTERS, TEMPERATURE CONTROL SYSTEM, FPB BOXES, DUCT SILENCERS, FIRE DAMPERS, LIGHTING FIXTURES, PANELBOARDS, ELECTRICAL DEVICES, PLUMBING FIXTURES, ETC. TO ENGINEER FOR APPROVAL PRIOR TO ORDERING ANY ITEMS OR FABRICATING ANY DUCTWORK.
- 22. CONTRACTOR SHALL PROVIDE OWNER TRAINING ON ALL EQUIPMENT AND BUILDING SYSTEMS PROVIDED/ALTERED BY HIS WORK. TRAINING SHALL BE ACCOMPLISHED DURING TIME DEDICATED FOR THAT PURPOSE, NOT IN CONJUNCTION WITH SERVICE WORK. SEE SPECIAL TEMPERATURE CONTROL TRAINING INSTRUCTIONS ELSEWHERE.
- 23. AT COMPLETION OF PROJECT, CONTRACTOR SHALL SUBMIT ELECTRONIC COPIES OF OPERATION AND MAINTENANCE MANUALS FOR ALL WORK PROVIDED BY HIM ON PROJECT. MANUALS SHALL BE CLEARLY ORGANIZED AND CONTAIN COPIES OF APPROVED EQUIPMENT, SHOP DRAWINGS, EQUIPMENT PARTS LISTS, SERVICE CONTACTS, CONTRACTOR AND MANUFACTURER WARRANTEES, AND "AS BUILT" FLOOR PLANS.
- 24. CONTRACTOR SHALL PROVIDE WARRANTY FOR ALL MATERIAL AND GUARANTEE ALL WORKMANSHIP PROVIDED BY HIM FOR I (ONE) YEAR FROM SUBSTANTIAL COMPLETION OF WORK INVOLVED.
- 25. CONTRACTOR SHALL MAINTAIN A CURRENT CITY OF CRYSTAL LAKE LICENSE THROUGHOUT ALL PHASES OF CONSTRUCTION. IT SHALL BE THE CONTRACTORS RESPONSIBILITY TO COORDINATE ALL INSPECTIONS WITH THE CITY OF CRYSTAL LAKE. THE CITY OF CRYSTAL LAKE REQUIRES MINIMUM ONE DAY PRIOR NOTICE FOR ALL INSPECTIONS.
- 26. IDENTIFY ALL PIPING AND DUCTWORK WITH PLASTIC LABELS INDICATING CONTENTS AND FLOW DIRECTION. MARKERS TO BE PLACED AT A MAXIMUM OF 50 FT. INTERVALS AT BRANCH CONNECTIONS, AND AT BOTH SIDES OF WALL/FLOOR PENETRATIONS. IDENTIFY VALVES, EQUIPMENT, AND PANELS WITH ENGRAVED 3-LAYER PLASTIC LAMINATED TAGS OR SIGNS. IN ADDITION TO PROVIDING ENGRAVED PLASTIC NAMEPLATES ON THE VAV AND FPB BOXES, PROVIDE ENGRAVED PLASTIC NAMEPLATES ON THE CEILING GRID BELOW THE BOX. THE NAMEPLATE SHALL BE NO WIDER THAN THE WIDTH OF THE GRID (WHITE WITH BLACK LETTERS).



PIPE INSULATION SHIELD SCHEDULE								
PIPE SIZE	LENGTH	GAUGE						
UP TO 3/4"	8"	20 GA.						
l" - 2"	12"	18 GA.						
2 1/2" - 4"	12"	16 GA.						
5" \$ 6"	18"	16 GA.						
8" \$ UP	24"	14 GA.						


NOTE: I. CONFER WITH ARCHITECT AND REFER TO STRUCTURAL DRAWINGS FOR ADDITIONAL INFORMATION ON ACCEPTABLE METHODS AND LOCATIONS FOR HANGER SUPPORTS

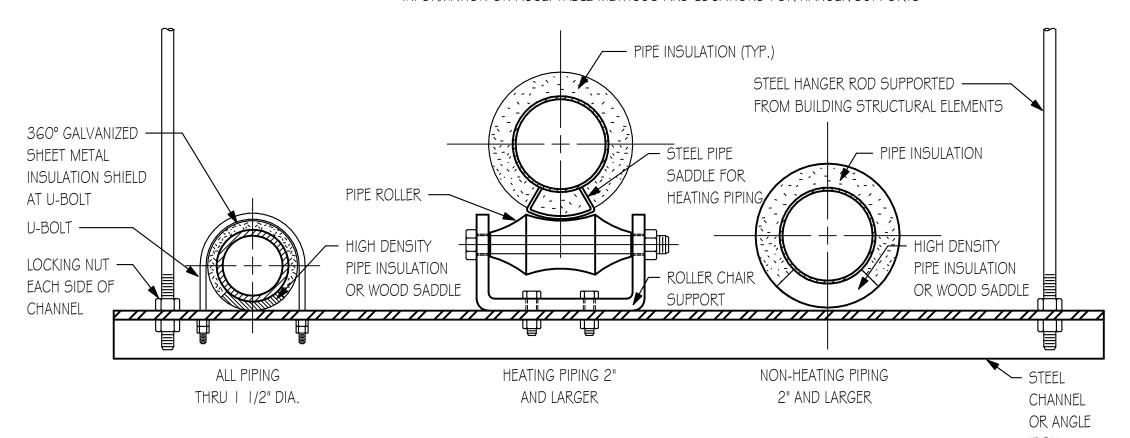

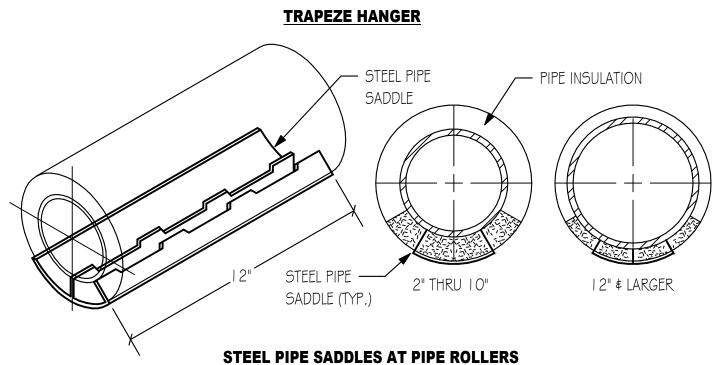

TYPICAL PIPE HANGER DETAILS

NO SCALE

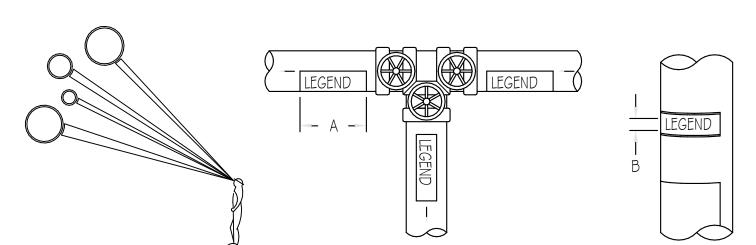

NOTE:
IDENTIFICATION MARKERS OR STRIPS TO BE PLACED ON ALL EXPOSED COVERED AND UNCOVERED PIPES AT 50'-0" INTERVALS, ADJACENT TO ALL VALVES OR BRANCHES, AND AT BOTH SIDES OF WALL/FLOOR PENETRATIONS. ARROWS OF SAME COLOR AS IDENTIFICATION MARKERS SHALL ALSO BE PLACED ON PIPES POINTING AWAY FROM MARKER INDICATING DIRECTION OF FLOW.

SIZE OF LEGEND LETTERS						
OUTSIDE DIAMETER	LENGTH OF	SIZE OF				
OF PIPE	COLOR FIELD	LETTERS				
OR COVERING	А	В				
3/4" TO   1/4"	8"	1/2"				
1 1/2" TO 2"	8"	3/4"				
2 1/2" TO 6"	12"	/4"				
8" TO 10"	24"	2 1/2"				
OVER 10"	32"	3 1/2"				
BACKGROUND OR LETTER						
SERVICE	COLOR BAND	COLOR				
FIRE PROTECTION (SPRINKLE	ER) SAFETY RED	WHITE				

TYPICAL PIPE IDENTIFICATION MARKERS

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## ARY COUNTY COLLE TEAM CHANGING ROOMS

KEY PLAN:

ISSUED FOR BIDS - NOT FOR CONSTRUCTION

NO: DESCRIPTION: DATE:

SHEET TITLE:

MECHANICAL/
ELECTRICAL/
PLUMBING

COORDINATION
SHEET NUMBER:

### **DRAWING NOTES**

- MAKE NEW CONNECTION TO EXISTING DUCTWORK AT THIS LOCATION.
   TRANSFER OPENING OF SIZE INDICATED IN WALL ABOVE CEILING. SEE ARCHITECTURAL DRAWINGS FOR MORE COMMENTS.
- 3 EXISTING DUCTWORK, DIFFUSERS, REGISTERS, AND GRILLES TO REMAIN.
- 4 EXISTING HVAC EQUIPMENT TO REMAIN.
- NEW CONNECTION TO BE MADE AT THIS LOCATION. REMOVE ALL DUCTWORK, DIFFUSERS, REGISTERS, HANGERS, INSULATION, ETC. SHOWN DASHED BEYOND THIS POINT.
- 6 REMOVE ALL DUCTWORK, DIFFUSERS, REGISTERS, HANGERS, INSULATION, ETC. SHOWN DASHED.
- 7 NEW LOCATION OF EXISTING DIFFUSER. BALANCE TO AIRFLOW RATE INDICATED.
- 8 EXISTING THERMOSTAT TO REMAIN.

### **HVAC SYMBOLS AND ABBREVIATIONS**

- AD ACCESS DOOR
- BAS BUILDING AUTOMATION SYSTEM
- CFM CUBIC FEET PER MINUTE
- DN. DOW
- ESP EXTERNAL STATIC PRESSURE
- F FAHRENHI
- FPB PARALLEL FAN POWERED BOX
- FPM FEET PER MINUTE
- FV FACE VELOCITY
- GC GENERAL CONTRACTOR
- NEW CONNECTION
- NK NECK
- N.C. NORMALLY CLOSED
- N.I.C.NOT IN CONTRACT
- N.O. NORMALLY OPEN
- PD PRESSURE DROP
- SP STATIC PRESSURE
- TC TEMPERATURE CONTROL

  TSP TOTAL STATIC PRESSURE
- UC UNDERCUT DOOR
- VD VOLUME DAMPER



MANUAL SINGLE BLADE OR OPPOSED BLADE DAMPER

DUCT SIZE FREE AREA (I ST FIGURE, SIDE OF DUCT SHOWN)

CROSS-SECTION OF SUPPLY OR OUTSIDE AIR INTAKE DUCT


CROSS-SECTION OF RETURN OR EXHAUST DUCT


90° BRANCH TAKE-OFF W/45 DEGREE ENTRY

(2))))))))))))) ROUND FLEXIBLE DUCT

SQUARE OR RECTANGLE DUCT TRANSITION


WALL THERMOSTAT OR TEMPERATURE SENSOR

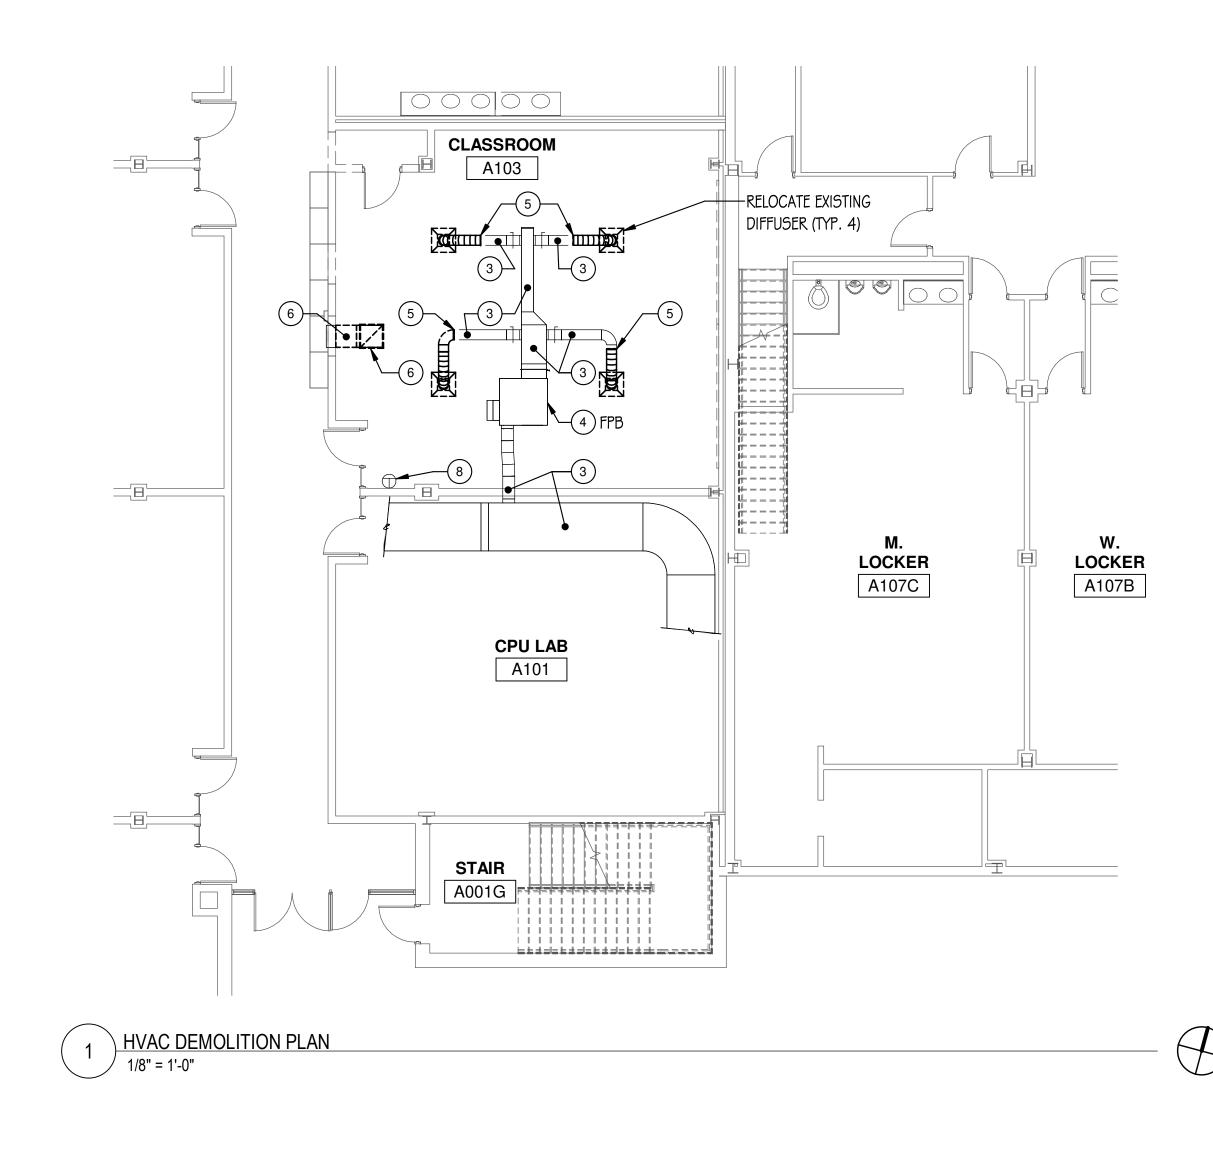

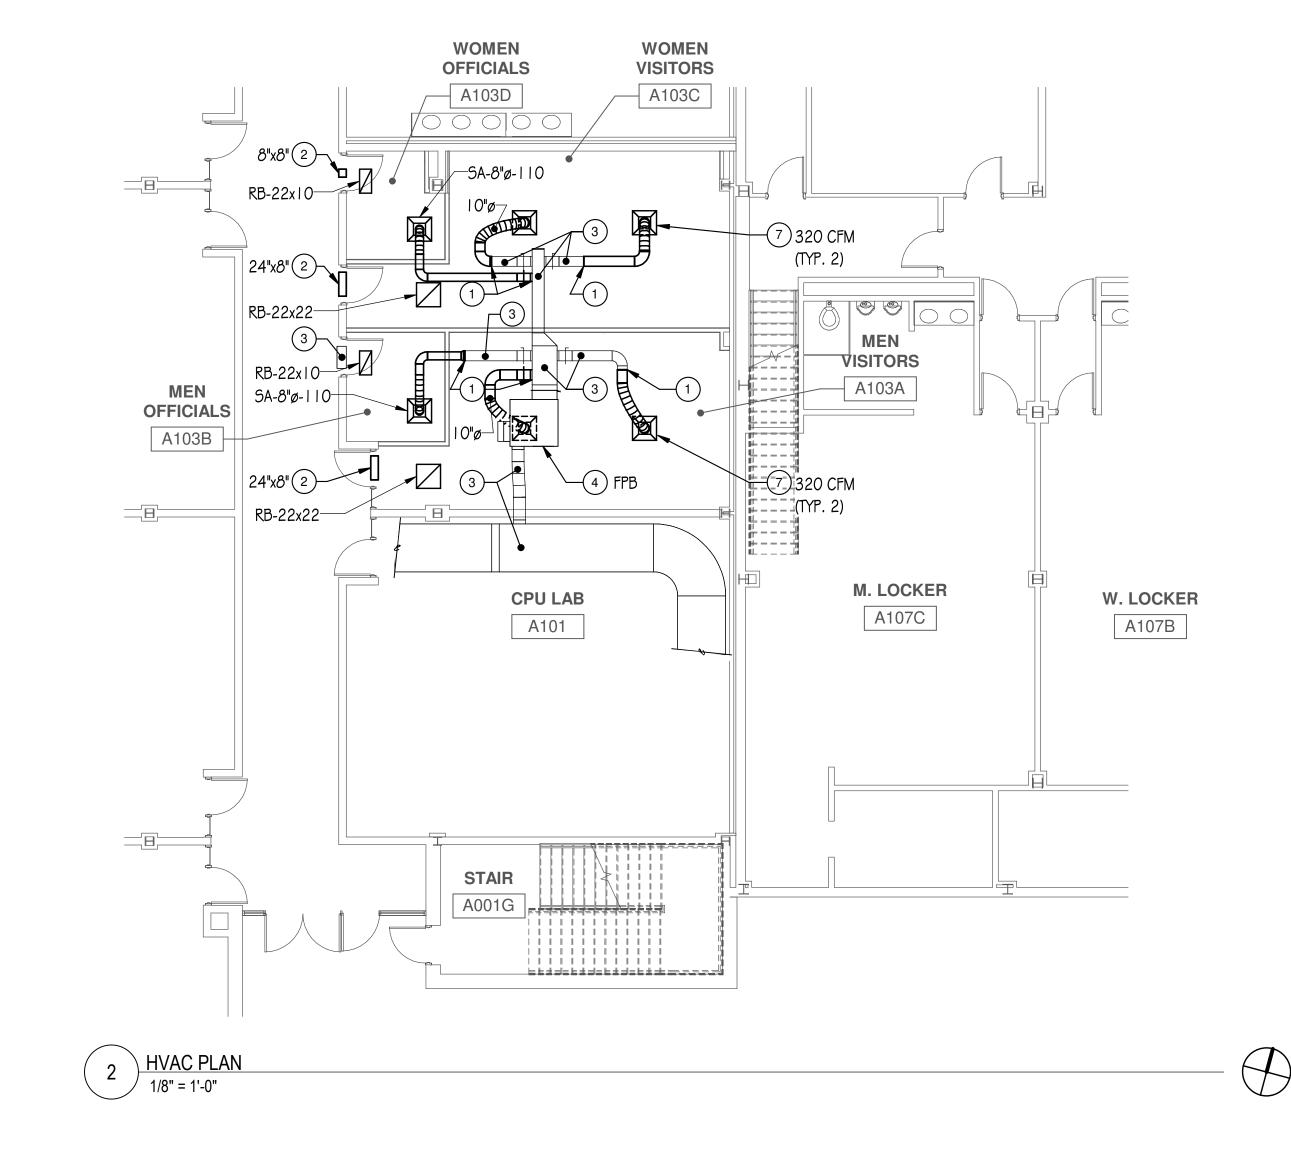

### **GENERAL NOTES - HVAC WORK:**

- ALL NEW WORK AND MATERIALS SHALL CONFORM TO CITY OF CRYSTAL LAKE CODE AND COMMUNITY COLLEGE BUILDING STANDARDS.
- 2. NOISE AND VIBRATION WILL NOT BE TOLERATED. CONTRACTOR SHALL BID ON FURNISHING EVERY DETAIL TO ASSURE THIS END.
- 3. PATCH AND REFINISH ALL DAMAGED INSULATED SURFACES OF ALL EXISTING DUCTWORK, PIPING AND ASSOCIATED FITTINGS TO MATCH EXISTING WHERE NEW CONNECTIONS ARE BEING MADE.
- 4. THE LOCATIONS SHOWN FOR ALL DIFFUSERS, REGISTERS AND GRILLES, ETC. ARE DIAGRAMMATIC. EXACT LOCATION SHALL BE DETERMINED FROM THE REFLECTED CEILING PLANS AND/OR ON THE JOB SITE BY THE ARCHITECT/ENGINEER REPRESENTATIVES.
- 5. EXCEPT AS NOTED OTHERWISE, ALL SUPPLY, RETURN, AND EXHAUST DUCTWORK SHALL BE GALVANIZED SHEET METAL WITH SEALED JOINTS CONSTRUCTED AND INSTALLED IN ACCORDANCE WITH CURRENT SMACNA MANUAL. SIZES SHOWN ARE INSIDE FACE TO INSIDE FACE.
- 6. THE GAUGES OF IRON FOR DUCTS AND CASINGS AND SIZE OF STRUCTURAL REINFORCING ANGLES FOR DUCTS AND CASING SHALL BE SUCH AS TO PROVIDE ABSOLUTELY AIR TIGHT CONSTRUCTION FREE FROM PULSATION, DEFORMATION, OR VIBRATION AT NORMAL OPERATING PRESSURES.
- 7. ALL NEW CONCEALED SUPPLY DUCTWORK SHALL BE EXTERNALLY INSULATED 1 1/2" THICK WITH FLEXIBLE FIBERGLASS INSULATION WITH VAPOR BARRIER JACKET.
- 8. ALL ROUND CONCEALED FLEXIBLE DUCT SHALL BE WIREMOLD OR THERMOFLEX FACTORY INSULATED 1" THICK MAXIMUM OF 5'-0" LONG TO DIFFUSERS/REGISTERS.
- 9. PROVIDE MANUAL VOLUME DAMPERS AT EACH BRANCH DUCT TAKEOFF IN SUPPLY DUCTWORK (DOWNSTREAM OF VAV BOXES) AND IN RETURN/EXHAUST DUCTWORK. PROVIDE TURNING VANES IN ALL SQUARE DUCT ELBOWS.
- IO. BALANCE DUCT SYSTEMS TO ACCOMPLISH AIR QUANTITIES SHOWN AT ALL INLETS/OUTLETS (NEW AND EXISTING) AS SHOWN ON DRAWING AND SUBMIT TEST REPORT FOR REVIEW BY OWNER AND ENGINEER.

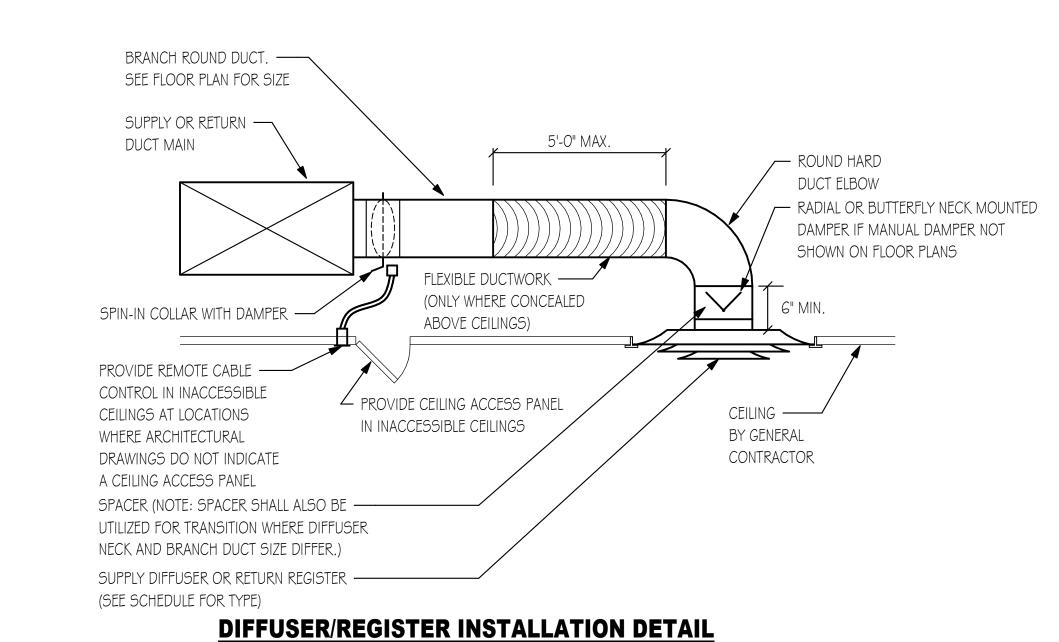

DIFFUSER, REGISTER, AND GRILLE SCHEDULE							
TAG	MANUFACTURER	MODEL	TYPE	NOMINAL FACE SIZE	MATERIAL	MAX. N.C.	NOTES
Α	TITUS	OMNI	SQUARE PANEL FACE	24"x24"	STEEL	30	1,2,3
В	TITUS	50F	EGG CRATE	VARIES	ALUMINUM	30	1,2,4
<ol> <li>FIN</li> <li>OF</li> <li>I/I</li> </ol>	THER ACCEPTABLE MANUFAC NISH AS SELECTED BY ARCH PPOSED BLADE DAMPER. 2"x1/2"x1" OR 1/2"x1/2"x1/2" FLECTION GRID.	ITECT.	L. 'S'=SUPF	RN/RELIEF UST			FLOW (CFM)

BIDDING NOTE:

SEE DRAWINGS ME I . I O FOR GENERAL NOTES AND ADDITIONAL DETAILS APPLICABLE TO THIS TRADE'S

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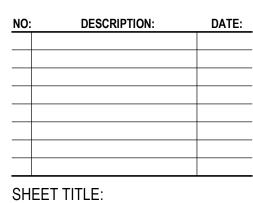
Y COUNTY COLLEGEAM CHANGING ROOMS

KEY PLAN:

SHEET STATUS: 04/28/2023

ISSUED FOR BIDS - NOT FOR CONSTRUCTION

NO: DESCRIPTION: DATE:



NOTES, AND SCHEDULES

SHEET NUMBER:

**HVAC PLANS**,


DETAILS, LEGENDS,

### GENERAL NOTES - FIRE PROTECTION

- SYSTEM TO PROVIDE COVERAGE FOR RENOVATED AREAS. SYSTEM SHALL CONFORM TO THE DESIGN CRITERIA REQUIRED BY NFPA-13 AND THE LOCAL AUTHORITY HAVING JURISDICTION. WORKING PLANS AND CALCULATIONS SHALL BE SUBMITTED TO LOCAL APPROVAL AGENCIES AND TO OWNER'S FIRE PROTECTION CONSULTANT FOR APPROVAL.
- 2. ALL WORK SHALL BE INSTALLED AND ALL MATERIALS SHALL BE IN STRICT ACCORDANCE WITH ALL APPLICABLE RULES AND REGULATIONS OF NFPA-13, 2010 EDITION AND ALL LOCAL AMENDMENTS.
- 3. IT SHALL BE THE CONTRACTOR'S RESPONSIBILITY TO COORDINATE ALL INSPECTIONS WITH THE LOCAL AUTHORITY HAVING JURISDICTION.
- 4. CONTRACTOR SHALL PROVIDE WARRANTY FOR ALL MATERIAL AND GUARANTEE ALL WORKMANSHIP FOR (1) ONE YEAR FROM SUBSTANTIAL COMPLETION OF WORK.
- DRAWINGS ARE GENERALLY DIAGRAMMATIC. ROUTING OF PIPING, ETC., AS SHOWN ON DRAWINGS, DOES NOT INTEND TO SHOW EVERY RISE, DROP, OFFSET, FITTING NOR EVERY STRUCTURAL ELEMENT THAT MAY BE ENCOUNTERED DURING THE INSTALLATION OF THIS WORK. CONTRACTOR SHALL MAKE ANY REQUIRED CHANGES FROM THE GENERAL ROUTING SHOWN ON THESE DRAWINGS, SUCH AS OFFSETS, BENDS OR CHANGES IN ELEVATION DUE TO COORDINATION WITH THE WORK OF OTHER TRADES AND BUILDING CONSTRUCTION. ALL CHANGES SHALL BE MADE WITHOUT ADDITIONAL COST TO THE OWNER OR DELAY IN COMPLETION DATE OF THE PROJECT.
- 6. ALL EXISTING PIPING INFORMATION SHOWN ON THIS DRAWING HAS BEEN OBTAINED FROM OWNER'S EXISTING CONSTRUCTION DOCUMENTS AND LIMITED FIELD SURVEY. EXACT LOCATION OF EXISTING SPRINKLER SYSTEM COMPONENTS SHALL BE FIELD VERIFIED BEFORE STARTING INSTALLATION.
- 7. CONTRACTOR SHALL VERIFY EXISTING AVAILABLE FLOW DATA WITH OWNER'S FIRE PUMP SYSTEM AND FIELD CONDITIONS. CONTRACTOR TO CONTACT ARCHITECT/ENGINEER AND LOCAL MUNICIPALITY 48 HOURS PRIOR TO FLOW TEST.
- 8. CONTRACTOR SHALL REVIEW ALL FLOOR PLANS AND DETERMINE EACH ROOM SPECIFIC HAZARD PER THE REQUIREMENTS OF NFPA-13. SPRINKLER DESIGN SHALL ADHERE TO THE STANDARDS SET FORTH IN NFPA-13.
- 9. <u>LIGHT HAZARD AREAS</u> SHALL BE DESIGNED TO 0.10 GPM PER SQUARE FOOT, 225 SQ.FT PER HEAD WITH A REMOTE AREA OF 1500 SQUARE FEET. AN AREA OF LESS THAN 1,500 SQUARE FEET MAY BE PERMITTED WHEN THE USE OF QUICK RESPONSE HEADS QUALIFIES FOR AN AREA REDUCTION. AREA SIZES SHALL BE DETERMINED BY THE REGULATIONS OF NFPA-13. ROOM TYPES SHALL INCLUDE BUT NOT BE LIMITED TO CLASSROOMS, TOILET ROOMS, CORRIDORS, VESTIBULES, MULTI-PURPOSE ROOMS, STAIRWAYS, EXAM ROOMS, OFFICE SPACES, ETC.
- 10. ALL FIRE PROTECTION PIPING SHALL BE SUSPENDED WITH APPROVED/LISTED PIPE HANGERS IN COMPLIANCE WITH NFPA STANDARDS. CUTTING STRUCTURAL MEMBERS TO RUN PIPING, OR TO FACILITATE HANGER FASTENING IS NOT PERMITTED.
- 11. VERTICAL ATTACHMENT TO METAL DECK AND WOOD TRUSS'S SHALL NOT BE PERMITTED. HORIZONTAL ATTACHMENT TO WOOD TRUSS SHALL BE MADE BY HORIZONTAL SUPPORT TO BOTTOM CORD OF TRUSS.
- 12. FIRE PROTECTION SYSTEM SHALL INCLUDE ALL ITEMS FOR A COMPLETE SYSTEM. SPECIFICALLY THIS IS TO INCLUDE BUT NOT LIMITED TO: PIPE SUPPORTS, VALVES, GAUGES, TRIM, ALARMS, SPECIALTY DEVICES, CONTROLS, AND ITEMS INCIDENTAL TO A COMPLETE SYSTEM.
- 13. CONTRACTOR SHALL PROVIDE ALL MEANS TO SHUT-DOWN EXISTING PIPING SYSTEMS WHERE REQUIRED TO COMPLETE WORK UNDER THIS CONTRACT. CONTRACTOR SHALL PROVIDE ALL NECESSARY VALVES TO ISOLATE RENOVATED SECTIONS OF THE BUILDING WITHOUT DISTURBING SECTIONS OF THE BUILDING NOT UNDER RENOVATION.
- 14. INSTALL VALVES WITH STEMS UPRIGHT OR HORIZONTAL, NOT INVERTED.
- 15. PROVIDE ACCESS TO ALL VALVES AND SYSTEM COMPONENTS REQUIRING ACCESS. ALL PIPING ACCESSORIES AND EQUIPMENT SUCH AS VALVES SHALL BE INSTALLED AT A REASONABLE HEIGHT AND POSITION IN ORDER TO FACILITATE MAINTENANCE.
- 16. ALL SPRINKLER HEADS SHALL BE LOCATED IN THE CENTER OF 2x2 TILE OR QUARTER POINT OF 2x4 CEILING TILE UNLESS OTHERWISE NOTED OR DIRECTED BY THE ARCHITECT/ENGINEER OR LOCAL FIRE DEPARTMENT AUTHORITIES.
- 17. OPTION FOR EXTENDED COVERAGE SPRINKLERS ALLOWED WHERE PRESSURE PERMITS.
- 18. ALL SPRINKLER HEADS BELOW 7'-0" FEET OR IN MECHANICAL ROOMS, STORAGE ROOMS, GYMNASIUMS OR IN AREAS SUBJECTED TO MECHANICAL INJURY SHALL HAVE AN APPROVED HEAD GUARD.
- 19. CONTRACTOR SHALL PROVIDE ADDITIONAL SPRINKLER HEADS ABOVE AND BELOW MECHANICAL/ ELECTRICAL DUCTS AND EQUIPMENT WHICH EXCEEDS 48 INCHES IN WIDTH.
- 20. FLEXIBLE CONNECTION TO SPRINKLER HEADS SHALL NOT BE PERMITTED.
- 21. SPRINKLER HEADS SHOWN ARE MINIMUMS. CONTRACTOR SHALL PROVIDE ADDITIONAL HEADS AS REQUIRED TO COORDINATE WITH ARCHITECTURAL REFLECTED CEILING PLANS OR TO PROVIDE ADEQUATE COVERAGE AS SPECIFIED OR REQUIRED BY APPROPRIATE HAZARD CLASS.
- 22. MINIMUM PIPE SIZE SHALL BE 1 INCH. ANY REDUCING OF SIZE SHALL OCCUR AT SPRINKLER HEAD CONNECTION.
- 23. SPRINKLER PIPING SHALL NOT BE INSTALLED DIRECTLY OVER ANY ELECTRICAL EQUIPMENT PANELS, TELEPHONE OR LOW VOLTAGE EQUIPMENT OR SIMILAR TYPE OF
- EQUIPMENT.

  24. ALL PIPE AND FITTINGS SHALL BE INSTALLED IN RUST-FREE CONDITION.
- 25. THE USE OF THREADED BUSHINGS WILL NOT BE PERMITTED IN ANY AREA OF THIS INSTALLATION.
- 26. ALL PIPING SHALL BE HYDROSTATICALLY TESTED @ 200 PSI FOR NO LESS THAN 2 HOURS. THE FIRE DEPARTMENT SHALL BE NOTIFIED (NO LESS THAN 48 HOURS PRIOR) OF THE DATE AND TIME OF THE TEST AND MAY WITNESS IT IF SO DESIRED OR REQUIRED.
- 27. ALL PIPING PASSING THRU' FLOOR CONSTRUCTION SHALL HAVE A SCHEDULE 40 STEEL PIPE SLEEVE INSTALLED AROUND PIPE ONLY. ALL PIPE PASSING THRU WALLS SHALL HAVE A GALVANIZED SHEET METAL OR SCHEDULE 40 STEEL PIPE SLEEVE INSTALLED AROUND THE PIPE. ALL EXPOSED PIPE WHICH PASSES THROUGH A WALL OR CEILING SHALL BE EQUIPPED WITH AN ESCUTCHEON PLATE.
- 28. ALL PIPING SHALL BE INSTALLED TO ALLOW FOR PROPER DRAINING OF ENTIRE SYSTEM PER NFPA-13.
- 29. SCREWED UNIONS SHALL NOT BE PERMITTED ON PIPING LARGER THAN 2 INCHES.
- 30. ALL NEW CONNECTIONS MADE TO AN EXISTING SYSTEM MAIN SHALL BE ACCOMPLISHED WITH A CUT-IN OR TEE FITTING OF EQUAL SIZE TO THAT OF THE EXISTING MAIN.
- 31. PROVIDE PIPE LABELING IDENTIFICATION PER ASME A13.1. SEE DETAIL FOR ADDITIONAL INFORMATION. PIPE LABELS SHALL BE WRAP AROUND TYPE. SELF ADHESIVE TYPE SHALL
- 32. GENERAL PURPOSE FIRE STOPPING SEALANT SHALL BE DOW CORNING, NELSON OR 3M COMPANY; WATER BASED, NON SLUMPING, PREMIXED SEALANT WITH INTUMESCENT PROPERTIES, RATED FOR 3 HOURS PER ASTM E814, NFPA AND UL-1479. FILL ALL VOIDS AROUND ALL PIPING PENETRATIONS THROUGH WALLS AND CEILINGS WITH A MINIMUM 1 HOUR FIRE RATING. PROVIDE PVC COLLAR ASSEMBLY AT ALL PVC PIPING PENETRATIONS THROUGH FIRE WALLS, FLOORS OR CEILING WHERE REQUIRED BY LOCAL FIRE DISTRICT.


### SPRINKLER SYMBOLS AND ABBREVIATIONS

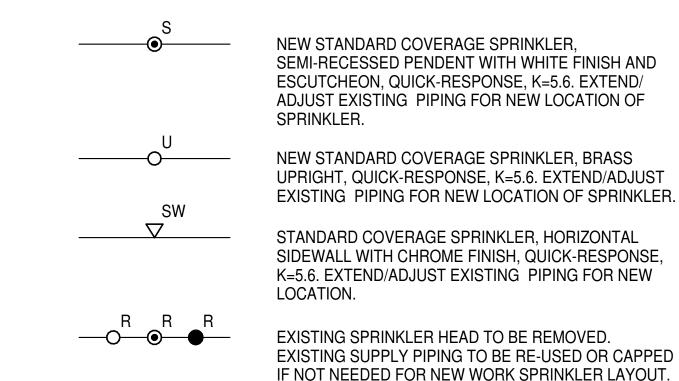


### FIRE PROTECTION SYMBOLS AND ABBREVIATIONS

EXISTING SPRINKLER TO REMAIN. PROTECT DURING

AFF.	ABOVE FINISHED FLOOR	———FP———	FIRE PROTECTION (SPRINKLER) PIPE
AP	ACCESS PANEL	<b>───</b>	GATE VALVE
BFP	BACKFLOW PREVENTER	<del></del>	CHECK VALVE
BHP	BRAKE HORSE POWER		BALL VALVE
CW	COLD WATER	<u> </u>	PRESSURE GAUGE AND NEEDLE VALVE
D	DRAIN LINE	<u>P</u>	FLOW SWITCH (WITH THREAD OR WELD-O-LET)
DN.	DOWN	<del></del>	DIRECTION OF FLOW
FP	FIRE PROTECTION	•	PIPE ELBOW (TURNED UP)
NC	NEW CONNECTION	<b>———</b>	PIPE ELBOW (TURNED DOWN)
PH	PHASE	<del></del>	PIPE TEE DOWN (DROP)
PSI	POUNDS PER SQUARE INCH	<del></del>	PIPE TEE UP
TYP.	TYPICAL		PIPE TEE UP OR ANGLE
		Ŷ	PIPE TEE DOWN OR ANGLE
		<del></del>	PIPE CAP

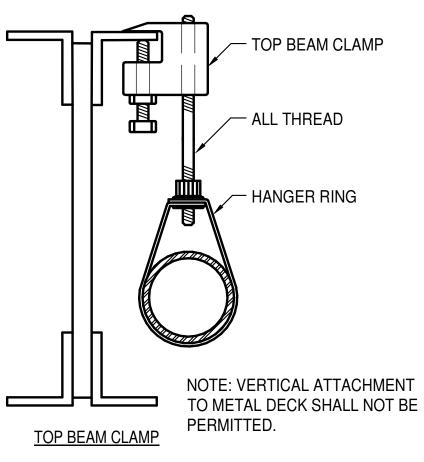


TYPICAL HANGER DETAILS

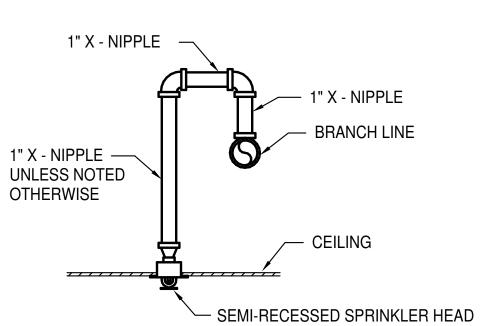


RETURN BEND DETAIL

NO SCALE

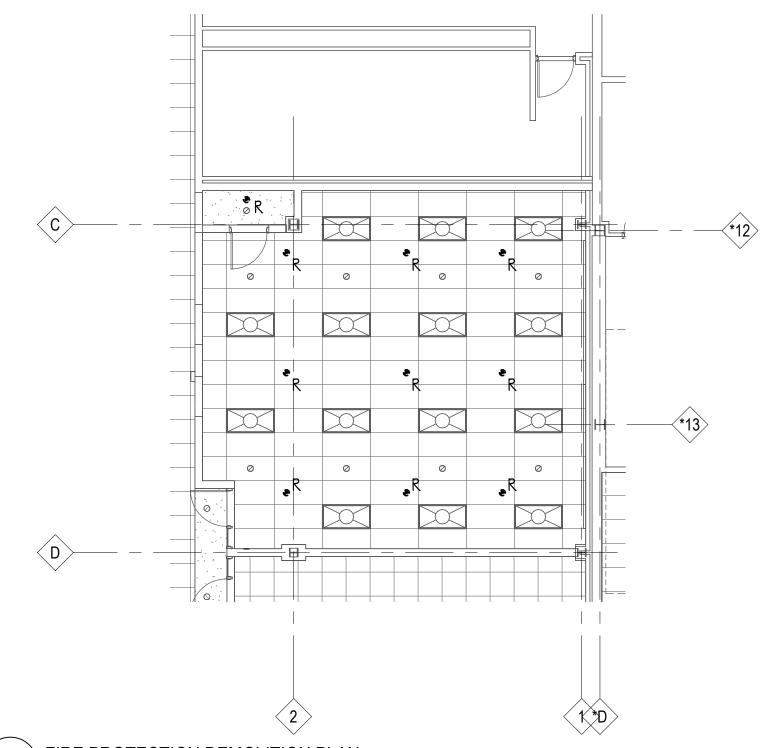

1 FIRE PROTECTION DEMOLITION PLAN
1/8" = 1'-0"

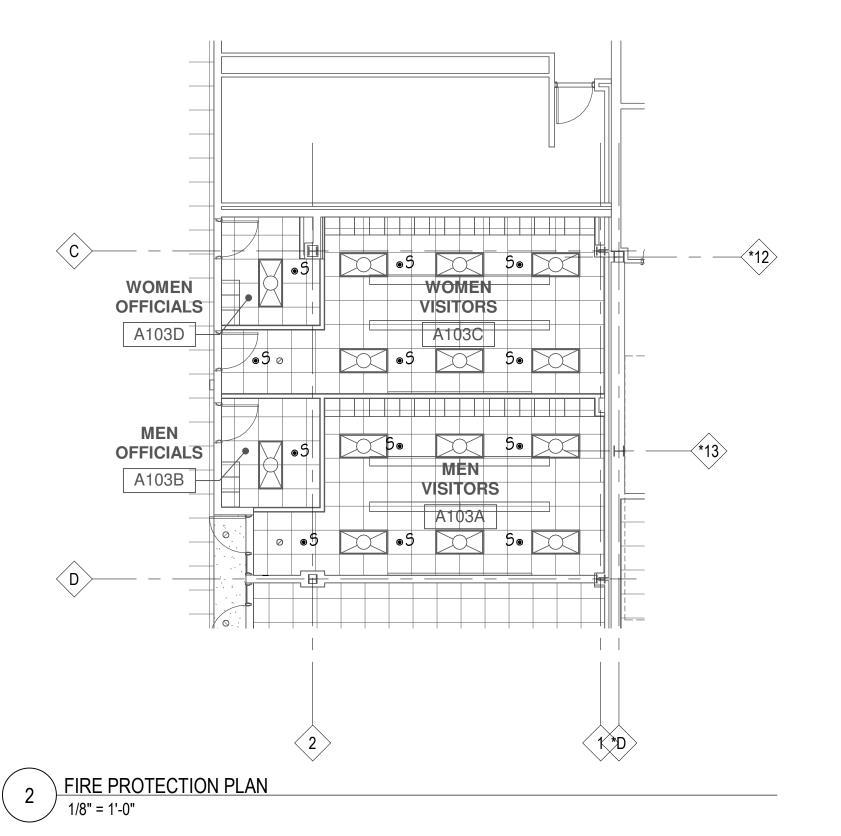

THE FOLLOWING ITEMS ARE CLARIFICATIONS TO THE CONTRACTOR REGARDING THE SHUT DOWN OF THE EXISTING SPRINKLER SYSTEM AND FIRE DEPARTMENT OPERATIONAL REQUIREMENTS

- FIRE PROTECTION SPRINKLER SYSTEM MUST REMAIN OPERATIONAL DURING TIMES THAT BUILDING IS OCCUPIED BY STUDENTS AND STAFF.
- 2. DAILY ACTIVATION AND DEACTIVATION OF THE SPRINKLER SYSTEM FOR MODIFICATION OF PIPING AND SPRINKLER INSTALLATION IS THE CONTRACTORS RESPONSIBILITY. CONTRACTOR SHALL DRAIN ZONE AS NEEDED TO PERFORM WORK. SPRINKLER SYSTEM MUST BE RESTORED TO OPERATIONAL CONDITION INCLUDING REFILLING AND VENTING OF SYSTEM AT COMPLETION OF EACH DAY'S WORK.
- 3. ALL TIMES OF SPRINKLER SYSTEM SHUT-DOWN ARE SUBJECT TO OWNERS DISCRETION AND MAY HAVE RESTRICTIONS BASED ON SCHEDULED EVENTS AT FACILITY. ALL ASPECTS OF SPRINKLER SYSTEM SHUT-DOWN SHALL BE COORDINATED WITH OWNER. CONTRACTOR MAY REQUEST TO DEVIATE FROM SCHEDULED AVAILABLE SHUT-DOWN TIMES HOWEVER OWNER SHALL REVIEW EACH REQUEST AND APPROVE OR DENY ANY SUCH REQUEST.

BIDDING NOTE

SEE DRAWING ME1.10
FOR GENERAL NOTES
AND ADDITIONAL DETAILS
APPLICABLE TO THIS
TRADE'S WORK.

ARCHITECT OF RECORD

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COUNTY COLLECAM CHANGING ROOMS

KEY PLAN:

SHEET STATUS: 04/28/2023

ISSUED FOR BIDS - NOT FOR CONSTRUCTION

NO: DESCRIPTION: DATE:

SHEET TITLE:
FIRE PROTECTION
PLANS

SHEET NUMBER:

### **EMERGENCY LIGHTING SCHEDULE**

						MANUFACTURER &	ALTERNATIVE	
SYMBOL	TAG	DESCRIPTION	MOUNTING	LAMPS	VOLTAGE	CATALOG NUMBER	MANUFACTURER	NOTES
	EMI	DUAL HEAD EMERGENCY LIGHTING UNIT WITH WHITE	SURFACE/	LED	UVOLT	LITHONIA LIGHTING	DUAL-LITE, HE WILLIAMS	1
		CONTEMPORARY THERMOPLASTIC ENCLOSURE	WALL			#ELM2L-UVOLT-LTP-SDRT		

CONNECT ALL BATTERY LIGHT FIXTURES TO LOCAL UNSWITCHED NORMAL LIGHTING CIRCUIT.

### **GENERAL NOTES**:

CONTRACTOR TO PROVIDE ALL NECESSARY MOUNTING HARDWARE AND LABOR FOR ALL DEVICES.

BATTERIES SHALL BE CAPABLE OF PROVIDING ILLUMINATION FOR A MINIMUM OF 90 MINUTES.

LIGHTING CONTROL DEVICES SCHEDULE							
SYMBOL	TYPE	DESCRIPTION	MOUNTING	MANUFACTURER & CATALOG NUMBER	ACCEPTABLE MANUFACTURERS		
\$	osA	WALL SWITCH SENSOR, LOW VOLTAGE, DUAL TECHNOLOGY	WALL	ACUITY nLIGHT #nWSXA-PDT-LV	HUBBELL LIGHTING CONTROLS, LUTRON		
0	оѕВ	EXTENDED RANGE 360°, LOW VOLTAGE, DUAL TECHNOLOGY	CEILING	ACUITY nLIGHT #nCM-PDT-10-RJB	HUBBELL LIGHTING CONTROLS, LUTRON		
\$	sA	ON/OFF SINGLE ZONE PUSH-BUTTON CONTROL STATION	WALL	ACUITY nLIGHT #nPODMA	HUBBELL LIGHTING CONTROLS, LUTRON		

### GENERAL NOTES:

- ALL SENSOR LOCATIONS ARE APPROXIMATE, REFER TO MANUFACTURERS INSTALLATION INSTRUCTIONS PRIOR TO
- INSTALLATION.
- ULTRASONIC CEILING MOUNT SENSORS SHOULD BE LOCATED A MINIMUM OF SIX FEET FROM HVAC SUPPLY/RETURN
- CONTRACTOR IS RESPONSIBLE FOR: PROPER SENSITIVITY & TIME DELAY SETTINGS (FOR NON-ADAPTIVE PRODUCTS) RECOMMENDED PLACEMENT, AND FIELD VERIFICATION OF CIRCUITS WITH IN RESPECT TO POWER PLACEMENT.
- CONTRACTOR IS RESPONSIBLE FOR FIELD VERIFICATION OF REQUIRED NUMBER OF POWER PACKS:
- ONE POWER PACK IS REQUIRED FOR EACH CIRCUIT TO BE CONTROLLED.
- ONE POWER PACK IS REQUIRED FOR EACH ZONE.
- IF MULTIPLE CIRCUITS ARE TO BE CONTROLLED BY A SENSOR, AN AUXILIARY RELAY CAN BE USED IN CONJUNCTION WITH THE POWER PACK.
- THE MAXIMUM NUMBER OF SENSORS THAT CAN BE PUT ON A POWER PACK IS TO BE REDUCED BY ONE FOR EACH SLAVE PACK USED.
- MOUNT CONTROL UNITS WITHIN JUNCTION BOXES INSTALLED PER ALL CODE REQUIREMENTS.
- CONTROL WIRING BETWEEN SENSORS AND CONTROLS UNITS SHALL BE CLASS II, 18-24 AWG, STRANDED UL
- CLASSIFIED. WHERE RETURN AIR PLENUM IS UTILIZED, ALL CONTROL WIRING SHALL BE PLENUM-RATED.
- SENSORS MOUNTED OVER THE DOOR MUST BE PLACED ONE FOOT INSIDE THE THRESHOLD. SENSOR PLACEMENT ON PLANS IS APPROXIMATE. CONTRACTOR IS RESPONSIBLE FOR ENGAGING A MANUFACTURER


PRODUCTS FROM SPECIFIED AND ACCEPTABLE MANUFACTURERS SHALL PROVIDE SAME LEVEL OF CONTROL.

- TO PRODUCE A MOTION SENSOR LAYOUT THAT IS COMPLIANT WITH THE GOVERNING ENERGY CODE.
- CONTRACTOR IS RESPONSIBLE FOR ENSURING MOTION CONTROL OF ALL LOCATIONS SHOWN ON PLAN. CONTRACTOR IS RESPONSIBLE FOR INSTALLING EQUIPMENT IN COMPLIANCE WITH LOCAL CODE.


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VISITING TEAM LOCKERS ELECTRICAL DEMOLITION

PLAN
1/8" = 1'-0"

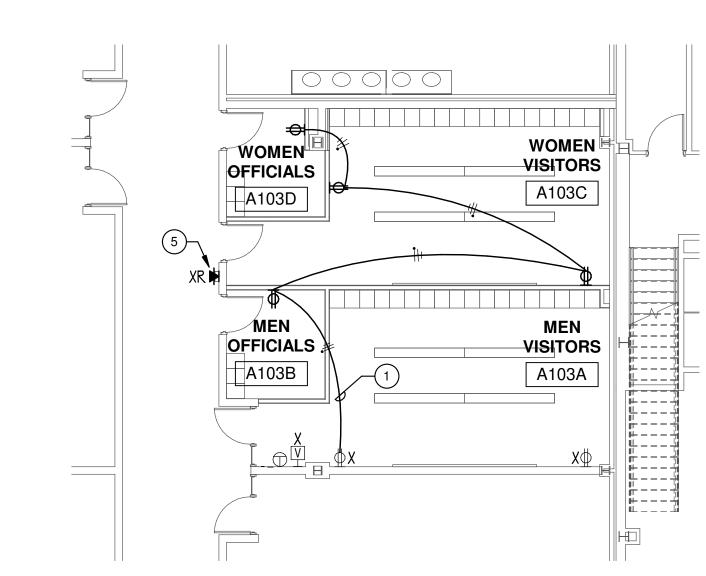

2 VISITING TEAM LOCKERS ELECTRICAL PLAN
1/8" = 1'-0"

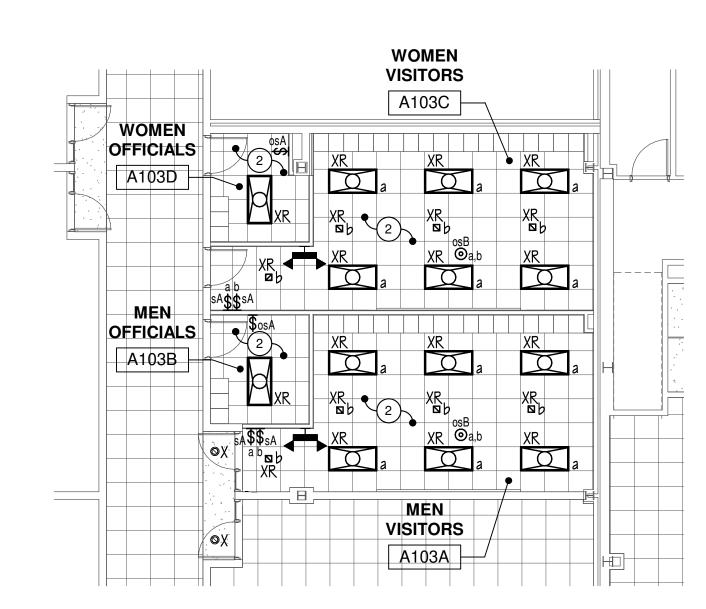

3 VISITING TEAM LOCKERS LIGHTING PLAN
1/8" = 1'-0"

### **DRAWING NOTES**

- I WIRE TO EXISTING RECEPTACLE BRANCH CIRCUIT CURRENTLY SERVING THIS AREA WITH CAPACITY. FIELD VERIFY EXACT REQUIREMENTS.
- 2 LUMINAIRES SHALL RECONNECT TO EXISTING LIGHTING BRANCH CIRCUIT SERVING AREA. PROVIDE NEW LIGHTING CONTROL AS INDICATED. FIELD VERIFY EXACT REQUIREMENTS.
- 3 CAREFULLY DISCONNECT, REMOVE AND TURN OVER EQUIPMENT TO OWNER'S
- REPRESENTATIVE. 4 CAREFULLY DISCONNECT, REMOVE, STORE AND PROTECT EXISTING WALL PHONE FOR RE-INSTALLATION AT NEW LOCATION. EXISTING CABLES SHALL BE PULLED BACK TO THE
- 5 RE-INSTALL WALL PHONE AT NEW LOCATION. RE-ROUTE EXISTING CABLE IN NEW SURFACE MOUNTED RACEWAY, WIREMOLD 700 SERIES OR EQUAL, FOR TERMINATION AT WALL PHONE. FIELD VERIFY EXACT REQUIREMENTS.

ACCESSIBLE CEILING SPACE AND PROTECTED DURING CONSTRUCTION FOR RE-USE.




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KEY PLAN:

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SHEET NUMBER:

FIRE ALARM ANNUNCIATOR PANEL.

SECURITY CAMERA. (WALL MOUNT)

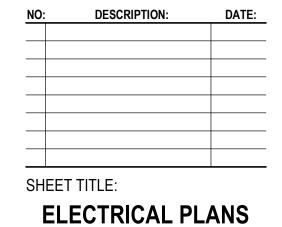ACCESS CONTROL CREDENTIAL READER.

SECURITY CAMERA. (MOUNTED IN THE ACOUSTIC CEILING TILE)

**GENERAL REMODELING NOTE:** (APPLICABLE TO ALL SHEETS.)

I. WORK SHOWN ON DRAWINGS SHALL BE CONSIDERED NEW AND IN CONTRACT UNLESS SPECIFICALLY INDICATED OTHERWISE.

- 2. DRAWINGS ARE GENERALLY DIAGRAMMATIC. ROUTING OF CONDUITS, RACEWAYS, ETC., AS SHOWN ON DRAWINGS, DOES NOT INTEND TO SHOW EVERY RISE, DROP, OFFSET, FITTING NOR EVERY STRUCTURAL ELEMENT THAT MAY BE ENCOUNTERED DURING THE INSTALLATION OF THIS WORK. EACH CONTRACTOR SHALL MAKE ANY REQUIRED CHANGES FROM THE GENERAL ROUTING SHOWN ON THESE DRAWINGS, SUCH AS OFFSETS, BENDS OR CHANGES IN ELEVATION DUE TO COORDINATION WITH THE WORK OF OTHER TRADES AND BUILDING CONSTRUCTION. ALL CHANGES SHALL BE MADE WITHOUT ADDITIONAL COST TO THE OWNER OR DELAY IN COMPLETION DATE OF THE PROJECT.
- 3. IT IS INTENDED THAT EQUIPMENT SHALL BE LOCATED SYMMETRICALLY WITH THE ARCHITECTURAL ELEMENTS OF THE BUILDING, NOTWITHSTANDING THE FACT THAT LOCATIONS INDICATED BY THESE DRAWINGS MAY BE DISTORTED FOR CLEARNESS OF PRESENTATION.
- 4. CONTRACTOR SHALL CHECK DRAWINGS OF OTHER TRADES TO VERIFY THAT SPACES IN WHICH THEIR WORK WILL BE INSTALLED ARE CLEAR OF OBSTRUCTIONS. WORK SHALL BE INSTALLED TO MAINTAIN MAXIMUM HEADROOM AND SPACE CONDITIONS AT ALL POINTS IN THE BUILDING. WHERE HEADROOM OR SPACE CONDITIONS APPEAR INADEQUATE, CONTRACTOR SHALL NOTIFY ARCHITECT/ENGINEER BEFORE PROCEEDING WITH THE INSTALLATION OF THEIR WORK.
- CONTRACTOR SHALL FURNISH OTHER TRADES ADVANCE INFORMATION AND/OR SHOP DRAWINGS ON LOCATIONS AND SIZES OF PIPING. DUCTWORK. CONDUIT. RACEWAYS, EQUIPMENT, FRAMES, BOXES, SLEEVES AND OPENINGS, ETC. NEEDED FOR THEIR WORK TO PERMIT OTHER TRADES AFFECTED TO INSTALL THEIR WORK PROPERLY AND WITHOUT DELAY.
- 6. WHERE THERE IS EVIDENCE THAT WORK OF ONE TRADE WILL INTERFERE WITH WORK OF OTHER TRADES, ALL TRADES SHALL MEET ON JOB SITE TO WORK OUT SPACE CONDITIONS AND MAKE SATISFACTORY ADJUSTMENTS TO INSTALLATION OF THE NEW WORK. CONTRACTORS SHALL VERIFY EXACT LOCATIONS OF ALL DEVICES AND EQUIPMENT WITH FIELD CONDITIONS, SHOP DRAWINGS, AND WORK OF OTHER TRADES PRIOR TO ROUGH-IN. EACH CONTRACTOR SHALL BE RESPONSIBLE, AT THEIR OWN EXPENSE. FOR THE REMOVAL AND REINSTALLATION OF ANY PART OF THEIR WORK IF SAME WAS INSTALLED WITHOUT CONSULTING WITH OTHER TRADES BEFORE INSTALLING THEIR WORK.
- CONTRACTOR SHALL PROVIDE SLEEVES IN BEAMS, FLOORS, COLUMNS AND WALLS AS SHOWN ON THE DRAWINGS, AS REQUIRED BY JOB SITE CONDITIONS, AND/OR AS SPECIFIED, WHEN INSTALLING THEIR WORK. ALL BEAMS AND COLUMNS WHICH ARE REQUIRED TO BE SLEEVED SHALL BE CUT AND REINFORCED AS REQUIRED BY FIELD CONDITIONS AND LOCATIONS AND SIZES SHALL BE CHECKED AND APPROVED BY ARCHITECT BEFORE CONTRACTOR CUTS ANY STRUCTURAL BUILDING MEMBER
- 8. THE SEQUENCE FOR THE INSTALLATION OF ALL WORK SHALL BE COORDINATED BETWEEN ALL CONTRACTORS ON THE PROJECT AND IN STRICT ACCORDANCE WITH ARCHITECT/ENGINEER AND OWNERS STIPULATION AS DIRECTED.
- 9. CONTRACTOR SHALL REFER TO THE ARCHITECTURAL AND STRUCTURAL CONTRACT DRAWINGS (BEFORE SUBMITTING THEIR BIDS) TO FAMILIARIZE THEMSELVES WITH THE EXTENT OF THE GENERAL CONTRACTORS WORK. CEILING HEIGHTS AND CLEARANCE FOR INSTALLING THEIR WORK
- 10. CONTRACTOR SHALL BE RESPONSIBLE AND PAY FOR ALL CORING, CUTTING, PATCHING, REPAIRING, REFINISHING AND REMOVAL/REPLACEMENT OF NEW BUILDING CONSTRUCTION REQUIRED TO ACCOMMODATE THE INSTALLATION OR REMOVAL OF THEIR WORK. REMOVE, STORE AND REINSTALL CEILING TILES AS REQUIRED TO INSTALL WORK ABOVE EXISTING CEILINGS WHICH REMAIN. REPLACE TILES BROKEN OR DAMAGED DURING CONSTRUCTION. ALL PATCHING, REPAIRING AND REFINISHING WORK SHALL BE PERFORMED BY THOSE REGULARLY INVOLVED IN THAT TRADE AND SHALL MATCH THE ADJACENT CONSTRUCTION AS CLOSELY AS POSSIBLE. CARE SHALL BE TAKEN SO AS NOT TO DAMAGE ANY EXISTING BUILDING CONSTRUCTION OR ITEMS THAT ARE TO REMAIN. ANY EXISTING FINISHES THAT ARE DAMAGED DURING THE INSTALLATION OF NEW WORK OR REMOVAL OF EXISTING WORK SHALL BE REPAIRED, REPLACED AND PAID FOR BY THE INSTALLING CONTRACTOR, TO THE SATISFACTION OF THE ARCHITECT AND OWNER. REFER TO ARCHITECTURAL DRAWINGS FOR EXISTING BUILDING CONSTRUCTION THAT IS TO REMAIN AND, THEREFORE, SUBJECT TO PATCHING, REPAIRING, REFINISHING, AND REMOVAL/REPLACEMENT.
- II. CONTRACTOR SHALL BE RESPONSIBLE FOR THEIR OWN CLEAN-UP DURING CONSTRUCTION. IF CONTRACTOR FAILS TO PROVIDE SUCH CLEAN-UP, THE ARCHITECT/ENGINEER WILL DIRECT ANOTHER CONTRACTOR TO PERFORM THE CLEAN-UP AND THE NEGLIGENT CONTRACTOR SHALL PAY THE ASSOCIATED BACK-CHARGES
- 12. CONTRACTOR SHALL INSTALL ALL AUXILIARY SUPPORTING STEEL AS REQUIRED FOR THE SUPPORTING OF THEIR CONDUIT, EQUIPMENT, ETC. ALL SUPPORTING STEEL FOR ITEMS ABOVE A SUSPENDED CEILING SHALL BE FROM BUILDING STRUCTURAL MEMBERS ONLY.
- 13. IT IS MANDATORY THAT THE COMPLETE EXISTING BUILDING REMAIN IN CONTINUOUS AND NON-INTERRUPTED OPERATION DURING REMODELING/ALTERING OF SAID EXISTING BUILDING. THE SPECIFIC AREA(S) BEING REMODELED/ALTERED AT ANY SCHEDULED TIME ARE OBVIOUSLY EXCLUSIVE OF THIS STATEMENT. SERVICES TO EXISTING BUILDING SHALL BE KEPT IN CONTINUOUS OPERATION INCLUDING POWER, SIGNAL SYSTEMS, LIGHTING, TELEPHONE, HEATING, COOLING, VENTILATING, TEMPERATURE CONTROL. ANY ABSOLUTELY NECESSARY INTERRUPTION OF THESE SERVICES TO ACCOMPLISH CONTRACT WORK SHALL BE ARRANGED WITH THE OWNER. A MINIMUM OF TEN (10) WORKING DAYS IN ADVANCE. SUCH INTERRUPTIONS SHALL BE KEPT TO AN ABSOLUTE MINIMUM AS FAR AS TIME INTERVAL IS INVOLVED AND TEMPORARY SERVICES SHALL BE FURNISHED AND INSTALLED UNDER THIS CONTRACT WHERE NECESSARY TO ACCOMPLISH THIS PURPOSE. TEMPORARIES SHALL BE REMOVED BY THE CONTRACTOR ONLY AFTER NEW PERMANENT SERVICES ARE INSTALLED AND FULLY OPERATIONAL
- 14. UNLESS INDICATED OTHERWISE. THE ARCHITECT/ENGINEER MAKES NO REPRESENTATION AS TO WHETHER OR NOT ANY HAZARDOUS OR CONTAMINATED MATERIALS (INCLUDING BUT NOT LIMITED TO ASBESTOS, PCB'S, CONTAMINATED SOILS, ETC.) ARE PRESENT WITHIN THE EXISTING BUILDING OR ON THE SITE. WORK SHOWN ON THE DRAWINGS AND/OR INDICATED IN THE SPECIFICATIONS SHALL NOT BE CONSTRUED TO CALL FOR CONTACT WITH ANY OF THESE MATERIALS. IF THESE MATERIALS ARE ENCOUNTERED OR SUSPECTED, THE CONTRACTOR SHALL NOT DISTURB THEM AND SHALL CONTACT THE ARCHITECT/ENGINEER IMMEDIATELY
- 15. CONTRACTOR SHALL STORE ALL MATERIALS AND EQUIPMENT SHIPPED TO THE SITE IN A PROTECTED AREA. IF MATERIAL IS STORED OUTSIDE OF THE BUILDING, IT MUST BE STORED OFF THE GROUND A MINIMUM OF SIX INCHES (6") SET ON 6 X 6 PLANKS AND/OR WOOD PALLETS. ALL MATERIAL AND EQUIPMENT MUST BE COMPLETELY COVERED WITH WATERPROOF TARPS OR VISQUIN. ALL CONDUIT WILL HAVE THE ENDS CLOSED TO KEEP OUT DIRT AND OTHER DEBRIS. NO EQUIPMENT WILL BE ALLOWED TO BE STORED ON THE SITE UNLESS IT IS SITTING ON WOOD PLANKS AND COMPLETELY PROTECTED WITH WEATHERPROOF COVERS.
- 16. THE DRAWINGS, SCHEDULES AND SPECIFICATIONS HAVE BEEN PREPARED USING ONE MANUFACTURER FOR EACH PIECE OF EQUIPMENT AS THE BASIS FOR DIMENSIONAL DESIGN. IF THE CONTRACTOR PURCHASES EQUIPMENT FROM A SPECIFIED ACCEPTABLE MANUFACTURER, BUT NOT THE SCHEDULED MANUFACTURER USED FOR THE BASE DESIGN, THE CONTRACTOR SHALL BE RESPONSIBLE FOR CHECKING ALL THE DIMENSIONS OF THE EQUIPMENT TO VERIFY THAT IT WILL FIT IN THE SPACE SHOWN ON THE DRAWINGS. MINOR DEVIATIONS IN DIMENSIONS WILL BE PERMITTED, PROVIDED THE RATINGS MEET THOSE SHOWN ON THE DRAWINGS AND EQUIPMENT WILL PHYSICALLY FIT INTO THE SPACE ALLOCATED WITH SUITABLE ACCESS AROUND EQUIPMENT FOR OPERATION AND MAINTENANCE OF THE EQUIPMENT. WHEN EQUIPMENT SUBMITTED FOR REVIEW DOES NOT MEET THE PHYSICAL SIZE OR ARRANGEMENT OF THAT SCHEDULED AND SPECIFIED, CONTRACTOR SHALL PAY FOR ALL ALTERATIONS REQUIRED TO ACCOMMODATE SUCH EQUIPMENT AT NO ADDITIONAL COST TO THE OWNER. CONTRACTOR WILL ALSO PAY ALL COSTS FOR ADDITIONAL WORK REQUIRED BY OTHER CONTRACTORS, OWNER, ARCHITECT OR ENGINEER TO MAKE CHANGES WHICH WOULD ALLOW THE EQUIPMENT TO FIT IN THE SPACE AND FUNCTION AS INTENDED.
- 17. CONTRACTOR AND/OR MANUFACTURER SHALL VERIFY THAT THE CHARACTERISTICS OF THE EQUIPMENT HE SUBMITS FOR REVIEW MEET THE CAPACITY AND DUTY SPECIFIED.
- 18. CONTRACTOR SHALL BE RESPONSIBLE FOR OBTAINING ALL NECESSARY PERMITS AND THEIR ASSOCIATED FEES.

### **GENERAL NOTE:**

CONTRACTOR SHALL MAINTAIN FIRE RATING OF ALL PARTITIONS FOR NEW PENETRATIONS. ANY PENETRATIONS THROUGH WALLS AND FLOORS SHALL BE PROPERLY SEALED AND TREATED TO MAINTAIN THE FIRE STOPPING RATING OF THE WALL. CABLING SHALL NOT PENETRATE WALLS UNLESS ROUTED THROUGH RACEWAY SYSTEM OR ROUTED ABOVE ACCESSIBLE CEILINGS THROUGH METALLIC CONDUIT SLEEVES, EXTENDING A MINIMUM OF 6" EACH SIDE OF THE WALL WITH PROTECTIVE END BUSHINGS TO PREVENT DAMAGE TO CABLES. VOIDS AROUND SLEEVES SHALL BE SEALED WITH APPROPRIATE MATERIALS AS TO MAINTAIN THE ACOUSTIC OR FIRE RATING OF WALLS ABOVE AND BELOW CEILINGS. CABLES RAN THROUGH VOIDS WITHOUT SLEEVES OR RACEWAYS WILL NOT BE ACCEPTABLE. CONTRACTOR SHALL VERIFY EXISTING FIRE PARTITIONS IN THE FIELD.

### **GENERAL NOTE:**

INCIDENTAL WORK MAY ALSO BE NECESSARY DUE TO CHANGES AFFECTING, FIRE ALARM, ELECTRICAL, OR OTHER SYSTEMS. SUCH INCIDENTAL WORK IS ALSO PART OF THIS CONTRACT. INSPECT THOSE AREAS, ASCERTAIN WORK NEEDED, AND DO THAT WORK IN ACCORD WITH THE CONTRACT REQUIREMENTS, AT NO ADDITIONAL COST. THE REMOVAL \$ REINSTALLATION OF EXISTING WORK TO ACCOMMODATE CHANGES TO EXISTING, OR INSTALLATION OF, ELECTRICAL, OTHER SYSTEMS IS ALSO PART OF THIS CONTRACT.

### **GENERAL NOTE:** REFER TO ARCHITECTURAL FLOOR PLANS FOR ADDITIONAL INFORMATION

REGARDING MOUNTING HEIGHTS AND LOCATIONS OF ELECTRICAL DEVICES BEFORE ROUGH-IN.

WHERE CONFLICTS BETWEEN ELECTRICAL & ARCHITECTURAL ELEVATIONS ARISE, CONTRACTOR TO VERIFY WITH ARCHITECT/ENGINEER TEAM PRIOR TO ROUGH-IN.

### **GENERAL NOTE:**

WORK.

EXISTING CONDITIONS WERE OBTAINED FROM EXISTING AS-BUILT DRAWINGS AND CURSORY FIELD OBSERVATION. THIS CONTRACTOR SHALL IDENTIFY ANY DISCREPANCIES IN THE FIELD AND REPORT THEM TO THE ENGINEER.

**BIDDING NOTE:** SEE DRAWINGS MEI. 10 FOR GENERAL NOTES AND

ADDITIONAL DETAILS APPLICABLE TO THIS TRADE'S

GENERAL ELECTRICAL DEMOLITION NOTES: (APPLICABLE TO ALL SHEETS.)

1. ALL INDICATED ELECTRICAL EQUIPMENT, LUMINAIRES, DEVICES, AND RELATED CONDUIT AND CABLING TO BE REMOVED UNLESS NOTED OTHERWISE.

- 2. ALL DEMOLITION OF THE ELECTRICAL SYSTEM AS NOTED ON THE DEMOLITION DRAWINGS SHALL BE COORDINATED WITH THE RENOVATION REQUIREMENTS TO DETERMINE THIS CONTRACTOR'S WORK.
- 3. IT IS THE INTENT OF THE ELECTRICAL DEMOLITION DRAWING(S) TO INDICATE AREAS IN WHICH ELECTRICAL EQUIPMENT, CONDUIT, LUMINAIRES, DEVICES, ETC. NEED TO BE REMOVED. RELOCATED. OR MODIFIED BY THIS CONTRACTOR TO ALLOW FOR THE RENOVATION PHASE OF CONSTRUCTION. THE ELECTRICAL DEMOLITION PLAN IS FOR REFERENCE PURPOSES ONLY AND IT IS NOT INTENDED TO BE THE SOLE SOURCE OF EXISTING CONDITIONS.
- 4. CONTRACTOR SHALL VISIT THE BUILDING, BEFORE SUBMITTING THEIR BID, TO VERIFY THE EXISTING CONDITIONS WHICH WILL AFFECT THEIR WORK.
- 5. CONTRACTOR SHALL BE RESPONSIBLE FOR THE COMPLETE ELECTRICAL DEMOLITION REQUIRED TO ACCOMMODATE THE RENOVATION. REMOVE AS REQUIRED ALL LUMINAIRES, CONNECTIONS TO MECHANICAL EQUIPMENT, DEVICES, ETC.. PULL OUT ALL UNUSED CONDUCTORS AND CABLES, AND REMOVE ALL ABANDONED CONDUIT. ELECTRICALLY DISCONNECT AIR HANDLING UNITS, PUMPS, BOILERS, AND OTHER SUCH EQUIPMENT FOR REMOVAL BY OTHERS. BACKFEED AS REQUIRED ALL DOWNSTREAM DEVICES WHICH REMAIN. (THE CONTRACTOR SHALL COORDINATE WITH THE OWNER WHICH ITEMS INDICATED TO BE REMOVED \$ DISCONNECTED SHALL BE SALVAGED AND PRESENTED TO THE OWNER PRIOR TO ANY DISPOSAL OF THESE ITEMS.)
- 6. ALL REMOVED EQUIPMENT SHALL BECOME THE PROPERTY OF THE CONTRACTOR AND SHALL BE REMOVED FROM THE SITE. WHERE WORK CALLED FOR ON THE DRAWINGS OR IN THE SPECIFICATIONS INVOLVES THE REMOVAL OF FLUORESCENT LAMPS CONTAINING MERCURY OR CLOTH INSULATED CONDUCTORS, THEY SHALL BE PROPERLY HANDLED AND REMOVED FROM SITE BY APPROVED METHODS PER EPA REGULATIONS.
- 7. ALL EXISTING RECEPTACLES/DATA OUTLETS/DEVICES/EQUIPMENT THAT ARE NOT PART OF DEMOLITION SHALL REMAIN AS IS UNLESS NOTED OTHERWISE. CONTRACTOR SHALL CHECK AND VERIFY FOR CONTINUING OPERATION OF THESE DEVICES PRIOR TO SUBSTANTIAL COMPLETION. IF ANY EXISTING CIRCUITS TO REMAIN ARE INTERRUPTED BY DEMOLITION OR NEW CONSTRUCTION. CONTRACTOR SHALL BE RESPONSIBLE FOR REPLACEMENT/REMOVAL/REROUTING/MODIFICATION OF CONDUITS AND WIRES INCLUDING EXTENSION, AS REQUIRED TO MAINTAIN FUNCTIONALITY OF DOWNSTREAM RECEPTACLES/DATA OUTLETS/DEVICES/EQUIPMENT.
- 8. THE CONTRACTOR SHALL COORDINATE WITH THE PROJECT PHASING AND MAINTAIN EXISTING SYSTEMS ACTIVE IN AREAS WHICH REMAIN OCCUPIED.
- 9. EXISTING CEILING MOUNTED SPEAKERS, PROGRAM BELLS, FIRE ALARM DEVICES, AND SIMILAR ELECTRICAL EQUIPMENT AND DEVICES TO REMAIN SHALL BE EXTENDED AND REINSTALLED AS REQUIRED IN NEW CEILINGS. FIELD VERIFY EXACT QUANTITIES AND REQUIREMENTS.
- 10. SUPPORT ALL CABLING DRAPED OR LYING LOOSE ABOVE EXISTING CEILINGS WHICH ARE SCHEDULED TO BE REMOVED. TIE WRAP CABLING TO JOISTS OR OTHER STRUCTURAL MEMBERS AS REQUIRED. UPON THE COMPLETION OF THE PROJECT, NO CABLING SHALL BE LYING ON ACCESSIBLE CEILINGS.
- II. WHERE EXISTING DEVICE IS REMOVED FROM WALL WITH NO NEW DEVICE GOING BACK AT SAME LOCATION, PROVIDE BLANK BRUSHED STAINLESS STEEL COVER PLATES AS REQUIRED. COVER PLATES SHALL BE OF PROPER SIZE AND INSTALLED FLUSH WITH WALL.

### GENERAL ELECTRICAL NOTES: (APPLICABLE TO ALL SHEETS.)

1. THE MINIMUM WIRE SIZE SHALL BE #12 AWG. THE MINIMUM CONDUIT SIZE FOR HOMERUNS AND BRANCH FEEDS TO POWER OUTLETS SHALL BE 3/4". 1/2" CONDUIT IS ACCEPTABLE FOR BRANCH WIRING TO END OF THE LINE RECEPTACLES ONLY. ALL BRANCH CIRCUITS SHALL TERMINATE AT 20A-1P CIRCUIT BREAKERS IN PANELBOARD INDICATED UNLESS NOTED OTHERWISE.

- PROVIDE ALL PENETRATIONS, SLEEVES, AND SEALANT AS REQUIRED THROUGH PARTITIONS TO ACCOMMODATE THE FIRE ALARM, PAGING, CLOCK, VOICE, AND DATA CABLING. ANY PENETRATIONS THROUGH WALLS AND FLOORS SHALL BE PROPERLY SEALED AND TREATED TO MAINTAIN THE FIRE STOPPING RATING OF THE WALLS, FLOORS,
- 3. BACKBOXES ARE TO BE MOUNTED OFFSET. NOT BACK TO BACK.
- 4. CIRCUIT NUMBER(S), WHERE SHOWN, ARE TO INDICATE QUANTITY OF CIRCUITS REQUIRED. VERIFY EXACT CIRCUIT NUMBER TO BE UTILIZED IN FIELD. CONTRACTOR SHALL PROVIDE ACTUAL CIRCUITING AS PART OF "AS BUILT" DRAWINGS.
- 5. UNLESS INDICATED OTHERWISE, ALL MATERIALS REQUIRED TO PROVIDE BRANCH CIRCUITS AND FEEDERS ARE TO BE NEW.
- 6. DURING THE COURSE OF INVESTIGATION AND DEMOLITION, IF IT IS DETERMINED THAT IT MAY BE FEASIBLE TO UTILIZE EXISTING MATERIALS FOR BRANCH CIRCUITS AND FEEDERS, CONTRACTOR SHALL NOTIFY ENGINEER FOR APPROVAL PRIOR TO PERFORMING ANY WORK.
- 7. ANY ELECTRICAL DEVICES ON NEW WALLS SHALL BE FLUSH MOUNTED. NO WIREMOLDS ARE ACCEPTABLE ON NEW WALLS UNLESS NOTED OTHERWISE
- VERIFY RECEPTACLE LOCATIONS WITH ARCHITECTURAL FURNITURE LAYOUT TO ENSURE PROPER ACCESSIBILITY.
- 9. DRAWINGS DO NOT REPRESENT ALL EXISTING FIRE ALARM DEVICES. INITIATING AND NOTIFICATION DEVICES NOT SHOWN ON THE DRAWINGS ARE EXISTING TO REMAIN. IT IS THE CONTRACTOR'S RESPONSIBILITY TO MAINTAIN OPERATION OF THE EXISTING DEVICES NOT SHOWN.
- 10. EXISTING FIRE ALARM SYSTEM SHALL BE OPERATIONAL AT ALL TIMES. THE OCCUPIED AREA OF THE BUILDING SHALL NOT BE LEFT UNPROTECTED AT ANY TIME. IF AN INTERRUPTION OF FIRE ALARM SYSTEM IS REQUIRED TO FACILITATE DEVICE INSTALLATION, PROVIDE 48 HOURS OF ADVANCE NOTICE TO THE OWNER AND THE LOCAL FIRE DEPARTMENT. CONTRACTOR SHALL HIRE AN AUTHORIZED PERSONNEL TO WATCH/GUARD ANY UNPROTECTED AREAS OF THE BUILDING WHERE NECESSARY.
- II. REMOVE AND REINSTALL CEILING MOUNTED DEVICES AS REQUIRED TO ALLOW INSTALLATION OF FEEDERS, BRANCH CIRCUITS, MECHANICAL PIPING, AND DUCT WORK. DEVICES INCLUDE BUT ARE NOT LIMITED TO: LUMINAIRES, SPEAKERS, FIRE ALARM, AND PAGING DEVICES.
- 12. PROVIDE PULL BOX(ES) BETWEEN PULL POINTS AS REQUIRED TO COMPLY WITH NEC 344.26 SUCH THAT THERE SHALL NOT BE MORE THAN THE EQUIVALENT OF FOUR QUARTER BENDS (360 DEGREE TOTAL) BETWEEN PULL POINTS.
- 13. SPECIAL ATTENTION SHALL BE PAID TO ALL CONDUIT ROUTING IN OPEN CEILING SPACE FOR AESTHETIC PURPOSES. ALL EXPOSED CONDUITS SHALL BE ROUTED PERPENDICULAR AND PARALLEL TO BUILDING LINES AND TIGHT TO CEILING/STRUCTURAL CORNERS. WHERE THIS IS NOT FEASIBLE, SUBMIT CONDUIT ROUTING PLAN TO ARCHITECT/ENGINEER FOR APPROVAL PRIOR TO INSTALLATION.
- 14. IN RENOVATIONS, IF AN EXISTING RECEPTACLE/JUNCTION BOX LOCATION WILL END UP HIDDEN BEHIND PERMANENTLY INSTALLED EQUIPMENT OR CASEWORK, PROCEED AS NOTED BELOW:
- A. IF THE RECEPTACLE IS AN END OF LINE DEVICE (IT DOES NOT FEED OTHER DEVICES), IT SHALL BE REMOVED INCLUDING ASSOCIATED WIRING BACK TO LAST ACTIVE DEVICE OR JUNCTION BOX AND A BLANK COVER PLATE INSTALLED. B. IF THE RECEPTACLE DOES SERVE DOWNSTREAM DEVICES, REMOVE RECEPTACLE AND REWORK WIRING TO A NEW OR EXISTING JUNCTION BOX ABOVE CEILING SUCH THAT NO WIRES ARE PRESENT IN THE JUNCTION BOX. A BLANK COVER PLATE SHALL BE INSTALLED.
- 15. CONTRACTOR SHALL PROVIDE DEDICATED NEUTRAL FOR EACH BRANCH CIRCUIT TO MEET THE REQUIREMENTS OF NEC ARTICLE 210.4(B).
- 16. IN JUNCTION BOXES WHERE CURRENT CARRYING CONDUCTORS ARE SPLICED OR TERMINATED, PROVIDE BOND TO JUNCTION BOX FROM EQUIPMENT GROUNDING CONDUCTOR.
- 17. IN AREAS OF THE BUILDING WHERE NEW CEILING HEIGHT IS HIGHER THAN THE EXISTING CEILING HEIGHT, ANY EXISTING CONDUITS/CONDUCTORS AND JUNCTION BOXES SERVING EXISTING DEVICES/EQUIPEMNT TO REMAIN SHALL BE RE-ROUTED. RELOCATED. AND MODIFIED AS REQUIRED TO ACCOMMODATE NEW CEILING HEIGHT. FIELD VERIFY EXACT CONDITIONS.
- 18. IN AREAS OF THE BUILDING WHERE NEW DRYWALL OR PLASTER CEILING IS SCHEDULED TO BE INSTALLED, ANY EXISTING JUNCTION BOXES AND ASSOCIATED CONDUITS/CONDUCTORS SHALL BE MODIFIED AND RELOCATED AS REQUIRED TO AN ACCESSIBLE LOCATION UNLESS NEW ACCESS PANELS ARE PERMITTED TO BE INSTALLED IN NEW CEILING BY THE ARCHITECT.
- 19. REFER TO MECHANICAL PLANS FOR EXACT LOCATIONS OF THERMOSTAT/CARBON DIOXIDE DETECTORS. PROVIDE SINGLE GANG BACKBOX AND EMPTY 3/4" CONDUIT WITH PULL STRING STUBBED INTO ACCESSIBLE CEILING SPACE FOR INSTALLATION OF THERMOSTAT/CARBON DIOXIDE DETECTORS. CABLING AND DEVICE SHALL BE BY OTHERS.
- 20. CONDUCTORS FOR EQUIPMENT RATED 100AMP. AND BELOW ARE SIZED PER ARTICLE 110.14(C)(1)(a)(2) WHICH INDICATES TO UTILIZE THE 60° TEMPERATURE RATING COLUMN OF TABLE 310.15(B)(16) REGARDLESS OF CONDUCTOR INSULATION RATING.

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MEP/FP ENGINEER 20/10 ENGINEERING GROUP 1216 TOWER ROAD SCHAUMBURG, IL 60193 P: 847.882.2010

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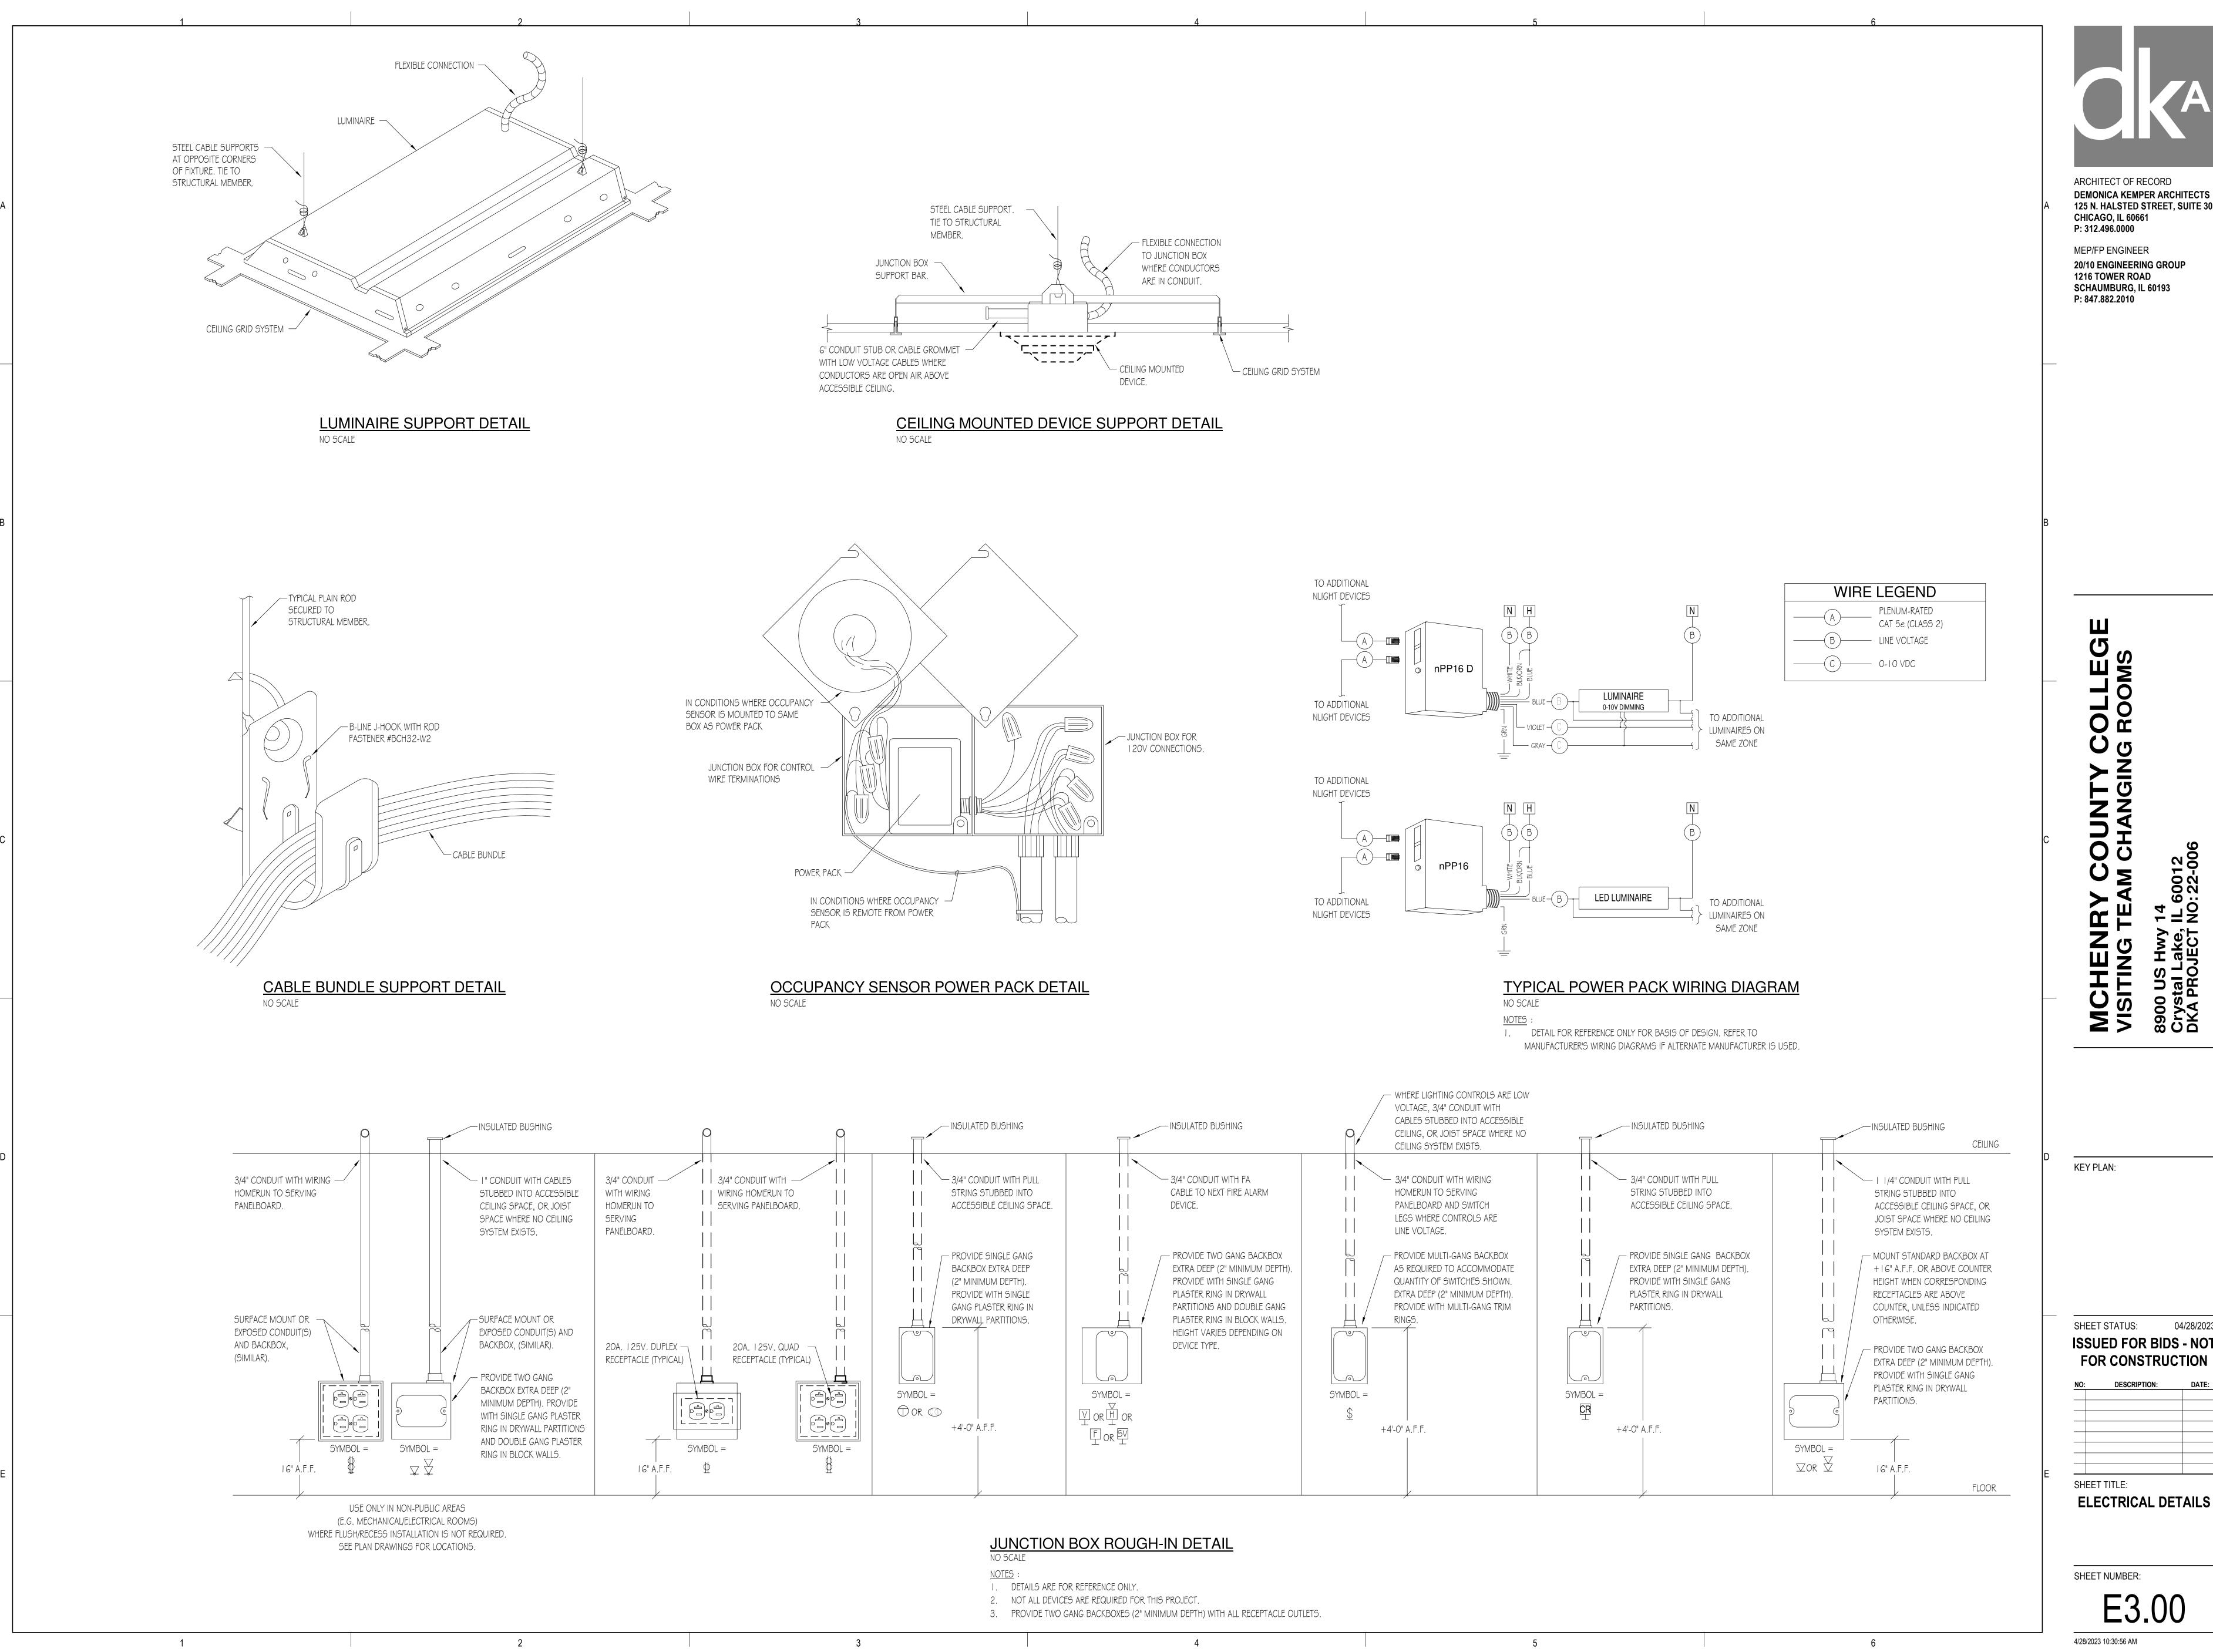
KEY PLAN:

SHEET STATUS: 04/28/2023 ISSUED FOR BIDS - NOT FOR CONSTRUCTION DESCRIPTION: DATE:

SHEET TITLE: **ELECTRICAL SYMBOL** 

SHEET NUMBER:

LIST AND NOTES



ARCHITECT OF RECORD **DEMONICA KEMPER ARCHITECTS** 125 N. HALSTED STREET, SUITE 301 **CHICAGO, IL 60661** P: 312.496.0000

MEP/FP ENGINEER 20/10 ENGINEERING GROUP 1216 TOWER ROAD SCHAUMBURG, IL 60193

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KEY PLAN:

04/28/2023 SHEET STATUS: **ISSUED FOR BIDS - NOT** 

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**ELECTRICAL DETAILS** 

SHEET NUMBER: E3.00

### I. SCOPE

THE WORK COVERED BY THIS SPECIFICATION INCLUDES THE COMPLETE ELECTRICAL SYSTEM.

THE WORK TO BE PERFORMED UNDER THE ELECTRICAL SPECIFICATIONS AND DRAWINGS CONSISTS OF FURNISHING ALL LABOR AND MATERIAL FOR THE COMPLETE INSTALLATION OF ELECTRICAL SYSTEMS, INCLUDING BUT NOT LIMITED TO THE FOLLOWING:

- A. CONDUIT AND WIRING
- B. WIRING DEVICES
- C. LUMINAIRES

### D. LIGHTING CONTROL SYSTEM

2. GENERAL THIS SPECIFICATION IS INCLUSIVE FOR EACH ITEM REQUIRING ALL LABOR, MATERIAL, AND EQUIPMENT NECESSARY TO PROPERLY INSTALL, ALTER, ADJUST, AND PUT INTO OPERATION THE COMPLETE ELECTRICAL SYSTEM.

THE CONTRACTOR IS RESPONSIBLE FOR THE PROPER LAYOUT AND CONSTRUCTION OF THE WORK INCLUDED IN THIS CONTRACT.

THE DRAWINGS AND SPECIFICATIONS SHALL BE UNDERSTOOD TO COVER, ACCORDING TO THEIR INTENT AND MEANING, COMPLETE SYSTEMS AS DESCRIBED

MINOR ITEMS, ACCESSORIES, AND DEVICES REASONABLY INFERABLE AS NECESSARY FOR THE COMPLETE AND PROPER OPERATION OF ANY SYSTEM SHALL BE PROVIDED BY THE CONTRACTOR FOR SUCH SYSTEM(S) WHETHER OR NOT THEY ARE SPECIFICALLY CALLED FOR BY THE DRAWINGS AND/OR SPECIFICATIONS.

### THE COMPLETE INSTALLATION SHALL MEET ALL APPLICABLE CODE REQUIREMENTS.

### 3. VISIT TO SITE

ATTENTION IS DIRECTED TO THE NECESSITY OF THE CONTRACTOR TO VISIT THE SITE AND EXAMINE ALL CONDITIONS AFFECTING THE PROPER EXECUTION OF THIS CONTRACT. SUBMISSION OF PROPOSALS SHALL BE CONSIDERED EVIDENCE THAT THE CONTRACTOR HAS VISITED AND EXAMINED THE SITE.

NO EXTRA PAYMENT WILL BE ALLOWED TO THE CONTRACTOR FOR EXTRA WORK CAUSED BY FAILURE TO VISIT, EXAMINE, AND CLARIFY.

### 4. LAWS, ORDINANCES, AND REGULATIONS

ALL SYSTEMS SHALL CONFORM IN FULL AND/OR PART TO ALL PERTINENT LAWS, ORDINANCES, AND REGULATIONS OF ALL BODIES HAVING JURISDICTION AT ALL GOVERNING LEVELS, NOTWITHSTANDING ANYTHING IN THESE DRAWINGS OR SPECIFICATIONS TO THE CONTRARY. IN THE CASE OF CONFLICT BETWEEN GOVERNING LEVELS, THE MORE STRINGENT LAWS SHALL APPLY.

WHERE APPLICABLE, ALL NEW MATERIAL SHALL BEAR THE UNDERWRITER'S SEAL OF APPROVAL, AS WELL AS THOSE SEALS OF ALL MUNICIPALITIES HAVING JURISDICTION. CERTIFICATES TO THIS EFFECT SHALL BE FURNISHED TO THE ARCHITECT UPON REQUEST.

THE CONTRACTOR SHALL SECURE AND PAY FOR ALL LICENSES REQUIRED BY THE GOVERNING BODIES TO OPERATE AS AN ELECTRICAL CONTRACTOR FOR THIS PROJECT.

### WORKMANSHIP

ALL WORK TO BE PERFORMED SHALL BE DONE BY QUALIFIED MECHANICS IN THE EMPLOY OF THE CONTRACTOR ON THIS PROJECT: MECHANICS SHALL BE SKILLED IN THE PHASES OF THE WORK TO WHICH THEY ARE USED.

THE COMPLETE SYSTEM SHALL MEET THE REQUIREMENTS OF THE CURRENT EDITION OF THE NATIONAL ELECTRICAL CODE AND AS MAY BE MODIFIED BY THE LOCAL ELECTRICAL CODE.

### 6. MATERIALS AND EQUIPMENT

ALL MATERIALS AND EQUIPMENT SHALL BE NEW AND SHALL CONFORM TO THE GRADE, QUALITY, AND STANDARD SPECIFIED HEREIN.

ALL EQUIPMENT OFFERED UNDER THESE SPECIFICATIONS SHALL BE LIMITED TO PRODUCTS REGULARLY PRODUCED AND RECOMMENDED FOR SERVICE IN ACCORDANCE WITH ENGINEERING DATA, RATINGS, OR OTHER COMPREHENSIVE LITERATURE MADE AVAILABLE TO THE PUBLIC AND IN EFFECT AT THE TIME OF

EQUIPMENT SHALL BE INSTALLED IN STRICT ACCORDANCE WITH MANUFACTURER'S INSTRUCTIONS FOR TYPE AND CAPACITY OF EACH PIECE OF EQUIPMENT USED.

### 7. COORDINATION WITH OTHER TRADES

THE CONTRACTOR SHALL BE RESPONSIBLE FOR COORDINATING THEIR WORK WITH THE WORK OF OTHER TRADES. THE CONTRACTOR IS COMPLETELY RESPONSIBLE IF FAILURE ON THEIR PART TO COORDINATE EFFORTS RESULTS IN EXTRA WORK HAVING TO BE DONE TO COMPLETE A TASK. AS SUCH, THEIR FAILURE SHALL NOT BE THE BASIS FOR ANY EXTRA CHARGES AGAINST THE OWNER.

### 8. GROUNDING

PROVIDE ALL ELECTRICAL SYSTEM AND EQUIPMENT GROUNDS AS REQUIRED BY THE NATIONAL ELECTRICAL CODE AND AS MAY BE MODIFIED BY THE LOCAL ELECTRICAL CODE, THE NATIONAL SAFETY CODE, AND ALL AGENCIES/AUTHORITIES NOTED ABOVE.

### 9. WIRING - MANNER OF INSTALLATION

ALL WIRES SHALL BE INSTALLED IN METALLIC CONDUIT. PROVIDE THIN WALL CONDUIT (EMT) IN ALL LOCATIONS EXCEPT WHERE PROHIBITED BY CODE, EXPOSED TO WEATHER, EXPOSED TO MECHANICAL INJURY, OR WHERE BURIED IN OR BELOW SLABS ON GRADE; IN THOSE LOCATIONS PROVIDE RIGID STEEL CONDUIT.

THE ENTIRE CONDUIT SYSTEM SHALL BE INSTALLED BOTH ELECTRICALLY AND MECHANICALLY CONTINUOUS. CONDUIT FITTINGS SHALL BE SUITABLE FOR THEIR PURPOSE AND SHALL BE COMPRESSION TYPE ONLY. INDENTER TYPE FITTINGS ARE STRICTLY PROHIBITED.

### IO. WIRE AND CABLE

WIRE AND CABLE FOR BRANCH CIRCUITS AND SECONDARY FEEDERS WITHIN THE BUILDING SHALL BE COPPER, THERMOPLASTIC INSULATED, TYPE THWN OR THHN, AND 600V RATED. TYPE THW MAY BE USED IN LIEU OF TYPE THWN OR THHN IN SIZES OF #12 AWG AND #10 AWG IN DRY LOCATIONS AT THE CONTRACTOR'S OPTION. WIRE BENEATH OR IN THE GROUND FLOOR AND OTHER WET LOCATIONS SHALL BE TYPE THWN.

NO WIRE SMALLER THAN #12 AWG SHALL BE USED ON THIS PROJECT UNLESS INDICATED. LOW VOLTAGE CONTROL AND SIGNAL CIRCUITS MAY BE A MINIMUM OF #18 AWG.

### PROVIDE COLOR CODED WIRING AS FOLLOWS:

	120/208V	120/240V DELTA	277/480V
PHASE A	BLACK	BLACK	BROWN
PHASE B	RED	ORANGE	ORANGE
PHASE C	BLUE	BLUE	YELLOW
NEUTRAL	WHITE	WHITE	GRAY
GROUND	GREEN	GREEN	GREEN WITH YELLOW ST

BRANCH CIRCUIT WIRING FOR 20 AMP RECEPTACLES AND LIGHTING CIRCUITS SHALL BE ADJUSTED FOR VOLTAGE DROP:

0-75' - #12AWG MINIMUM 75'-150' - #10AWG MINIMUM 150'-225' - #8AWG MINIMUM B. 277/480V: 0-100 - #12AWG MINIMUM 100'-200' - #10AWG MINIMUM 200'-300' - #8AWG MINIMUM

WIRE SIZES #12 AWG AND #10 AWG SHALL BE SOLID. WIRE SIZE #8 AWG AND LARGER SHALL BE STRANDED.

CONDUCTORS OF DIFFERENT VOLTAGES ("LOW VOLTAGE" vs. 120/208 VOLT) SHALL NOT OCCUPY THE SAME WIRING ENCLOSURE, CABLE, OR RACEWAY.

ALL WIRING SHALL BE ENCLOSED WITHIN A COMPLETE AND CONTINUOUS METAL RACEWAY.

### II. SPLICING

SPLICING WIRES SHALL BE DONE ONLY IN ACCESSIBLE OUTLET, JUNCTION, OR PULL BOXES. SPLICES SHALL BE MADE STRICTLY IN ACCORDANCE WITH THE INSTRUCTIONS OF THE CABLE MANUFACTURER USING THE METHODS AND MATERIALS RECOMMENDED BY THE MANUFACTURER.

FOR #10 AWG AND #12 AWG WIRE, SPLICES SHALL BE MADE WITH SCOTCHLOK CONNECTORS.

### WIRE #8 AWG AND LARGER:

BURNDY OR EQUAL SOLDERLESS MECHANICAL LUG AND PAINTED WITH INSULATING VARNISH.

POLARIS OR EQUAL SOLDERLESS MECHANICAL LUG WITH FACTORY APPLIED CHEMICAL AND ABRASION RESISTANT, UV RATED INSULATION.

ALL CONNECTIONS SHALL BE PROPERLY TAPED WITH SCOTCH ELECTRICAL TAPE #22, #33, OR APPROVED EQUAL.

### 12. JUNCTION AND PULL BOXES

JUNCTION BOXES, PULL BOXES, AND TERMINAL BOXES SHALL BE INSTALLED WHERE SHOWN ON THE DRAWINGS AND AT OTHER LOCATIONS AS REQUIRED TO FACILITATE THE PULLING OF CABLES. THEY SHALL BE CODE SIZED AND SHALL BE CONSTRUCTED OF CODE GAUGE GALVANIZED SHEET STEEL. EACH BOX SHALL BE PROVIDED WITH A SCREW-ON REMOVABLE COVER. PROVIDE FLANGED COVERS ON FLUSH BOXES. BOXES SHALL BE SMOOTH, SQUARE, AND SET PARALLEL WITH WALLS AND CEILING. MINIMUM SIZE OF JUNCTION BOXES SHALL BE 4" X 4" X 2" SQUARE.

### 13. CONDUIT AND ELECTRIC METALLIC TUBING

CONDUIT AND ELECTRIC METALLIC TUBING SHALL BE IN ACCORDANCE WITH APPLICABLE ARTICLES OF THE NATIONAL ELECTRICAL CODE AND AS MAY BE MODIFIED BY THE LOCAL ELECTRICAL CODE.

INTERMEDIATE METAL CONDUIT (IMC) - ARTICLE 342 RIGID METAL CONDUIT (RMC) - ARTICLE 344 FLEXIBLE METAL CONDUIT (FMC) - ARTICLE 248 LIQUID TIGHT FLEXIBLE METAL CONDUIT (LFMC) - ARTICLE 350 RIGID POLYVINYL CHLORIDE CONDUIT (PVC) ARTICLE 352 ELECTRICAL METALLIC TUBING (EMT) - ARTICLE 358

IMC, RMC, AND EMT SHALL BE GALVANIZED STEEL.

### THE CONDUIT SHALL BE INSTALLED PERPENDICULAR AND PARALLEL TO BUILDING LINES.

ALL CONDUIT INSTALLED OVERHEAD SHALL BE RIGIDLY SUPPORTED FROM THE STRUCTURE ABOVE AND NOT FROM ANY PART OF THE ROOFING SYSTEM OR CEILING SYSTEM. CEILING SYSTEM TO INCLUDE T-BAR GRID, SUPPORT WIRES, ETC.

### ALL CONDUIT INSTALLATION SHALL BE AS FOLLOWS UNLESS NOTED OTHERWISE:

- A. SINGLE PHASE I 20 VOLT BRANCH CIRCUITS, COMMUNICATIONS WIRING, AND OTHER SIGNALING CIRCUITS FOR INTERIOR LOCATIONS: USE EMT.
- B. THREE PHASE 208 VOLT FEEDERS AND SINGLE PHASE BRANCH CIRCUITS FOR INTERIOR LOCATIONS: UP TO 2" USE EMT, OVER 2" USE IMC.
- EXTERIOR CONDUITS ABOVE GRADE SHALL BE IMC OR RMC.
- D. EXTERIOR CONDUITS BELOW GRADE SHALL RMC OR PVC. PROVIDE METALLIC TRACER WIRE OR TAPE FOR ALL BELOW GRADE NON-METALLIC CONDUITS.

### 14. OUTLET BOXES

GENERALLY, OUTLET BOXES OF PROPER TYPE AND NOT LESS THAN 4 INCHES SQUARE OR OCTAGONAL AS REQUIRED BY BUILDING CONDITIONS SHALL BE PLACED AT ALL LIGHT, RECEPTACLE, AND SWITCH OUTLETS. OUTLET BOXES SHALL BE FIRMLY SECURED IN PLACE AND SHALL BE SET TRUE, SQUARE, AND FLUSH WITH THE FINISHED SURFACES. THE CONTRACTOR SHALL MOVE ANY OUTLET BOX UP TO 5 FEET IN ANY DIRECTION WITHOUT COST IF RELOCATED PRIOR TO INSTALLATION. MINIMUM DEPTH SHALL BE 2 INCHES.

### 15. WIRING DEVICES

ACCEPTABLE MANUFACTURERS: PASS & SEYMOUR, LEVITON, COOPER, OR HUBBELL

SWITCHES SHALL BE OF THE HEAVY DUTY GRADE, 120/277 VOLT, FLUSH TOGGLE TYPE RATED AT 20 AMPERES AND UL APPROVED. ALL SWITCHES SHALL HAVE POLES AS REQUIRED AND SHALL BE SIMILAR TO PASS \$ SEYMOUR #PS20AC1. RECEPTACLES SHALL BE POLARIZED, GROUNDED, DUPLEX, BACK AND SIDE WIRED, RATED 20 AMPERES, AND UL APPROVED. ALL GENERAL PURPOSE RECEPTACLES SHALL BE SPECIFICATION GRADE, TAMPER-RESISTANT TYPE SIMILAR TO PASS & SEYMOUR #TR5362. ALL RECEPTACLES WITH GROUND-FAULT CIRCUIT INTERRUPTER SHALL BE TAMPER-RESISTANT TYPE SIMILAR TO PASS \$ SEYMOUR #2097TR. ALL WEATHER-RESISTANT RECEPTACLES WITH GROUND-FAULT CIRCUIT INTERRUPTER SHALL BE SIMILAR TO PASS \$ SEYMOUR #2095TRWR. DEVICE COLORS TO BE SELECTED BY ARCHITECT.

CONTRACTOR TO SUBMIT SHOP DRAWINGS ON THIS ITEM.

### 16. DEVICE WALLPLATES

SWITCH AND RECEPTACLE PLATES IN FINISHED AREAS SHALL BE TYPE 302/304 BRUSHED STAINLESS STEEL. ALL PLATES IN UNFINISHED AREAS AREA SHALL BE FORMED STEEL (GARVIN COVERS).

CONTRACTOR TO SUBMIT SHOP DRAWINGS ON THIS ITEM.

### 17. LUMINAIRES

LUMINAIRES SHALL BE PROVIDED AS SPECIFIED ON DRAWINGS. LUMINAIRES SHALL BE HUNG AND MOUNTED IN PLACE, PROPERLY WIRED, TESTED, AND LEFT READY FOR OPERATION BY THE CONTRACTOR.

LED LUMINAIRES: DESIGNED AND TESTED TO IESNA STANDARDS LM-80 AND LM-79, WITH 5 YEAR MANUFACTURER'S WARRANTY.

WHERE LOCATED BENEATH DUCTWORK, THE CONTRACTOR IS PROHIBITED FROM PUNCTURING THE DUCTWORK OR MOUNTING LUMINAIRES DIRECTLY TO THE DUCTWORK. THE CONTRACTOR MAY MOUNT THE LUMINAIRES TO THE DUCTWORK SUPPORT MEMBERS. HANGING DEVICES, BRACKETS, ENCLOSURES, AND OTHER ACCESSORIES SHALL BE PROVIDED FOR A COMPLETE INSTALLATION AND SHALL BE INSTALLED BY THE CONTRACTOR. LUMINAIRES SHALL BE HUNG PLUMB AND SET SQUARE AGAINST THE WALL OR CEILING, OR SUSPENDED AS DESIGNATED. THE MOUNTING HEIGHT OF LUMINAIRES SHALL BE CONFIRMED BEFORE INSTALLATION.

CONTRACTOR TO SUBMIT SHOP DRAWINGS ON THIS ITEM.

### 18. LIGHTING CONTROL SYSTEM

LIGHTING CONTROLS SHALL BE PROVIDED AS SPECIFIED ON DRAWINGS. ALL SENSORS SHALL BE MOUNTED IN PLACE, PROPERLY WIRED, PROGRAMMED AND TESTED FOR OPERATION BY THE CONTRACTOR.

TIME-BASED, SENSOR-BASED AND MANUAL LIGHTING CONTROL WITHOUT THE USE OF ANY CENTRALLY HARDWIRED SWITCHING EQUIPMENT (RELAY PANELS). THE SYSTEM'S CONTROL SHALL BE EXERTED BY DIRECTLY SWITCHING LOADS ON/OFF AND/OR DIMMING LIGHTS.

COVERAGE OF SENSORS SHALL REMAIN CONSTANT AFTER SENSITIVITY CONTROL HAS BEEN SET. NO AUTOMATIC REDUCTION SHALL OCCUR IN COVERAGE DUE TO THE CYCLING OF AIR CONDITIONER OR HEATING FANS.

### ALL SENSORS SHALL HAVE READILY ACCESSIBLE, USER ADJUSTABLE CONTROLS FOR TIME DELAY AND SENSITIVITY.

IN THE EVENT OF FAILURE, A BYPASS MANUAL OVERRIDE SHALL BE PROVIDED ON EACH SENSOR. WHEN BYPASS IS UTILIZED, LIGHTING SHALL REMAIN ON CONSTANTLY OR CONTROL SHALL DIVERT TO A WALL SWITCH UNTIL SENSOR IS REPLACED.

### ALL SENSORS SHALL PROVIDE A METHOD OF INDICATION TO VERIFY THAT MOTION IS BEING DETECTED DURING TESTING AND THAT THE UNIT IS WORKING.

POWER PACKS: PLENUM RATED, SELF-CONTAINED LOW VOLTAGE CLASS 2 TRANSFORMER AND RELAY COMPATIBLE WITH SPECIFIED LOW VOLTAGE OCCUPANCY SENSORS FOR SWITCHING OF LINE VOLTAGE LOADS. PROVIDE QUANTITY, TYPE AND CONFIGURATION OF POWER AND SLAVE PACKS WITH ALL ASSOCIATED WIRING AND ACCESSORIES AS REQUIRED TO CONTROL THE LOAD INDICATED ON DRAWINGS.

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CONTRACTOR TO SUBMIT SHOP DRAWINGS ON THIS ITEM.

### 20. FIRESTOPPING

THE CONTRACTOR SHALL FIRE STOP ALL PENETRATIONS THROUGH FIRE RATED WALLS, PARTITIONS, ROOFS, AND/OR FLOORS SO THAT THE INTEGRITY OF THE FIRE RATING IS NOT COMPROMISED BY THE CONTRACTOR'S INSTALLATION OF ANY BOX, CABLE TRAY, RACEWAY, AND/OR CONDUIT. FIRE STOPPING METHODS AND MATERIALS SHALL CONFORM TO LOCAL CODE AUTHORITY REQUIREMENTS. AT A MINIMUM, THE CONTRACTOR SHALL GROUT AROUND ALL BOXES, CABLE TRAYS, RACEWAYS, CONDUITS, ETC., IN PENETRATION RATED PARTITION/FLOOR CONSTRUCTION WITH NON-SHRINK GROUT SO THAT ALL OPEN SPACES ARE FILLED IN SOLIDLY.

THE CONTRACTOR SHALL PROVIDE SUITABLY RATED LUMINAIRES OR UTILIZE APPROVED MATERIALS AND METHODS TO MAINTAIN THE INTEGRITY OF THE FIRE RATED CEILING. THE CONTRACTOR SHALL REFER TO ARCHITECTURAL PLANS FOR THE LOCATION OF ALL FIRE RATED CEILINGS, PARTITIONS, AND WALLS.

### 21. BALANCING

THE SYSTEM OF FEEDERS AND BRANCH CIRCUITS FOR POWER AND LIGHTING SHALL BE CONNECTED IN SUCH A MANNER THAT THE CONNECTED LOADS ARE BALANCED ELECTRICALLY ON THE THREE PHASES AS CLOSELY AS POSSIBLE (WITHIN 10 PERCENT). SHOULD THE POWER COMPANY FIND AN UNFAVORABLE OPERATING CONDITION REACTING ON THE SERVICE, THE CONTRACTOR SHALL MAKE SUCH CHANGES REQUIRED TO BALANCE THE LOAD WITHOUT ADDITIONAL COST TO THE OWNER.

### 22. TESTING AND ADJUSTMENTS

ALL WORK SHALL BE TESTED BY THE CONTRACTOR. ALL MATERIAL, LABOR, AND EQUIPMENT SHALL BE FURNISHED BY THE CONTRACTOR TO ACCOMPLISH SUCH TESTS AS REQUIRED BY THE ARCHITECT/ENGINEER.

UPON COMPLETION OF THIS WORK, THE PROJECT SHALL BE FREE FROM SHORT CIRCUITS AND GROUNDS AND A THOROUGH TEST SHALL BE MADE. ALL OVERLOAD DEVICES, INCLUDING THOSE FURNISHED UNDER OTHER CONTRACTS SHALL BE ADJUSTED TO SUIT LOAD CONDITIONS BY THE CONTRACTOR. ALL SYSTEMS SHALL BE TESTED AND THEIR OPERATION DEMONSTRATED

LIGHTING EQUIPMENT SHALL BE ADJUSTED TO THE SATISFACTION OF THE OWNER.

### 23. GUARANTEE

THE CONTRACTOR SHALL UNCONDITIONALLY GUARANTEE IN WRITING ALL MATERIAL, EQUIPMENT, AND WORKMANSHIP FOR A PERIOD OF ONE YEAR FROM DATE OF SUBSTANTIAL COMPLETION. THE CONTRACTOR SHALL PROVIDE FREE SERVICE FOR ALL EQUIPMENT INVOLVED IN THEIR CONTRACT DURING THIS GUARANTEE

THE GUARANTEE SHALL INCLUDE RESTORATION TO ITS ORIGINAL CONDITION OF ALL ADJACENT WORK THAT MUST BE DISTURBED IN FULFILLING THIS GUARANTEE.

ALL SUCH REPAIRS AND/OR REPLACEMENTS SHALL BE MADE WITHOUT DELAY AND AT THE CONVENIENCE OF THE OWNER.

### 24. SUBSTITUTIONS

APPROVALS OF SUBSTITUTIONS FOR "APPROVED EQUAL" MUST BE MADE IN WRITING AND SUBSTITUTIONS MUST BE APPROVED BEFORE INSTALLATION. INSTALLATION WITHOUT PRIOR APPROVAL MAY RESULT IN THE CONTRACTOR REMOVING SUBSTITUTION AND REPLACING IT WITH SPECIFIED ITEM AT THEIR EXPENSE.

APPROVAL MAY BE GIVEN BY ARCHITECT OR ENGINEER.

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